

Marion County ATC - Renovation & Addition

Lebanon, Kentucky

for the

Marion County Board of Education

755 East Main Street Lebanon, Kentucky 40033
 p 270.692.3721

BG 25-341
 RTA # 25015

rosstarrant | a MORE group brand

enhancing education through great design

STRUCTURAL ENGINEER: STRUCTURAL DESIGN GROUP, INC.
 220 Great Circle Road, Suite 106 Nashville, Tennessee 37228
 p 615.255.5537

ME/P ENGINEER: CMTA, INC.
 7701 Lexington Green Circle, Suite 600 Lexington, Kentucky 40503
 p 859.253.0897

HARDWARE CONSULTANT: CALVERT INDEPENDENT HARDWARE SPECIFICATIONS, LLC
 307 Oakwood Circle Vine Grove, Kentucky 40175
 p 502.930.2039

101 Old Lafayette Avenue
 Lexington, Kentucky 40502
 p. 859.254.4018

721 East Main Street
 Lebanon, Kentucky
 40033

PROJECT SITE ADDRESS

VICINITY MAP



SITE

PROJECT VICINITY MAP



INDEX OF DRAWINGS

001	COVER SHEET
002	NOT FOR CONSTRUCTION
003	GENERAL NOTES
004	PERMISSION TO CONSTRUCT
005	PERMISSION TO CONSTRUCT
006	PERMISSION TO CONSTRUCT
100	PERMISSION TO CONSTRUCT

COVER SHEET


MARION COUNTY ATC - RENOVATION & ADDITION
 FOR
 MARION COUNTY BOARD OF EDUCATION
 LEBANON, KENTUCKY

NOT FOR
 CONSTRUCTION



DATE: 08/25/2020
 DRAWN BY: [Name]
 CHECKED BY: [Name]
 SHEET TITLE: [Title]



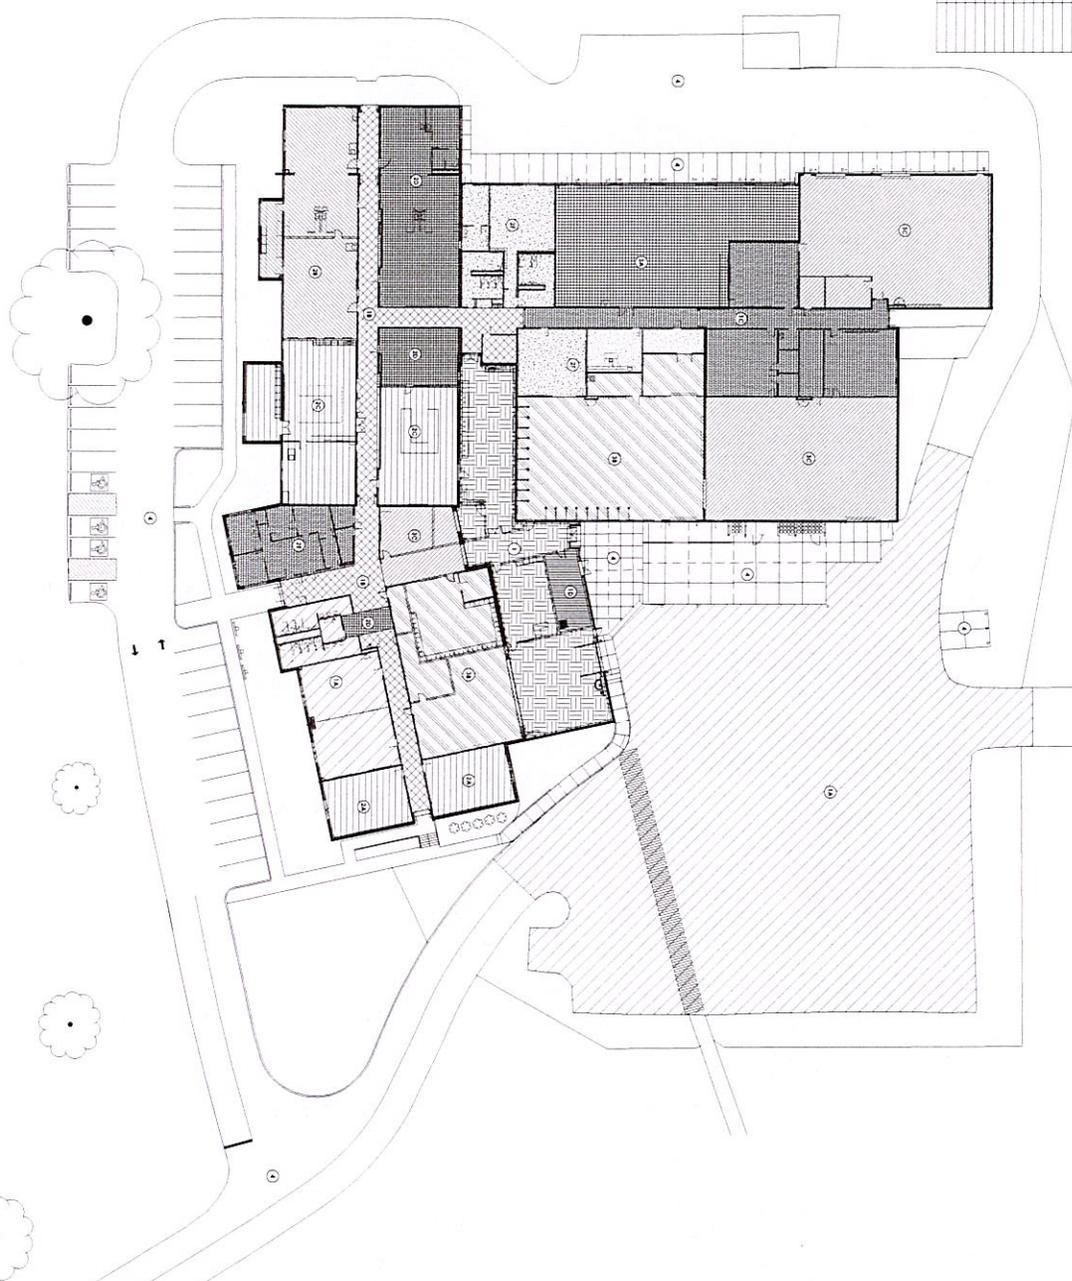

FIRST FLOOR PHASING PLAN
1" = 20' 0"

PHASING PLAN
<p>PHASE 1: 2014-2015 - 2014-2015</p> <ul style="list-style-type: none"> RENOVATION OF EXISTING CLASSROOMS AND COMPUTER LABS RENOVATION OF EXISTING STUDENT CENTER RENOVATION OF EXISTING GYMNASIUM RENOVATION OF EXISTING CAFETERIA RENOVATION OF EXISTING OFFICES RENOVATION OF EXISTING STORAGE RENOVATION OF EXISTING MECHANICAL ROOMS RENOVATION OF EXISTING ELECTRICAL ROOMS RENOVATION OF EXISTING PLUMBING ROOMS RENOVATION OF EXISTING ROOF RENOVATION OF EXISTING EXTERIOR RENOVATION OF EXISTING LANDSCAPE RENOVATION OF EXISTING SIGNAGE RENOVATION OF EXISTING SECURITY RENOVATION OF EXISTING ACCESSIBILITY RENOVATION OF EXISTING SAFETY RENOVATION OF EXISTING MAINTENANCE RENOVATION OF EXISTING UTILITIES RENOVATION OF EXISTING RECORDS RENOVATION OF EXISTING ARCHIVES RENOVATION OF EXISTING ARTS RENOVATION OF EXISTING MUSIC RENOVATION OF EXISTING THEATRE RENOVATION OF EXISTING DANCE RENOVATION OF EXISTING ATHLETICS RENOVATION OF EXISTING GOLF RENOVATION OF EXISTING TENNIS RENOVATION OF EXISTING BASKETBALL RENOVATION OF EXISTING SOFTBALL RENOVATION OF EXISTING BASEBALL RENOVATION OF EXISTING FOOTBALL RENOVATION OF EXISTING HOCKEY RENOVATION OF EXISTING RUGBY RENOVATION OF EXISTING CRICKET RENOVATION OF EXISTING TENNIS RENOVATION OF EXISTING GOLF RENOVATION OF EXISTING TENNIS RENOVATION OF EXISTING BASKETBALL RENOVATION OF EXISTING SOFTBALL RENOVATION OF EXISTING BASEBALL RENOVATION OF EXISTING FOOTBALL RENOVATION OF EXISTING HOCKEY RENOVATION OF EXISTING RUGBY RENOVATION OF EXISTING CRICKET
<p>PHASE 2: 2016-2017 - 2016-2017</p> <ul style="list-style-type: none"> RENOVATION OF EXISTING CLASSROOMS AND COMPUTER LABS RENOVATION OF EXISTING STUDENT CENTER RENOVATION OF EXISTING GYMNASIUM RENOVATION OF EXISTING CAFETERIA RENOVATION OF EXISTING OFFICES RENOVATION OF EXISTING STORAGE RENOVATION OF EXISTING MECHANICAL ROOMS RENOVATION OF EXISTING ELECTRICAL ROOMS RENOVATION OF EXISTING PLUMBING ROOMS RENOVATION OF EXISTING ROOF RENOVATION OF EXISTING EXTERIOR RENOVATION OF EXISTING LANDSCAPE RENOVATION OF EXISTING SIGNAGE RENOVATION OF EXISTING SECURITY RENOVATION OF EXISTING ACCESSIBILITY RENOVATION OF EXISTING SAFETY RENOVATION OF EXISTING MAINTENANCE RENOVATION OF EXISTING UTILITIES RENOVATION OF EXISTING RECORDS RENOVATION OF EXISTING ARCHIVES RENOVATION OF EXISTING ARTS RENOVATION OF EXISTING MUSIC RENOVATION OF EXISTING THEATRE RENOVATION OF EXISTING DANCE RENOVATION OF EXISTING ATHLETICS RENOVATION OF EXISTING GOLF RENOVATION OF EXISTING TENNIS RENOVATION OF EXISTING BASKETBALL RENOVATION OF EXISTING SOFTBALL RENOVATION OF EXISTING BASEBALL RENOVATION OF EXISTING FOOTBALL RENOVATION OF EXISTING HOCKEY RENOVATION OF EXISTING RUGBY RENOVATION OF EXISTING CRICKET
<p>PHASE 3: 2018-2019 - 2018-2019</p> <ul style="list-style-type: none"> RENOVATION OF EXISTING CLASSROOMS AND COMPUTER LABS RENOVATION OF EXISTING STUDENT CENTER RENOVATION OF EXISTING GYMNASIUM RENOVATION OF EXISTING CAFETERIA RENOVATION OF EXISTING OFFICES RENOVATION OF EXISTING STORAGE RENOVATION OF EXISTING MECHANICAL ROOMS RENOVATION OF EXISTING ELECTRICAL ROOMS RENOVATION OF EXISTING PLUMBING ROOMS RENOVATION OF EXISTING ROOF RENOVATION OF EXISTING EXTERIOR RENOVATION OF EXISTING LANDSCAPE RENOVATION OF EXISTING SIGNAGE RENOVATION OF EXISTING SECURITY RENOVATION OF EXISTING ACCESSIBILITY RENOVATION OF EXISTING SAFETY RENOVATION OF EXISTING MAINTENANCE RENOVATION OF EXISTING UTILITIES RENOVATION OF EXISTING RECORDS RENOVATION OF EXISTING ARCHIVES RENOVATION OF EXISTING ARTS RENOVATION OF EXISTING MUSIC RENOVATION OF EXISTING THEATRE RENOVATION OF EXISTING DANCE RENOVATION OF EXISTING ATHLETICS RENOVATION OF EXISTING GOLF RENOVATION OF EXISTING TENNIS RENOVATION OF EXISTING BASKETBALL RENOVATION OF EXISTING SOFTBALL RENOVATION OF EXISTING BASEBALL RENOVATION OF EXISTING FOOTBALL RENOVATION OF EXISTING HOCKEY RENOVATION OF EXISTING RUGBY RENOVATION OF EXISTING CRICKET
<p>PHASE 4: 2020-2021 - 2020-2021</p> <ul style="list-style-type: none"> RENOVATION OF EXISTING CLASSROOMS AND COMPUTER LABS RENOVATION OF EXISTING STUDENT CENTER RENOVATION OF EXISTING GYMNASIUM RENOVATION OF EXISTING CAFETERIA RENOVATION OF EXISTING OFFICES RENOVATION OF EXISTING STORAGE RENOVATION OF EXISTING MECHANICAL ROOMS RENOVATION OF EXISTING ELECTRICAL ROOMS RENOVATION OF EXISTING PLUMBING ROOMS RENOVATION OF EXISTING ROOF RENOVATION OF EXISTING EXTERIOR RENOVATION OF EXISTING LANDSCAPE RENOVATION OF EXISTING SIGNAGE RENOVATION OF EXISTING SECURITY RENOVATION OF EXISTING ACCESSIBILITY RENOVATION OF EXISTING SAFETY RENOVATION OF EXISTING MAINTENANCE RENOVATION OF EXISTING UTILITIES RENOVATION OF EXISTING RECORDS RENOVATION OF EXISTING ARCHIVES RENOVATION OF EXISTING ARTS RENOVATION OF EXISTING MUSIC RENOVATION OF EXISTING THEATRE RENOVATION OF EXISTING DANCE RENOVATION OF EXISTING ATHLETICS RENOVATION OF EXISTING GOLF RENOVATION OF EXISTING TENNIS RENOVATION OF EXISTING BASKETBALL RENOVATION OF EXISTING SOFTBALL RENOVATION OF EXISTING BASEBALL RENOVATION OF EXISTING FOOTBALL RENOVATION OF EXISTING HOCKEY RENOVATION OF EXISTING RUGBY RENOVATION OF EXISTING CRICKET

PHASING PLAN
MARION COUNTY ATC - RENOVATION & ADDITION
FOR
MARION COUNTY BOARD OF EDUCATION
LEBANON, KENTUCKY

NOT FOR CONSTRUCTION




rossmore architects
a HOCHTIEF group

101 West Main Street, Suite 200, Lebanon, KY 40026 | 606.334.4278

G2.0


DATE: 08/29/2014
DRAWN: J. B. BROWN
CHECKED: J. B. BROWN
SCALE: AS SHOWN

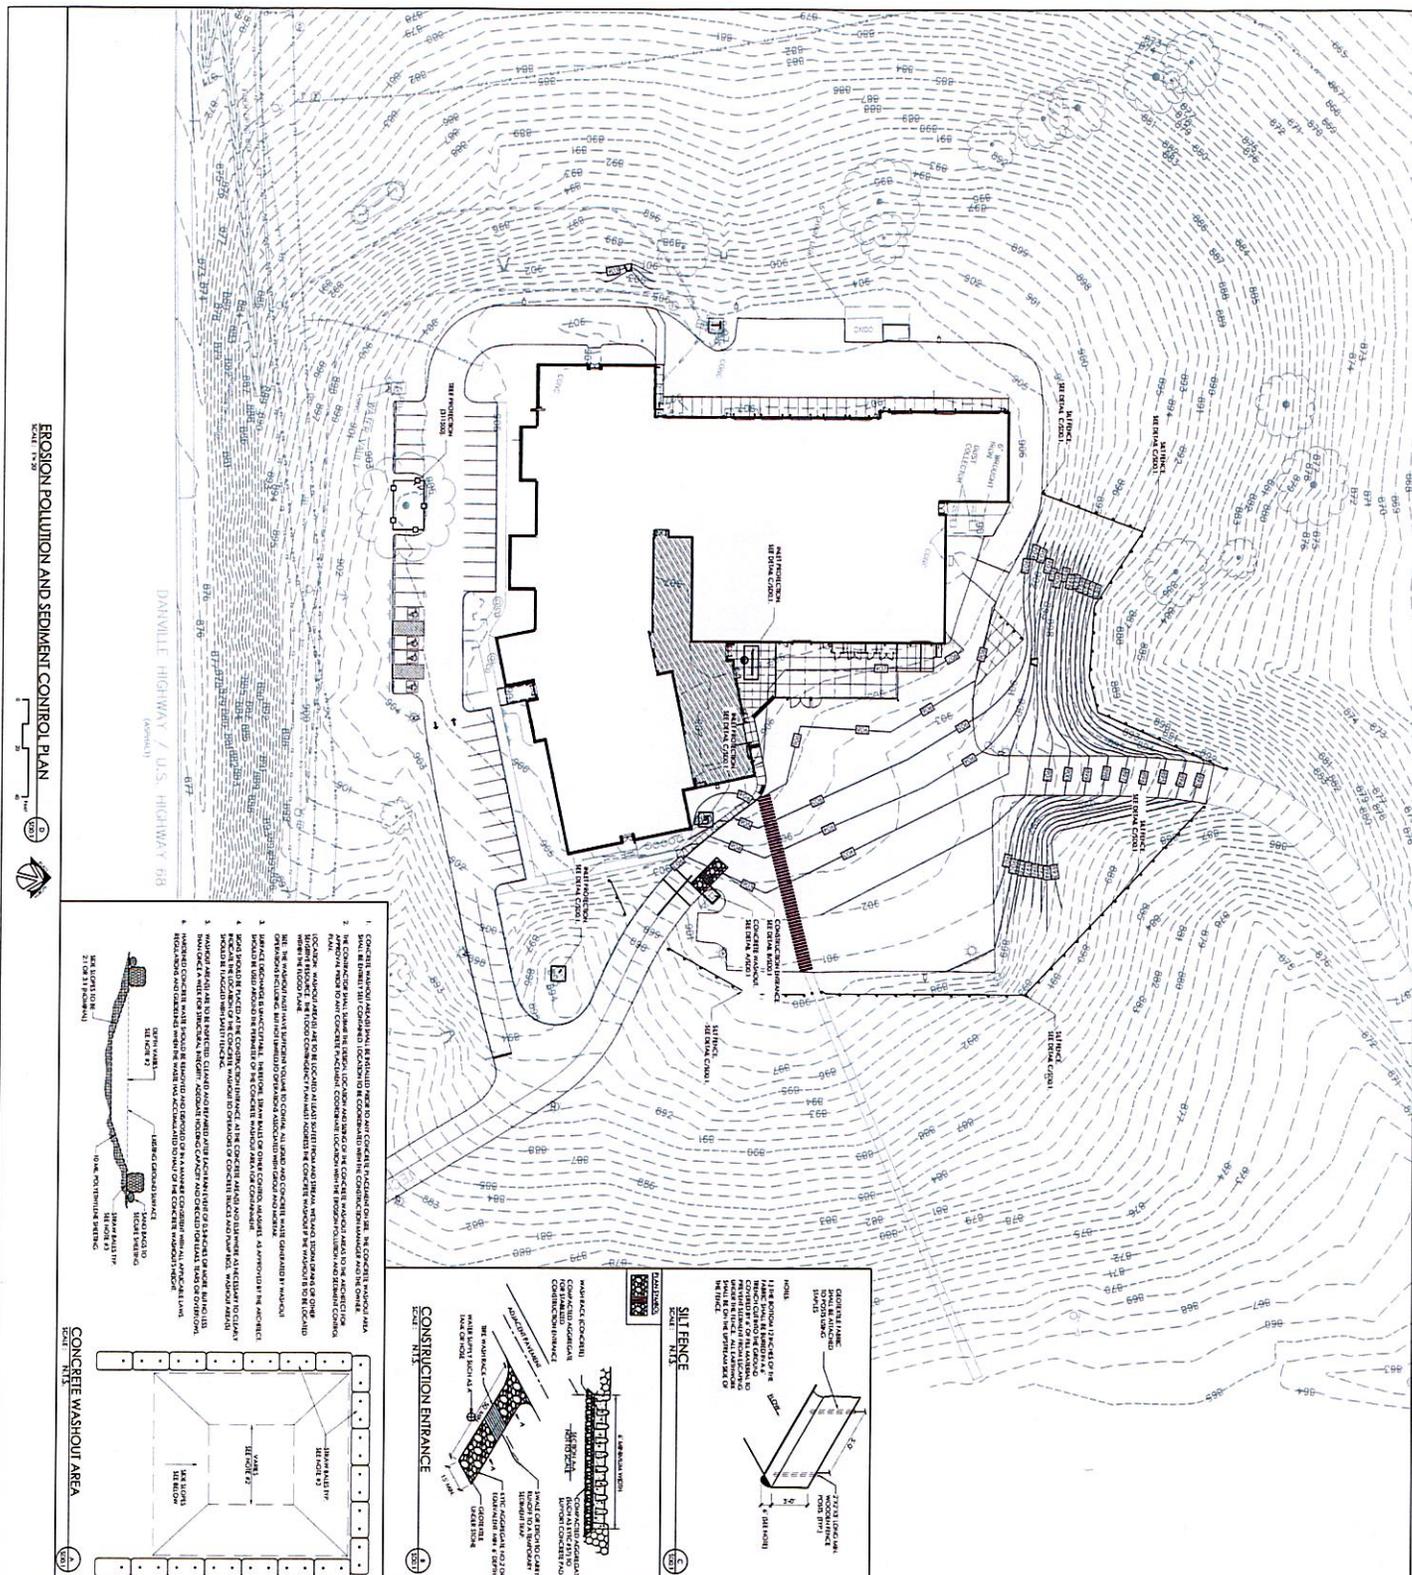

- ### GENERAL SITE NOTES
1. THE SITE IS TO BE REDEVELOPED IN ACCORDANCE WITH THE MARION COUNTY ZONING ORDINANCE AND THE MARION COUNTY SUBDIVISION ORDINANCE.
 2. EXISTING UTILITIES ARE SHOWN AS DASHED LINES AND SHALL BE PROTECTED AND MAINTAINED THROUGHOUT THE PROJECT.
 3. THE PROJECT SHALL BE CONSTRUCTED IN ACCORDANCE WITH THE MARION COUNTY ZONING ORDINANCE AND THE MARION COUNTY SUBDIVISION ORDINANCE.
 4. THE CONSTRUCTION SHALL BE CONDUCTED IN ACCORDANCE WITH THE MARION COUNTY ZONING ORDINANCE AND THE MARION COUNTY SUBDIVISION ORDINANCE.
 5. THE PROJECT SHALL BE CONSTRUCTED IN ACCORDANCE WITH THE MARION COUNTY ZONING ORDINANCE AND THE MARION COUNTY SUBDIVISION ORDINANCE.
 6. THE PROJECT SHALL BE CONSTRUCTED IN ACCORDANCE WITH THE MARION COUNTY ZONING ORDINANCE AND THE MARION COUNTY SUBDIVISION ORDINANCE.
 7. THE PROJECT SHALL BE CONSTRUCTED IN ACCORDANCE WITH THE MARION COUNTY ZONING ORDINANCE AND THE MARION COUNTY SUBDIVISION ORDINANCE.
 8. THE PROJECT SHALL BE CONSTRUCTED IN ACCORDANCE WITH THE MARION COUNTY ZONING ORDINANCE AND THE MARION COUNTY SUBDIVISION ORDINANCE.
 9. THE PROJECT SHALL BE CONSTRUCTED IN ACCORDANCE WITH THE MARION COUNTY ZONING ORDINANCE AND THE MARION COUNTY SUBDIVISION ORDINANCE.
 10. THE PROJECT SHALL BE CONSTRUCTED IN ACCORDANCE WITH THE MARION COUNTY ZONING ORDINANCE AND THE MARION COUNTY SUBDIVISION ORDINANCE.

- ### SITE BMP NOTES
1. CONSTRUCTION SHALL BE CONDUCTED IN ACCORDANCE WITH THE MARION COUNTY ZONING ORDINANCE AND THE MARION COUNTY SUBDIVISION ORDINANCE.
 2. CONSTRUCTION SHALL BE CONDUCTED IN ACCORDANCE WITH THE MARION COUNTY ZONING ORDINANCE AND THE MARION COUNTY SUBDIVISION ORDINANCE.
 3. CONSTRUCTION SHALL BE CONDUCTED IN ACCORDANCE WITH THE MARION COUNTY ZONING ORDINANCE AND THE MARION COUNTY SUBDIVISION ORDINANCE.
 4. CONSTRUCTION SHALL BE CONDUCTED IN ACCORDANCE WITH THE MARION COUNTY ZONING ORDINANCE AND THE MARION COUNTY SUBDIVISION ORDINANCE.
 5. CONSTRUCTION SHALL BE CONDUCTED IN ACCORDANCE WITH THE MARION COUNTY ZONING ORDINANCE AND THE MARION COUNTY SUBDIVISION ORDINANCE.
 6. CONSTRUCTION SHALL BE CONDUCTED IN ACCORDANCE WITH THE MARION COUNTY ZONING ORDINANCE AND THE MARION COUNTY SUBDIVISION ORDINANCE.
 7. CONSTRUCTION SHALL BE CONDUCTED IN ACCORDANCE WITH THE MARION COUNTY ZONING ORDINANCE AND THE MARION COUNTY SUBDIVISION ORDINANCE.
 8. CONSTRUCTION SHALL BE CONDUCTED IN ACCORDANCE WITH THE MARION COUNTY ZONING ORDINANCE AND THE MARION COUNTY SUBDIVISION ORDINANCE.
 9. CONSTRUCTION SHALL BE CONDUCTED IN ACCORDANCE WITH THE MARION COUNTY ZONING ORDINANCE AND THE MARION COUNTY SUBDIVISION ORDINANCE.
 10. CONSTRUCTION SHALL BE CONDUCTED IN ACCORDANCE WITH THE MARION COUNTY ZONING ORDINANCE AND THE MARION COUNTY SUBDIVISION ORDINANCE.

- ### LEGEND
- | | |
|----------|----------------------------------|
| [Symbol] | CONCRETE WASHOUT AREA (SEE PLAN) |
| [Symbol] | CONSTRUCTION ENTRANCE (SEE PLAN) |
| [Symbol] | SILT FENCE (SEE PLAN) |
| [Symbol] | EXISTING UTILITIES (SEE PLAN) |
| [Symbol] | PROPOSED UTILITIES (SEE PLAN) |
| [Symbol] | PROPOSED CONSTRUCTION (SEE PLAN) |
| [Symbol] | PROPOSED PAVING (SEE PLAN) |
| [Symbol] | PROPOSED GRASS (SEE PLAN) |
| [Symbol] | PROPOSED TREES (SEE PLAN) |
| [Symbol] | PROPOSED BUSHES (SEE PLAN) |
| [Symbol] | PROPOSED ROCK (SEE PLAN) |
| [Symbol] | PROPOSED SAND (SEE PLAN) |
| [Symbol] | PROPOSED SILT (SEE PLAN) |
| [Symbol] | PROPOSED CLAY (SEE PLAN) |
| [Symbol] | PROPOSED LOESS (SEE PLAN) |
| [Symbol] | PROPOSED COAL (SEE PLAN) |
| [Symbol] | PROPOSED IRON (SEE PLAN) |
| [Symbol] | PROPOSED MANGANESE (SEE PLAN) |
| [Symbol] | PROPOSED ZINC (SEE PLAN) |
| [Symbol] | PROPOSED COPPER (SEE PLAN) |
| [Symbol] | PROPOSED LEAD (SEE PLAN) |
| [Symbol] | PROPOSED CADMIUM (SEE PLAN) |
| [Symbol] | PROPOSED CHROMIUM (SEE PLAN) |
| [Symbol] | PROPOSED NICKEL (SEE PLAN) |
| [Symbol] | PROPOSED SILICON (SEE PLAN) |
| [Symbol] | PROPOSED ALUMINUM (SEE PLAN) |
| [Symbol] | PROPOSED POTASSIUM (SEE PLAN) |
| [Symbol] | PROPOSED SODIUM (SEE PLAN) |
| [Symbol] | PROPOSED CALCIUM (SEE PLAN) |
| [Symbol] | PROPOSED MAGNESIUM (SEE PLAN) |
| [Symbol] | PROPOSED PHOSPHORUS (SEE PLAN) |
| [Symbol] | PROPOSED NITROGEN (SEE PLAN) |
| [Symbol] | PROPOSED SULFUR (SEE PLAN) |
| [Symbol] | PROPOSED CHLORINE (SEE PLAN) |
| [Symbol] | PROPOSED FLUORINE (SEE PLAN) |
| [Symbol] | PROPOSED IODINE (SEE PLAN) |
| [Symbol] | PROPOSED BROMINE (SEE PLAN) |
| [Symbol] | PROPOSED SELENIUM (SEE PLAN) |
| [Symbol] | PROPOSED ZINC (SEE PLAN) |
| [Symbol] | PROPOSED COPPER (SEE PLAN) |
| [Symbol] | PROPOSED LEAD (SEE PLAN) |
| [Symbol] | PROPOSED CADMIUM (SEE PLAN) |
| [Symbol] | PROPOSED CHROMIUM (SEE PLAN) |
| [Symbol] | PROPOSED NICKEL (SEE PLAN) |
| [Symbol] | PROPOSED SILICON (SEE PLAN) |
| [Symbol] | PROPOSED ALUMINUM (SEE PLAN) |
| [Symbol] | PROPOSED POTASSIUM (SEE PLAN) |
| [Symbol] | PROPOSED SODIUM (SEE PLAN) |
| [Symbol] | PROPOSED CALCIUM (SEE PLAN) |
| [Symbol] | PROPOSED MAGNESIUM (SEE PLAN) |
| [Symbol] | PROPOSED PHOSPHORUS (SEE PLAN) |
| [Symbol] | PROPOSED NITROGEN (SEE PLAN) |
| [Symbol] | PROPOSED SULFUR (SEE PLAN) |
| [Symbol] | PROPOSED CHLORINE (SEE PLAN) |
| [Symbol] | PROPOSED FLUORINE (SEE PLAN) |
| [Symbol] | PROPOSED IODINE (SEE PLAN) |
| [Symbol] | PROPOSED BROMINE (SEE PLAN) |
| [Symbol] | PROPOSED SELENIUM (SEE PLAN) |

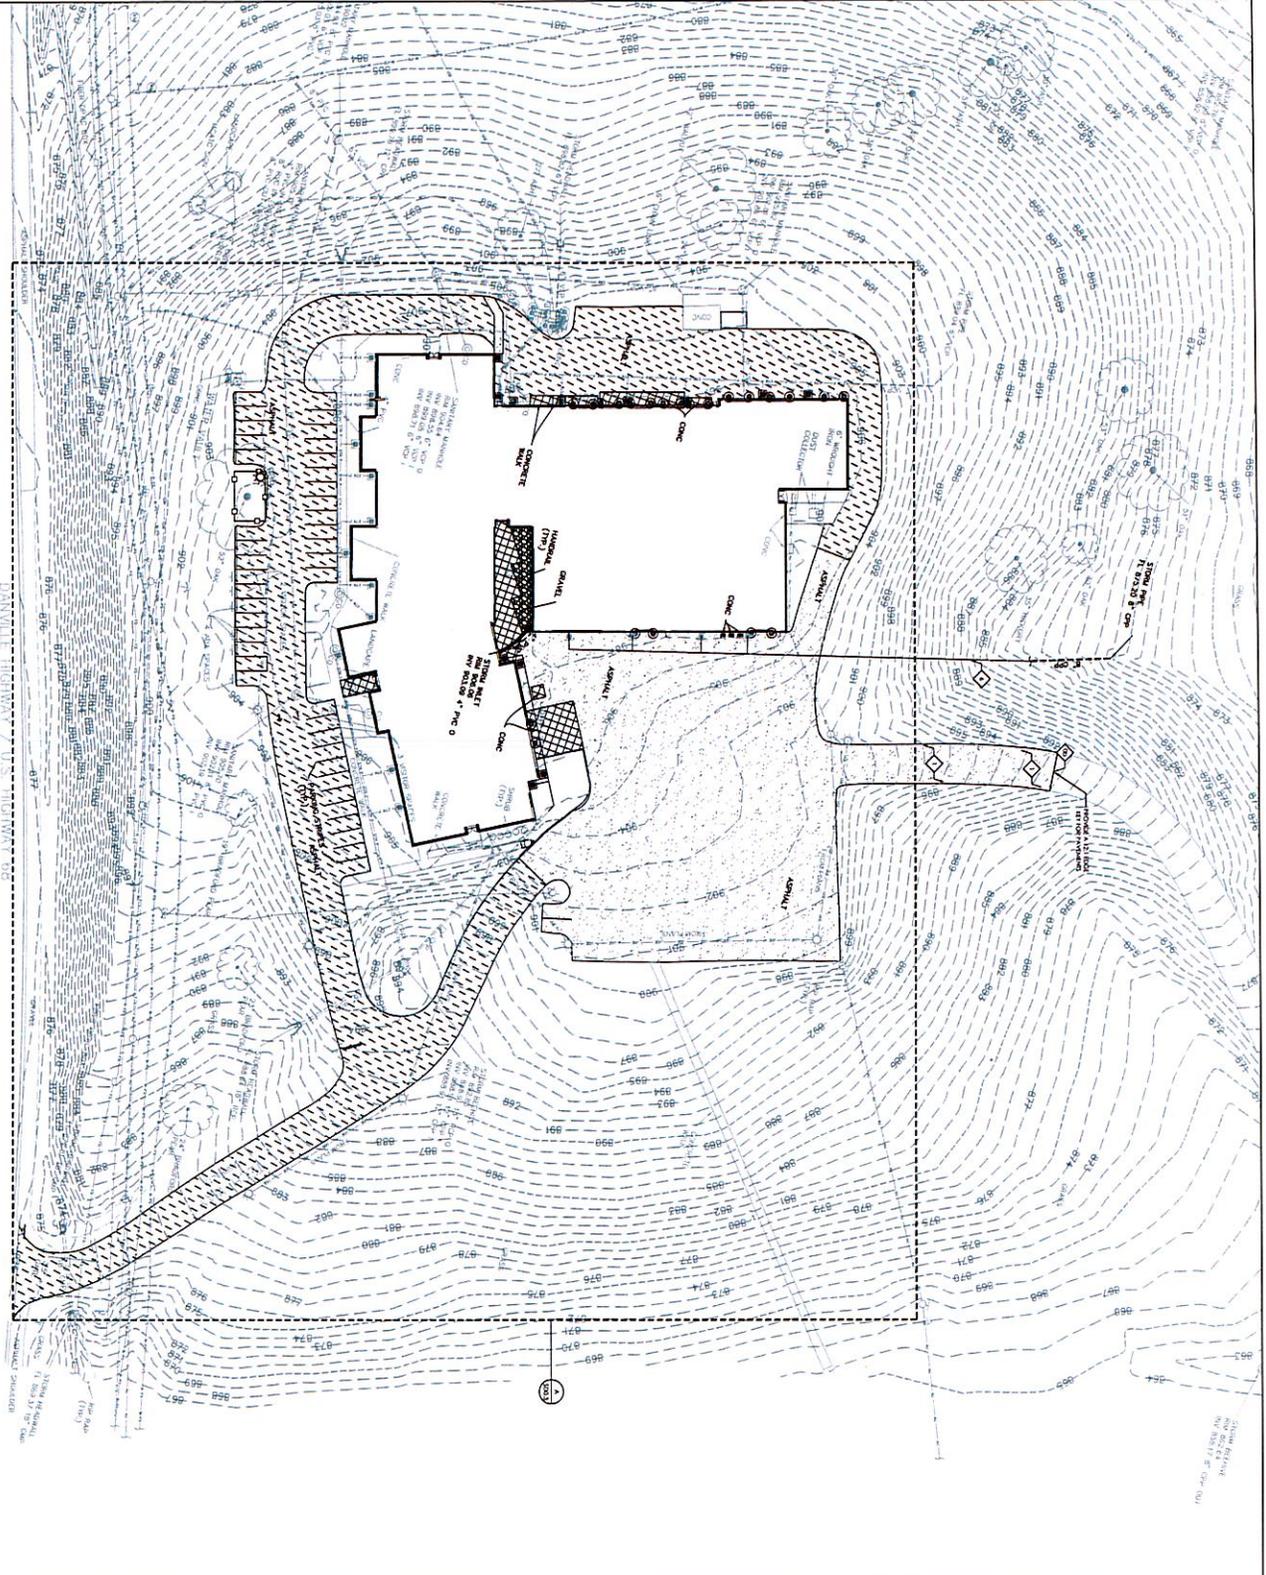

OVERALL SITE DEMOLITION PLAN
SCALE 1" = 20'



<p>LEGEND</p> <ul style="list-style-type: none"> CONCRETE IN PLACE DEMOLITION ASPHALT IN PLACE DEMOLITION MAINT. DEMO. ASPHALT PAVEMENT GRAVEL IN PLACE DEMOLITION REINFORCED CONCRETE, STEEL, ALUMINUM FRAMES, COMBINATION, AND OTHER CONCRETE 	<p>GENERAL SITE NOTES</p> <ol style="list-style-type: none"> THE SITE HAS BEEN PROVIDED MULTIPHASE DEMOLITION: PHASE 1 IS THE EXISTING BUILDING AND PHASE 2 IS THE EXISTING DRIVEWAY AND DRIVEWAY PAVEMENT. THE CONTRACTOR SHALL REMOVE ALL EXISTING DRIVEWAY AND DRIVEWAY PAVEMENT AND RECONSTRUCT TO THE EXISTING FINISH ELEVATION. THE CONTRACTOR SHALL REMOVE ALL EXISTING DRIVEWAY AND DRIVEWAY PAVEMENT AND RECONSTRUCT TO THE EXISTING FINISH ELEVATION. THE CONTRACTOR SHALL REMOVE ALL EXISTING DRIVEWAY AND DRIVEWAY PAVEMENT AND RECONSTRUCT TO THE EXISTING FINISH ELEVATION. THE CONTRACTOR SHALL REMOVE ALL EXISTING DRIVEWAY AND DRIVEWAY PAVEMENT AND RECONSTRUCT TO THE EXISTING FINISH ELEVATION. 	<p>SITE DEMOLITION TAGS</p> <ul style="list-style-type: none"> DEMOLITION TAGS: INDICATE THE LOCATION OF ALL EXISTING STRUCTURES TO BE DEMOLISHED. THE CONTRACTOR SHALL REMOVE ALL EXISTING STRUCTURES AND RECONSTRUCT TO THE EXISTING FINISH ELEVATION. DEMOLITION TAGS: INDICATE THE LOCATION OF ALL EXISTING DRIVEWAY AND DRIVEWAY PAVEMENT TO BE DEMOLISHED. THE CONTRACTOR SHALL REMOVE ALL EXISTING DRIVEWAY AND DRIVEWAY PAVEMENT AND RECONSTRUCT TO THE EXISTING FINISH ELEVATION. DEMOLITION TAGS: INDICATE THE LOCATION OF ALL EXISTING ASPHALT PAVEMENT TO BE DEMOLISHED. THE CONTRACTOR SHALL REMOVE ALL EXISTING ASPHALT PAVEMENT AND RECONSTRUCT TO THE EXISTING FINISH ELEVATION. DEMOLITION TAGS: INDICATE THE LOCATION OF ALL EXISTING GRAVEL IN PLACE DEMOLITION TO BE DEMOLISHED. THE CONTRACTOR SHALL REMOVE ALL EXISTING GRAVEL IN PLACE DEMOLITION AND RECONSTRUCT TO THE EXISTING FINISH ELEVATION. DEMOLITION TAGS: INDICATE THE LOCATION OF ALL EXISTING REINFORCED CONCRETE, STEEL, ALUMINUM FRAMES, COMBINATION, AND OTHER CONCRETE TO BE DEMOLISHED. THE CONTRACTOR SHALL REMOVE ALL EXISTING REINFORCED CONCRETE, STEEL, ALUMINUM FRAMES, COMBINATION, AND OTHER CONCRETE AND RECONSTRUCT TO THE EXISTING FINISH ELEVATION. 	<p>NOT FOR CONSTRUCTION</p>	<p>rasARRANT architects 101 402 2nd Street, Lexington, Kentucky, 40502 606.254.4218</p>
<p>SD0.2</p>	<p>OVERALL SITE DEMOLITION PLAN</p>	<p>OVERALL SITE DEMOLITION PLAN MARION COUNTY ATC - RENOVATION & ADDITION FOR: MARION COUNTY BOARD OF EDUCATION LEBANON, KENTUCKY</p>	<p>DATE: 08/20/2013 DRAWN BY: J. HARRIS CHECKED BY: J. HARRIS APPROVED BY: J. HARRIS</p>	<p>DATE: 08/20/2013 DRAWN BY: J. HARRIS CHECKED BY: J. HARRIS APPROVED BY: J. HARRIS</p>



SITE DEMOLITION PLAN
SCALE: 1" = 20'

GENERAL SITE NOTES

1. THE CONTRACTOR SHALL BE RESPONSIBLE FOR OBTAINING ALL NECESSARY PERMITS AND APPROVALS FROM THE MARION COUNTY BOARD OF EDUCATION AND THE MARION COUNTY BOARD OF ZONING AND PLANNING.
2. THE CONTRACTOR SHALL BE RESPONSIBLE FOR OBTAINING ALL NECESSARY PERMITS AND APPROVALS FROM THE MARION COUNTY BOARD OF EDUCATION AND THE MARION COUNTY BOARD OF ZONING AND PLANNING.
3. THE CONTRACTOR SHALL BE RESPONSIBLE FOR OBTAINING ALL NECESSARY PERMITS AND APPROVALS FROM THE MARION COUNTY BOARD OF EDUCATION AND THE MARION COUNTY BOARD OF ZONING AND PLANNING.
4. THE CONTRACTOR SHALL BE RESPONSIBLE FOR OBTAINING ALL NECESSARY PERMITS AND APPROVALS FROM THE MARION COUNTY BOARD OF EDUCATION AND THE MARION COUNTY BOARD OF ZONING AND PLANNING.
5. THE CONTRACTOR SHALL BE RESPONSIBLE FOR OBTAINING ALL NECESSARY PERMITS AND APPROVALS FROM THE MARION COUNTY BOARD OF EDUCATION AND THE MARION COUNTY BOARD OF ZONING AND PLANNING.

SITE DEMOLITION TAGS

- 1. ASBESTOS
- 2. LEAD
- 3. PCB
- 4. HAZARDOUS WASTE
- 5. ...

LEGEND

- CONCRETE WALL
- ASPHALT
- FRAMING STUDS
- ...


SITE DEMOLITION PLAN
MARION COUNTY ATC - RENOVATION & ADDITION
FOR:
MARION COUNTY BOARD OF EDUCATION
LEBANON, KENTUCKY

rosstarrant architects
a MORE+ap brand
101 28th Street, Suite 200, Lexington, KY 40502 | 606.254.4158

NOT FOR CONSTRUCTION

SD0.3

DATE: 08/20/2024
DRAWN BY: [Name]
CHECKED BY: [Name]
SCALE: 1" = 20'

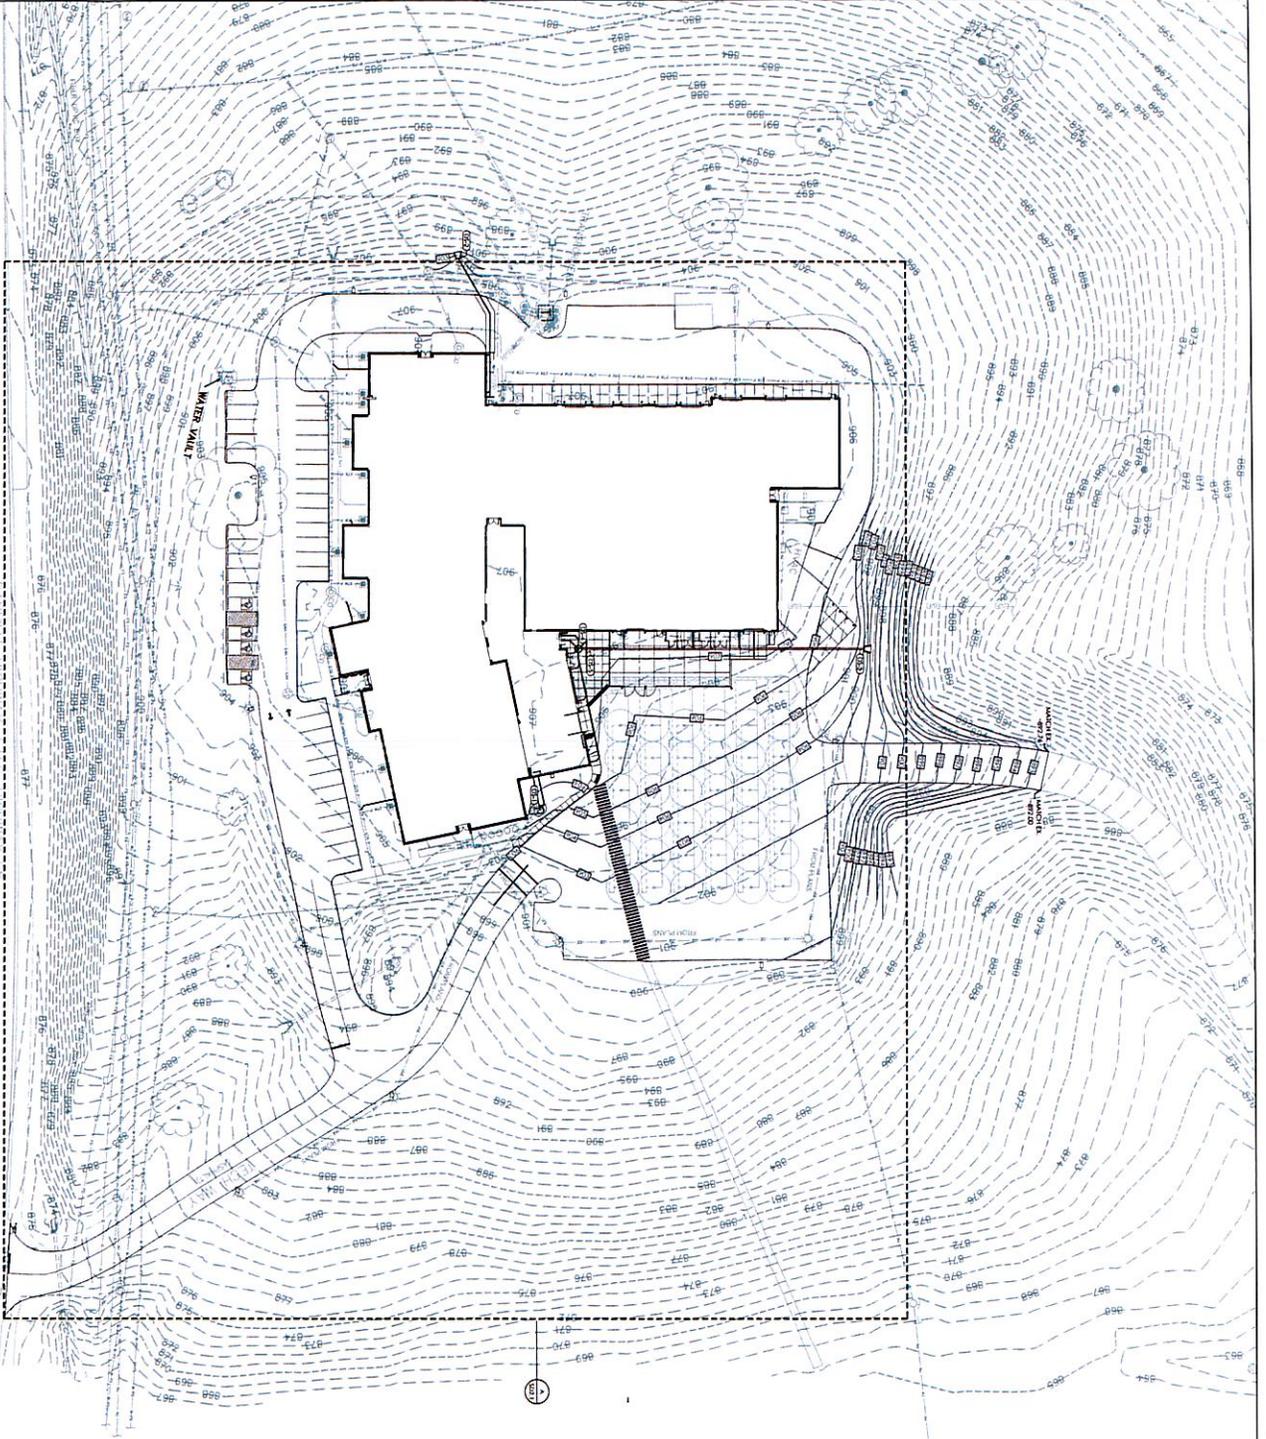

DANVILLE HIGHWAY / U.S. HIGHWAY 708

OVERALL SITE GRADING & DRAINAGE PLAN



GENERAL SITE NOTES

1. THE CONTRACTOR SHALL VERIFY LOCATION AND DEPTH OF ALL EXISTING UTILITIES PRIOR TO CONSTRUCTION. ALL UTILITIES SHALL BE PROTECTED AND DEEPENED AS NECESSARY TO PREVENT DAMAGE TO EXISTING UTILITIES.
2. THE CONTRACTOR SHALL MAINTAIN ALL EXISTING UTILITIES AND SHALL BE RESPONSIBLE FOR ANY DAMAGE TO EXISTING UTILITIES.
3. THE CONTRACTOR SHALL MAINTAIN ALL EXISTING UTILITIES AND SHALL BE RESPONSIBLE FOR ANY DAMAGE TO EXISTING UTILITIES.
4. THE CONTRACTOR SHALL MAINTAIN ALL EXISTING UTILITIES AND SHALL BE RESPONSIBLE FOR ANY DAMAGE TO EXISTING UTILITIES.
5. THE CONTRACTOR SHALL MAINTAIN ALL EXISTING UTILITIES AND SHALL BE RESPONSIBLE FOR ANY DAMAGE TO EXISTING UTILITIES.

SITE GRADING NOTES

1. ALL EXISTING GRADE SHALL BE MAINTAINED UNLESS OTHERWISE NOTED.
2. ALL EXISTING GRADE SHALL BE MAINTAINED UNLESS OTHERWISE NOTED.
3. ALL EXISTING GRADE SHALL BE MAINTAINED UNLESS OTHERWISE NOTED.
4. ALL EXISTING GRADE SHALL BE MAINTAINED UNLESS OTHERWISE NOTED.
5. ALL EXISTING GRADE SHALL BE MAINTAINED UNLESS OTHERWISE NOTED.

SITE STORM DRAINAGE NOTES

1. THE CONTRACTOR SHALL MAINTAIN ALL EXISTING STORM DRAINAGE SYSTEMS.
2. THE CONTRACTOR SHALL MAINTAIN ALL EXISTING STORM DRAINAGE SYSTEMS.
3. THE CONTRACTOR SHALL MAINTAIN ALL EXISTING STORM DRAINAGE SYSTEMS.
4. THE CONTRACTOR SHALL MAINTAIN ALL EXISTING STORM DRAINAGE SYSTEMS.
5. THE CONTRACTOR SHALL MAINTAIN ALL EXISTING STORM DRAINAGE SYSTEMS.

LEGEND

- (S) EXISTING STRUCTURE, EXISTING SYSTEM
- (D) EXISTING DRAINAGE, EXISTING SYSTEM
- (P) PROPOSED STRUCTURE, PROPOSED SYSTEM
- (PD) PROPOSED DRAINAGE, PROPOSED SYSTEM

SPOT ELEVATION LEGEND

1. SPOT ELEVATION

2. SPOT ELEVATION

3. SPOT ELEVATION

4. SPOT ELEVATION

5. SPOT ELEVATION

CONTRACTOR'S CHECKLIST

1. []

2. []

3. []

4. []

5. []

SD2.0

1. []

2. []

3. []

4. []

5. []

NOT FOR CONSTRUCTION

rosstarrant architects

101 10th Avenue, Lexington, Kentucky 40502 | 603.254.4018

OVERALL SITE GRADING & DRAINAGE PLAN
MARION COUNTY ATC - RENOVATION & ADDITION
FOR
MARION COUNTY BOARD OF EDUCATION
LEBANON, KENTUCKY

DATE: 08/25/24

PROJECT: MARION COUNTY ATC RENOVATION & ADDITION

SCALE: AS SHOWN


DESIGNED BY: []

CHECKED BY: []

DATE: 08/25/24

PROJECT NO: []

DATE: 08/25/24

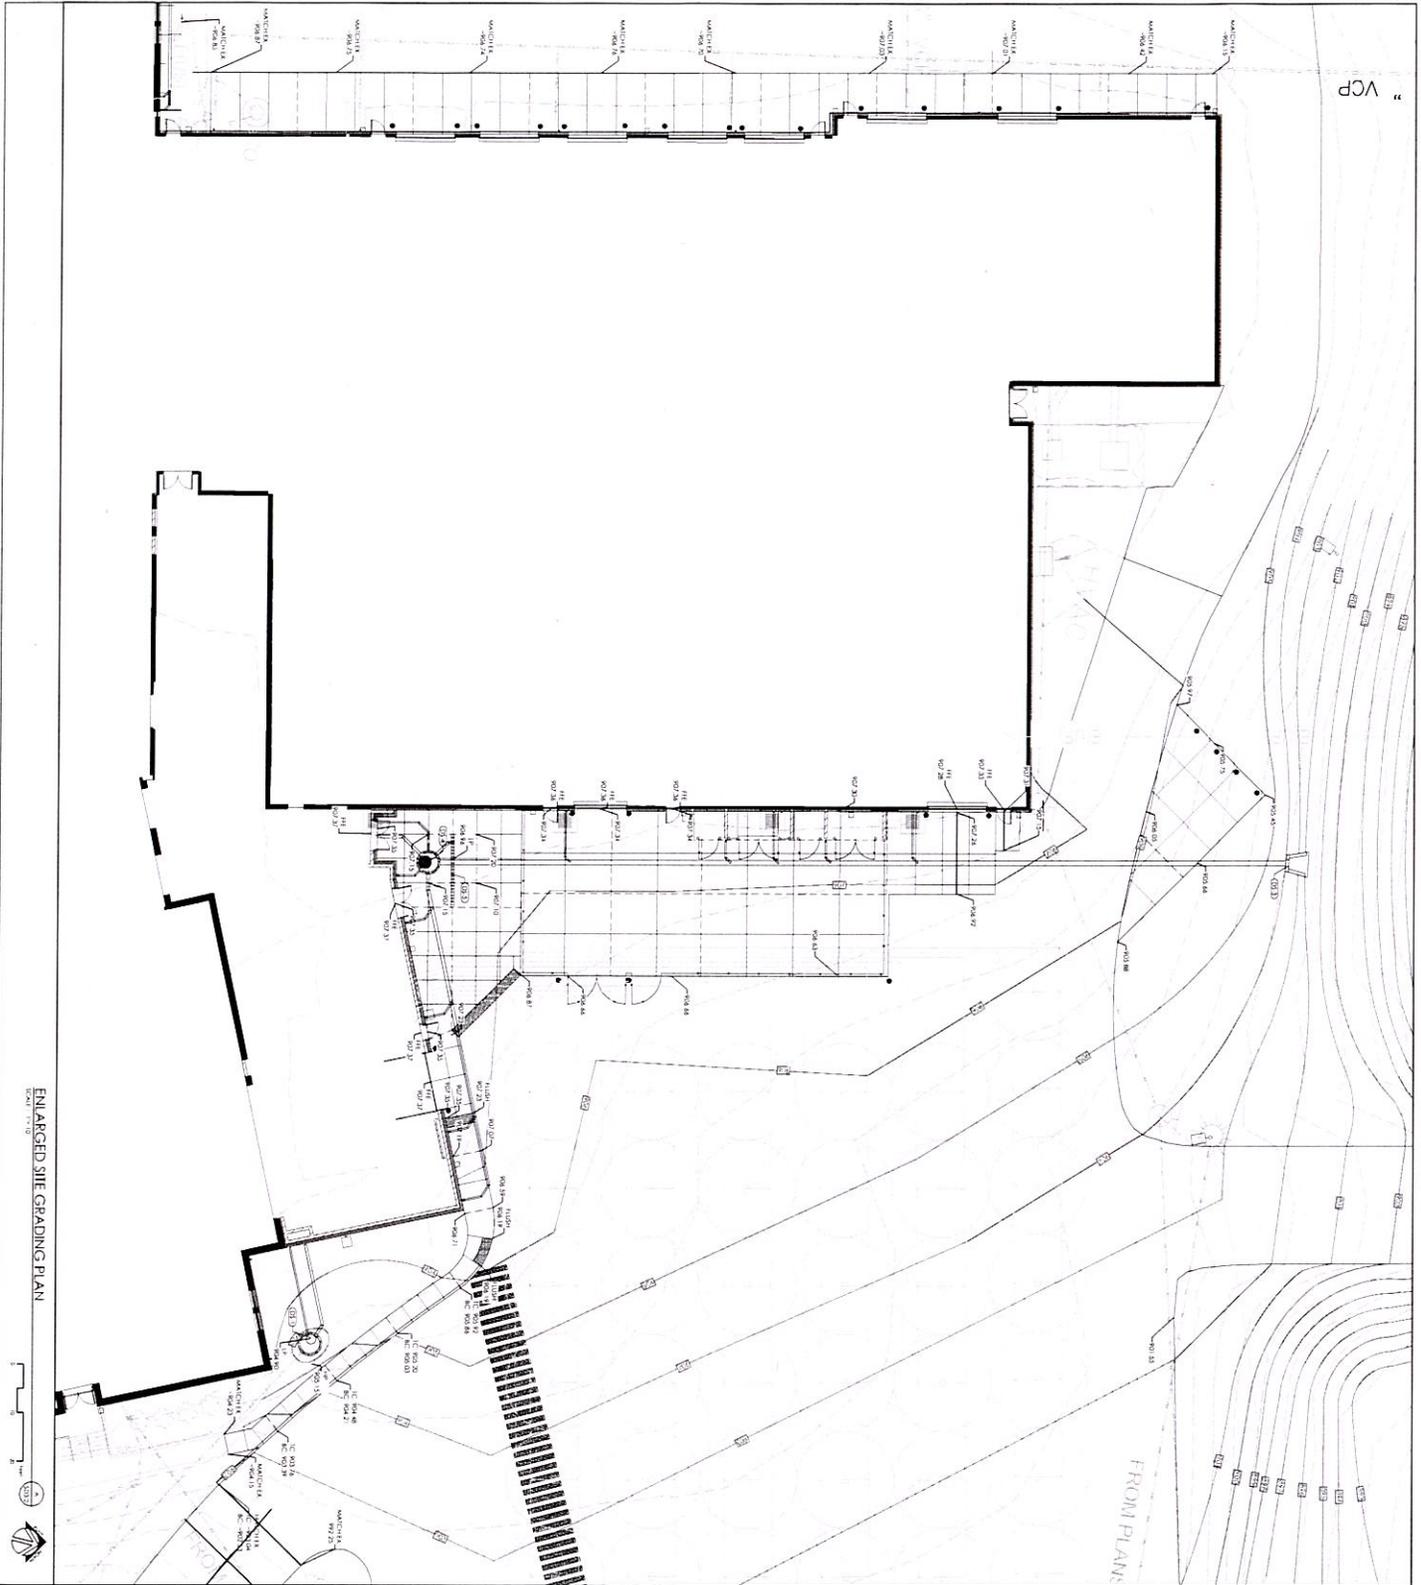

VCP

FROM PLANS

ENLARGED SITE GRADING PLAN

GENERAL SITE NOTES

1. ALL EXISTING UTILITIES SHOWN ON THIS PLAN ARE TO BE MAINTAINED AND PROTECTED. ANY UNIDENTIFIED UTILITIES SHALL BE LOCATED AND DELETED PRIOR TO CONSTRUCTION.
2. EXISTING UTILITIES SHALL BE MAINTAINED AND PROTECTED. ANY UNIDENTIFIED UTILITIES SHALL BE LOCATED AND DELETED PRIOR TO CONSTRUCTION.
3. ALL EXISTING UTILITIES SHALL BE MAINTAINED AND PROTECTED. ANY UNIDENTIFIED UTILITIES SHALL BE LOCATED AND DELETED PRIOR TO CONSTRUCTION.
4. ALL EXISTING UTILITIES SHALL BE MAINTAINED AND PROTECTED. ANY UNIDENTIFIED UTILITIES SHALL BE LOCATED AND DELETED PRIOR TO CONSTRUCTION.
5. ALL EXISTING UTILITIES SHALL BE MAINTAINED AND PROTECTED. ANY UNIDENTIFIED UTILITIES SHALL BE LOCATED AND DELETED PRIOR TO CONSTRUCTION.

SITE GRADING NOTES

1. ALL EXISTING UTILITIES SHOWN ON THIS PLAN ARE TO BE MAINTAINED AND PROTECTED. ANY UNIDENTIFIED UTILITIES SHALL BE LOCATED AND DELETED PRIOR TO CONSTRUCTION.
2. EXISTING UTILITIES SHALL BE MAINTAINED AND PROTECTED. ANY UNIDENTIFIED UTILITIES SHALL BE LOCATED AND DELETED PRIOR TO CONSTRUCTION.
3. ALL EXISTING UTILITIES SHALL BE MAINTAINED AND PROTECTED. ANY UNIDENTIFIED UTILITIES SHALL BE LOCATED AND DELETED PRIOR TO CONSTRUCTION.
4. ALL EXISTING UTILITIES SHALL BE MAINTAINED AND PROTECTED. ANY UNIDENTIFIED UTILITIES SHALL BE LOCATED AND DELETED PRIOR TO CONSTRUCTION.
5. ALL EXISTING UTILITIES SHALL BE MAINTAINED AND PROTECTED. ANY UNIDENTIFIED UTILITIES SHALL BE LOCATED AND DELETED PRIOR TO CONSTRUCTION.

SPOT ELEVATION LEGEND

- 1. SPOT ELEVATION
- 2. SPOT ELEVATION
- 3. SPOT ELEVATION
- 4. SPOT ELEVATION
- 5. SPOT ELEVATION

NOT FOR CONSTRUCTION




ENLARGED SITE GRADING PLAN
 MARION COUNTY ATC - RENOVATION & ADDITION
 FOR
 MARION COUNTY BOARD OF EDUCATION
 LEBANON, KENTUCKY

REVISED
 DATE
 DRAWN BY
 CHECKED BY
 APPROVED BY

SD3.2

DATE
 3/20/20

VCP

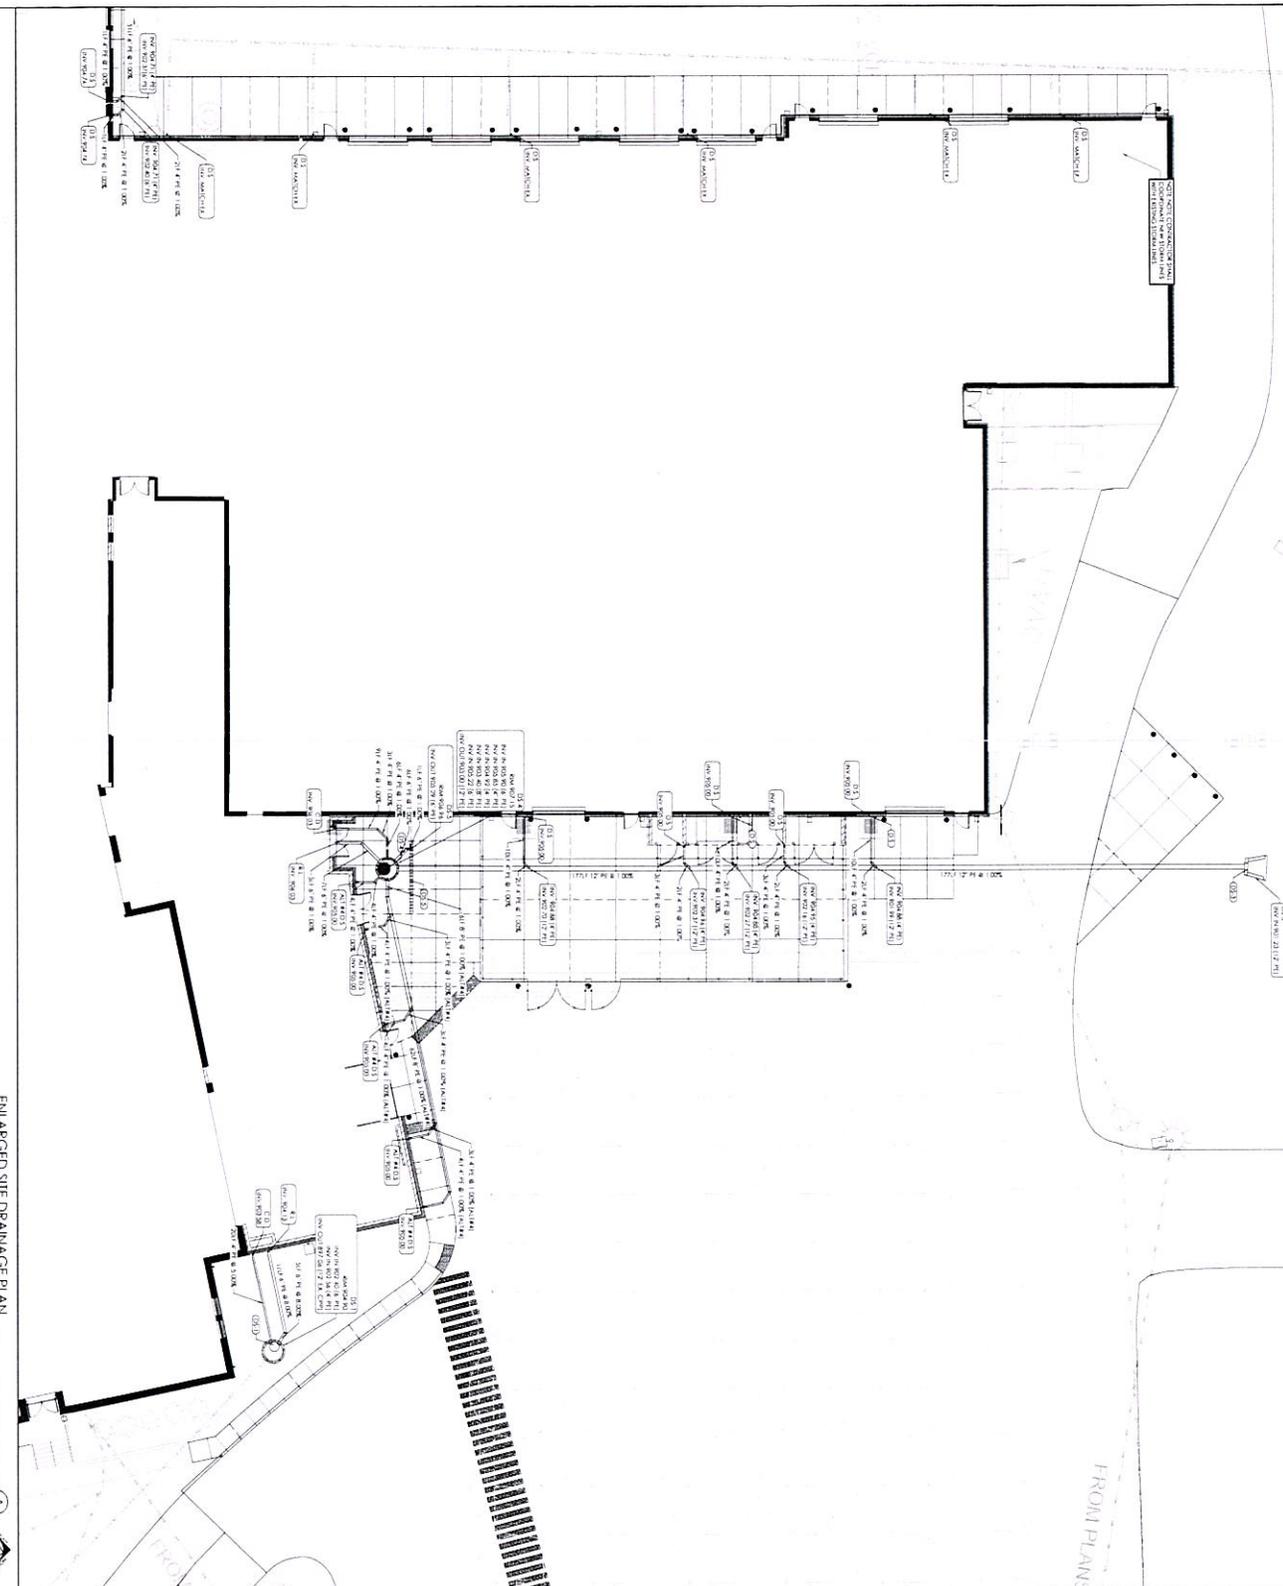

ENLARGED SITE DRAINAGE PLAN



GENERAL SITE NOTES

1. THE SITE AND ALL UTILITIES SHOWN ON THIS PLAN SHALL BE AS SHOWN ON THE SURVEY AND AS NOTED ON THE CONSTRUCTION OF THIS PLAN. THE CONTRACTOR SHALL VERIFY ALL UTILITIES SHOWN AND LOCATIONS OF ALL UTILITIES BEFORE ANY CONSTRUCTION BEGINS.
2. THE CONTRACTOR SHALL BE RESPONSIBLE FOR OBTAINING ALL NECESSARY PERMITS AND APPROVALS FROM ALL APPLICABLE AGENCIES AND AUTHORITIES.
3. THE CONTRACTOR SHALL BE RESPONSIBLE FOR OBTAINING ALL NECESSARY PERMITS AND APPROVALS FROM ALL APPLICABLE AGENCIES AND AUTHORITIES.
4. THE CONTRACTOR SHALL BE RESPONSIBLE FOR OBTAINING ALL NECESSARY PERMITS AND APPROVALS FROM ALL APPLICABLE AGENCIES AND AUTHORITIES.
5. THE CONTRACTOR SHALL BE RESPONSIBLE FOR OBTAINING ALL NECESSARY PERMITS AND APPROVALS FROM ALL APPLICABLE AGENCIES AND AUTHORITIES.

SITE STORM DRAINAGE NOTES

1. THE CONTRACTOR SHALL BE RESPONSIBLE FOR OBTAINING ALL NECESSARY PERMITS AND APPROVALS FROM ALL APPLICABLE AGENCIES AND AUTHORITIES.
2. THE CONTRACTOR SHALL BE RESPONSIBLE FOR OBTAINING ALL NECESSARY PERMITS AND APPROVALS FROM ALL APPLICABLE AGENCIES AND AUTHORITIES.
3. THE CONTRACTOR SHALL BE RESPONSIBLE FOR OBTAINING ALL NECESSARY PERMITS AND APPROVALS FROM ALL APPLICABLE AGENCIES AND AUTHORITIES.
4. THE CONTRACTOR SHALL BE RESPONSIBLE FOR OBTAINING ALL NECESSARY PERMITS AND APPROVALS FROM ALL APPLICABLE AGENCIES AND AUTHORITIES.
5. THE CONTRACTOR SHALL BE RESPONSIBLE FOR OBTAINING ALL NECESSARY PERMITS AND APPROVALS FROM ALL APPLICABLE AGENCIES AND AUTHORITIES.

LEGEND












- (3-D) DOWNSPOUT CONNECTION TO STORM DRAINAGE SYSTEM
- (3-D) DOWNSPOUT CONNECTION TO STORM DRAINAGE SYSTEM
- (3-D) DOWNSPOUT CONNECTION TO STORM DRAINAGE SYSTEM


NO.	DATE	DESCRIPTION
1	08/20/2013	ISSUED FOR PERMIT
2	08/20/2013	ISSUED FOR PERMIT
3	08/20/2013	ISSUED FOR PERMIT

ENLARGED SITE DRAINAGE PLAN
 MARION COUNTY ATC - RENOVATION & ADDITION
 FOR
 MARION COUNTY BOARD OF EDUCATION
 LEBANON, KENTUCKY


SD3.3
 8/20/2013

1. SEE PLAN FOR THE LOCATION OF THE MANHOLE. 2. SEE PLAN FOR THE LOCATION OF THE MANHOLE. 3. SEE PLAN FOR THE LOCATION OF THE MANHOLE. 4. SEE PLAN FOR THE LOCATION OF THE MANHOLE.

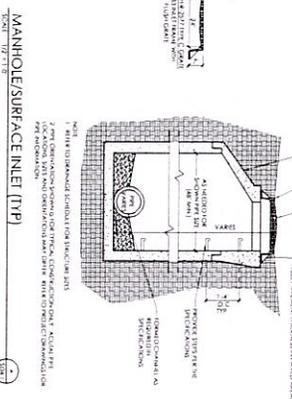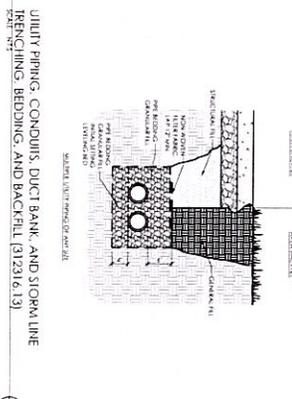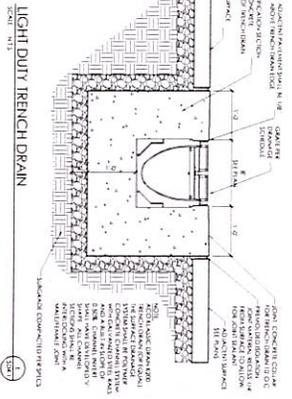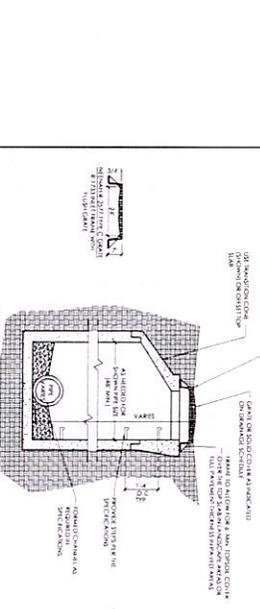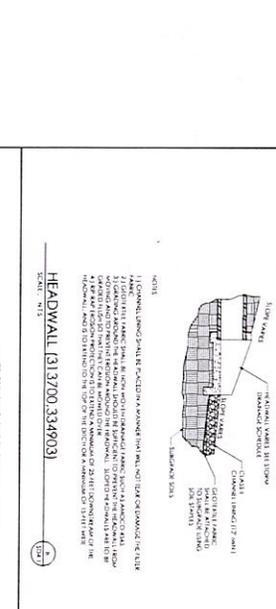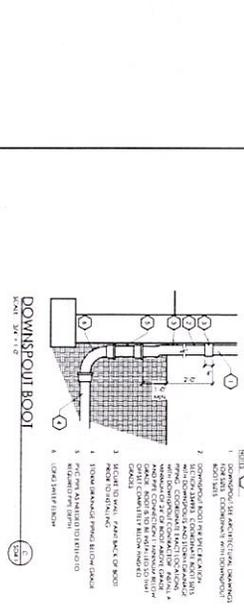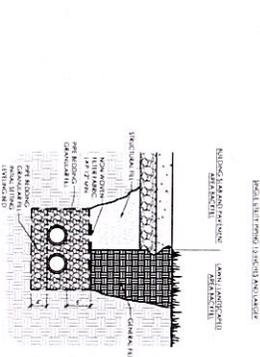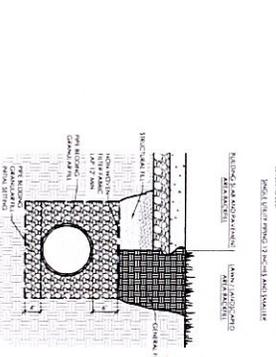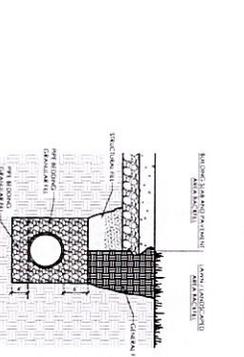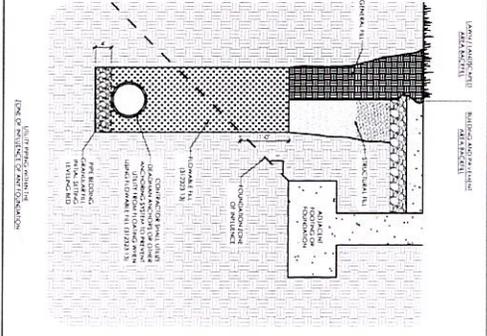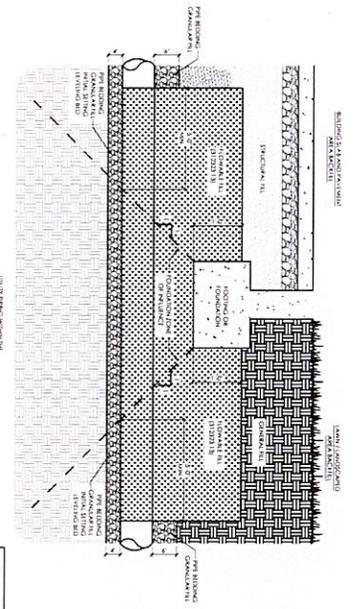


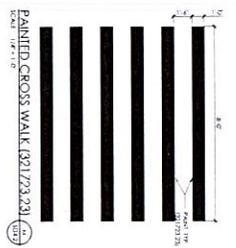


PAINED CROSS WALK (32123.23)
SCALE: 1" = 1'-0"

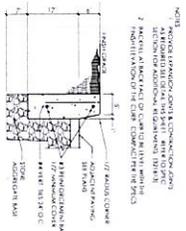


CONCRETE HEADR CURB (321613)
SCALE: 1" = 1'-0"

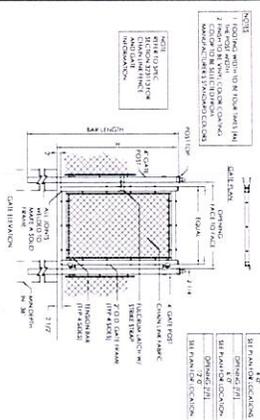


VINYL COATED CHAIN LINK PEDESTRIAN GATE (323113)
SCALE: 1" = 1'-0"

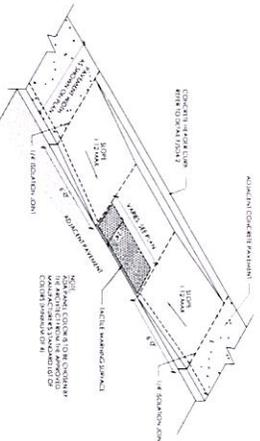


ACCESSIBLE DROPPED CURB - TYPE B
SCALE: 1" = 1'-0"

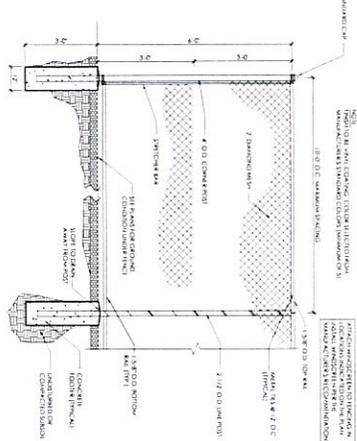


6' HEIGHT VINYL COATED CHAIN LINK FENCE (323113)
SCALE: 1" = 1'-0"

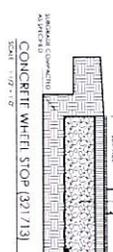


CONCRETE WHEEL STOP (321713)
SCALE: 1" = 1'-0"

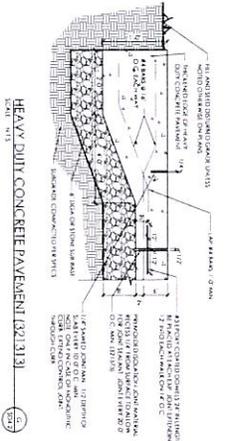


HEAVY DUTY CONCRETE PAVEMENT (321313)
SCALE: 1" = 1'-0"

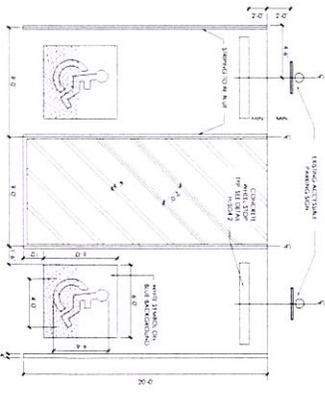


ACCESSIBLE PAVEMENT MARKINGS
SCALE: 1" = 1'-0"

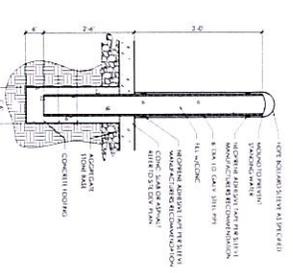


CONCRETE BUILT-UP LAMP (323136)
SCALE: 1" = 1'-0"

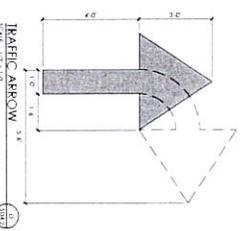


TRAFFIC ARROW 3'6"
SCALE: 1" = 1'-0"

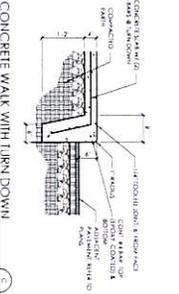

CONCRETE WALK WITH TURN DOWN
SCALE: 3/4" = 1'-0"

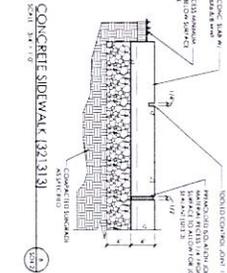

CONCRETE SIDEWALK (321318)
SCALE: 3/4" = 1'-0"

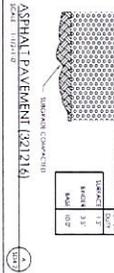

ASPHALT PAVEMENT (321216)
SCALE: 1" = 1'-0"

STRUCTURAL NOTES

THE STRUCTURAL NOTES SET FORTH DESIGN AND MATERIAL REQUIREMENTS AND ARE INTENDED TO SUPPLEMENT, BUT NOT REPLACE, THE PROJECT SPECIFICATIONS.

1. BUILDING CODES

1. Building Code: 2018 Kentucky Building Code and ASCE 7-10 (except Chapter 14 and Appendix 11A)

1.1 Building Risk Category: III

2. DESIGN LOADS

2.1 Uniform Floor Live Loads (Reduced per Building Code, 1000)

2.2 Dead Loads

2.2.1 Uniform Roof Live Load

2.2.2 Snow Loads

2.2.3 Wind Loads

2.2.4 Rain Loads

2.2.5 Seismic Loads

2.2.6 Lateral Loads

2.2.7 Impact Loads

2.2.8 Other Loads

2.2.9 Miscellaneous Loads

2.2.10 Special Loads

2.2.11 Other Loads

2.2.12 Other Loads

2.2.13 Other Loads

2.2.14 Other Loads

2.2.15 Other Loads

2.2.16 Other Loads

2.2.17 Other Loads

2.2.18 Other Loads

2.2.19 Other Loads

2.2.20 Other Loads

2.2.21 Other Loads

2.2.22 Other Loads

2.2.23 Other Loads

2.2.24 Other Loads

2.2.25 Other Loads

2.2.26 Other Loads

2.2.27 Other Loads

2.2.28 Other Loads

2.2.29 Other Loads

2.2.30 Other Loads

2.2.31 Other Loads

2.2.32 Other Loads

2.2.33 Other Loads

2.2.34 Other Loads

2.2.35 Other Loads

2.2.36 Other Loads

3. MATERIALS

3.1 Shop Drawings and Submittals

3.1.1 Reproduction of Structural Drawings for shop drawings is not permitted.

3.1.2 Electronic drawing files will not be provided to the contractor.

3.1.3 Review of shop drawings will be for conformance with the construction documents, regarding arrangement and sizes of members and the contractor's interpretation of the drawings. The contractor shall be responsible for the full responsibility to comply with the construction documents.

3.2 Submittals

3.2.1 The Structural Quality Assurance Plan and Specifications identify the required submittals. Prior to the start of construction, the contractor shall submit a list of all submittals to submittals@shps-structure.com

3.2.2 All submittals to submittals@shps-structure.com

3.2.3 All submittals to submittals@shps-structure.com

3.2.4 All submittals to submittals@shps-structure.com

3.2.5 All submittals to submittals@shps-structure.com

3.2.6 All submittals to submittals@shps-structure.com

3.2.7 All submittals to submittals@shps-structure.com

3.2.8 All submittals to submittals@shps-structure.com

3.2.9 All submittals to submittals@shps-structure.com

3.2.10 All submittals to submittals@shps-structure.com

3.2.11 All submittals to submittals@shps-structure.com

3.2.12 All submittals to submittals@shps-structure.com

3.2.13 All submittals to submittals@shps-structure.com

3.2.14 All submittals to submittals@shps-structure.com

3.2.15 All submittals to submittals@shps-structure.com

3.2.16 All submittals to submittals@shps-structure.com

3.2.17 All submittals to submittals@shps-structure.com

3.2.18 All submittals to submittals@shps-structure.com

3.2.19 All submittals to submittals@shps-structure.com

3.2.20 All submittals to submittals@shps-structure.com

3.2.21 All submittals to submittals@shps-structure.com

3.2.22 All submittals to submittals@shps-structure.com

3.2.23 All submittals to submittals@shps-structure.com

3.2.24 All submittals to submittals@shps-structure.com

3.2.25 All submittals to submittals@shps-structure.com

3.2.26 All submittals to submittals@shps-structure.com

3.2.27 All submittals to submittals@shps-structure.com

3.2.28 All submittals to submittals@shps-structure.com

3.2.29 All submittals to submittals@shps-structure.com

3.2.30 All submittals to submittals@shps-structure.com

3.2.31 All submittals to submittals@shps-structure.com

3.2.32 All submittals to submittals@shps-structure.com

3.2.33 All submittals to submittals@shps-structure.com

3.2.34 All submittals to submittals@shps-structure.com

3.2.35 All submittals to submittals@shps-structure.com

3.2.36 All submittals to submittals@shps-structure.com

3.2.37 All submittals to submittals@shps-structure.com

4. CONCRETE

4.1 Normal weight Structural Concrete

4.1.1 Normal weight Structural Concrete

4.1.2 Normal weight Structural Concrete

4.1.3 Normal weight Structural Concrete

4.1.4 Normal weight Structural Concrete

4.1.5 Normal weight Structural Concrete

4.1.6 Normal weight Structural Concrete

4.1.7 Normal weight Structural Concrete

4.1.8 Normal weight Structural Concrete

4.1.9 Normal weight Structural Concrete

4.1.10 Normal weight Structural Concrete

4.1.11 Normal weight Structural Concrete

4.1.12 Normal weight Structural Concrete

4.1.13 Normal weight Structural Concrete

4.1.14 Normal weight Structural Concrete

4.1.15 Normal weight Structural Concrete

4.1.16 Normal weight Structural Concrete

4.1.17 Normal weight Structural Concrete

4.1.18 Normal weight Structural Concrete

4.1.19 Normal weight Structural Concrete

4.1.20 Normal weight Structural Concrete

4.1.21 Normal weight Structural Concrete

4.1.22 Normal weight Structural Concrete

4.1.23 Normal weight Structural Concrete

4.1.24 Normal weight Structural Concrete

4.1.25 Normal weight Structural Concrete

4.1.26 Normal weight Structural Concrete

4.1.27 Normal weight Structural Concrete

4.1.28 Normal weight Structural Concrete

4.1.29 Normal weight Structural Concrete

4.1.30 Normal weight Structural Concrete

4.1.31 Normal weight Structural Concrete

4.1.32 Normal weight Structural Concrete

4.1.33 Normal weight Structural Concrete

4.1.34 Normal weight Structural Concrete

4.1.35 Normal weight Structural Concrete

4.1.36 Normal weight Structural Concrete

4.1.37 Normal weight Structural Concrete

4.1.38 Normal weight Structural Concrete

4.1.39 Normal weight Structural Concrete

4.1.40 Normal weight Structural Concrete

4.1.41 Normal weight Structural Concrete

5. REINFORCEMENT

5.1 Reinforcing Bars: ASTM A63, Grade 60

5.1.1 Reinforcing Bars: ASTM A63, Grade 60

5.1.2 Reinforcing Bars: ASTM A63, Grade 60

5.1.3 Reinforcing Bars: ASTM A63, Grade 60

5.1.4 Reinforcing Bars: ASTM A63, Grade 60

5.1.5 Reinforcing Bars: ASTM A63, Grade 60

5.1.6 Reinforcing Bars: ASTM A63, Grade 60

5.1.7 Reinforcing Bars: ASTM A63, Grade 60

5.1.8 Reinforcing Bars: ASTM A63, Grade 60

5.1.9 Reinforcing Bars: ASTM A63, Grade 60

5.1.10 Reinforcing Bars: ASTM A63, Grade 60

5.1.11 Reinforcing Bars: ASTM A63, Grade 60

5.1.12 Reinforcing Bars: ASTM A63, Grade 60

5.1.13 Reinforcing Bars: ASTM A63, Grade 60

5.1.14 Reinforcing Bars: ASTM A63, Grade 60

5.1.15 Reinforcing Bars: ASTM A63, Grade 60

5.1.16 Reinforcing Bars: ASTM A63, Grade 60

5.1.17 Reinforcing Bars: ASTM A63, Grade 60

5.1.18 Reinforcing Bars: ASTM A63, Grade 60

5.1.19 Reinforcing Bars: ASTM A63, Grade 60

5.1.20 Reinforcing Bars: ASTM A63, Grade 60

5.1.21 Reinforcing Bars: ASTM A63, Grade 60

5.1.22 Reinforcing Bars: ASTM A63, Grade 60

5.1.23 Reinforcing Bars: ASTM A63, Grade 60

5.1.24 Reinforcing Bars: ASTM A63, Grade 60

5.1.25 Reinforcing Bars: ASTM A63, Grade 60

5.1.26 Reinforcing Bars: ASTM A63, Grade 60

5.1.27 Reinforcing Bars: ASTM A63, Grade 60

5.1.28 Reinforcing Bars: ASTM A63, Grade 60

5.1.29 Reinforcing Bars: ASTM A63, Grade 60

5.1.30 Reinforcing Bars: ASTM A63, Grade 60

5.1.31 Reinforcing Bars: ASTM A63, Grade 60

5.1.32 Reinforcing Bars: ASTM A63, Grade 60

5.1.33 Reinforcing Bars: ASTM A63, Grade 60

5.1.34 Reinforcing Bars: ASTM A63, Grade 60

5.1.35 Reinforcing Bars: ASTM A63, Grade 60

5.1.36 Reinforcing Bars: ASTM A63, Grade 60

5.1.37 Reinforcing Bars: ASTM A63, Grade 60

5.1.38 Reinforcing Bars: ASTM A63, Grade 60

5.1.39 Reinforcing Bars: ASTM A63, Grade 60

5.1.40 Reinforcing Bars: ASTM A63, Grade 60

5.1.41 Reinforcing Bars: ASTM A63, Grade 60

6. STEEL

6.1 Structural Steel

6.1.1 Structural Steel

6.1.2 Structural Steel

6.1.3 Structural Steel

6.1.4 Structural Steel

6.1.5 Structural Steel

6.1.6 Structural Steel

6.1.7 Structural Steel

6.1.8 Structural Steel

6.1.9 Structural Steel

6.1.10 Structural Steel

6.1.11 Structural Steel

6.1.12 Structural Steel

6.1.13 Structural Steel

6.1.14 Structural Steel

6.1.15 Structural Steel

6.1.16 Structural Steel

6.1.17 Structural Steel

6.1.18 Structural Steel

6.1.19 Structural Steel

6.1.20 Structural Steel

6.1.21 Structural Steel

6.1.22 Structural Steel

6.1.23 Structural Steel

6.1.24 Structural Steel

6.1.25 Structural Steel

6.1.26 Structural Steel

6.1.27 Structural Steel

6.1.28 Structural Steel

6.1.29 Structural Steel

6.1.30 Structural Steel

6.1.31 Structural Steel

6.1.32 Structural Steel

6.1.33 Structural Steel

6.1.34 Structural Steel

6.1.35 Structural Steel

6.1.36 Structural Steel

6.1.37 Structural Steel

6.1.38 Structural Steel

6.1.39 Structural Steel

6.1.40 Structural Steel

6.1.41 Structural Steel

7. WELDING

7.1 Welding

7.1.1 Welding

7.1.2 Welding

7.1.3 Welding

7.1.4 Welding

7.1.5 Welding

7.1.6 Welding

7.1.7 Welding

7.1.8 Welding

7.1.9 Welding

7.1.10 Welding

7.1.11 Welding

7.1.12 Welding

7.1.13 Welding

7.1.14 Welding

7.1.15 Welding

7.1.16 Welding

7.1.17 Welding

7.1.18 Welding

7.1.19 Welding

7.1.20 Welding

7.1.21 Welding

7.1.22 Welding

7.1.23 Welding

7.1.24 Welding

7.1.25 Welding

7.1.26 Welding

7.1.27 Welding

7.1.28 Welding

7.1.29 Welding

7.1.30 Welding


7.1.31 Welding

7.1.32 Welding

7.1.33 Welding

7.1.34 Welding

7.1.35 Welding

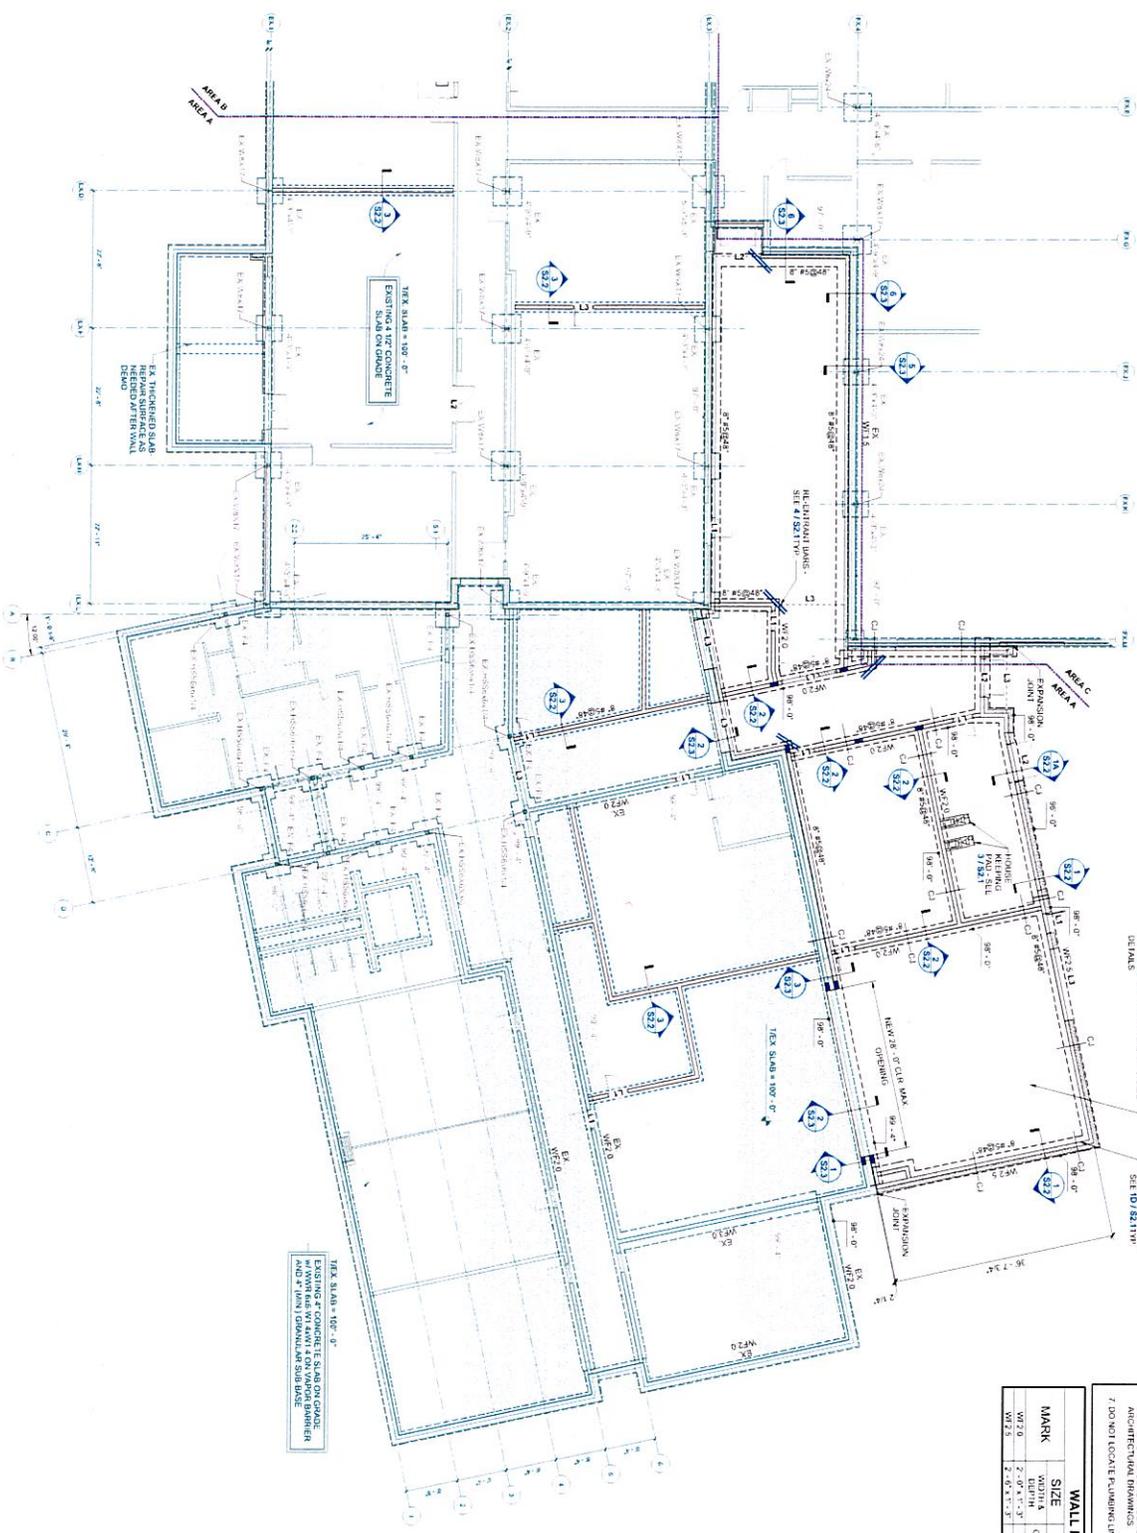

10'-0\"/>

10'-0\"/>


- FOUNDATION NOTES:**
1. WALL REINFORCEMENT FOR FULL HEIGHT OF WALLS IS INDICATED ON PLANS. SEE TYPICAL WALL REINFORCEMENT DETAIL FOR REINFORCEMENT REVISIONS AT GROUND LEVELS. CONCRETE WALL REINFORCEMENT JOINTS ARE:
 1. WALLS SHOWN ON PLAN WITHOUT REINFORCEMENT INDICATED TO HAVE REINFORCEMENT REVISIONS AS SHOWN IN THE TYPICAL WALL REINFORCEMENT DETAIL.
 2. WALLS SHOWN WITH REINFORCEMENT INDICATED TO HAVE REINFORCEMENT REVISIONS AS SHOWN IN THE TYPICAL WALL REINFORCEMENT DETAIL.
 2. ALL DIMENSIONS ARE TO BE KEPT WITHIN ARCHITECTURAL DIMENSIONS UNLESS OTHERWISE NOTED. SEE ARCHITECTURAL DIMENSIONS FOR LOCATION OF REINFORCEMENT JOINTS.
 3. ALL DIMENSIONS ARE TO BE KEPT WITHIN ARCHITECTURAL DIMENSIONS UNLESS OTHERWISE NOTED. SEE ARCHITECTURAL DIMENSIONS FOR LOCATION OF REINFORCEMENT JOINTS.
 4. DO NOT LOCATE REINFORCEMENT JOINTS WITHIN CONCRETE FOOTINGS.

WALL FOOTING SCHEDULE

MARK	SIZE	REINFORCEMENT	REMARKS
WF1.0	2'-0" x 3'-0"	CONCRETE	
WF2.0	2'-0" x 3'-0"	CONCRETE	

10'-0\"/>

FOUNDATION PLAN

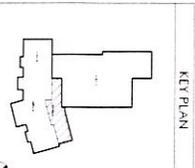

FOUNDATION PLAN
MARION COUNTY ATC - RENOVATION & ADDITION
 FOR
MARION COUNTY BOARD OF EDUCATION
 LEBANON, KENTUCKY



NOT FOR CONSTRUCTION







S1.1

DATE: 08/14/2024





PROJECT: MARION COUNTY ATC - RENOVATION & ADDITION

SCALE: AS SHOWN





NO. 29-341

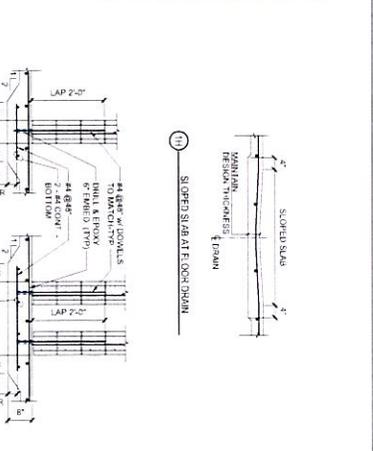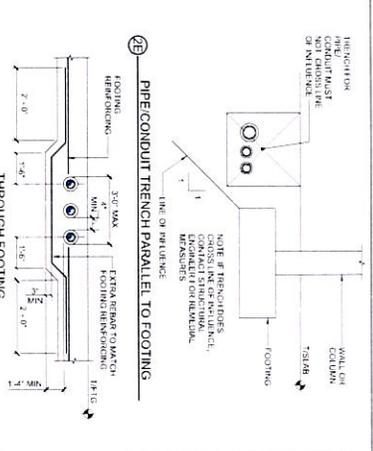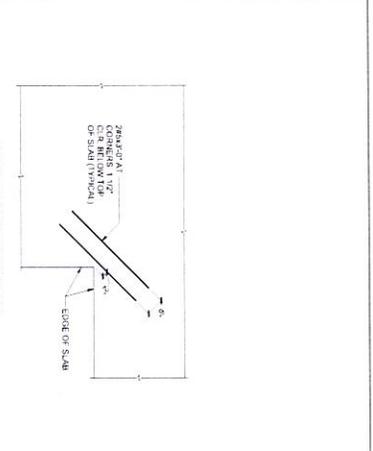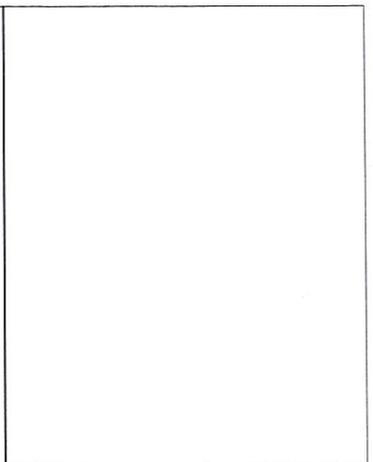





FOUNDATION SECTIONS AND DETAILS
 MARION COUNTY ATC - RENOVATION & ADDITION
 FOR
 MARION COUNTY BOARD OF EDUCATION
 LEBANON, KENTUCKY

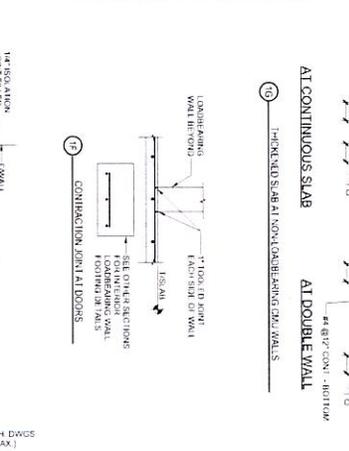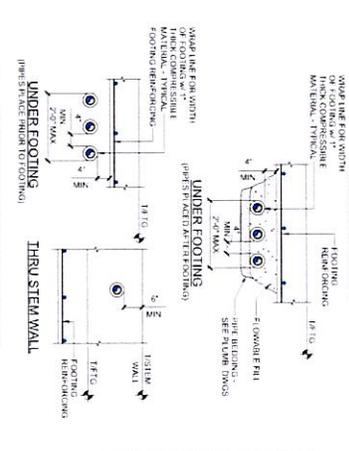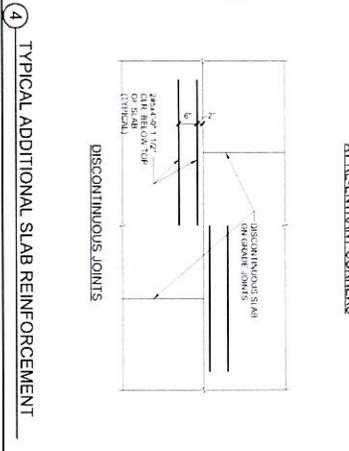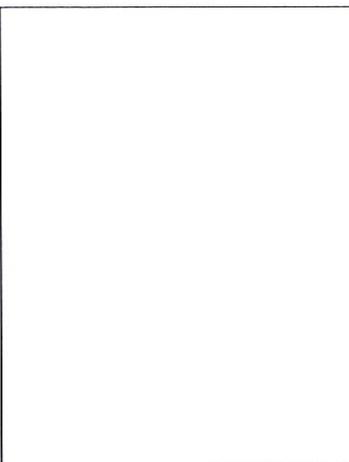

FOUNDATION SECTIONS AND DETAILS
 MARION COUNTY ATC - RENOVATION & ADDITION
 FOR
 MARION COUNTY BOARD OF EDUCATION
 LEBANON, KENTUCKY

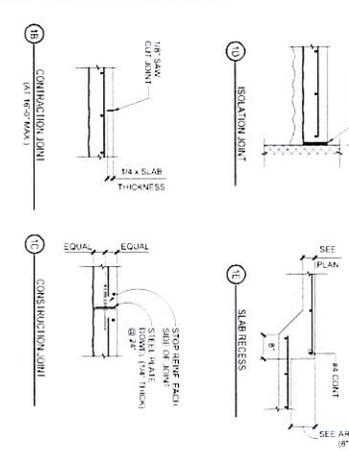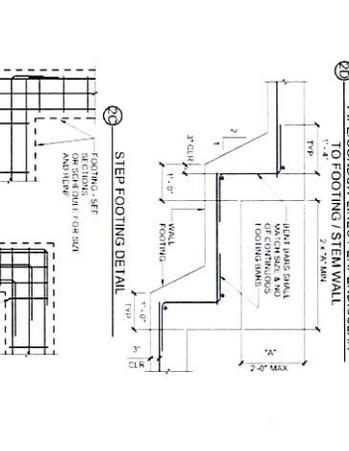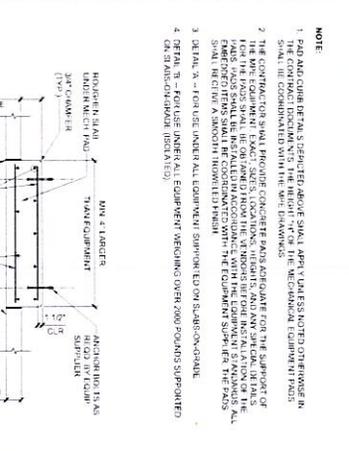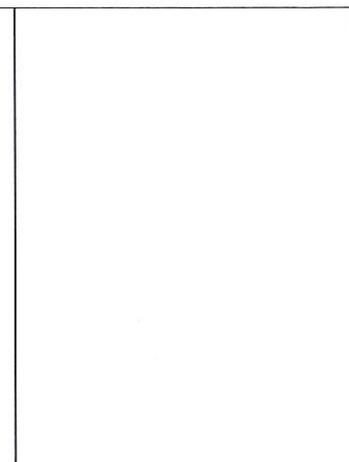

FOUNDATION SECTIONS AND DETAILS
 MARION COUNTY ATC - RENOVATION & ADDITION
 FOR
 MARION COUNTY BOARD OF EDUCATION
 LEBANON, KENTUCKY

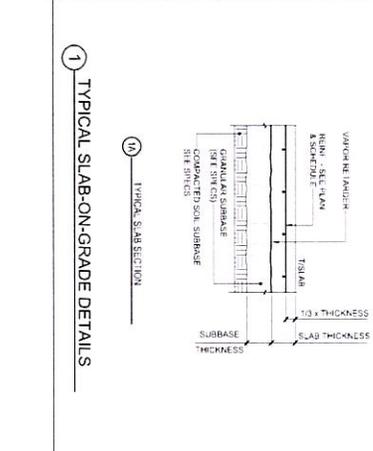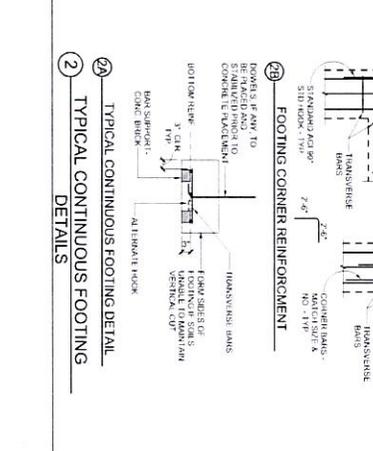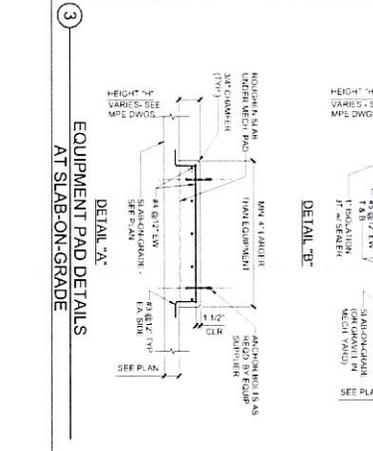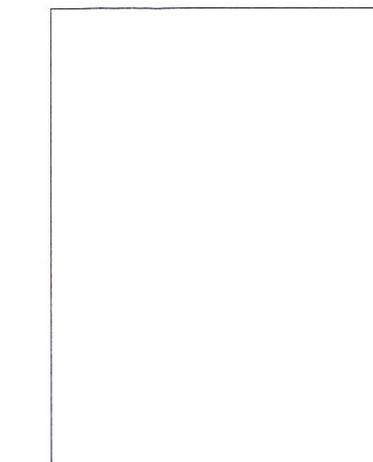

FOUNDATION SECTIONS AND DETAILS
 MARION COUNTY ATC - RENOVATION & ADDITION
 FOR
 MARION COUNTY BOARD OF EDUCATION
 LEBANON, KENTUCKY

NOT FOR CONSTRUCTION

rosstrant architects
 a HOK company

12100 KY 100, LEBANON, KY 40032-1000












FOUNDATION SECTIONS AND DETAILS
 MARION COUNTY ATC - RENOVATION & ADDITION
 FOR
 MARION COUNTY BOARD OF EDUCATION
 LEBANON, KENTUCKY

Structural Design Group
 12100 KY 100, LEBANON, KY 40032-1000

DATE: 08/25/2011

PROJECT: MARION COUNTY ATC - RENOVATION & ADDITION


NO. 52.1

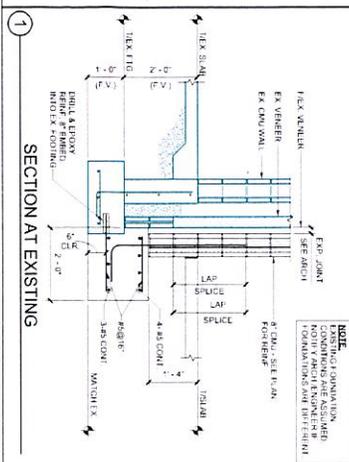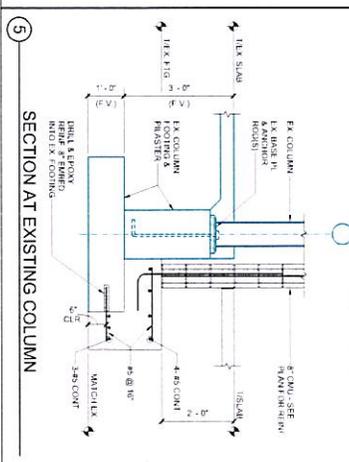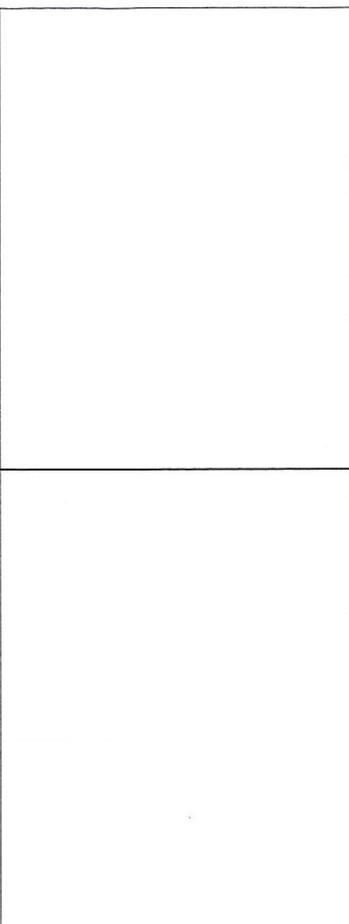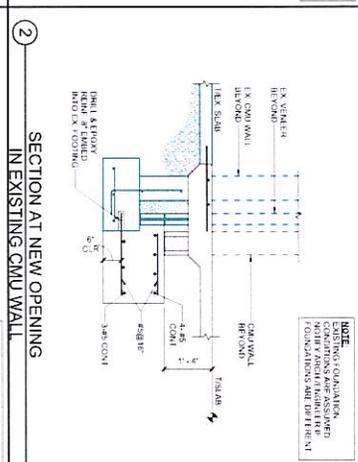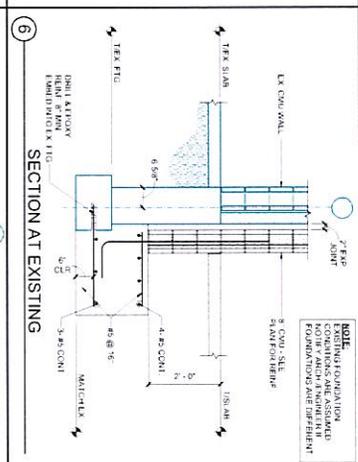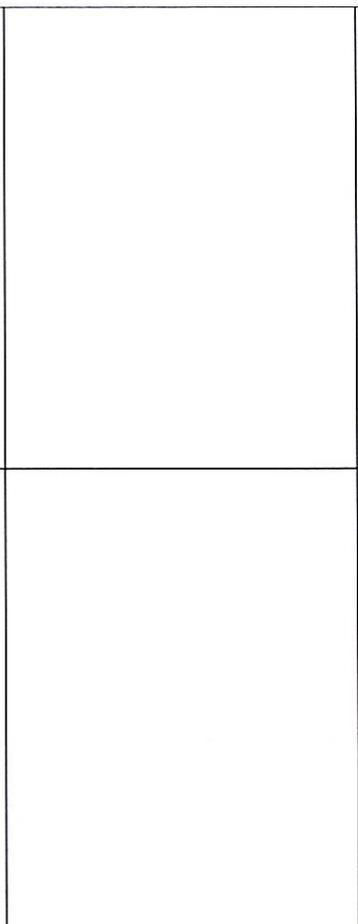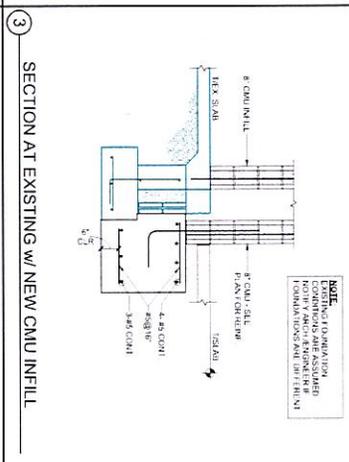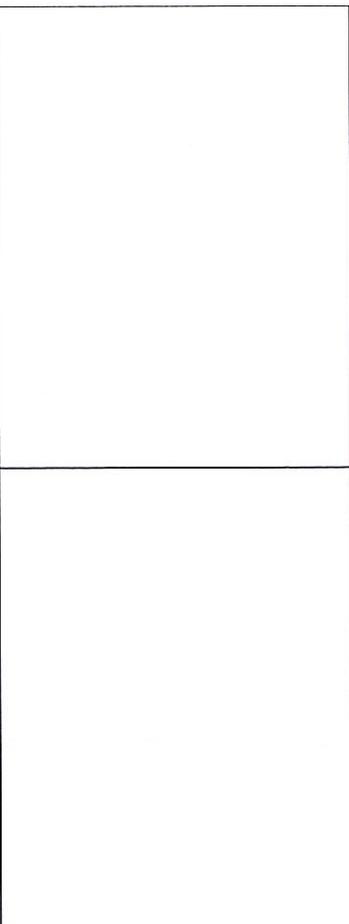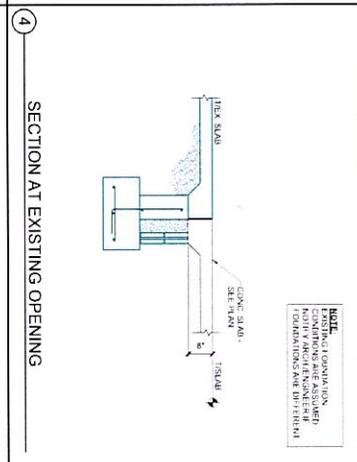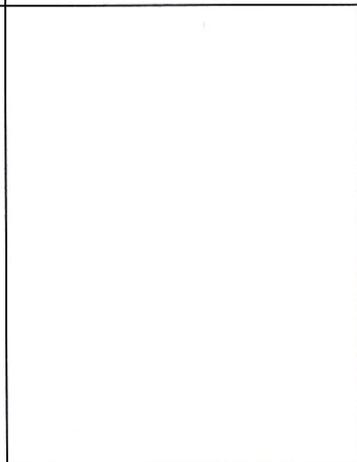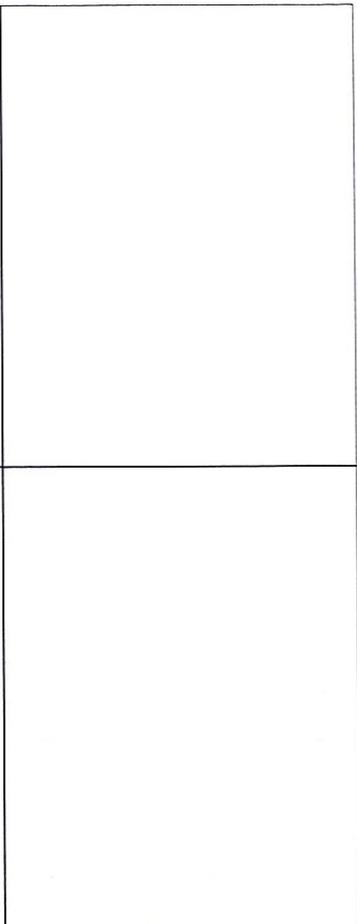

CMU LAP SPICE SCHEDULE

BLOCK SIZE	LAP LENGTH	
	INTERMEDIATE	ENDS
8" CMU	24"	24"
12" CMU	36"	36"
16" CMU	48"	48"
20" CMU	60"	60"
24" CMU	72"	72"
28" CMU	84"	84"
32" CMU	96"	96"
36" CMU	108"	108"
40" CMU	120"	120"
44" CMU	132"	132"
48" CMU	144"	144"


NOTE: # BARS ARE 1/4" DIA. REINFORCEMENT USE LAP LENGTHS SCHEDULE FOR THE BARS.

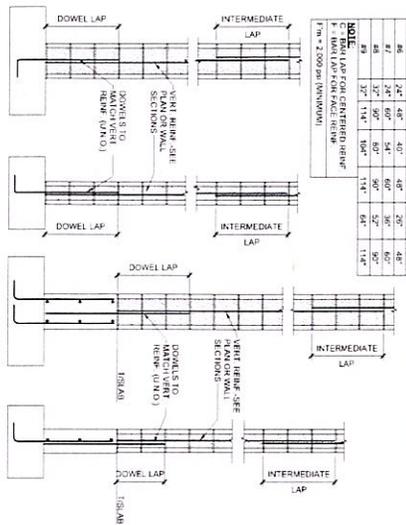


CMU REINFORCEMENT LAP SPICE SCHEDULE

1. LOCATE LOCATION OF CONTRACTION JOINTS AND STRUCTURAL NOTES FOR MAX. SPACING.
2. LOCATE CONTRACTION JOINTS 2'-0" MINIMUM FROM SIDES OF OPENINGS.
3. LOCATIONS ARE INTENDED TO COMPARE WITH CONCRETE SCHEDULE LOCATIONS OF CONTRACTION JOINTS.
4. SEE PLAN DRAWING FOR LOCATIONS OF BOND BEAMS.
5. DO NOT CONTRACT CONTRACTION JOINT THROUGH BOND BEAM AT THE FOLLOWING LOCATIONS: TOP WALL, 1' FROM THE END OF BOND BEAM, INTERMEDIATE BOND BEAMS, 1' FROM THE END OF BOND BEAM, 1' FROM THE END OF BOND BEAM.


CMU WALL CONTRACTION/CONTROL JOINT DETAIL

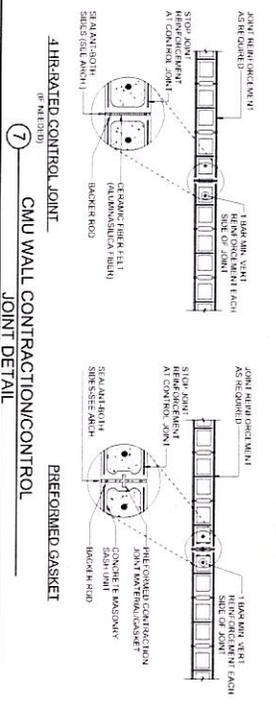


CMU WALL HORIZONTAL JOINT REINFORCEMENT DETAIL

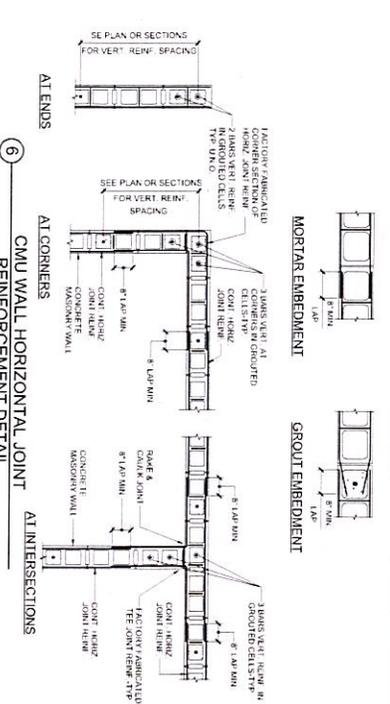


NON-CONTACT LAP SPICE DETAIL

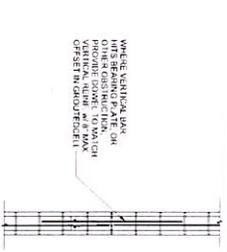


DOWEL-PERMITTED BENDING DETAIL

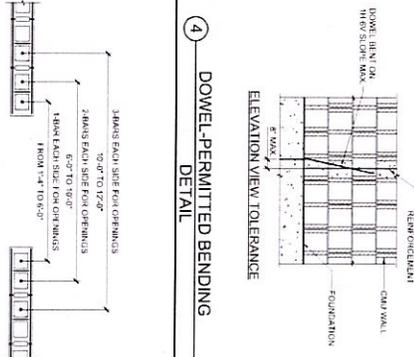


CMU WALL OPENING DETAIL

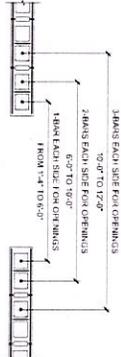

SLOPED BOND BEAM

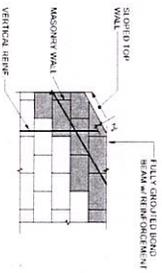


STEPPED BOND BEAM

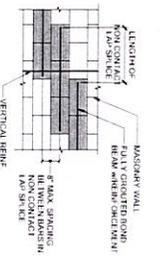


CMU BOND BEAM DETAILS

DOUBLE ROW REINFORCEMENT

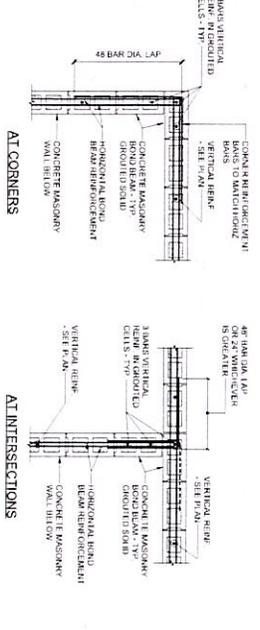

TYPICAL CMU WALL REINFORCING ELEVATION

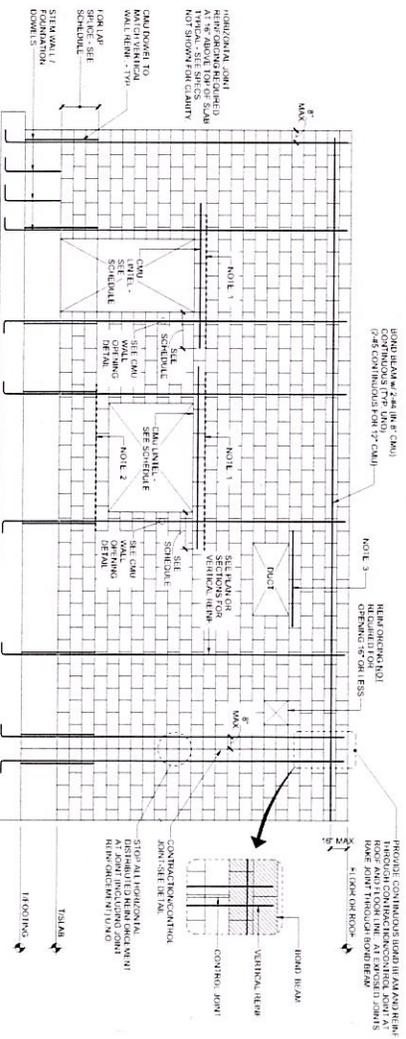

NOTE:
1. ADD HORIZONTAL JOINT REINFORCEMENT ABOVE UNTIL 1' FROM TOP OF EACH SIDE OF OPENING.
2. ADD HORIZONTAL JOINT REINFORCEMENT BELOW UNTIL 1' FROM BOTTOM OF EACH SIDE OF OPENING.
3. UNTIL OVERLAP OF BOND BEAM OVER UNFINISHED FOUNDATION.

MASONRY SECTIONS AND DETAILS
MARION COUNTY ATC - RENOVATION & ADDITION
FOR
MARION COUNTY BOARD OF EDUCATION
LEBANON, KENTUCKY







NOT FOR CONSTRUCTION
















rosstarr architects
a MORE.com brand

S3.1


NO. 22, 341	DATE: 01/15/2019
PROJECT: MARION COUNTY ATC - RENOVATION & ADDITION	DRAWN BY: J. W. HARRIS
CHECKED BY: J. W. HARRIS	DATE: 01/15/2019
SCALE: AS SHOWN	PROJECT NO: 19-001

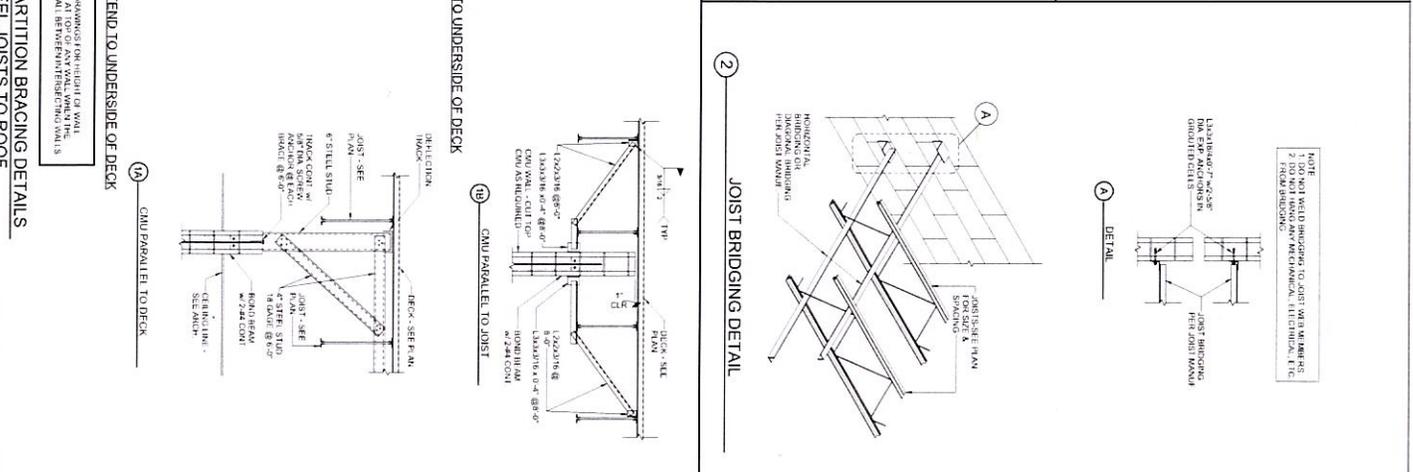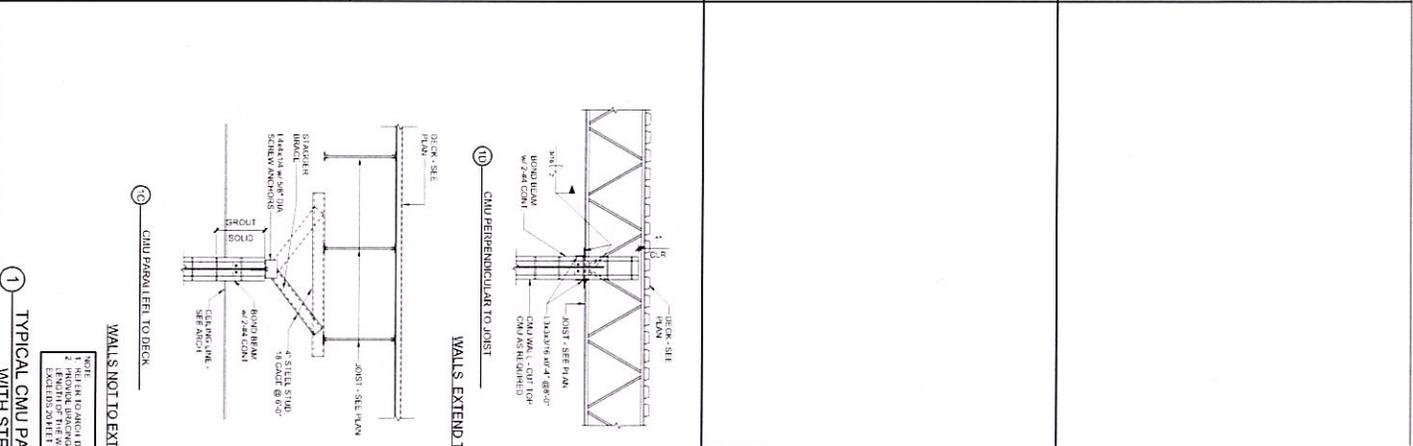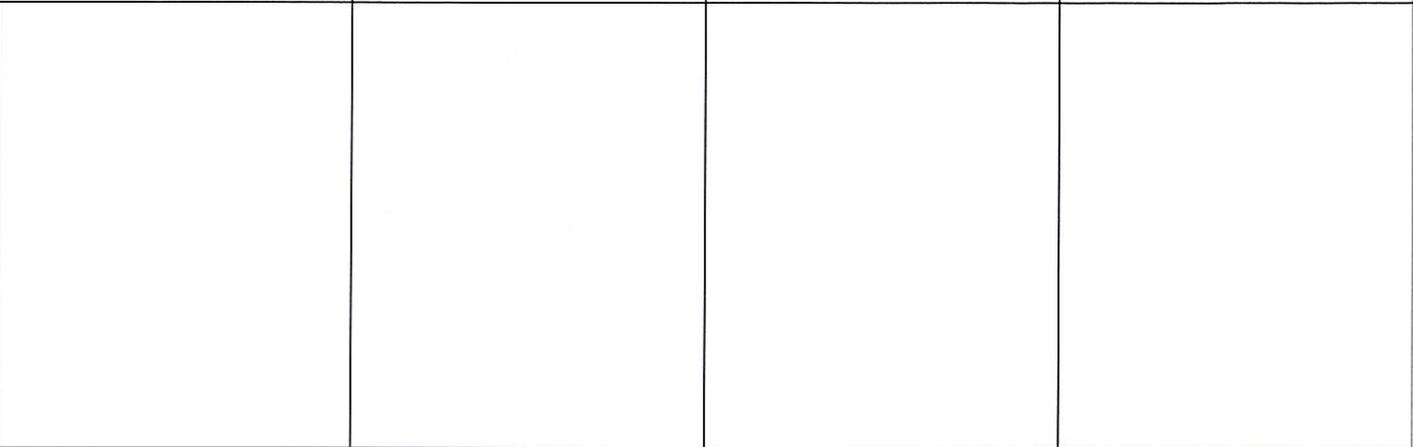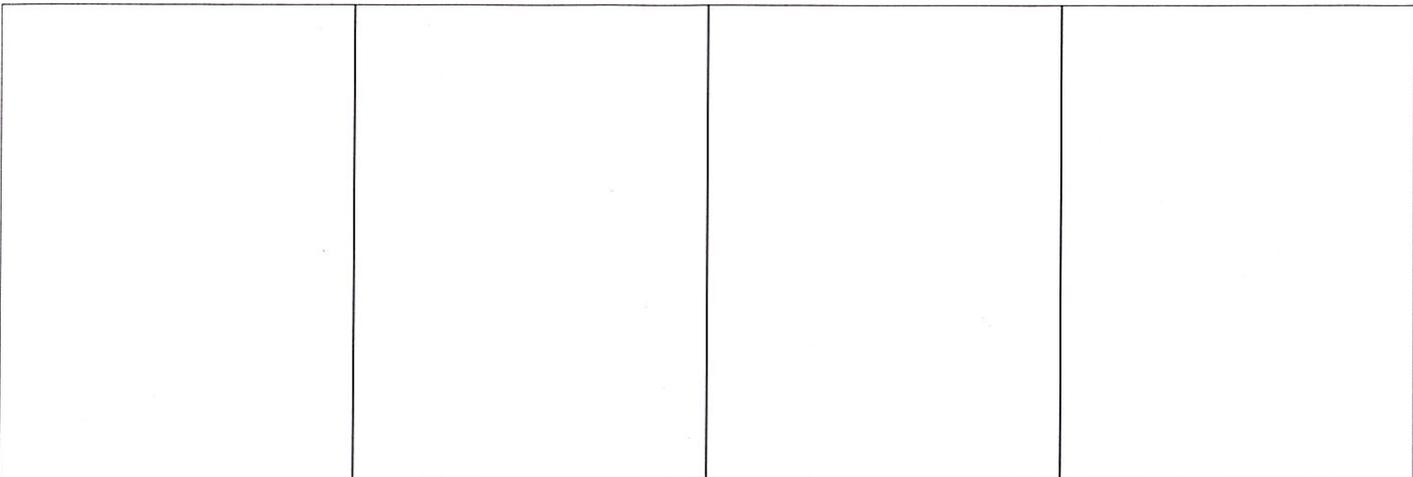


<p>PROJECT NO. 2019-001</p> <p>DATE: 08/20/2019</p> <p>SCALE: AS SHOWN</p> <p>BY: J. H. [unreadable]</p> <p>CHECKED BY: [unreadable]</p> <p>APPROVED BY: [unreadable]</p>	<p>MASONRY SECTIONS AND DETAILS MARION COUNTY ATC - RENOVATION & ADDITION FOR: MARION COUNTY BOARD OF EDUCATION LEBANON, KENTUCKY</p>	<p>Structural Design Group CONSULTING ENGINEERS</p> <p>1000 Poplar Ave. Ste. 100 Memphis, TN 38102 901.525.1234</p>	<p>NOT FOR CONSTRUCTION</p>	<p>rosstarrant architects a MORE group brand</p> <p>1000 Poplar Ave. Ste. 100 Memphis, TN 38102 901.525.1234</p>
---	---	---	------------------------------------	--

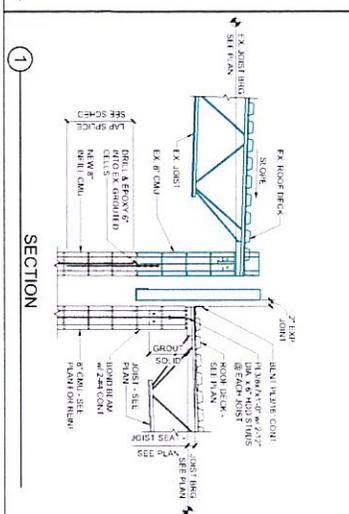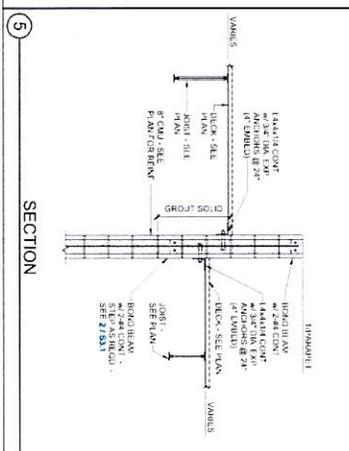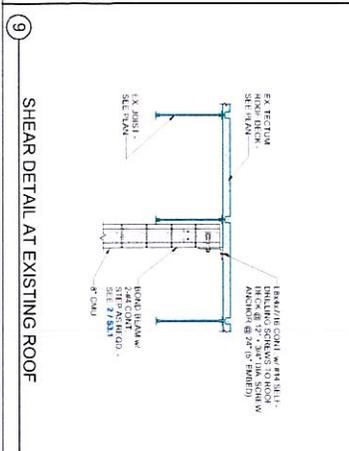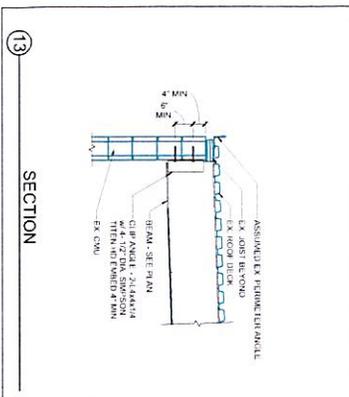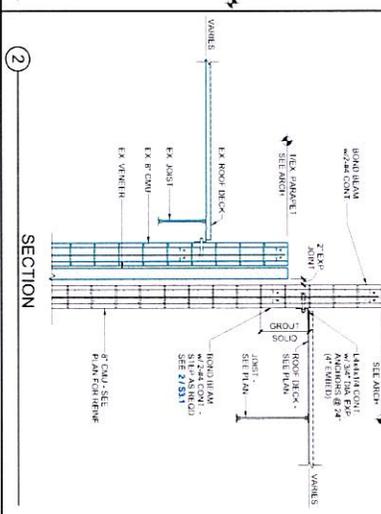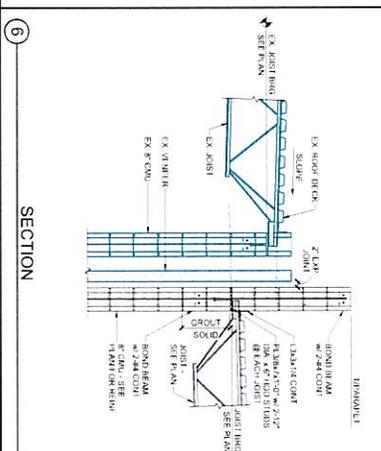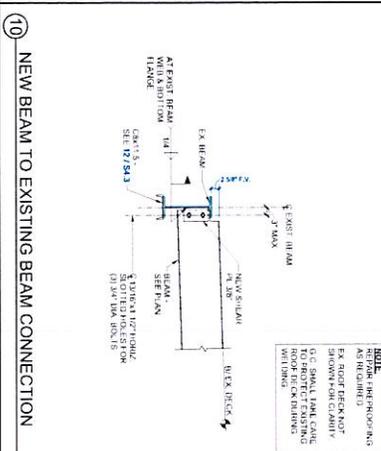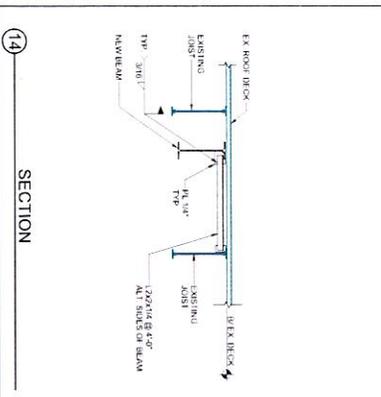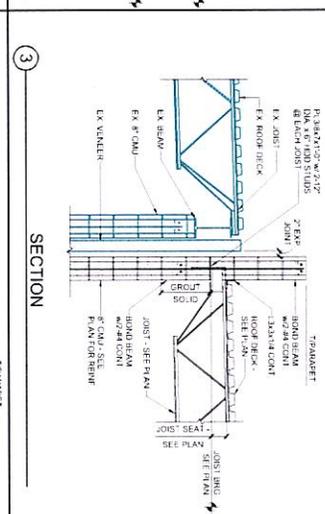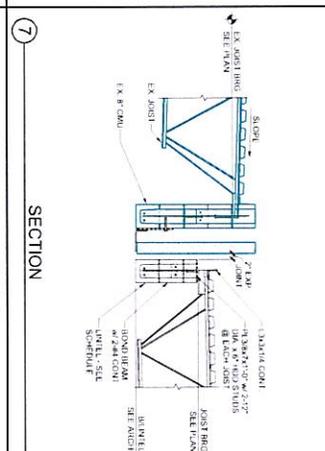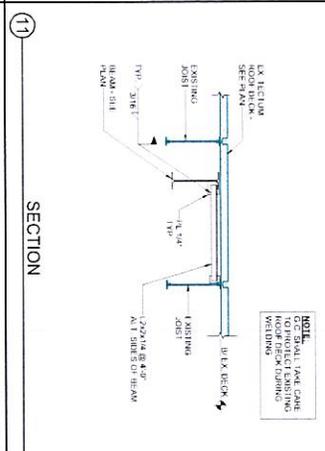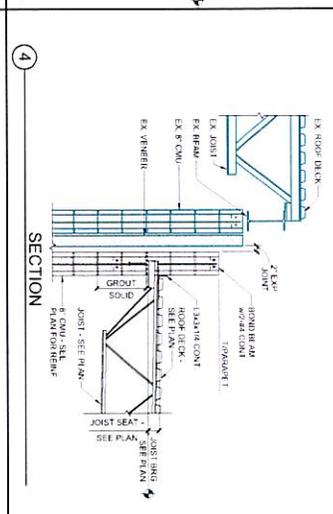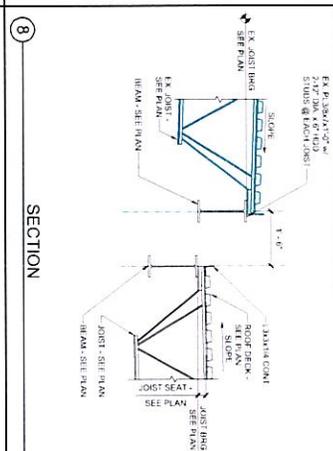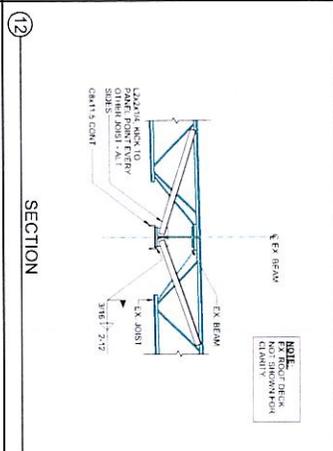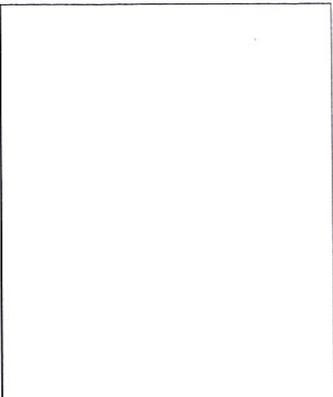

REVISIONS	NO.	DATE	DESCRIPTION

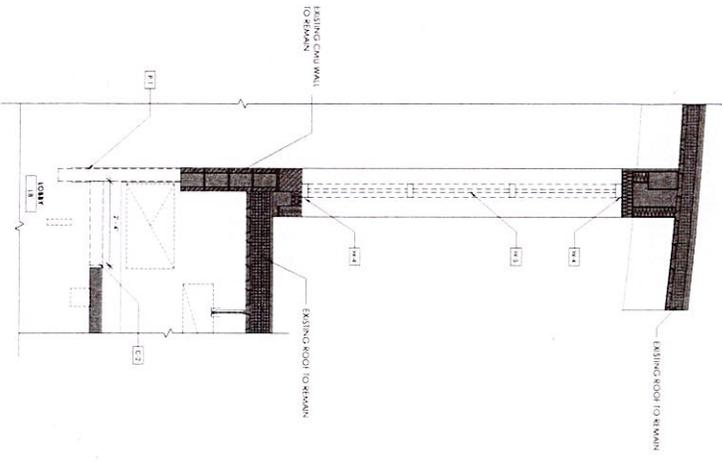

SECTION DEMOLITION
SCALE: 1/8" = 1'-0"

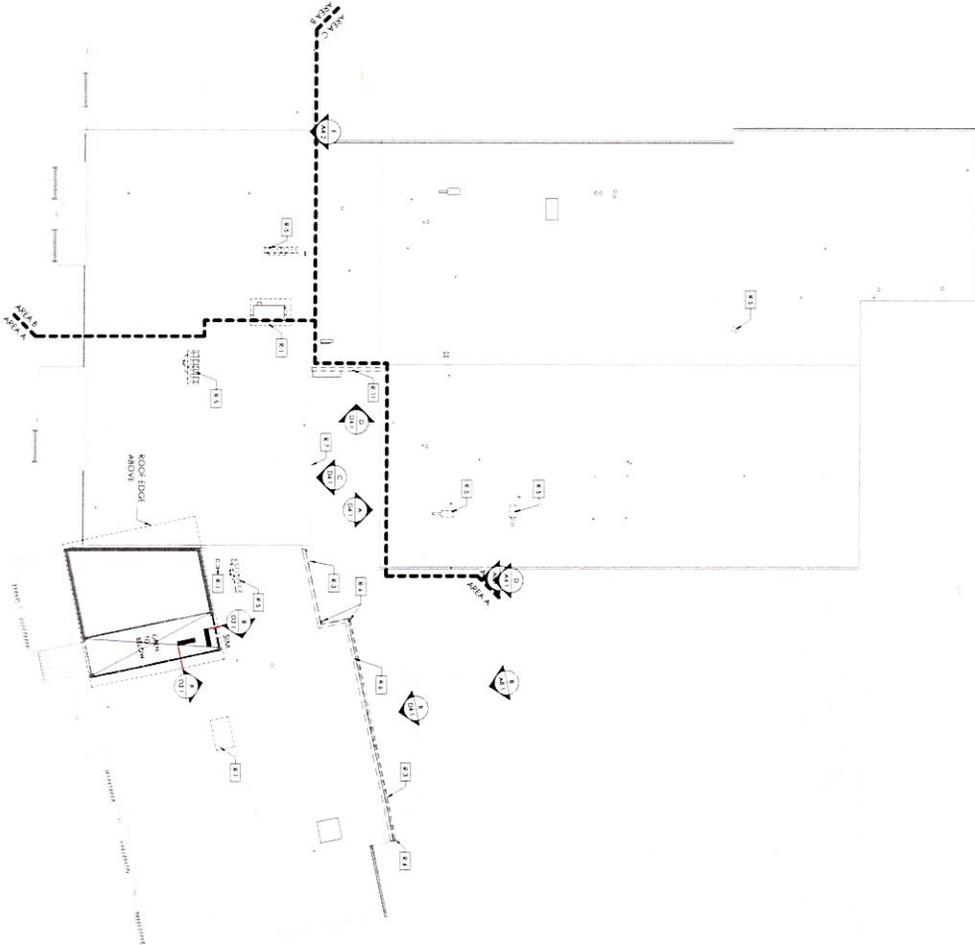

ROOF DEMOLITION PLAN
SCALE: 1/16" = 1'-0"

ROOF DEMOLITION NOTES

1. THESE SHEDDING DRAWINGS ARE MEANT TO BE A CONSTRUCTION AND DEMOLITION PLAN FOR ALL CONSTRUCTION AND DEMOLITION WORK. ALL WORK SHALL BE PERFORMED IN ACCORDANCE WITH THE LATEST EDITIONS OF THE INTERNATIONAL BUILDING CODE (IBC) AND THE INTERNATIONAL ROOFING INSTITUTE (IRI) STANDARDS. ALL WORK SHALL BE PERFORMED IN ACCORDANCE WITH THE LATEST EDITIONS OF THE INTERNATIONAL BUILDING CODE (IBC) AND THE INTERNATIONAL ROOFING INSTITUTE (IRI) STANDARDS.
2. THE CONTRACTOR SHALL BE RESPONSIBLE FOR OBTAINING ALL NECESSARY PERMITS AND APPROVALS FROM THE LOCAL BUILDING DEPARTMENT AND THE LOCAL HEALTH DEPARTMENT.
3. THE CONTRACTOR SHALL BE RESPONSIBLE FOR OBTAINING ALL NECESSARY PERMITS AND APPROVALS FROM THE LOCAL BUILDING DEPARTMENT AND THE LOCAL HEALTH DEPARTMENT.
4. THE CONTRACTOR SHALL BE RESPONSIBLE FOR OBTAINING ALL NECESSARY PERMITS AND APPROVALS FROM THE LOCAL BUILDING DEPARTMENT AND THE LOCAL HEALTH DEPARTMENT.
5. THE CONTRACTOR SHALL BE RESPONSIBLE FOR OBTAINING ALL NECESSARY PERMITS AND APPROVALS FROM THE LOCAL BUILDING DEPARTMENT AND THE LOCAL HEALTH DEPARTMENT.
6. THE CONTRACTOR SHALL BE RESPONSIBLE FOR OBTAINING ALL NECESSARY PERMITS AND APPROVALS FROM THE LOCAL BUILDING DEPARTMENT AND THE LOCAL HEALTH DEPARTMENT.
7. THE CONTRACTOR SHALL BE RESPONSIBLE FOR OBTAINING ALL NECESSARY PERMITS AND APPROVALS FROM THE LOCAL BUILDING DEPARTMENT AND THE LOCAL HEALTH DEPARTMENT.
8. THE CONTRACTOR SHALL BE RESPONSIBLE FOR OBTAINING ALL NECESSARY PERMITS AND APPROVALS FROM THE LOCAL BUILDING DEPARTMENT AND THE LOCAL HEALTH DEPARTMENT.
9. THE CONTRACTOR SHALL BE RESPONSIBLE FOR OBTAINING ALL NECESSARY PERMITS AND APPROVALS FROM THE LOCAL BUILDING DEPARTMENT AND THE LOCAL HEALTH DEPARTMENT.
10. THE CONTRACTOR SHALL BE RESPONSIBLE FOR OBTAINING ALL NECESSARY PERMITS AND APPROVALS FROM THE LOCAL BUILDING DEPARTMENT AND THE LOCAL HEALTH DEPARTMENT.

ROOF DEMOLITION NOTES

1. REMOVE EXISTING ROOF TO REMAIN.
2. REMOVE EXISTING ROOF TO REMAIN.
3. REMOVE EXISTING ROOF TO REMAIN.
4. REMOVE EXISTING ROOF TO REMAIN.
5. REMOVE EXISTING ROOF TO REMAIN.
6. REMOVE EXISTING ROOF TO REMAIN.
7. REMOVE EXISTING ROOF TO REMAIN.
8. REMOVE EXISTING ROOF TO REMAIN.
9. REMOVE EXISTING ROOF TO REMAIN.
10. REMOVE EXISTING ROOF TO REMAIN.

DEMOLITION NOTES

1. REMOVE EXISTING ROOF TO REMAIN.
2. REMOVE EXISTING ROOF TO REMAIN.
3. REMOVE EXISTING ROOF TO REMAIN.
4. REMOVE EXISTING ROOF TO REMAIN.
5. REMOVE EXISTING ROOF TO REMAIN.
6. REMOVE EXISTING ROOF TO REMAIN.
7. REMOVE EXISTING ROOF TO REMAIN.
8. REMOVE EXISTING ROOF TO REMAIN.
9. REMOVE EXISTING ROOF TO REMAIN.
10. REMOVE EXISTING ROOF TO REMAIN.

KEY PLAN

SCALE: 1/8" = 1'-0"

KEY PLAN

SCALE: 1/8" = 1'-0"

SCALE: 1/8" = 1'-0"

rostartart architects
a **MOORE** group brand
101 1st Avenue South, Lexington, Kentucky 40502 | 606.254.4218

NOT FOR CONSTRUCTION

ROOF DEMOLITION PLAN
MARION COUNTY ATC - RENOVATION & ADDITION
FOR
MARION COUNTY BOARD OF EDUCATION
LEBANON, KENTUCKY

D3.1
ROOF DEMOLITION PLAN
DATE: 04/15/2013

CONTRACT NO. 2013-004

PROJECT NO. 2013-004

DATE: 04/15/2013

SCALE: 1/8" = 1'-0"

DESIGNED BY: [Name]

CHECKED BY: [Name]

DATE: 04/15/2013








PROJECT NO. 2013-004

CONTRACT NO. 2013-004

DATE: 04/15/2013

SCALE: 1/8" = 1'-0"

NO.	DATE	REVISIONS

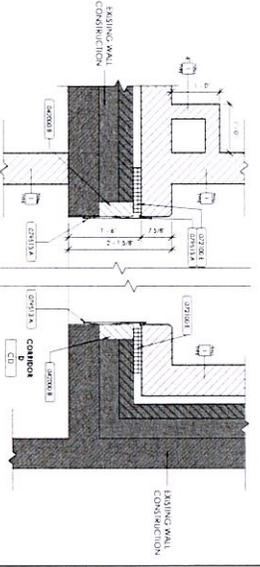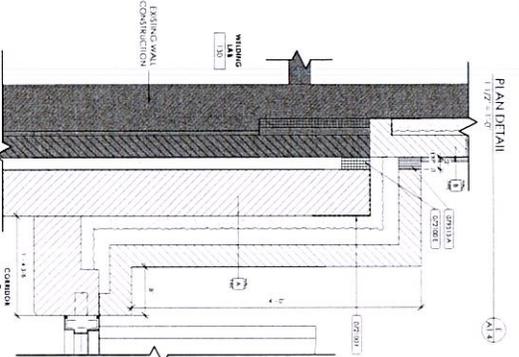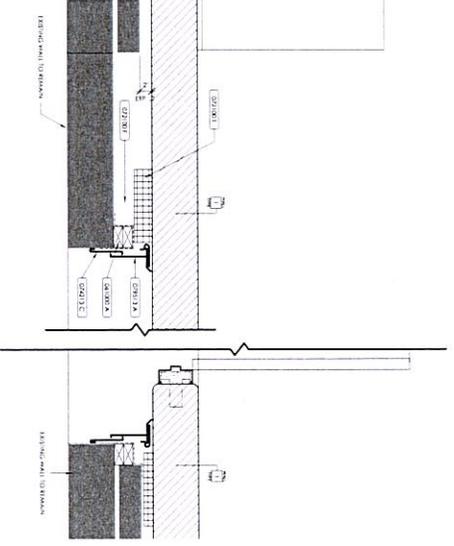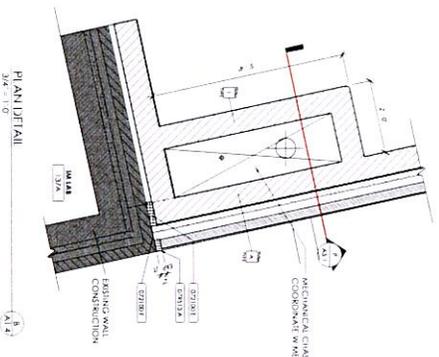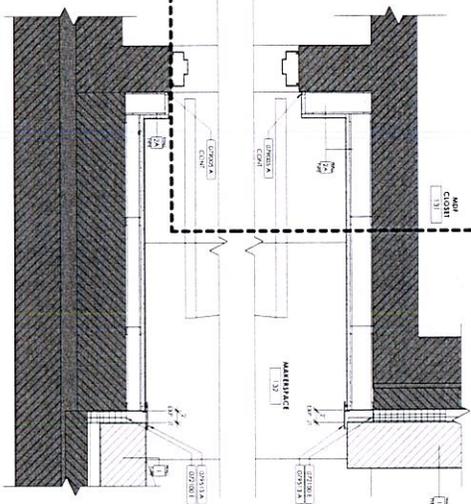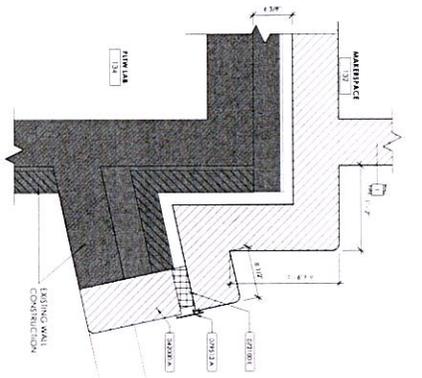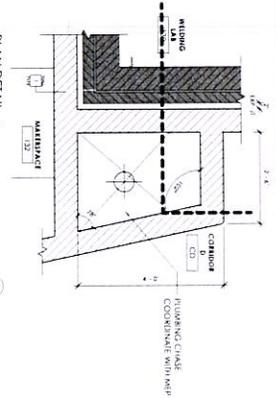

PLAN DETAIL
1/12" = 1'-0"

PLAN DETAIL
1/12" = 1'-0"

PLAN DETAIL
1/12" = 1'-0"

MATERIAL REFERENCE






rosstarrant architects
 a HOK GROUP BRAND
 101 oak street south, lebanon, kentucky 40052 | p 858.254.4218

NOT FOR CONSTRUCTION

PLAN DETAILS
 MARION COUNTY ATC - RENOVATION & ADDITION
 FOR
 MARION COUNTY BOARD OF EDUCATION
 LEBANON, KENTUCKY

A1.4
 MARION COUNTY BOARD OF EDUCATION
 101 OAK STREET SOUTH, LEBANON, KY 40052
 PROJECT NO. 2018-001
 DATE: 08/25/2018
 DRAWN BY: [Name]
 CHECKED BY: [Name]
 APPROVED BY: [Name]

NO.	DATE	DESCRIPTION
1		REVISIONS

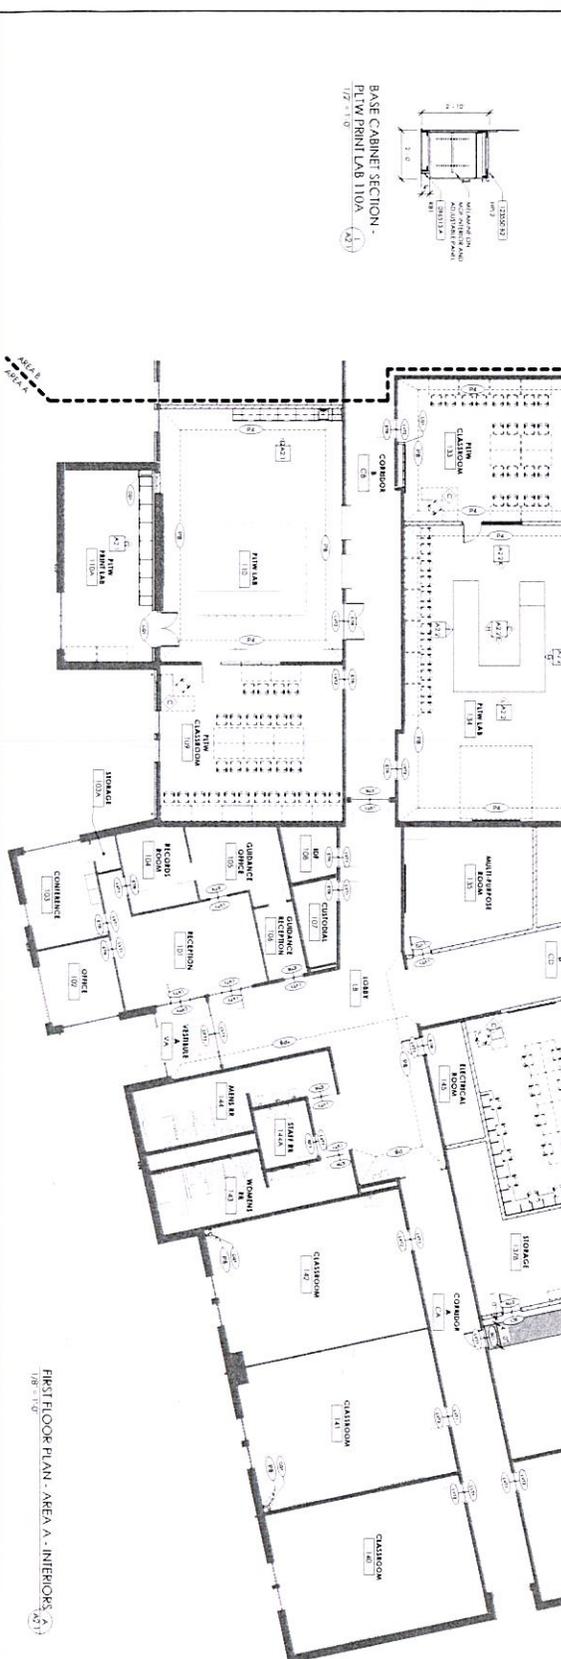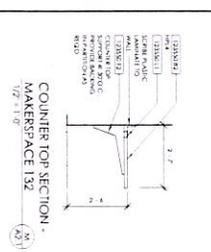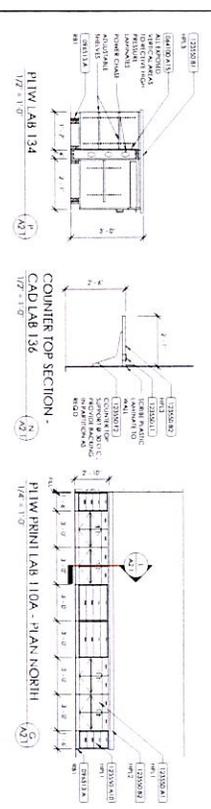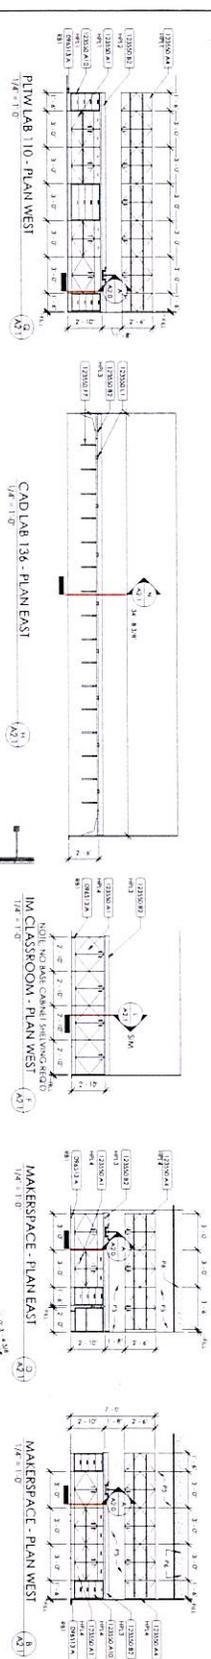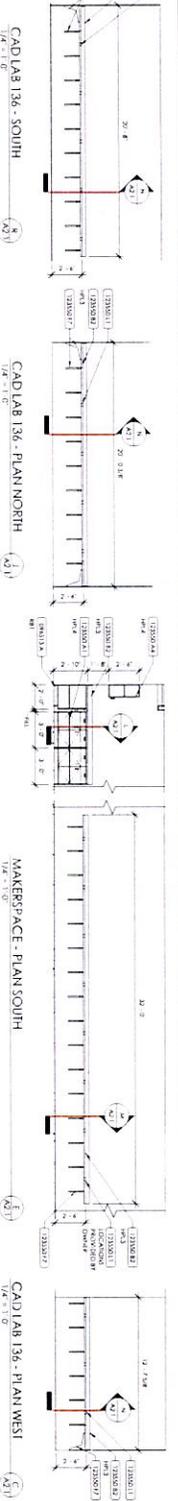

MATERIAL REFERENCE

- 1. WALLS: 1/2\"
- 2. FLOORING: 1/2\"
- 3. CEILING: 1/2\"
- 4. LIGHTING: 1/2\"
- 5. PAINT: 1/2\"
- 6. GLASS: 1/2\"
- 7. METAL: 1/2\"
- 8. WOOD: 1/2\"
- 9. FABRIC: 1/2\"
- 10. OTHER: 1/2\"

NOT FOR CONSTRUCTION

rosstarrant architects
an HOK company


FLOOR PLAN - AREA A - INTERIORS
MARION COUNTY ATC - RENOVATION & ADDITION
 FOR
MARION COUNTY BOARD OF EDUCATION
 LEBANON, KENTUCKY

KEY PLAN


A2.1

DATE: 08/21/2024
 SCALE: 1/8\"

NO.	DATE	REVISIONS

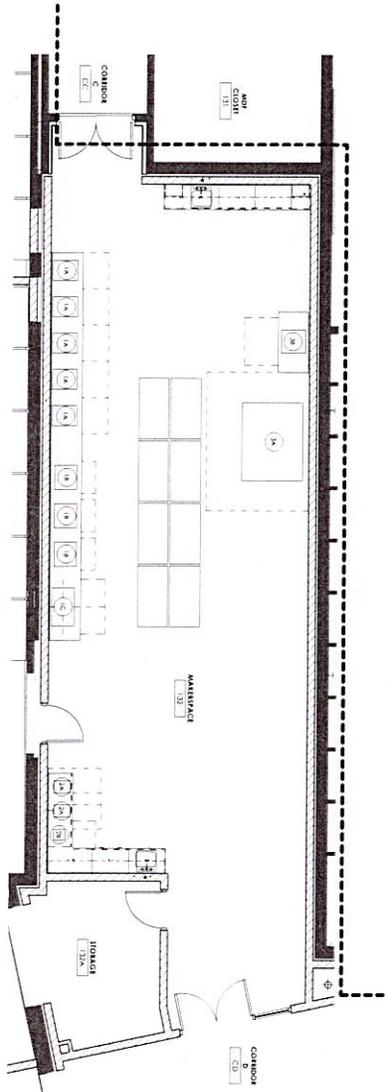

EQUIPMENT FLOOR PLAN - MAKERSPACE
1/2" = 1'-0"

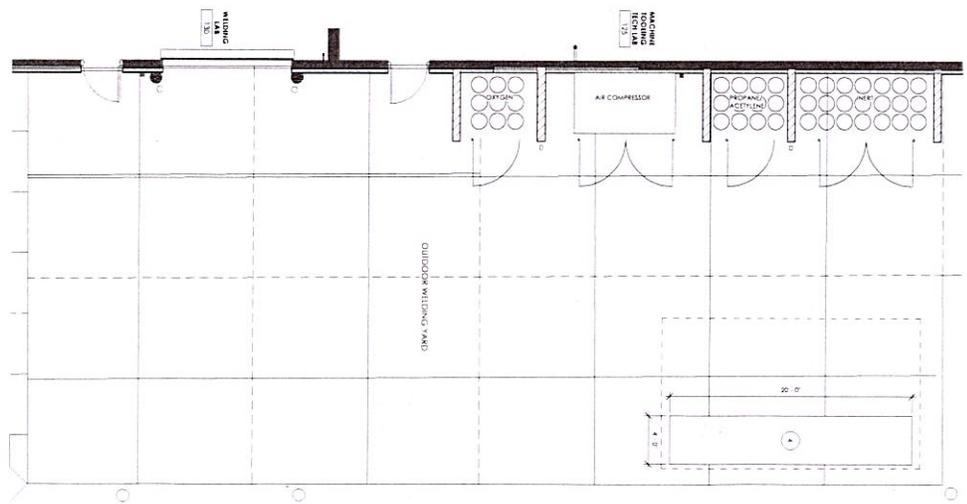

EQUIPMENT FLOOR PLAN - WELDING YARD
1/2" = 1'-0"

EQUIPMENT SCHEDULE

NO.	QUANTITY	EQUIPMENT NAME	NO.	LISTED	MANUFACT.	INSTALLER	COMMENTS
1	1	PROPANE/Acetylene	1				
2	1	AIR COMPRESSOR	2				
3	1	OXYGEN	3				
4	1	MATERIAL STORAGE	4				
5	1		5				
6	1		6				
7	1		7				
8	1		8				
9	1		9				
10	1		10				
11	1		11				
12	1		12				
13	1		13				
14	1		14				
15	1		15				
16	1		16				
17	1		17				
18	1		18				
19	1		19				
20	1		20				
21	1		21				
22	1		22				
23	1		23				
24	1		24				
25	1		25				
26	1		26				
27	1		27				
28	1		28				
29	1		29				
30	1		30				

A2.6

CONSTRUCTION CONTRACT

DATE: 08/25/2021

PROJECT: MARION COUNTY BOARD OF EDUCATION ATC - RENOVATION & ADDITION

CLIENT: MARION COUNTY BOARD OF EDUCATION

DESIGNER: ROSSTARRANT ARCHITECTS

151 MC ANNEVILLE AVENUE, WASHINGTON, MISSOURI 64502 | P. 816.254.4218

EQUIPMENT FLOOR PLAN - MAKERSPACE & WELDING YARD

MARION COUNTY ATC - RENOVATION & ADDITION

FOR

MARION COUNTY BOARD OF EDUCATION

LEBANON, KENTUCKY





rosstarrant architects

• MORE THAN JUST ARCHITECTS

NOT FOR CONSTRUCTION

REVISIONS

NO.	DATE	DESCRIPTION

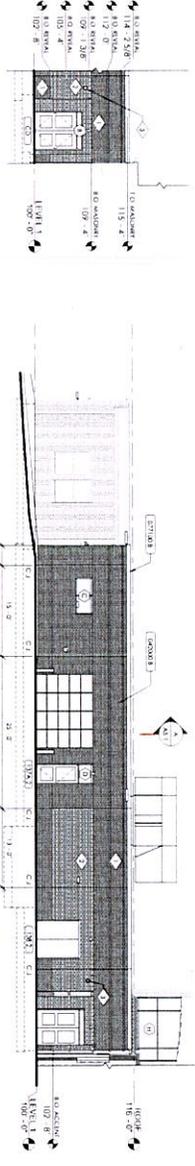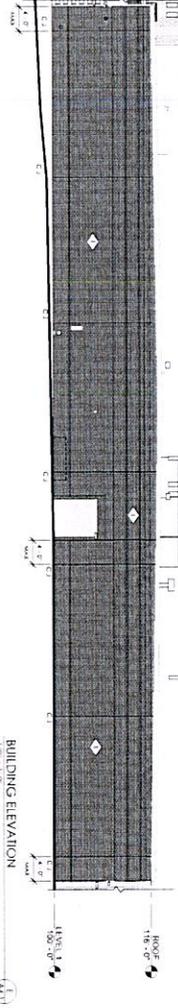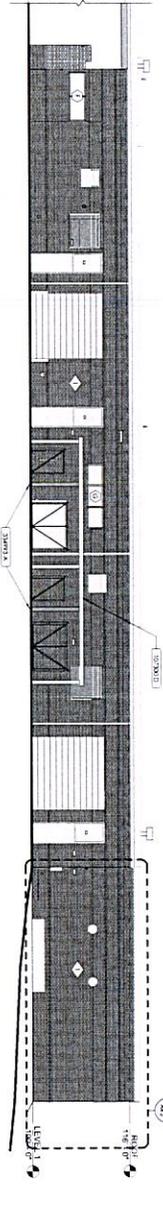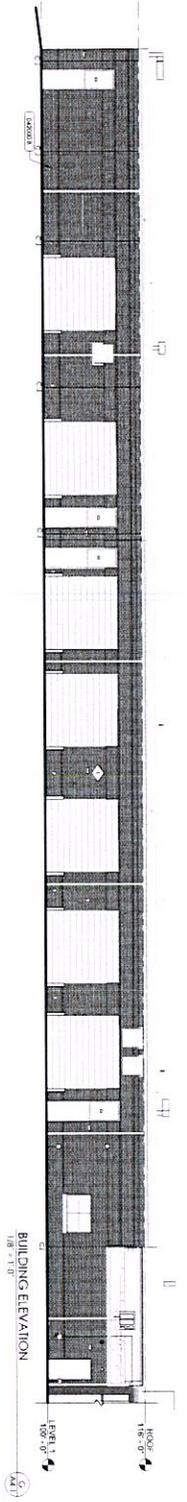

BUILDING ELEVATION-SOUTH
1/8" = 1'-0"

MATERIAL REFERENCE

NO.	DESCRIPTION


GENERAL ELEVATION NOTES

1. ALL MATERIALS TO BE SHOWN ON THIS DRAWING TO BE USED UNLESS OTHERWISE NOTED.
2. ALL MATERIALS TO BE SHOWN ON THIS DRAWING TO BE USED UNLESS OTHERWISE NOTED.
3. ALL MATERIALS TO BE SHOWN ON THIS DRAWING TO BE USED UNLESS OTHERWISE NOTED.
4. ALL MATERIALS TO BE SHOWN ON THIS DRAWING TO BE USED UNLESS OTHERWISE NOTED.
5. ALL MATERIALS TO BE SHOWN ON THIS DRAWING TO BE USED UNLESS OTHERWISE NOTED.
6. ALL MATERIALS TO BE SHOWN ON THIS DRAWING TO BE USED UNLESS OTHERWISE NOTED.
7. ALL MATERIALS TO BE SHOWN ON THIS DRAWING TO BE USED UNLESS OTHERWISE NOTED.
8. ALL MATERIALS TO BE SHOWN ON THIS DRAWING TO BE USED UNLESS OTHERWISE NOTED.
9. ALL MATERIALS TO BE SHOWN ON THIS DRAWING TO BE USED UNLESS OTHERWISE NOTED.

ELEVATION NOTES

1. ALL MATERIALS TO BE SHOWN ON THIS DRAWING TO BE USED UNLESS OTHERWISE NOTED.
2. ALL MATERIALS TO BE SHOWN ON THIS DRAWING TO BE USED UNLESS OTHERWISE NOTED.
3. ALL MATERIALS TO BE SHOWN ON THIS DRAWING TO BE USED UNLESS OTHERWISE NOTED.
4. ALL MATERIALS TO BE SHOWN ON THIS DRAWING TO BE USED UNLESS OTHERWISE NOTED.
5. ALL MATERIALS TO BE SHOWN ON THIS DRAWING TO BE USED UNLESS OTHERWISE NOTED.
6. ALL MATERIALS TO BE SHOWN ON THIS DRAWING TO BE USED UNLESS OTHERWISE NOTED.
7. ALL MATERIALS TO BE SHOWN ON THIS DRAWING TO BE USED UNLESS OTHERWISE NOTED.
8. ALL MATERIALS TO BE SHOWN ON THIS DRAWING TO BE USED UNLESS OTHERWISE NOTED.
9. ALL MATERIALS TO BE SHOWN ON THIS DRAWING TO BE USED UNLESS OTHERWISE NOTED.

BUILDING ELEVATIONS
MARION COUNTY ATC - RENOVATION & ADDITION
FOR
MARION COUNTY BOARD OF EDUCATION
LEBANON, KENTUCKY

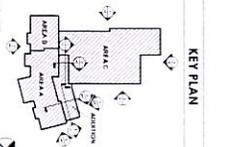

SCALE: 1/8" = 1'-0"

A4.1

DATE: 08/14/2013


BY: [Signature]

rostantant architects

1111 1st Street, Lexington, Kentucky 40502 • 606.254.6114

NOT FOR CONSTRUCTION

NO.	REVISIONS

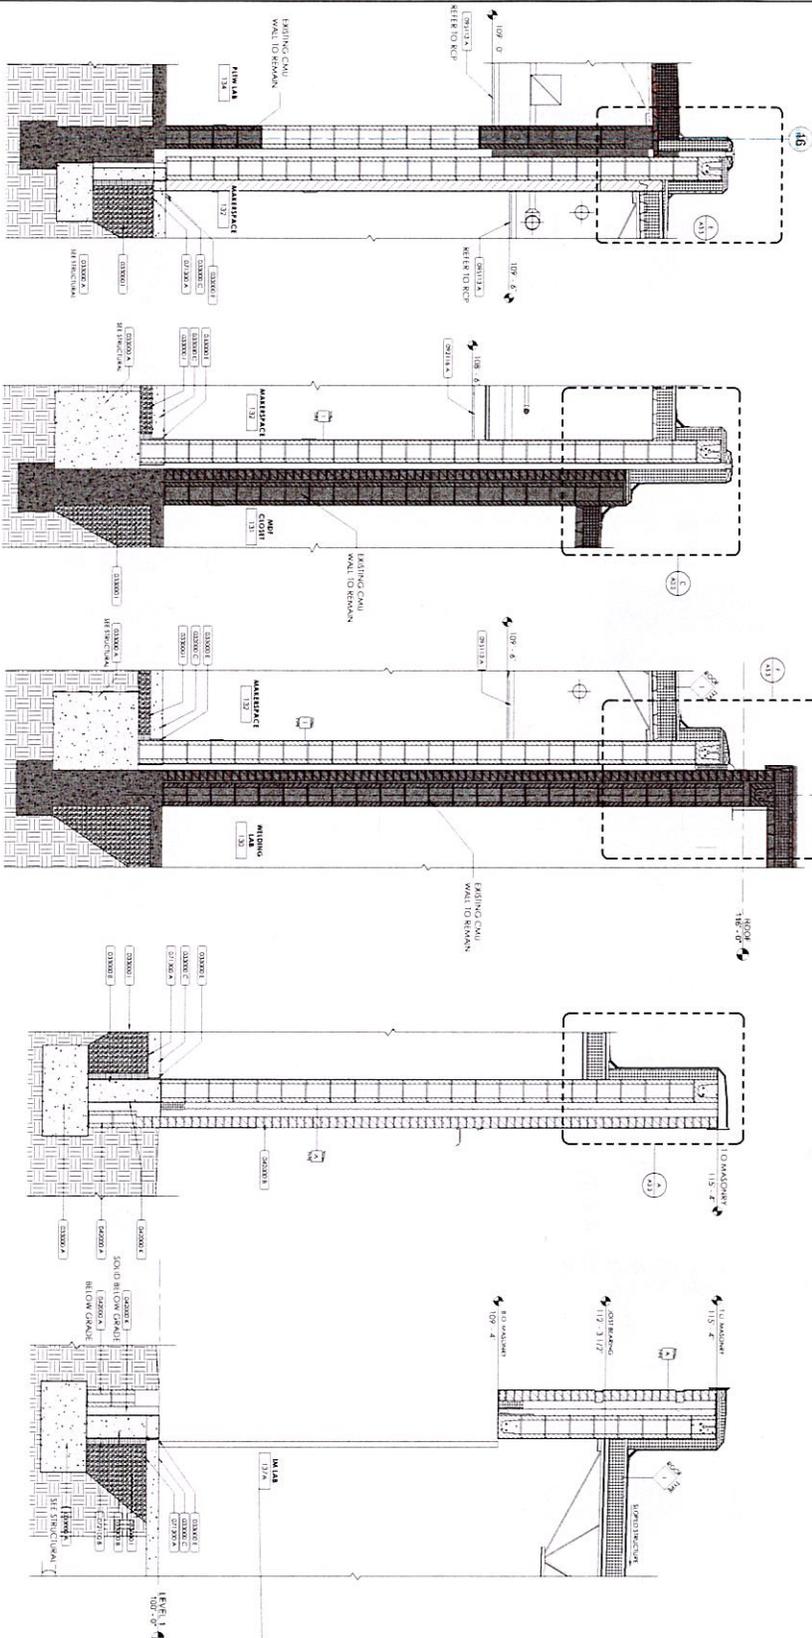

MATERIAL REFERENCE

1. MASONRY	2. MORTAR	3. REINFORCEMENT	4. FINISH
5. EXISTING CMU WALL TO REMAIN	6. NEW MASONRY	7. NEW MORTAR	8. NEW FINISH
9. EXISTING MORTAR	10. NEW REINFORCEMENT	11. NEW FINISH	12. NEW MASONRY
13. NEW MORTAR	14. NEW FINISH	15. NEW MASONRY	16. NEW MORTAR
17. NEW FINISH	18. NEW MASONRY	19. NEW MORTAR	20. NEW FINISH

DATE	

WALL SECTIONS
MARION COUNTY ATC - RENOVATION & ADDITION
 FOR
MARION COUNTY BOARD OF EDUCATION
 LEBANON, KENTUCKY


NOT FOR CONSTRUCTION

rosstarrant architects
 a HOBEgroup brand


101 west walton avenue - walter - lebanon, kentucky 40522 - phone 502.234.4318

A5.2
 WALL SECTION
 DATE: 05/03/2016
 DRAWN: [Name]


NO.	REVISIONS

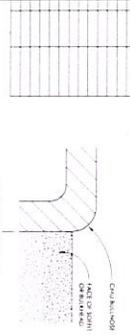


TYPICAL SOFFIT DETAIL
1/8" = 1'-0"

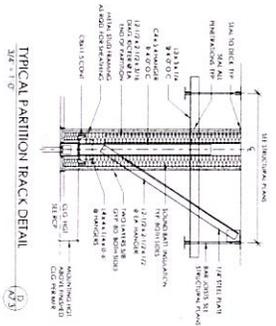


TYPICAL PARTITION TRACK DETAIL
1/8" = 1'-0"

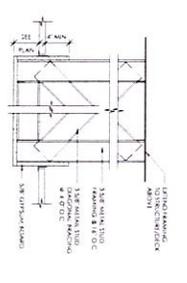

TYPICAL SOFFIT DETAIL
1/8" = 1'-0"

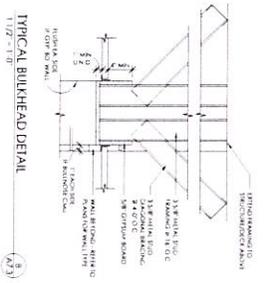

TYPICAL BULKHEAD DETAIL
1/8" = 1'-0"

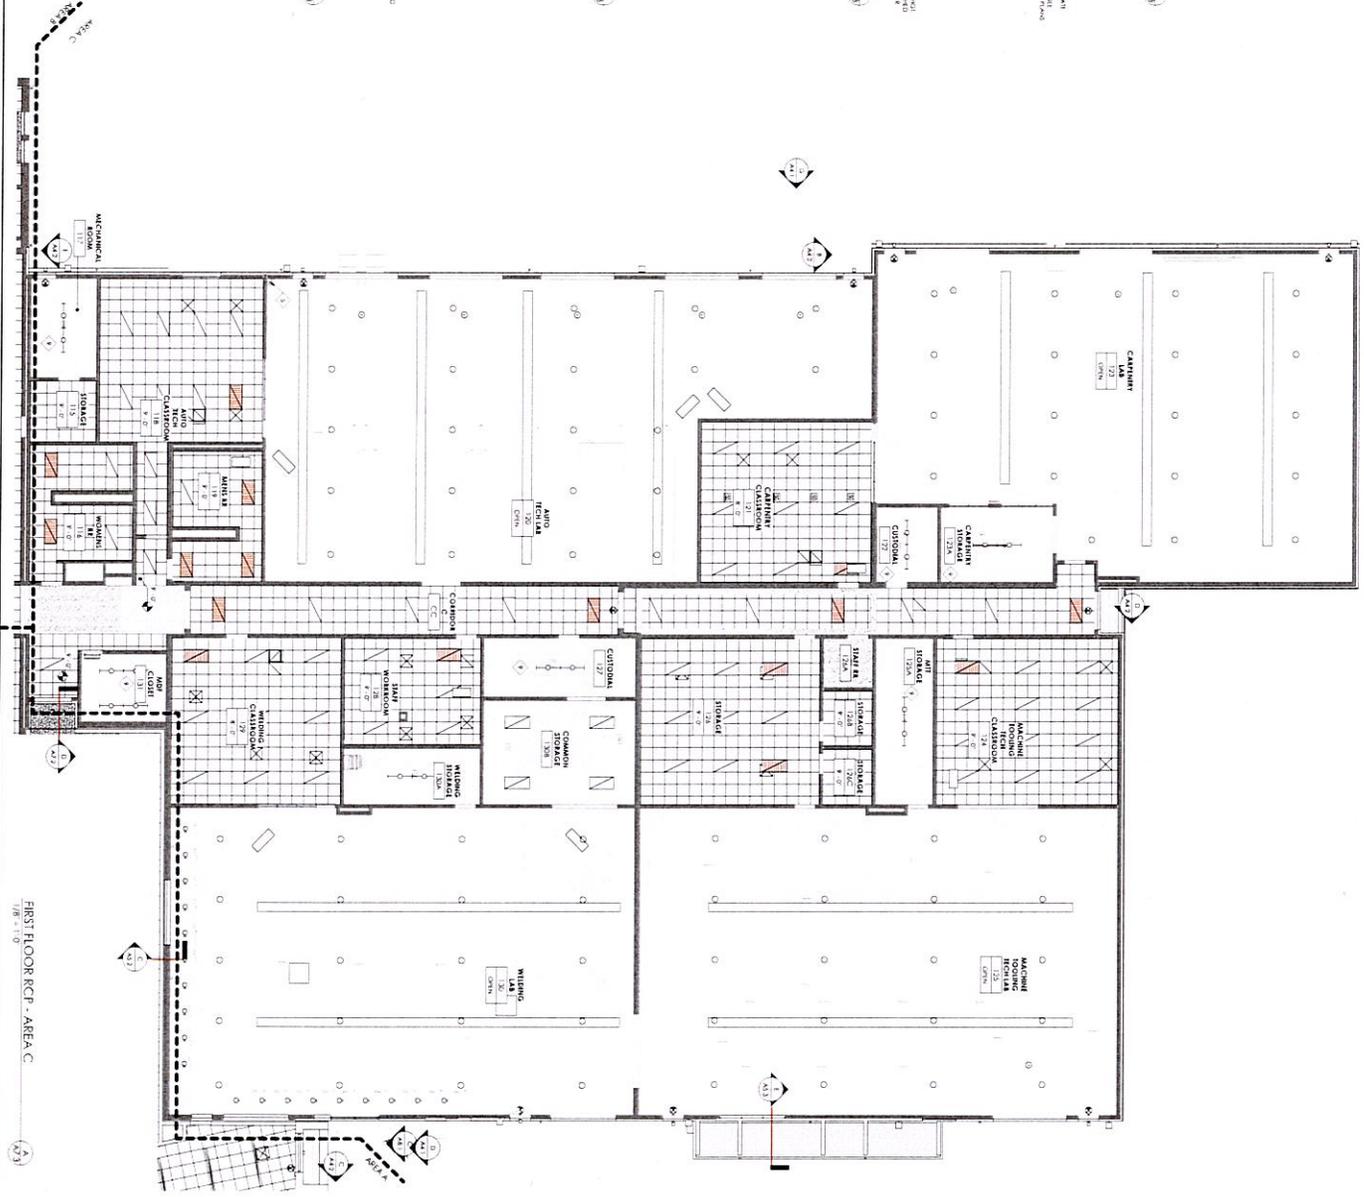

FIRST FLOOR RCP - AREA C
1/8" = 1'-0"

MATERIAL REFERENCE



NOT FOR CONSTRUCTION


GENERAL RCP NOTES

1. REFER TO ALL RELATED DRAWINGS FOR GENERAL NOTES.
2. REFER TO ALL RELATED DRAWINGS FOR MATERIALS AND FINISHES.
3. REFER TO ALL RELATED DRAWINGS FOR LIGHTING FIXTURES AND LAYOUT.
4. REFER TO ALL RELATED DRAWINGS FOR PARTITION TRACKS AND BULKHEADS.
5. REFER TO ALL RELATED DRAWINGS FOR SOFFIT DETAIL.
6. REFER TO ALL RELATED DRAWINGS FOR CEILING JOIST AND CONCRETE SLAB.
7. REFER TO ALL RELATED DRAWINGS FOR GYP BOARD AND PARTITION TRACK.
8. REFER TO ALL RELATED DRAWINGS FOR MECHANICAL AND ELECTRICAL.


RCP NOTES

1. REFER TO ALL RELATED DRAWINGS FOR MATERIALS AND FINISHES.
2. REFER TO ALL RELATED DRAWINGS FOR LIGHTING FIXTURES AND LAYOUT.
3. REFER TO ALL RELATED DRAWINGS FOR PARTITION TRACKS AND BULKHEADS.
4. REFER TO ALL RELATED DRAWINGS FOR SOFFIT DETAIL.
5. REFER TO ALL RELATED DRAWINGS FOR CEILING JOIST AND CONCRETE SLAB.
6. REFER TO ALL RELATED DRAWINGS FOR GYP BOARD AND PARTITION TRACK.
7. REFER TO ALL RELATED DRAWINGS FOR MECHANICAL AND ELECTRICAL.

RCP LEGEND

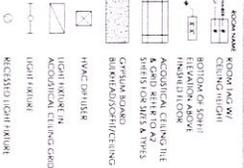

KEY PLAN

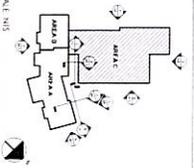


REFLECTED CEILING PLAN - AREA C
MARION COUNTY ATC - RENOVATION & ADDITION
FOR
MARION COUNTY BOARD OF EDUCATION
LEBANON, KENTUCKY

A7.3

DATE: 08/14/2023
DRAWN BY: [Name]
CHECKED BY: [Name]
SCALE: AS SHOWN

NO.	DATE	REVISIONS

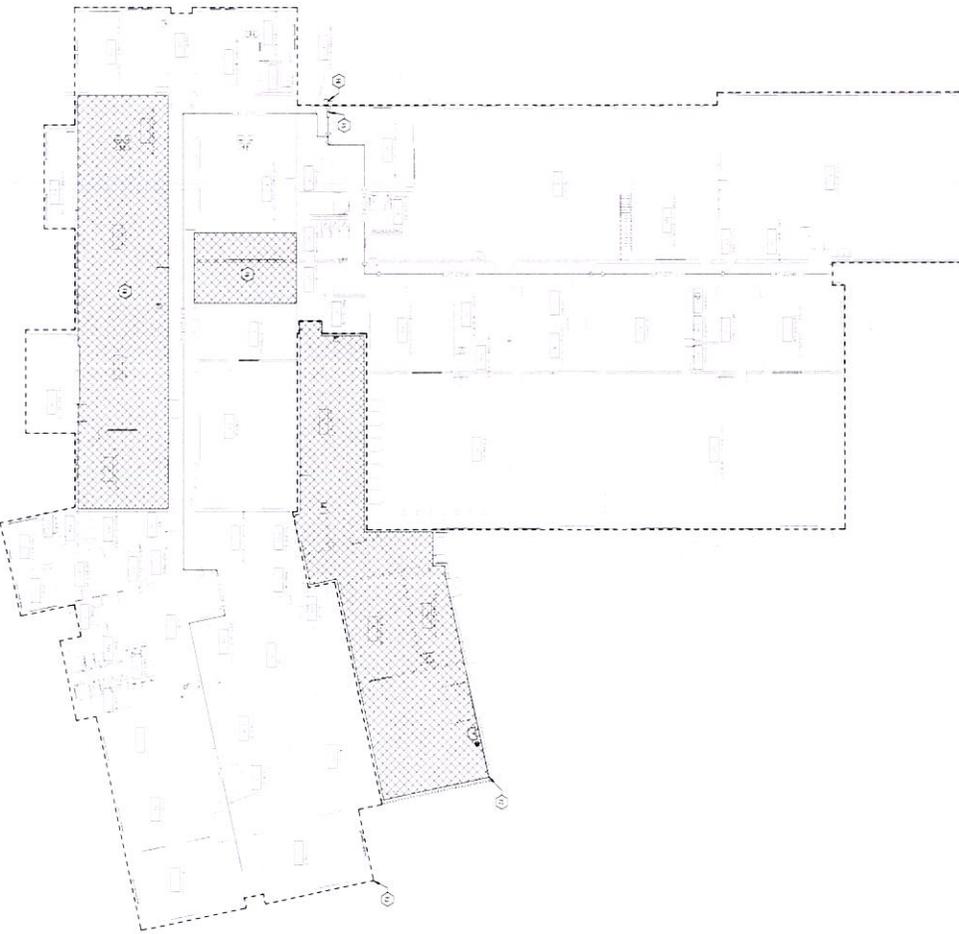

OVERALL FIRE PROTECTION NEW WORK PLAN
1/8" = 1' - 0"

102

TAGGED NOTES

1. CONSTRUCTION SHALL BE IN ACCORDANCE WITH THE LATEST EDITION OF THE INTERNATIONAL BUILDING CODE (IBC) AND THE LATEST EDITION OF THE INTERNATIONAL FIRE CODE (IFC).
2. ALL NEW WORK SHALL BE INSTALLED IN ACCORDANCE WITH THE LATEST EDITION OF THE NATIONAL FIRE PROTECTION ASSOCIATION (NFPA) 70, NATIONAL ELECTRICAL CODE (NEC).
3. ALL NEW WORK SHALL BE INSTALLED IN ACCORDANCE WITH THE LATEST EDITION OF THE NATIONAL FIRE PROTECTION ASSOCIATION (NFPA) 101, LIFE SAFETY CODE (LSC).
4. ALL NEW WORK SHALL BE INSTALLED IN ACCORDANCE WITH THE LATEST EDITION OF THE NATIONAL FIRE PROTECTION ASSOCIATION (NFPA) 13, FIRE PROTECTION CODE (FPC).
5. ALL NEW WORK SHALL BE INSTALLED IN ACCORDANCE WITH THE LATEST EDITION OF THE NATIONAL FIRE PROTECTION ASSOCIATION (NFPA) 16, STANDPIPE AND WET PIPE SYSTEMS CODE (SWPSC).
6. ALL NEW WORK SHALL BE INSTALLED IN ACCORDANCE WITH THE LATEST EDITION OF THE NATIONAL FIRE PROTECTION ASSOCIATION (NFPA) 201, MODEL FIRE MARSHAL CODE (MFC).
7. ALL NEW WORK SHALL BE INSTALLED IN ACCORDANCE WITH THE LATEST EDITION OF THE NATIONAL FIRE PROTECTION ASSOCIATION (NFPA) 220, MODEL CODE FOR HIGH-RISE BUILDINGS (MCHRB).
8. ALL NEW WORK SHALL BE INSTALLED IN ACCORDANCE WITH THE LATEST EDITION OF THE NATIONAL FIRE PROTECTION ASSOCIATION (NFPA) 25, FIRE ALARM AND NOTIFICATION SYSTEMS CODE (FANSC).
9. ALL NEW WORK SHALL BE INSTALLED IN ACCORDANCE WITH THE LATEST EDITION OF THE NATIONAL FIRE PROTECTION ASSOCIATION (NFPA) 303, MODEL CODE FOR COMMERCIAL AND INDUSTRIAL BUILDINGS (MCCIB).
10. ALL NEW WORK SHALL BE INSTALLED IN ACCORDANCE WITH THE LATEST EDITION OF THE NATIONAL FIRE PROTECTION ASSOCIATION (NFPA) 310, MODEL CODE FOR MULTIFAMILY DWELLING UNITS (MCDMU).
11. ALL NEW WORK SHALL BE INSTALLED IN ACCORDANCE WITH THE LATEST EDITION OF THE NATIONAL FIRE PROTECTION ASSOCIATION (NFPA) 313, MODEL CODE FOR SMALL MULTIFAMILY DWELLING UNITS (MCDMSMU).
12. ALL NEW WORK SHALL BE INSTALLED IN ACCORDANCE WITH THE LATEST EDITION OF THE NATIONAL FIRE PROTECTION ASSOCIATION (NFPA) 314, MODEL CODE FOR SINGLE-FAMILY DWELLINGS (MCSFD).
13. ALL NEW WORK SHALL BE INSTALLED IN ACCORDANCE WITH THE LATEST EDITION OF THE NATIONAL FIRE PROTECTION ASSOCIATION (NFPA) 315, MODEL CODE FOR ONE- AND TWO-FAMILY DWELLINGS (MCOFD).
14. ALL NEW WORK SHALL BE INSTALLED IN ACCORDANCE WITH THE LATEST EDITION OF THE NATIONAL FIRE PROTECTION ASSOCIATION (NFPA) 316, MODEL CODE FOR APARTMENT BUILDINGS (MCA).
15. ALL NEW WORK SHALL BE INSTALLED IN ACCORDANCE WITH THE LATEST EDITION OF THE NATIONAL FIRE PROTECTION ASSOCIATION (NFPA) 317, MODEL CODE FOR GROUP QUARTERS (MCGQ).
16. ALL NEW WORK SHALL BE INSTALLED IN ACCORDANCE WITH THE LATEST EDITION OF THE NATIONAL FIRE PROTECTION ASSOCIATION (NFPA) 318, MODEL CODE FOR DETACHED ONE-FAMILY DWELLINGS (MCOFD).
17. ALL NEW WORK SHALL BE INSTALLED IN ACCORDANCE WITH THE LATEST EDITION OF THE NATIONAL FIRE PROTECTION ASSOCIATION (NFPA) 319, MODEL CODE FOR ATTACHED ONE-FAMILY DWELLINGS (MCAOFD).
18. ALL NEW WORK SHALL BE INSTALLED IN ACCORDANCE WITH THE LATEST EDITION OF THE NATIONAL FIRE PROTECTION ASSOCIATION (NFPA) 320, MODEL CODE FOR MULTIFAMILY DWELLING UNITS (MCDMU).
19. ALL NEW WORK SHALL BE INSTALLED IN ACCORDANCE WITH THE LATEST EDITION OF THE NATIONAL FIRE PROTECTION ASSOCIATION (NFPA) 321, MODEL CODE FOR MULTIFAMILY DWELLING UNITS (MCDMU).
20. ALL NEW WORK SHALL BE INSTALLED IN ACCORDANCE WITH THE LATEST EDITION OF THE NATIONAL FIRE PROTECTION ASSOCIATION (NFPA) 322, MODEL CODE FOR MULTIFAMILY DWELLING UNITS (MCDMU).



KEY PLAN

OVERALL FIRE PROTECTION NEW WORK PLAN
MARION COUNTY ATC - RENOVATION & ADDITION
FOR
MARION COUNTY BOARD OF EDUCATION
LEBANON, KENTUCKY



NOT FOR
CONSTRUCTION



FP2.1
DATE: 11/14/2023
DRAWN BY: [Name]

NO.	DATE	REVISIONS

Project No. 2023000107
 Revision No. 001
 Date: 11/14/2023
 Project Name: OVERALL FIRE PROTECTION NEW WORK PLAN
 Location: MARION COUNTY ATC - RENOVATION & ADDITION
 Client: MARION COUNTY BOARD OF EDUCATION
 Designer: rostant architects
 Scale: 1/8" = 1' - 0"

