Change Order

PROJECT: (Name and address)
RHS Culinary Arts Renovation BG 25-203
1103 W 9th Street
Russellville, KY 42276

OWNER: (Name and address)
Russellville Independent Schools

355 S. Summer Street Russellville, KY 42276 CONTRACT INFORMATION:

Contract For: General Construction Date: the 18th day of March in the year 2025

ARCHITECT: (Name and address)
Hawkins Abney, PLLC

1503 N Main St Beaver Dam, KY 42320 CHANGE ORDER INFORMATION:

Change Order Number: 001 Date: the 17th day of June in the year

2025

CONTRACTOR: (Name and address)

A&K Construction, Inc. 100 Calloway Ct. Paducah, KY 42001

THE CONTRACT IS CHANGED AS FOLLOWS:

(Insert a detailed description of the change and, if applicable, attach or reference specific exhibits. Also include agreed upon adjustments attributable to executed Construction Change Directives.)

Changes to feed two panelboards from the existing main gear which includes downsizing from 800A to 400A, utilizing existing tap from main gear and omitting the UL re-certification. See included PR01 and included breakout from A&K.

The original Contract Sum was

The net change by previously authorized Change Orders

The Contract Sum prior to this Change Order was

The Contract Sum will be decreased by this Change Order in the amount of

The new Contract Sum including this Change Order will be

The Contract Time will be unchanged by Zero (0) days. The new date of Substantial Completion will be

\$ 1,730,000.00 \$ 0.00 \$ 1,730,000.00 \$ (32,625.62) \$ 1,697,374.38

NOTE: This Change Order does not include adjustments to the Contract Sum or Guaranteed Maximum Price, or the Contract Time, that have been authorized by Construction Change Directive until the cost and time have been agreed upon by both the Owner and Contractor, in which case a Change Order is executed to supersede the Construction Change Directive.

NOT VALID UNTIL SIGNED BY THE ARCHITECT, CONTRACTOR AND OWNER.

ARCHITECT (Signature)	CONTRACTOR (Signature)	OWNER (Signature)
BY: Jeremiah Hawkins, Managing	BY: Bill Boyd, President	BY: Kyle Estes, Superintendent
Principal	(Printed name and title)	(Printed name and title)
(Printed name, title, and license number if required)		Anna with annual
	Date	Date
Date		

Russellville Culinary Arts Renovation 2452-25 A & K Construction, Inc. Proposal - Change Order Request #1 5/18/2025

Division	Contractor	Labor	Material	Total
Electrical	Knight Electric	\$ 757.00	\$ (33,382.62)	\$ (32,625.62)
Sub-Total		\$ 757.00	\$ (33,382.62)	\$ (32,625.62)
Total				\$ (32,625.62)

Russellville Culinary Arts Renovation 2452-25 A & K Construction, Inc. Proposal - Change Order Request #1 18-May-25

Description	Material Quantity	Material Unit Price	Material Total	Labor Hours	Labor Rates	Labor Total
A & K Construction, Inc.	Quantity	OTHER FIGO	Total	110013	Raics	Total
Square D	1	\$ (34,008.00)	\$ (34,008.00)	(25)	\$ 75.00	\$ (1,868.00)
2" EMT	140	3.66	512.40	17	75.00	1,275.00
3" EMT	(40)	6.54	(261.60)	(6)	75.00	(450.00)
4" EMT	(10)	8.78	(87.80)	(2)	75.00	(150.00)
2" EMT STEEL SS CONN	32	5.37	171.84 [°]	5	75.00	375.00
3" EMT STEEL SS CONN	(4)	25.06	(100.24)	(1)	75.00	(75.00)
4" EMT STEEL SS CONN	(4)	47.72	(190.88)	(1)	75.00	(75.00)
2" EMT STEEL SS COUP	22	6.74	148.28	3	75.00	225.00
3" EMT STEEL SS COUP	(6)	18.90	(113.40)	(1)	75.00	(75.00)
4" EMT STEEL SS COUP	(2)	24.49	(48.98)	(1)	75.00	(75.00)
2" Plastic bushing	6	6.41	38.46	3	75.00	225.00
3" Plastic bushing	(4)	9.70	(38.80)	(2)	75.00	(150.00)
2" Grounding Bushing	13	31.70	412.10	5	75.00	375.00
4" Grounding Bushing	(2)	73.00	(146.00)	(2)	75.00	(150.00)
2" EMT 1 HOLE STRAP	22	1.48	32.56	1	75.00	75.00
3" EMT 1 HOLE STRAP	(6)	3.91	(23.46)	(1)	75.00	(75.00)
4" EMT 1 HOLE STRAP	(2)	10.08	(20.16)	(1)	75.00	(75.00)
8 THHN STR CU	30	0.68	20.40	1	75.00	75.00
6THHN STR CU	110	1.05	115.50	1	75.00	75.00
4THHN STR CU	(50)	1.48	(74.00)	(1)	75.00	(75.00)
3 THHN STR CU	150	1.99	298.50	4	75.00	300.00
3/0 THHN STR CU	510	5.45	2,779.50	19	75.00	1,425.00
300 THHN STR CU	(100)	8.09	(809.00)	(2)	75.00	(150.00)
500 THHN STR CU	(150)	13.55	(2,032.50)	(6)	75.00	(450.00)
Labor Investigation				2	75.00	150.00
Misc. Materials	1	42.66	42.66	1	75.00	75.00
Totals			\$ (33,382.62)			\$ 757.00

Russellville Culinary Arts Renovation 2452-25 A & K Construction, Inc. Proposal - Change Order Request #1 18-May-25

Material & Equipment	(33,382.62)	10.09	757.00
Equipment	0.00		
Material & equip total	(33,382.62)		
Labor	757.00		
Sub Total	(32,625.62)		
Total	(32,625.62)		



HAWKINS ABNEY

office: 270.363.2235

Hawkins Abney, PLLC - Proposal Request Form

Project No.: 24-23 DATE: 05.07.2025

Project Name: New Central Office and Bus Garage

Contractor: A&K Construction

Proposal Request No.: 01

DESCRIPTION:

Please refer to the updated drawing sheets and type written page from CMTA for changes regarding electrical scope of work.

Pricing should include any additional or credit costs for materials and labor, and overhead and profit.

ATTACHMENTS: Written description and 5 drawing sheets provided by CMTA.

Jeremiah Hawkins, AIA, LEED Green Associate Managing Principal Hawkins Abney, PLLC



May 7, 2025

Re: PR-01- Electrical Panelboards

Russellville Independent Schools Culinary Arts Renovation

CMTA Project No. XRIH24

Mr. Jeremiah Hawkins,

Please issue the following directive as a PR for the aforementioned project. The PR includes the following drawings and written description:


- 1. Refer to Sheet E1.0 ELECTRICAL DEMOLITION OVERALL PLAN
 - a. Refer to clouded region and clouded notes stating that existing tap feeder conductors shall remain for new MP1 panelboard.
- 2. Refer to Sheet E3.0 POWER NEW WORK OVERALL PLAN
 - a. Refer to clouded region and clouded notes for provision of power to new panelboards.
 - b. General: Refer to homerun arrows and updated panel-circuit number for each circuit. This issuance shall be used for panel numbering.
- 3. Refer to Sheet E4.0 MECHANICAL POWER NEW WORK OVERALL PLAN
 - a. General: Refer to homerun arrows and updated panel-circuit number for each circuit. This issuance shall be used for panel numbering.
- 4. Refer to Sheet E4.1 MECHANICAL POWER NEW WORK ROOF PLAN
 - a. General: Refer to homerun arrows and updated panel-circuit number for each circuit. This issuance shall be used for panel numbering.
- Refer to Sheet E5.0 ELECTRICAL SCHEDULES
 - a. Refer to clouded changes on panel schedules. This issuance shall be used for panel numbering. Refer to Items (2), (3), and (4).

If you need any further assistance, please don't hesitate to contact me.


Sincerely,

Adrian Partridge

Adrian Fartridge

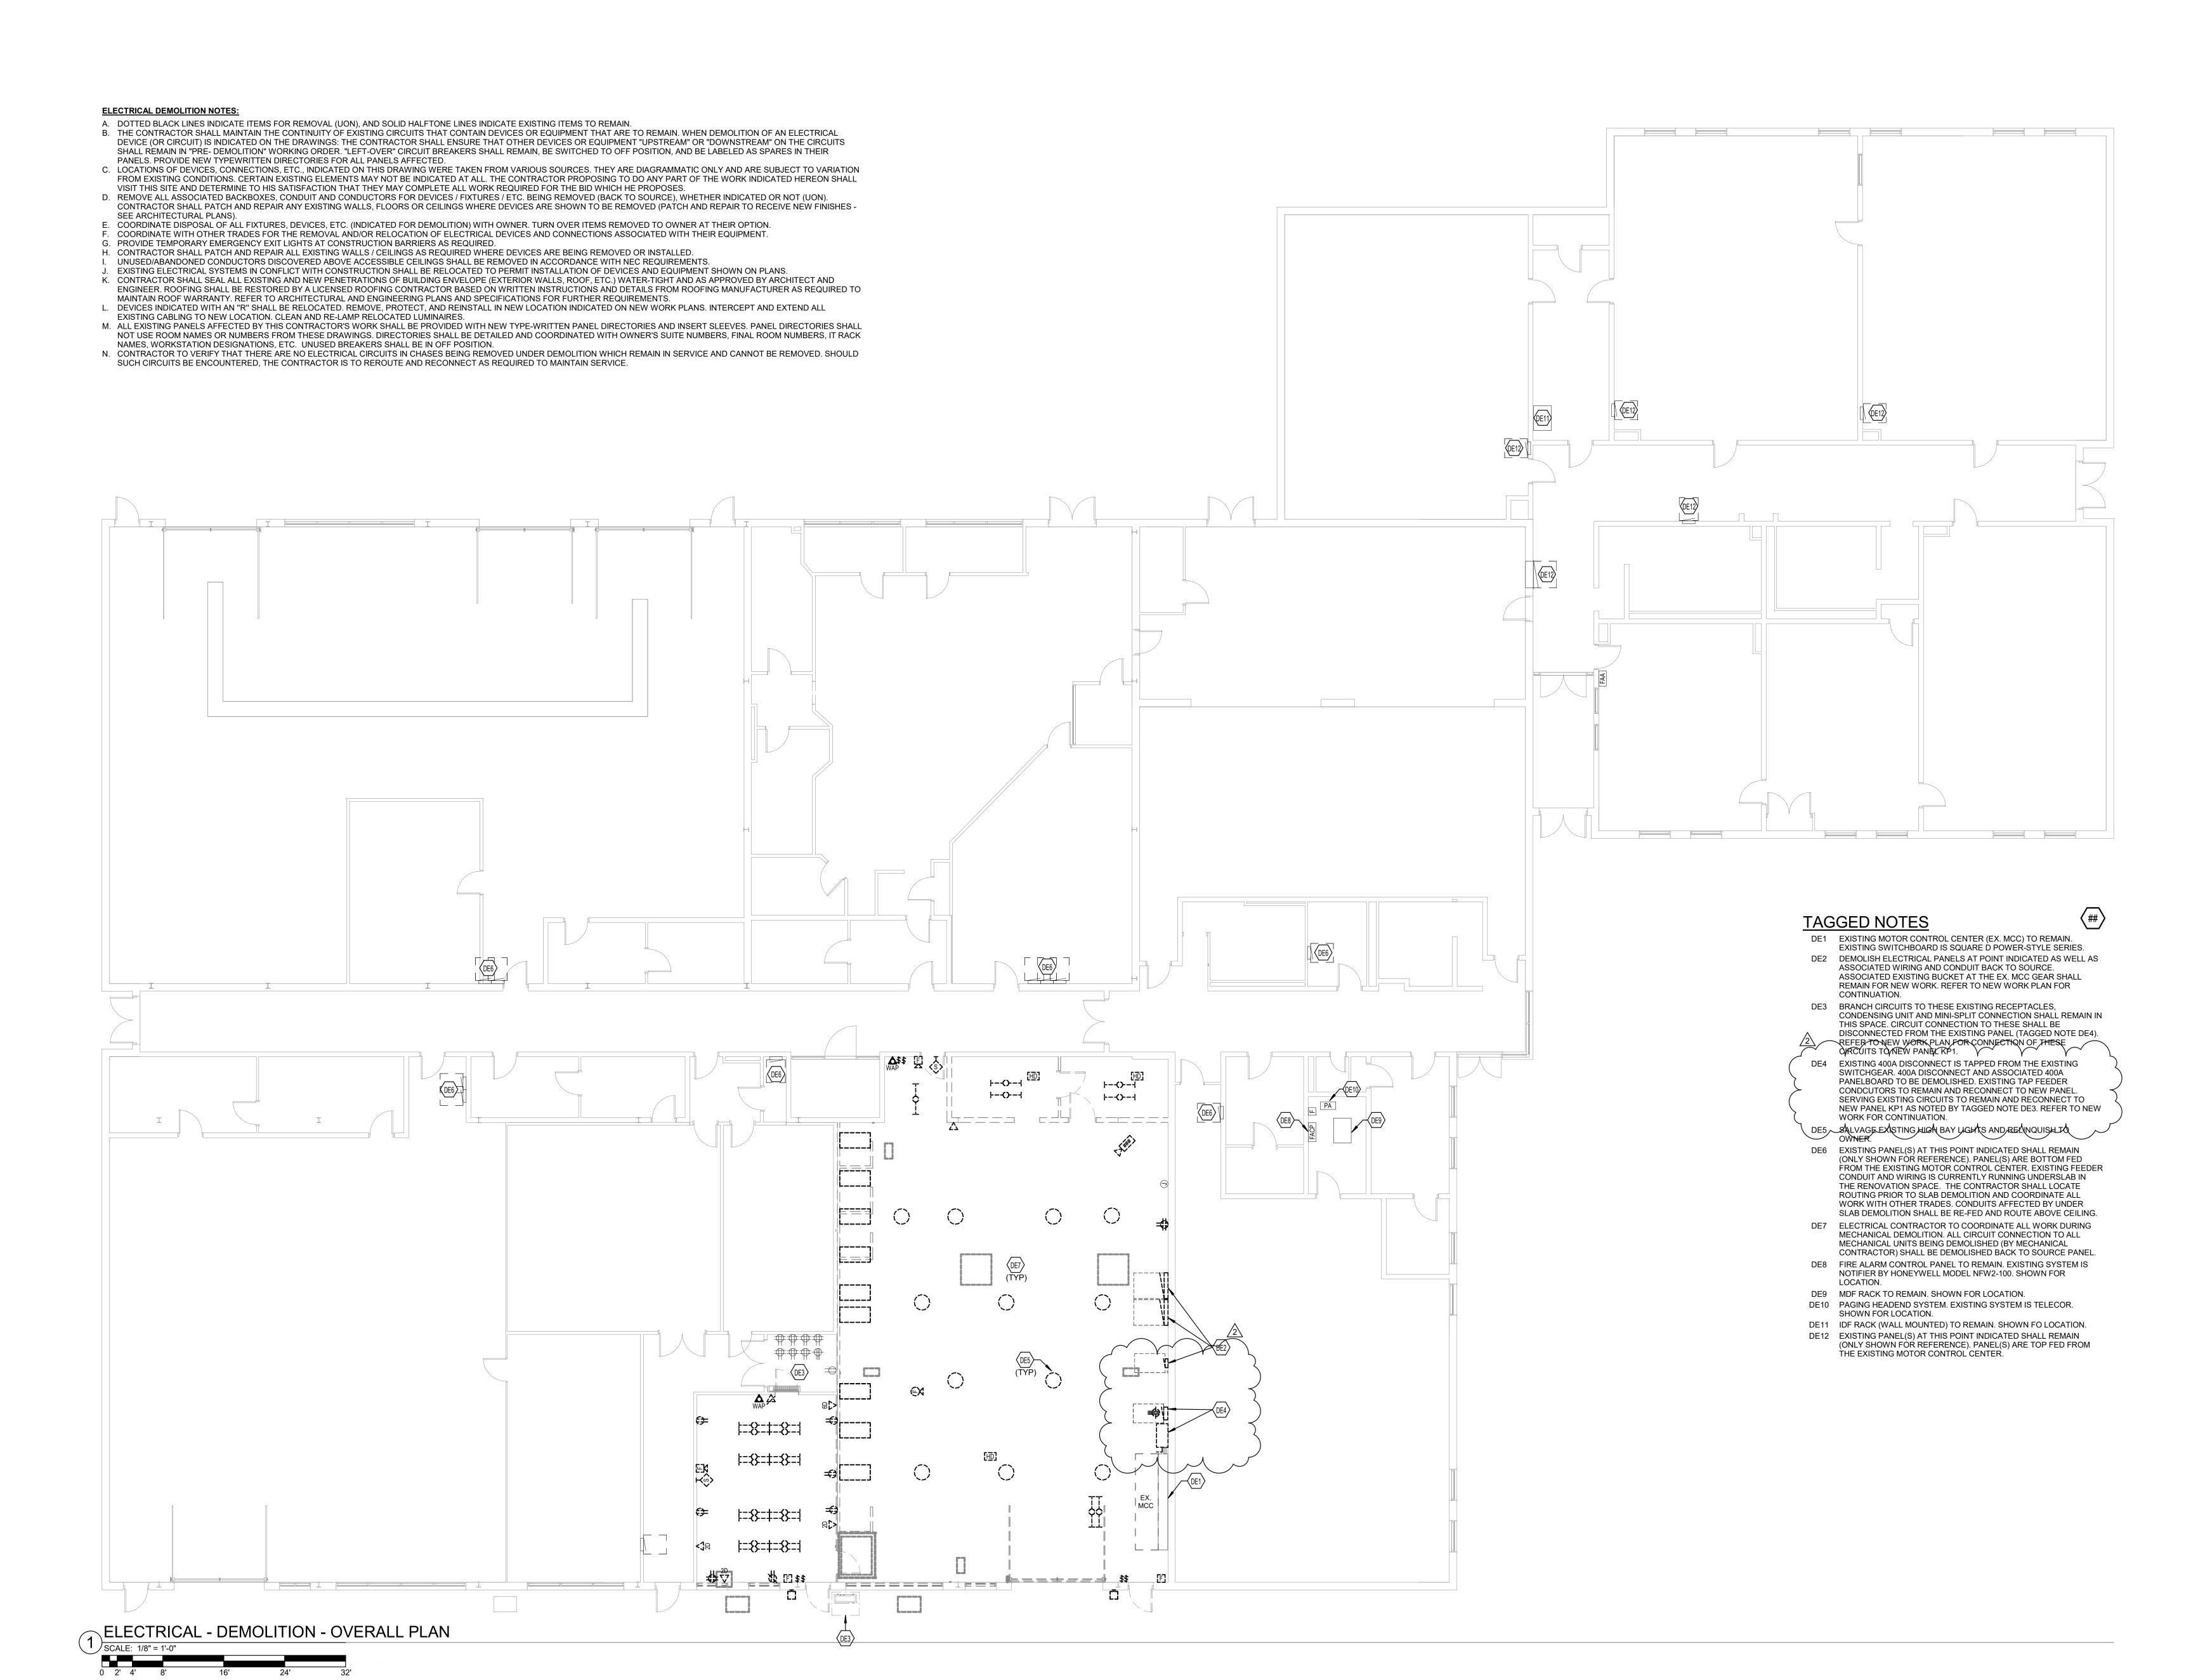



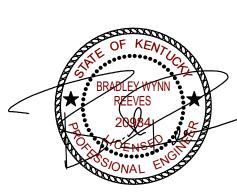

CULINARY ARTS RENOVATION

DATE 2/8/2025
PROJ. 24-23
NRAWN ASP
BY:
REVISION DATE

1 3-7-25
2 5-7-25


COPYRIGHTS RESERVED:
THIS DRAWING IS THE
PROPERTY OF HAWKINS
ABNEY, PLLC AND SHALL
NOT BE DUPLICATED OR
USED FOR ANY
CONSTRUCTION PROJECT
WITHOUT WRITTEN
CONSENT FROM THE
ARCHITECT OF RECORD.
DO NOT SCALE DRAWINGS.

ELECTRICAL


DEMOLITION
- OVERALL
PLAN

SHEET NO.

E1.0

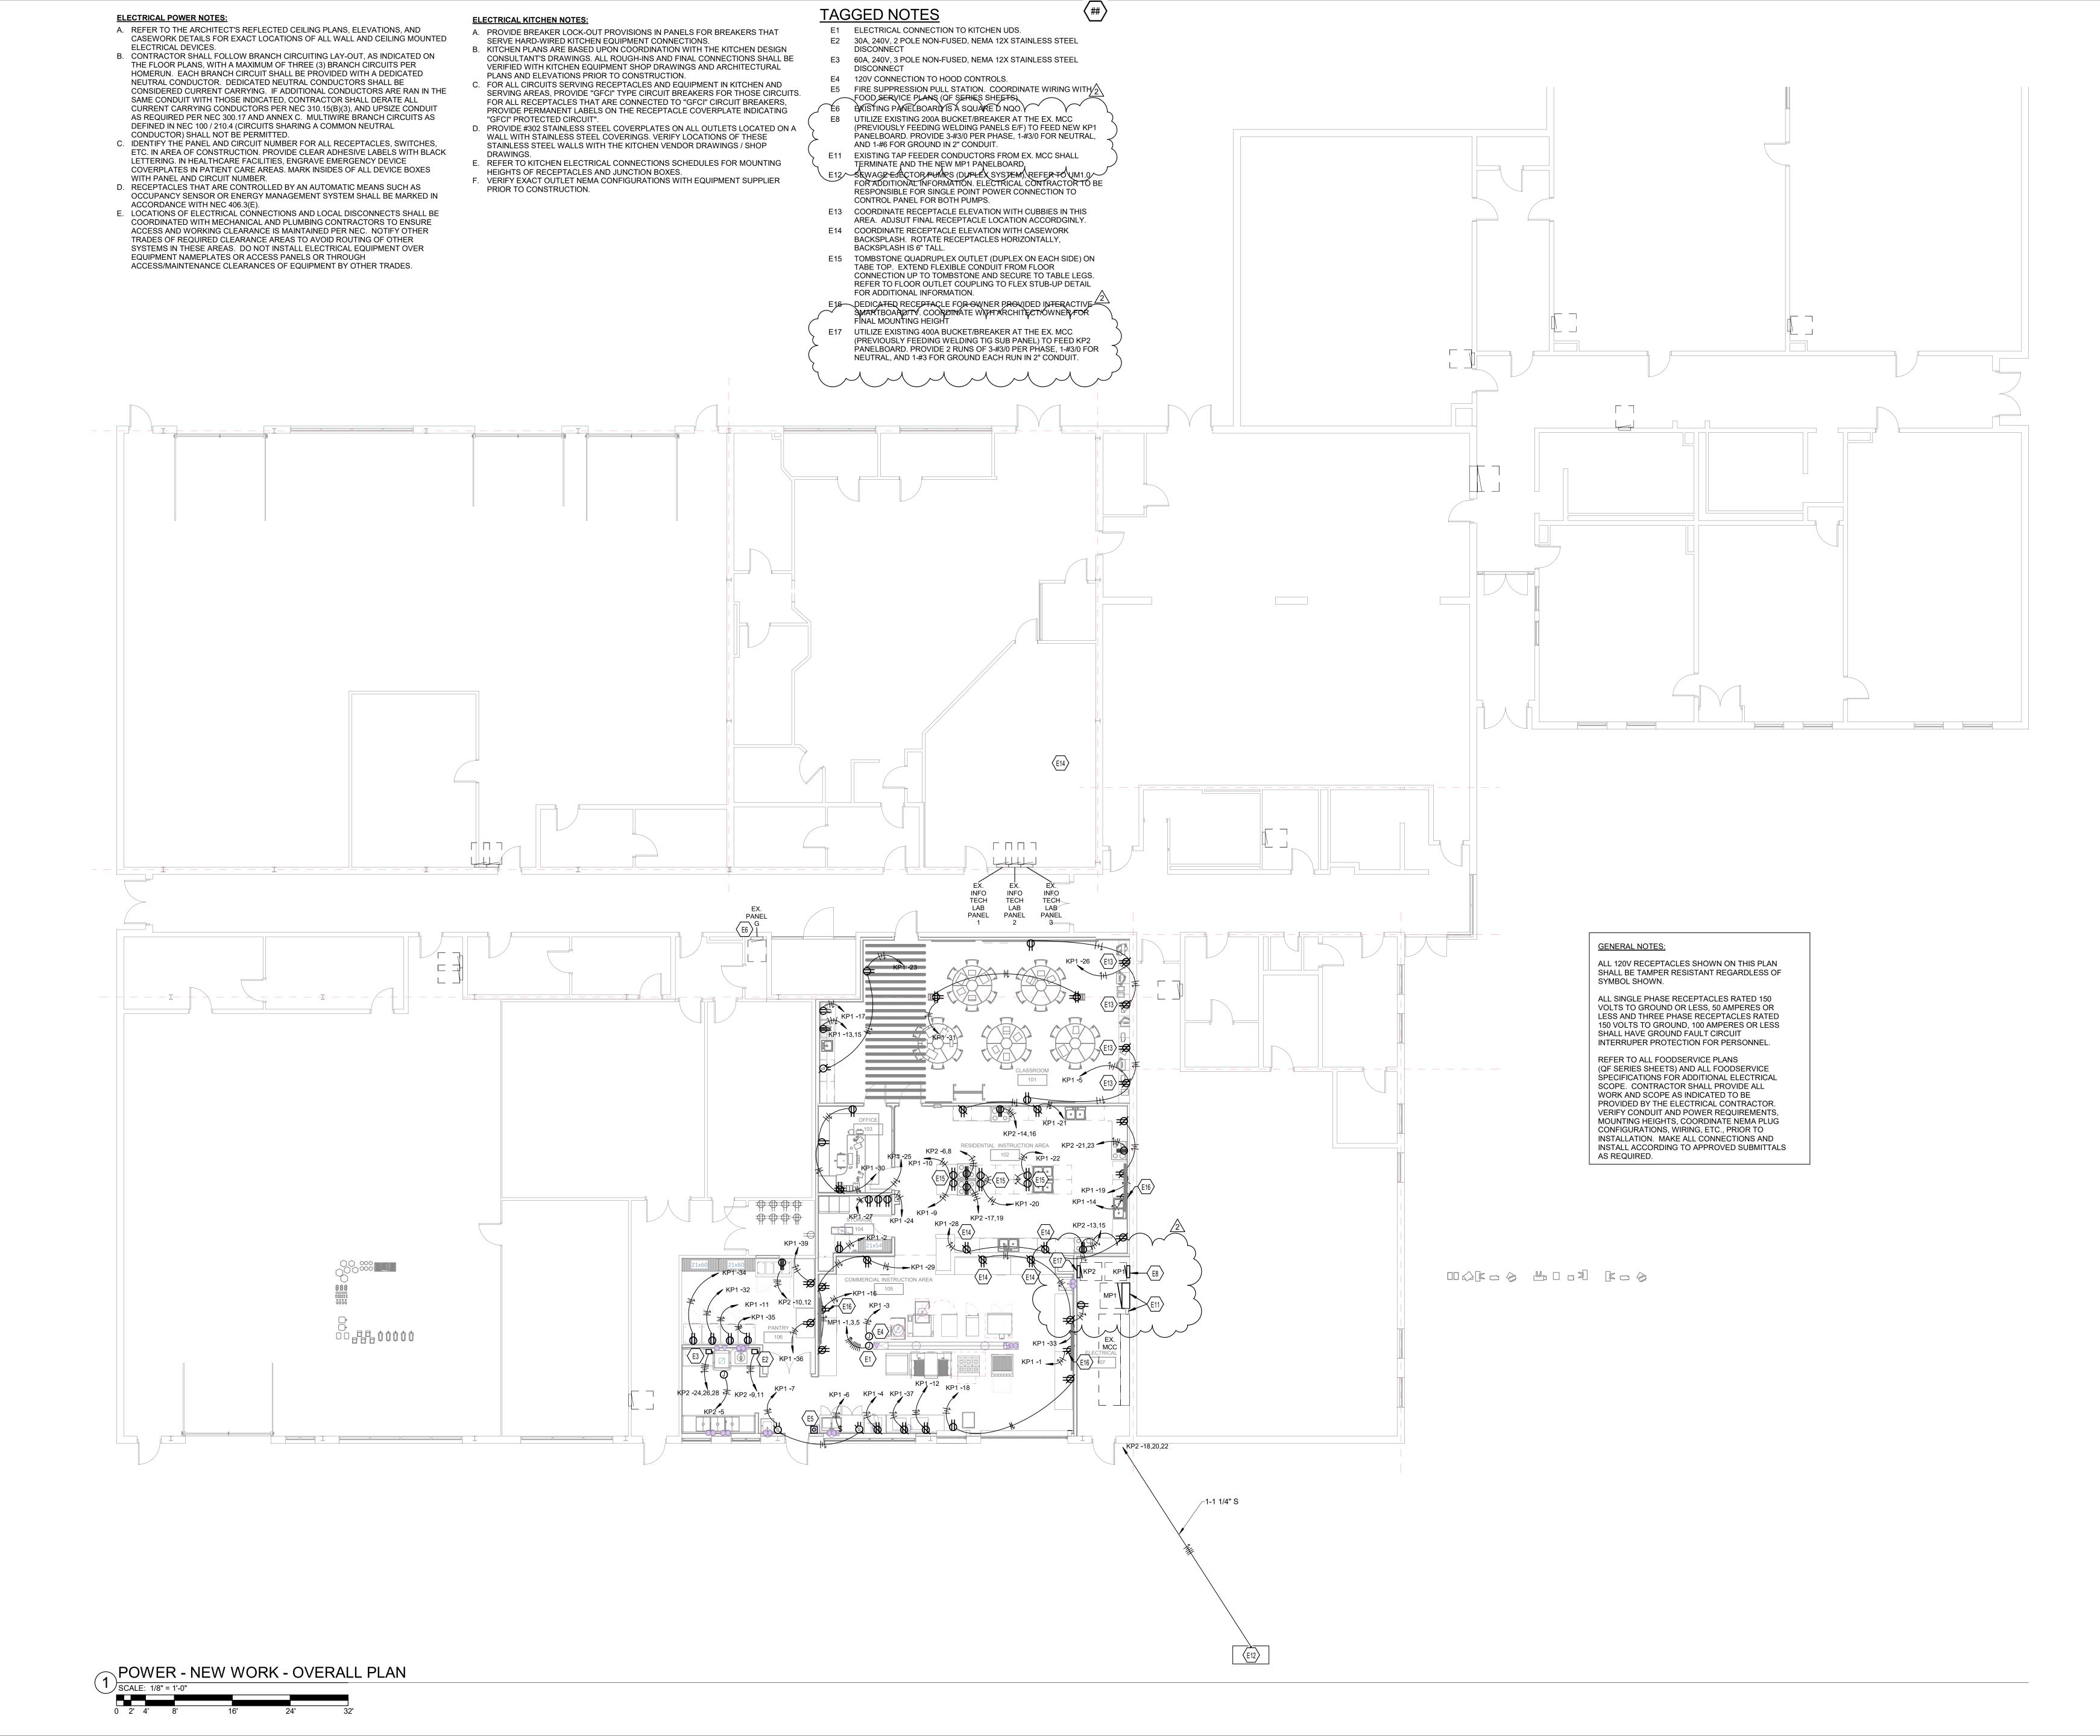



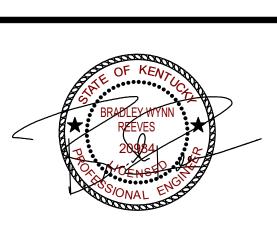

CULINARY ARTS RENOVATION

DATE 2/8/2025
PROJ. 24-23
MRAWN ASP
BY:
REVISION DATE

1 3-7-25
2 5-7-25


COPYRIGHTS RESERVED:
THIS DRAWING IS THE
PROPERTY OF HAWKINS
ABNEY, PLLC AND SHALL
NOT BE DUPLICATED OR
USED FOR ANY
CONSTRUCTION PROJECT
WITHOUT WRITTEN
CONSENT FROM THE
ARCHITECT OF RECORD.
DO NOT SCALE DRAWINGS.

POWER -NEW WORK -OVERALL PLAN

SHEET NO.

E3.0



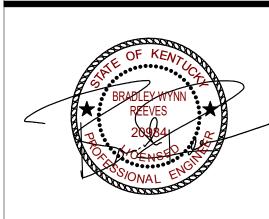

ARTS RENOVATION

DATE 2/8/2025
PROJ. 24-23
NRAWN ASP
BY:
REVISION DATE

COPYRIGHTS RESERVED:
THIS DRAWING IS THE
PROPERTY OF HAWKINS
ABNEY, PLLC AND SHALL
NOT BE DUPLICATED OR
USED FOR ANY
CONSTRUCTION PROJECT
WITHOUT WRITTEN
CONSENT FROM THE
ARCHITECT OF RECORD.
DO NOT SCALE DRAWINGS.

MECHANICAL POWER -NEW WORK -OVERALL PLAN

SHEET NO.

E4.0

HOMERUN. EACH BRANCH CIRCUIT SHALL BE PROVIDED WITH A DEDICATED NEUTRAL CONDUCTOR. DEDICATED NEUTRAL CONDUCTORS SHALL BE CONSIDERED CURRENT CARRYING. IF ADDITIONAL CONDUCTORS ARE RAN IN THE SAME CONDUIT WITH THOSE INDICATED, CONTRACTOR SHALL DERATE ALL CURRENT CARRYING CONDUCTORS PER NEC 310.15(B)(3), AND UPSIZE CONDUIT AS REQUIRED PER NEC 300.17 AND ANNEX C. MULTIWIRE BRANCH CIRCUITS AS DEFINED IN NEC 100 / 210.4 (CIRCUITS SHARING A COMMON NEUTRAL CONDUCTOR) SHALL NOT BE PERMITTED.

C. IDENTIFY THE PANEL AND CIRCUIT NUMBER FOR ALL RECEPTACLES, SWITCHES, ETC. IN AREA OF CONSTRUCTION. PROVIDE ENGRAVED LAMACOID LABLES FOR ALL EXTERIOR DEVICES. MARK INSIDES OF ALL DEVICE BOXES WITH PANEL AND CIRCUIT NUMBER.

D. PROVIDE UNI-STRUT AS REQUIRED FOR MOUNTING OF ALL DEVICES ON ROOF.

COORDINATE WITH ROOFING CONTRACTOR PRIOR TO CONSTRUCTION FOR ALL PENETRATIONS. SEAL PENETRATIONS AS REQUIRED PER ROOFING CONTRACTOR AND ROOFING MANUFACTURER'S RECOMMENDATIONS AS REQUIRED TO MAINTAIN ROOF WARRANTY. PROVIDE CURBS AND/OR FLASHED BOOTS AT ALL DEVICES AND PENETRATIONS.

E. CONDUITS SHALL PENETRATE ROOF FROM BELOW AS CLOSE TO FINAL ROOF

E. CONDUITS SHALL PENETRATE ROOF FROM BELOW AS CLOSE TO FINAL ROOF EQUIPMENT TERMINATION POINT AS POSSIBLE. SUPPORT ALL ROOF MOUNTED CONDUITS AT INTERVALS NOT EXCEEDING 10 FEET WITH STRUT-BASED SUPPORT SYSTEM. SUPPORT SYSTEM TO BE CADDY PYRAMID ST SERIES OR APPROVED

F. ALL CONDUIT EXPOSED TO DIRECT SUNLIGHT SHALL BE AT LEAST 12" ABOVE THE ROOF-TOP. NO CONDUIT SHALL BE EXPOSED TO DIRECT SUNLIGHT BELOW THIS

HEIGHT.

G. WHERE RACEWAY OR CONDUCTORS ARE INSTALLED EXPOSED ON ROOF,

DERATE AMPACITY OF CONDUCTORS IN ACCORDANCE WITH NEC.

H. LOCATIONS OF ELECTRICAL CONNECTIONS AND LOCAL DISCONNECTS SHALL BE COORDINATED WITH MECHANICAL AND PLUMBING CONTRACTORS TO ENSURE ACCESS AND WORKING CLEARANCE IS MAINTAINED PER NEC. NOTIFY OTHER TRADES OF REQUIRED CLEARANCE AREAS TO AVOID ROUTING OF OTHER SYSTEMS IN THESE AREAS. DO NOT INSTALL ELECTRICAL EQUIPMENT OVER EQUIPMENT NAMEPLATES OR ACCESS PANELS OR THROUGH ACCESS/MAINTENANCE CLEARANCES OF EQUIPMENT BY OTHER TRADES.

I. PROVIDE MAINTENANCE RECEPTACLE WITHIN 25 FT OF EACH MECHANICAL UNIT AS REQUIRED BY NEC. COORDINATE INSTALLATION LOCATIONS WITH FINAL

MECHANICAL POWER - NEW WORK - ROOF

PLAN

SCALE: 1/8" = 1'-0"

0 2' 4' 8'

ELECTRICAL POWER NOTES:

A. REFER TO THE ARCHITECT'S REFLECTED CEILING PLANS, ELEVATIONS, AND CASEWORK DETAILS FOR EXACT LOCATIONS OF ALL WALL AND CEILING MOUNTED ELECTRICAL DEVICES.

ELECTRICAL DEVICES.

B. CONTRACTOR SHALL FOLLOW BRANCH CIRCUITING LAY-OUT, AS INDICATED ON THE FLOOR PLANS, WITH A MAXIMUM OF THREE (3) BRANCH CIRCUITS PER HOMERUN. EACH BRANCH CIRCUIT SHALL BE PROVIDED WITH A DEDICATED NEUTRAL CONDUCTOR. DEDICATED NEUTRAL CONDUCTORS SHALL BE CONSIDERED CURRENT CARRYING. IF ADDITIONAL CONDUCTORS ARE RAN IN THE SAME CONDUIT WITH THOSE INDICATED, CONTRACTOR SHALL DERATE ALL CURRENT CARRYING CONDUCTORS PER NEC 310.15(B)(3), AND UPSIZE CONDUIT AS REQUIRED PER NEC 300.17 AND ANNEX C. MULTIWIRE BRANCH CIRCUITS AS DEFINED IN NEC 100 / 210.4 (CIRCUITS SHARING A COMMON NEUTRAL

CONDUCTOR) SHALL NOT BE PERMITTED.

C. IDENTIFY THE PANEL AND CIRCUIT NUMBER FOR ALL RECEPTACLES, SWITCHES, ETC. IN AREA OF CONSTRUCTION. PROVIDE CLEAR ADHESIVE LABELS WITH BLACK LETTERING. IN HEALTHCARE FACILITIES, ENGRAVE EMERGENCY DEVICE COVERPLATES IN PATIENT CARE AREAS. MARK INSIDES OF ALL DEVICE BOXES WITH PANEL AND CIRCUIT NUMBER.


D. RECEPTACLES THAT ARE CONTROLLED BY AN AUTOMATIC MEANS SUCH AS OCCUPANCY SENSOR OR ENERGY MANAGEMENT SYSTEM SHALL BE MARKED IN ACCORDANCE WITH NEC 406.3(E).

E. LOCATIONS OF ELECTRICAL CONNECTIONS AND LOCAL DISCONNECTS SHALL BE COORDINATED WITH MECHANICAL AND PLUMBING CONTRACTORS TO ENSURE ACCESS AND WORKING CLEARANCE IS MAINTAINED PER NEC. NOTIFY OTHER TRADES OF REQUIRED CLEARANCE AREAS TO AVOID ROUTING OF OTHER SYSTEMS IN THESE AREAS. DO NOT INSTALL ELECTRICAL EQUIPMENT OVER EQUIPMENT NAMEPLATES OR ACCESS PANELS OR THROUGH ACCESS/MAINTENANCE CLEARANCES OF EQUIPMENT BY OTHER TRADES.


TAGGED NOTES

E7 REFER TO KP2 PANEL SCHEDULE FOR WIRE SIZE AND OCPD RATING. DISCONNECT FURNISHED BY MECHANICAL CONTRACTOR AND ELECTRICAL CONTRACTOR TO INSTALL AND PROVIDE SUPPLY CIRCUIT CONNECTION.

E9 UNIT IS PROVIDED WITH INTEGRAL MOTOR STARTER CONTROL PANEL WITH DISCONNECT. ELECTRICAL CONTRACTOR TO FURNISH AND INSTALL CIRCUIT CONNECTION TO PANEL AT MAU-1 AND EXTEND TO EXHAUST FAN UNIT. REFER TO PANEL SCHEDULE FOR OCPD AND WIRE SIZE. REFER TO FOODSERVICE PLANS FOR ADDITIONAL ELECTRICAL SCOPE.

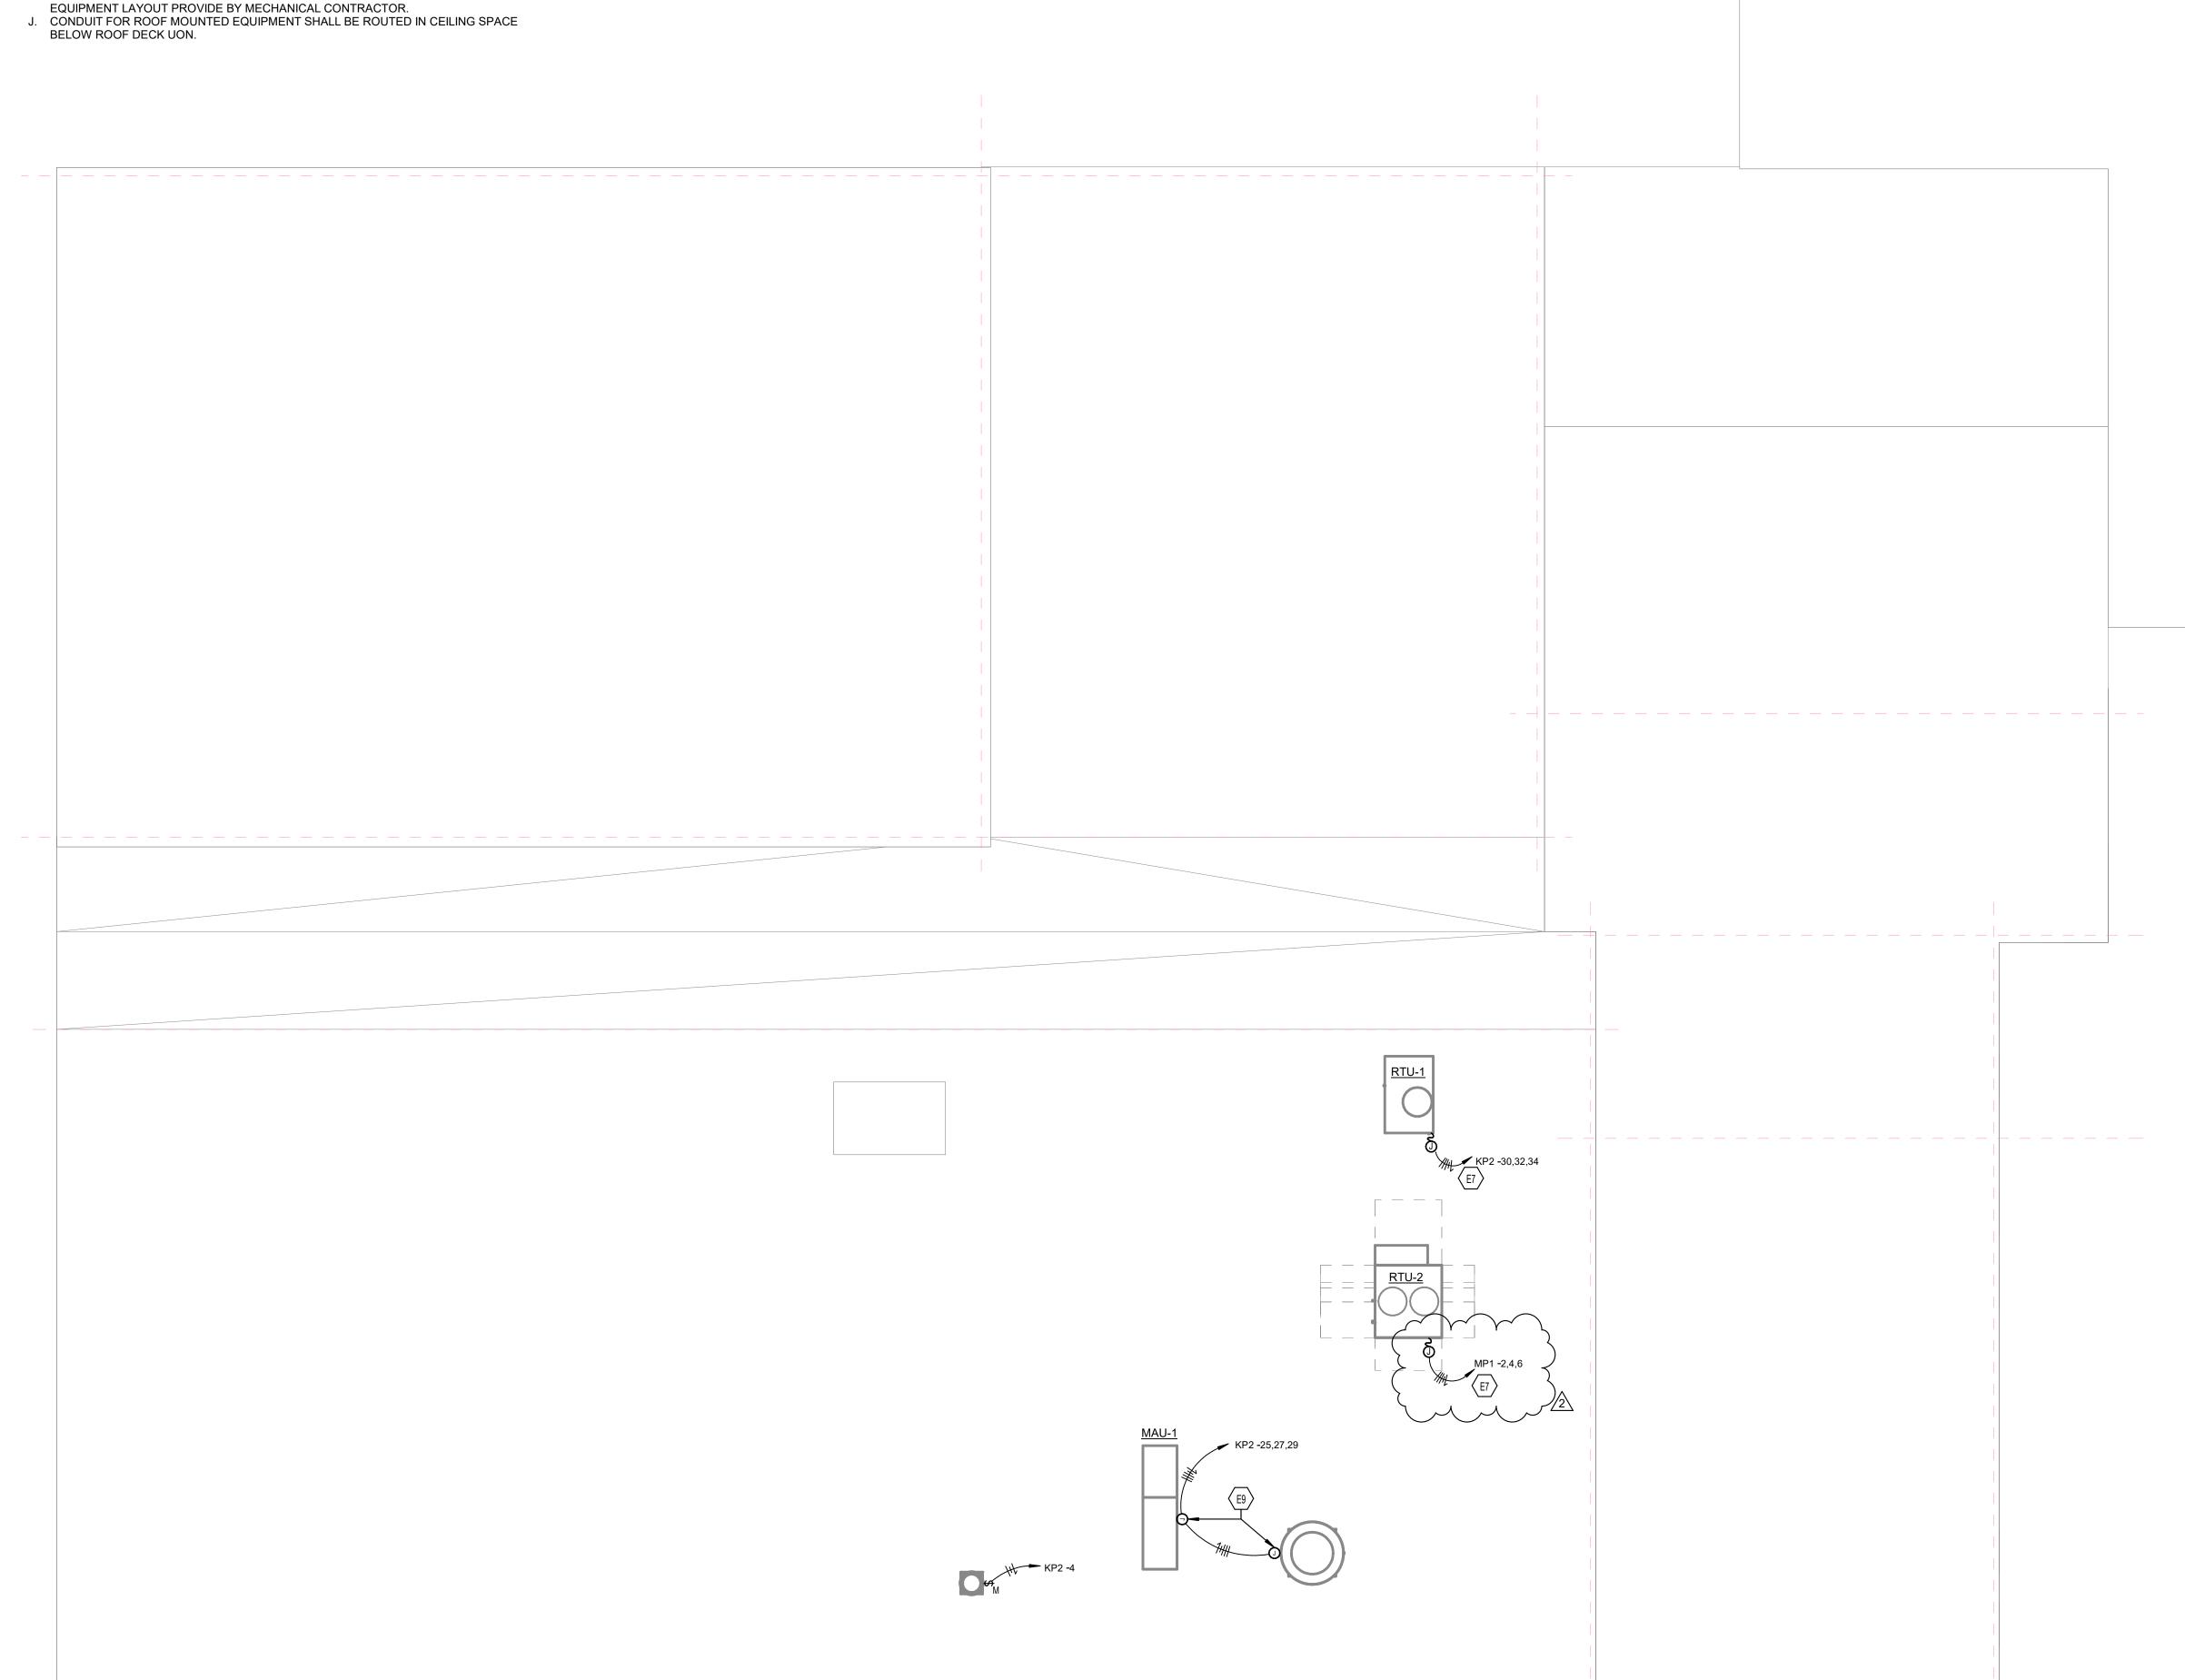



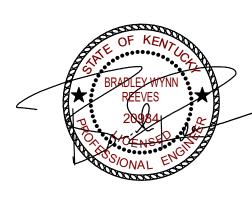

CULINARY ARTS RENOVATION

DATE 2/8/2025
PROJ. 24-23
NRAWN ASP
BY:
REVISION DATE

1 3-7-25
2 5-7-25

COPYRIGHTS RESERVED:
THIS DRAWING IS THE
PROPERTY OF HAWKINS
ABNEY, PLLC AND SHALL
NOT BE DUPLICATED OR
USED FOR ANY
CONSTRUCTION PROJECT
WITHOUT WRITTEN
CONSENT FROM THE
ARCHITECT OF RECORD.
DO NOT SCALE DRAWINGS.

MECHANICAL POWER -NEW WORK -ROOF PLAN

SHEET NO.

E4.1


		ELEC - LUMINAIR	E SCHEDU	JLE						
TYPE	DESCRIPTION	BASIS OF DESIGN	EQUALS	LAMPS / CCT	DRIVER	MINIMUM LUMENS	MOUNTING	MAXIMUM WATTAGE	VOLTAGE	REMARKS
A1	2' X 2' VOLUMETRIC TROFFER WITH HIGH EFFICIENCY DRIVER.	LITHONIA 2BLT2-33LHE-ADP-EZ1-LP840	METALUX, COLUMBIA	LED / 4000K	0-10V DIM TO 1%	3336	RECESSED	25	120	
A1E	SAME AS ABOVE WITH 10 W EMERGENCY BATTERY PACK.	LITHONIA 2BLT2-33LHE-ADP-LP840-EZ1-EL14L	METALUX, COLUMBIA	LED / 4000K	0-10V DIM TO 1%	3336	RECESSED	25	120	
A2	2' X 2' VOLUMETRIC TROFFER WITH HIGH EFFICIENCY DRIVER.	LITHONIA 2BLT2-40LHE-ADP-EZ1-LP840	METALUX, COLUMBIA	LED / 4000K	0-10V DIM TO 1%	4155	RECESSED	30	120	
A2E	SAME AS ABOVE WITH 10 W EMERGENCY BATTERY PACK.	LITHONIA 2BLT2-40LHE-ADP-EZ1-LP840-EL14L	METALUX, COLUMBIA	LED / 4000K	0-10V DIM TO 1%	4155	RECESSED	30	120	
C1	6" RECESSED CAN LIGHT FIXTURE	GOTHAM EVO6-40/05-EZ1	PRESCOLITE, HALO	LED / 4000K	0-10V DIM TO 1%	463	RECESSED	7	120	
C2	6" RECESSED CAN LIGHT FIXTURE, FOOD SERVICE	GOTHAM EVO6FS-40/10-EZ1	PRESCOLITE, HALO	LED / 4000K	0-10V DIM TO 1%	870	RECESSED	10	120	
F1	INDUSTRIAL STRIP LIGHT	LITHONIA ZL1D-L48-5000LM	COLUMBIA, WILLIAMS	LED / 4000K	NON DIMMING	5541	PENDANT 9' A.F.F.	41	120	
F1E	SAME AS ABOVE WITH 10 W EMERGENCY BATTERY PACK.	LITHONIA ZL1D-L48-5000LM-E10W	COLUMBIA, WILLIAMS	LED / 4000K	NON DIMMING	5541	PENDANT 9' A.F.F.	41	120	
K1	2' X 2' RECESSED WET LOCATION TROFFER.	LITHONIA 2WRTL-F-L24-5000LM-AFL-MVOLT-EZ1-40K-80CRI	METALUX, COLUMBIA	LED / 4000K	0-10V DIM TO 1%	5081	RECESSED	41	120	
K1E	SAME AS ABOVE WITH 10 W EMERGENCY BATTERY PACK.	LITHONIA 2WRTL-F-L24-5000LM-AFL-MVOLT-EZ1-40K-80CRI-E10W-LCP	METALUX, COLUMBIA	LED / 4000K	0-10V DIM TO 1%	5081	RECESSED	41	120	
L1	4" X 8' PENDANT LINEAR FIXTURE	MARK S4PD-8FT-80CRI-40K-400LMF-MIN10	METALUX, COLUMBIA	LED / 4000K	0-10V DIM TO 1%	400LMF	PENDANT	26	120	
X1	SINGLE FACED EXIT SIGN W/ RED LETTERING	LITHONIA LQM	PATHWAY, EVENLITE					2		RED LETTERING

	PANEL: KP1					MAIN	S TYPI	E: MLC)			PANE	L IN	TERRU	IPTING RATING: 42K/	** *		
	VOLTAGE : 208Y/120V,3P,4W						SPI) :				LOCATION: ELECTRICAL 107						
	AMPERES: 225 A					MO	UNTING	S: SUR	FACE		SUPPLY FROM: EX. MCC							
TES	CIRCUIT DESCRIPTION	HOT, NEUT, GND	ОСР	Р	СКТ	,	4	Е	3	(;	СКТ	Р	ОСР	HOT, NEUT, GND	CIRCUIT DESCRIPTION	NOTE	
FI	REC - TV	1-#12, 1-#12, 1-#12	20	1	1	0.2	0.8					2	1	20	1-#12, 1-#12, 1-#12	REC ICE MAKER W/ BIN	GFI	
	HOOD CONTROLS	1-#12, 1-#12, 1-#12	20	1	3			0.5	0.7			4	1	20	1-#12, 1-#12, 1-#12	SLICER	GFI	
	REC 101 CLASSROOM	1-#12, 1-#12, 1-#12	20	1	5					0.5	1.0	6	1	20	1-#12, 1-#12, 1-#12	DISPOSER		
1	REC 105 COMMERCIAL INSTR. AREA	1-#12, 1-#12, 1-#12	20	1	7	0.8	0.9					8	1	20	1-#12, 1-#12, 1-#12	H-1 KITCHEN RESIDENTIAL HOODS		
1	REC	1-#12, 1-#12, 1-#12	20	1	9			0.8	0.8			10	1	20	1-#12, 1-#12, 1-#12	REC	GFI	
Ι	REFRIGERATOR FREEZER,	1-#12, 1-#12, 1-#12	15	1	11					1.0	1.0	12	1	20	1-#12, 1-#12, 1-#12	CATERING WARMER	GFI	
	PDV5D	0 1140 4 1140 4 1140			13	0.8	0.2					14	1	20	1-#12, 1-#12, 1-#12	REC - TV	GFI	
1	DRYER	2-#10, 1-#10, 1-#10	30	2	15			0.8	0.2			16	1	20	1-#12, 1-#12, 1-#12	REC - TV	GFI	
1	WASHER	1-#12, 1-#12, 1-#12	20	1	17					0.2	0.4	18	1	20	1-#12, 1-#12, 1-#12	REC 105 COMMERCIAL INSTR. AREA		
	REC 102 RES. INSTR. AREA	1-#12, 1-#12, 1-#12	20	1	19	0.4	0.4					20	1	20	1-#12, 1-#12, 1-#12	REC	GFI	
	REC 102 RESIDENTIAL	1-#12, 1-#12, 1-#12	20	1	21			0.4	0.4			22	1	20	1-#12, 1-#12, 1-#12	REC - RES INSTRUCTION AREA 102	GFI	
	REC 101 CLASSROOM	1-#12, 1-#12, 1-#12	20	1	23					0.4	0.5	24	1	20	1-#12, 1-#12, 1-#12	UNDERSINK PUMP	GFI	
1	REC WATER HEATER	1-#12, 1-#12, 1-#12	20	1	25	0.5	0.5					26	1	20	1-#12, 1-#12, 1-#12	REC 101 CLASSROOM		
	REC WATER HEATER	1-#12, 1-#12, 1-#12	20	1	27			0.5	0.5			28	1	20	1-#12, 1-#12, 1-#12	REC 102 RES. INSTR. AREA	GFI	
	REC 105 COMMERCIAL	1-#12, 1-#12, 1-#12	20	1	29					0.5	0.7	30	1	20	1-#12, 1-#12, 1-#12	REC OFFICE 103		
	REC 101 CLASSROOM	1-#12, 1-#12, 1-#12	20	1	31	0.7	1.0					32	1	15	1-#12, 1-#12, 1-#12	REFRIGERATOR FREEZER	GFI	
1	REC 105 COMMERCIAL INSTR. AREA	1-#12, 1-#12, 1-#12	20	1	33			0.7	1.0			34	1	15	1-#12, 1-#12, 1-#12	REFRIGERATOR FREEZER,	GFI	
	REFRIGERATOR FREEZER,	1-#12, 1-#12, 1-#12	15	1	35			• • • • • • • • • • • • • • • • • • • •		1.0	1.0	36	1	20	1-#12, 1-#12, 1-#12	SANDWICH BAR	GFI	
	DISPLAY CASE	1-#12, 1-#12, 1-#12	20	1	37	1.0	0.0					38	1	20	-	SPARE	GFI	
	SALAD BAR	1-#12, 1-#12, 1-#12	20	1	39			1.0	0.0			40	1	20		SPARE	GFI	
1	SPARE		20	1	41					0.0	0.0	42	1	20		SPARE	GFI	
1	SPARE		20	1	43	0.0	0.0					44	1	20		SPARE	GFI	
Ť	SPARE		20	1	45	0.0	0.0	0.0	0.0			46	1	20		SPARE	GFI	
	SPARE		20	1	47					0.0	0.0	48	1	20		SPARE	-	
	SPARE		20	1	49	0.0	0.0			0.0	0.0	50	1	20		SPARE		
	SPARE		20	1	51	0.0	0.0	0.0	0.0			52	1	20		SPARE		
	SPARE		20	1	53			0.0	0.0	0.0	0.0	54	1	20		SPARE		
	OI / UKE		20	<u> </u>	_ 00	8.1	kVA	8.1	L k\/Δ	8.1			'			OI / W.E.		
								_										
D (LACCIFICATION	CONNECTED LO	<u> </u>	DE	NA A A I C		A CD		AATED		A				DANE	LTOTALS		
	LASSIFICATION	CONNECTED LO	Aυ	DΕ		PACT	UK	ESIII		DEMA	עוי					L TOTALS Fotal connected load: 24275	1//	
JIP		3875 VA				00% 51%	-		3100									
<u>; </u>		20400 VA			74.	51%			15200	VA						TAL ESTIMATED DEMAND: 18300	VA	
																AL CONNECTED CURRENT: 67 A		
																IATED DEMAND CURRENT: 51 A		
															25	% ADDITIONAL CAPACITY: 13 A		
																TOTAL PANEL CURRENT: 63 A		

	PANEL: KP2 VOLTAGE: 208Y/120V,3P,4W						IS TYPI SPI	D:				PANE	L IN		PTING RATING: 42K LOCATION: ELE	CTRICAL 107	
	AMPERES: 400 A		,			MO	UNTING								SUPPLY FROM: EX.		
NOTES		HOT, NEUT, GND	OCP	P	СКТ		A	l	В			СКТ	Р	OCP	HOT, NEUT, GND	CIRCUIT DESCRIPTION	NOTE
	RP-1	1-#12, 1-#12, 1-#12	15	1	1	0.2	0.5					2	1	20	1-#12, 1-#12, 1-#12	WH-1	
	WH-2	1-#12, 1-#12, 1-#12	20	1	3			0.5	0.8	4.0	10	4	1	20	1-#12, 1-#12, 1-#12	EXHAUST FAN	
	COND HOOD EXHAUST	1-#10, 1-#10, 1-#10	20	1	5	0.0	4.0			1.8	4.9	6	2	50	2-#6, 1-#6, 1-#10	RANGE	GFI
	SPARE		20	1	7	0.0	4.9	0.8	2.2			8					_
	DISPOSER	2-#12, 1-#12, 1-#12	20	2	9			0.0	2.2	0.8	2.2	10	2	30	2-#10, 1-#10, 1-#10	SERVING COUNTER	
				\vdash	13	4.9	4.9			0.0	2.2	14					
GFI	RANGE	2-#6, 1-#6, 1-#10	50	2	15	4.9	4.3	4.9	4.9			16	2	50	2-#6, 1-#6, 1-#10	RANGE	GFI
					17			4.9	4.9	4.9	2.9	18					
GFI	RANGE	2-#6, 1-#6, 1-#10	50	2	19	4.9	2.9			4.3	2.5	20	3	50	3-#6, 1-#6, 1-#10	SEWAGE EJECTOR	
					21	7.5	2.5	4.9	2.9			22	"	30	3-#0, 1-#0, 1-#10	SEWAGE ESECTOR	
GFI	RANGE	2-#6, 1-#6, 1-#10	50	2	23			7.3	2.5	4.9	3.2	24					
					25	4.1	3.2			7.0	0.2	26	3	40	3-#8, 1-#8, 1-#10	DISHWASHER	
	MAU-1 AND EF UNIT	3-#8, 1-#8, 1-#10	40	3	27	1.1	0.2	4.1	3.2			28		10	0 110, 1 110, 1 1110	BIGHWAGHER	
		0 110, 1 110, 1 11 10	1-#10 40		29				0.2	4.1	4.1	30					
					31	0.0	4.1					32	3	50	3-#8, 1-#8, 1-#10	RTU-1	
	SPARE		40	3	33			0.0	4.1			34			,		
					35					0.0	0.0	36	1	20		SPARE	
					37	0.0	0.0					38					
	SPARE	_	50	3	39			0.0	0.0			40	3	30		SPARE	
					41					0.0	0.0	42					
					43	0.0	0.0					44					
	SPARE	-	20	3	45			0.0	0.0			46	3	30		SPARE	
					47					0.0	0.0	48					
GFI	SPARE		20	1	49	0.0	0.0					50	1	20	 -	SPARE	GFI
GFI	SPARE		20	1	51			0.0	0.0			52	1	20		SPARE	
	SPARE	-	20	1	53					0.0	0.0	54	1	20		SPARE	
						34.5	kVA	33.1	kVA	33.7	kVA						
						28	8 A	27	6 A	28	1 A						
LOAD (CLASSIFICATION	CONNECTED LC	AD	DE	MAND	FACT	OR	ESTI	MATED	DEMA	ND				PANI	EL TOTALS	
EQUIP		101314 VA			80.0	00%			81051	VA						TOTAL CONNECTED LOAD: 10	314 VA
															T(OTAL ESTIMATED DEMAND: 810	51 VA
																AL CONNECTED CURRENT: 28	
																MATED DEMAND CURRENT: 225	
																% ADDITIONAL CAPACITY: 56	
															20		
NOTES	: WHERE NOT LISTED, WIRE AND	OONDUIT COMME	DE 1.00		4.555	0000	151615	10110	00455	DD=::	/ED 0 =		001	45		TOTAL PANEL CURRENT: 28	^

	NEUT, GND f 3-#3/0, 1-#3/0, 1-#3	ОСР	Р	СКТ		SPI UNTINO							LOCATION: ELE	CTRICAL 107			
NOTES CIRCUIT DESCRIPTION HOT,	f 3-#3/0, 1-#3/0,	ОСР	Р	CKT		UNTING	C. CLID						LOOAHON. LLL	· · · · · · · · · · · · · · · · · · ·			
2 11100 0	f 3-#3/0, 1-#3/0,	OCP	Р	CKT			NG: SURFACE					SUPPLY FROM:					
KITCHEN UDS 2 runs o				CIVI		A	В			<u> </u>	CKT P	OCP	HOT, NEUT, GND	CIRCUIT DESCRIPTION	NOTE		
KITCHEN UDS		400		1	38.3	6.8	00.0				2	400	0.110.4.110.4.110	DTU 0			
		400	3	3 5			38.3	6.8	38.3	6.8	6 3	100	3-#3, 1-#3, 1-#8	RTU-2			
				7					36.3	0.0	8						
				9							10						
				11							12						
				13							14						
				15							16						
				17 19							18						
				21							20						
				23							24						
					45.2	kVA	45.2	kVA	45.2	kVA							
					37	6 A	370	6 A	370	6 A							
LOAD CLASSIFICATION CO	NNECTED LOA	D	DE	MAND	FACT	OR	ESTIN	MATED	D DEMAND PANEL TOTALS								
EQUIP	135450 VA			80.0	00%			108360) VA					TOTAL CONNECTED LOAD: 1354	150 VA		
													TC	DTAL ESTIMATED DEMAND: 108	360 VA		
														AL CONNECTED CURRENT: 376			
														MATED DEMAND CURRENT: 301			
													25	% ADDITIONAL CAPACITY: 75 A			
														TOTAL PANEL CURRENT: 376	Α		



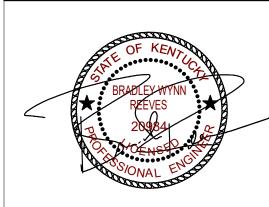

E INDEPENDENT SCHOOLS RY ARTS RENOVATION

DATE 2/8/2025
PROJ. 24-23
NRAWN ASP
BY:
REVISION DATE

1 3-7-25
2 5-7-25

COPYRIGHTS RESERVED:
THIS DRAWING IS THE
PROPERTY OF HAWKINS
ABNEY, PLLC AND SHALL
NOT BE DUPLICATED OR
USED FOR ANY
CONSTRUCTION PROJECT
WITHOUT WRITTEN
CONSENT FROM THE
ARCHITECT OF RECORD.
DO NOT SCALE DRAWINGS.

ELECTRICAL SCHEDULES

SHEET NO.

E8.0