



AIA[®] Document G731[™] – 2019

Change Order, Construction Manager as Adviser Edition

PROJECT: *(name and address)*
Christian County High School

5185 Fort Campbell Blvd
Hopkinsville, KY 42240

OWNER: *(name and address)*
Christian County Board of Education
200 Glass Avenue Hopkinsville, KY 42240

CONTRACTOR: *(name and address)*
Herring Construction
1072 State Route 373 North Eddyville, KY Fort White, FL 32038

CONTRACT INFORMATION:
Contract For: BP 010-08 Site
Excavation/Storm Drainage
Date: November 19, 2024

CHANGE ORDER INFORMATION:
Change Order Number: 065
Date: March 13, 2025

ARCHITECT: *(name and address)*
Hafer PSC
21 Southeast Third St, Ste 800 Evansville, IN 47708
CONSTRUCTION MANAGER: *(name and address)*
Alliance Corporation
116 E. College Street Glasgow, KY 42141

THE CONTRACT IS CHANGED AS FOLLOWS:

(Insert a detailed description of the change and, if applicable, attach or reference specific exhibits. Also include agreed upon adjustments attributable to executed Construction Change Directives.)

Cost associated with athletic field site grading and storm drainage per PR #28R.

The original Contract Sum was	\$	2,692,390.03
Net change by previously authorized Change Orders	\$	147,471.31
The Contract Sum prior to this Change Order was	\$	2,839,861.34
The Contract Sum will be increased by this Change Order in the amount of	\$	649,433.24
The new Contract Sum including this Change Order will be	\$	3,489,294.58

The Contract time will be unchanged by (0) days.
The Contractor's Work shall be substantially complete on .

NOTE: This Change Order does not include adjustments to the Contract Sum or Guaranteed Maximum Price, or the Contract Time, that have been authorized by Construction Change Directive until the cost and time have been agreed upon by both the Owner and Contractor, in which case a Change Order is executed to supersede the Construction Change Directive.

NOT VALID UNTIL SIGNED BY THE ARCHITECT, CONSTRUCTION MANAGER, CONTRACTOR, AND OWNER.

ARCHITECT *(Signature)*
BY: Eric Rang, Hafer PSC
(Printed name, title, and license number if required)

Date

CONSTRUCTION MANAGER *(Signature)*
BY: Kevin Hitchel, Alliance Corporation
(Printed name and title)

Date

CONTRACTOR *(Signature)*
BY: Chris Garner, Herring Construction
(Printed name and title)

Date

OWNER *(Signature)*
BY: Christopher Bentzel, Christian County Board of Education
(Printed name and title)

Date



PROPOSED CHANGE ORDER

PROJECT Christian County High School

CONTRACTOR/SUPPLIER Herring Construction

BID PACKAGE 010 65. 010-08

DETAIL ITEM	AMOUNT
LABOR	\$ 267,500.00
MATERIALS	\$ 381,933.24
PROFIT & OVERHEAD	
BOND INSURANCE	
COST BREAKDOWN TOTAL	\$ 649,433.24

DESCRIPTION

Athletic Field Site Grading and Storm Drainage per PR #28R.

PR # 28R *(ATTACH PR)*

CHANGE ORDER INITIATED BY:

- ARCHITECT/ENGINEER
- OWNER
- CONTRACTOR
- CM
- CODE OFFICIAL
- OTHER _____

PLEASE INCLUDE THIS FORM WITH EVERY CHANGE ORDER.

PROPOSAL REQUEST

Project: Christian County High School PR No.: 028r1
5185 Ft. Campbell Blvd
Hopkinsville, KY 42240 Date: January 3, 2025

Owner: Christian County Public Schools Project Number: 2106-204
222 Glass Ave
Hopkinsville, KY 42240 Contract for:

To: Kevin Hitchell
Alliance Corporation
116 E. College Steet
Glasgow, KY 42141

RE: **Athletic Field Site Grading and Storm Drainage & Sidwalks - Revised**

Please submit an itemized quotation for changes in the Contract Sum and/or Time incidental to proposed modifications to the Contract Documents described herein.
THIS IS NOT A CHANGE ORDER NOR A DIRECTION TO PROCEED WITH THE WORK DESCRIBED HEREIN.

Description:

- 1) Provide price provide Site Grading and Storm Drainage for Athletic Fields and Greenhouse as shown in attached revised civil sheets. Provide concrete sidewalks and concrete walkways as noted on attached plans. Omit baseball hatched area of baseball and softball fields, these will be bid out as a separate project along with tennis court and track.

1/3/2025 – Revision includes raising fields to account for excess soil on site.

Attachments: C3.0, C3.2, C3.3, C4.2, C4.3, C5.2, C6.1
Additional R1 sheets include C3.01, C3.5,

By: Rick Harper, Eric Rang

CC:

HAFER
 1181 S. 11th Street, Hopkinsville, KY 40424
 Phone: 502-231-1412 Fax: 502-231-1413

ALLIANCE
 1181 S. 11th Street, Hopkinsville, KY 40424
 Phone: 502-231-1412

bell
 1181 S. 11th Street, Hopkinsville, KY 40424
 Phone: 502-231-1412

K&S Engineering PLLC
 1181 S. 11th Street, Hopkinsville, KY 40424
 Phone: 502-231-1412

WBM
 1181 S. 11th Street, Hopkinsville, KY 40424
 Phone: 502-231-1412

CTE Pledge and Equipment Co.
 1181 S. 11th Street, Hopkinsville, KY 40424
 Phone: 502-231-1412

SITE KEY PLAN




NO.	DESCRIPTION	DATE
1	AS-BUILT	11/15/10
2	CONCEPT PLAN	11/15/10
3	PRELIMINARY PLAN	11/15/10
4	FINAL PLAN	11/15/10
5	AS-BUILT	11/15/10


SITE LAYOUT PLAN
 Architect's Project No: 2106-201
 Date: May, 2021
 Drawing No: BELL # 731-002



- 1) GENERAL USE CLASSIFICATION: #1**
- 1. ALL UTILITIES TO BE SHOWN AND LOCATED BY THE CONTRACTOR.
 - 2. ALL UTILITIES TO BE SHOWN AND LOCATED BY THE CONTRACTOR.
 - 3. ALL UTILITIES TO BE SHOWN AND LOCATED BY THE CONTRACTOR.
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 - 54. ALL UTILITIES TO BE SHOWN AND LOCATED BY THE CONTRACTOR.

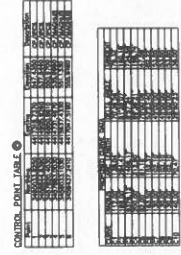

POINT	NO.	COORDINATES (EASTING)	COORDINATES (NORTHING)
1	245011.00	41772.00	41772.00
2	245012.00	41773.00	41773.00
3	245013.00	41774.00	41774.00
4	245014.00	41775.00	41775.00
5	245015.00	41776.00	41776.00
6	245016.00	41777.00	41777.00
7	245017.00	41778.00	41778.00
8	245018.00	41779.00	41779.00
9	245019.00	41780.00	41780.00
10	245020.00	41781.00	41781.00
11	245021.00	41782.00	41782.00
12	245022.00	41783.00	41783.00
13	245023.00	41784.00	41784.00
14	245024.00	41785.00	41785.00
15	245025.00	41786.00	41786.00
16	245026.00	41787.00	41787.00
17	245027.00	41788.00	41788.00
18	245028.00	41789.00	41789.00
19	245029.00	41790.00	41790.00
20	245030.00	41791.00	41791.00
21	245031.00	41792.00	41792.00
22	245032.00	41793.00	41793.00
23	245033.00	41794.00	41794.00
24	245034.00	41795.00	41795.00
25	245035.00	41796.00	41796.00
26	245036.00	41797.00	41797.00
27	245037.00	41798.00	41798.00
28	245038.00	41799.00	41799.00
29	245039.00	41800.00	41800.00
30	245040.00	41801.00	41801.00
31	245041.00	41802.00	41802.00
32	245042.00	41803.00	41803.00
33	245043.00	41804.00	41804.00
34	245044.00	41805.00	41805.00
35	245045.00	41806.00	41806.00
36	245046.00	41807.00	41807.00
37	245047.00	41808.00	41808.00
38	245048.00	41809.00	41809.00
39	245049.00	41810.00	41810.00
40	245050.00	41811.00	41811.00
41	245051.00	41812.00	41812.00
42	245052.00	41813.00	41813.00
43	245053.00	41814.00	41814.00
44	245054.00	41815.00	41815.00
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46	245056.00	41817.00	41817.00
47	245057.00	41818.00	41818.00
48	245058.00	41819.00	41819.00
49	245059.00	41820.00	41820.00
50	245060.00	41821.00	41821.00
51	245061.00	41822.00	41822.00
52	245062.00	41823.00	41823.00
53	245063.00	41824.00	41824.00
54	245064.00	41825.00	41825.00

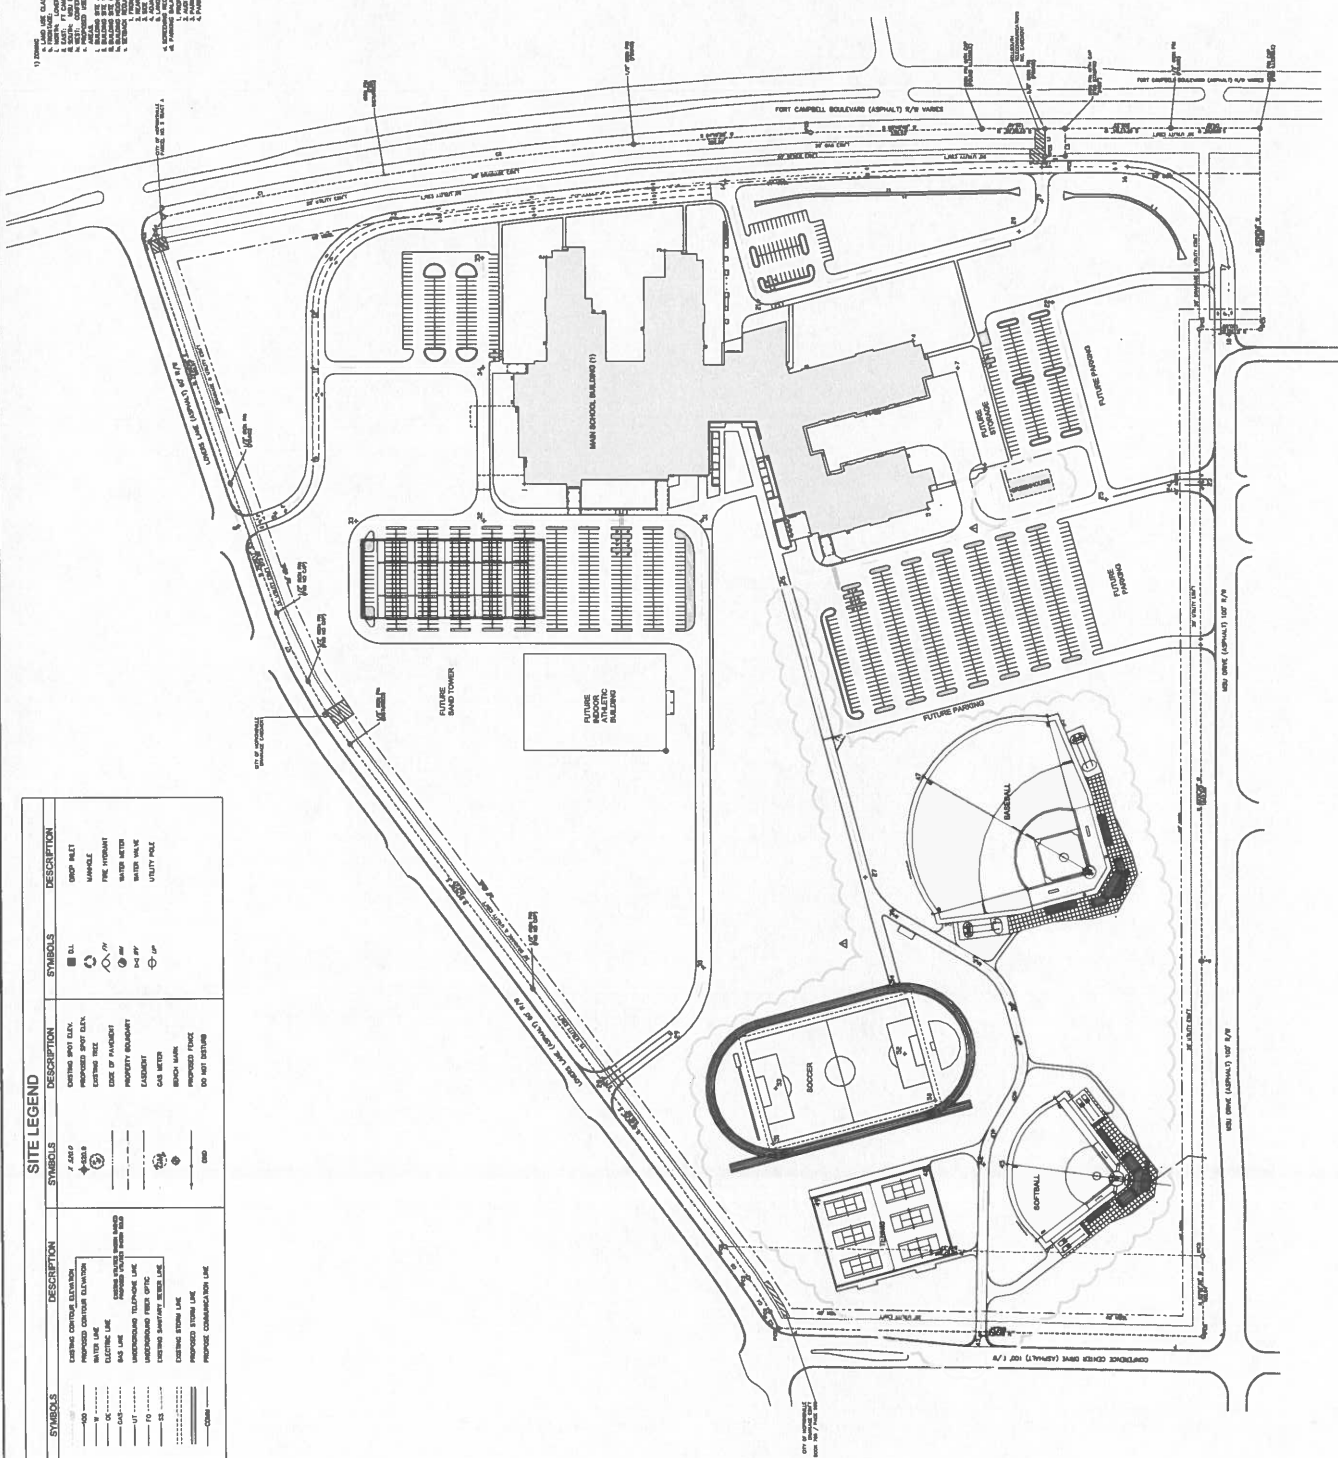

SITE LAYOUT PLAN
 SCALE: 1" = 100'




- 1. ROAD CLASSIFICATION #
- 2. CURB - 1' CURB (MINIMUM FOR ADA)
- 3. SIDEWALK - 5' SIDEWALK (MINIMUM FOR ADA)
- 4. DRIVEWAY - 10' DRIVEWAY (MINIMUM FOR ADA)
- 5. DRIVEWAY - 12' DRIVEWAY (MINIMUM FOR ADA)
- 6. DRIVEWAY - 14' DRIVEWAY (MINIMUM FOR ADA)
- 7. DRIVEWAY - 16' DRIVEWAY (MINIMUM FOR ADA)
- 8. DRIVEWAY - 18' DRIVEWAY (MINIMUM FOR ADA)
- 9. DRIVEWAY - 20' DRIVEWAY (MINIMUM FOR ADA)
- 10. DRIVEWAY - 22' DRIVEWAY (MINIMUM FOR ADA)
- 11. DRIVEWAY - 24' DRIVEWAY (MINIMUM FOR ADA)
- 12. DRIVEWAY - 26' DRIVEWAY (MINIMUM FOR ADA)
- 13. DRIVEWAY - 28' DRIVEWAY (MINIMUM FOR ADA)
- 14. DRIVEWAY - 30' DRIVEWAY (MINIMUM FOR ADA)
- 15. DRIVEWAY - 32' DRIVEWAY (MINIMUM FOR ADA)
- 16. DRIVEWAY - 34' DRIVEWAY (MINIMUM FOR ADA)
- 17. DRIVEWAY - 36' DRIVEWAY (MINIMUM FOR ADA)
- 18. DRIVEWAY - 38' DRIVEWAY (MINIMUM FOR ADA)
- 19. DRIVEWAY - 40' DRIVEWAY (MINIMUM FOR ADA)
- 20. DRIVEWAY - 42' DRIVEWAY (MINIMUM FOR ADA)
- 21. DRIVEWAY - 44' DRIVEWAY (MINIMUM FOR ADA)
- 22. DRIVEWAY - 46' DRIVEWAY (MINIMUM FOR ADA)
- 23. DRIVEWAY - 48' DRIVEWAY (MINIMUM FOR ADA)
- 24. DRIVEWAY - 50' DRIVEWAY (MINIMUM FOR ADA)
- 25. DRIVEWAY - 52' DRIVEWAY (MINIMUM FOR ADA)
- 26. DRIVEWAY - 54' DRIVEWAY (MINIMUM FOR ADA)
- 27. DRIVEWAY - 56' DRIVEWAY (MINIMUM FOR ADA)
- 28. DRIVEWAY - 58' DRIVEWAY (MINIMUM FOR ADA)
- 29. DRIVEWAY - 60' DRIVEWAY (MINIMUM FOR ADA)
- 30. DRIVEWAY - 62' DRIVEWAY (MINIMUM FOR ADA)
- 31. DRIVEWAY - 64' DRIVEWAY (MINIMUM FOR ADA)
- 32. DRIVEWAY - 66' DRIVEWAY (MINIMUM FOR ADA)
- 33. DRIVEWAY - 68' DRIVEWAY (MINIMUM FOR ADA)
- 34. DRIVEWAY - 70' DRIVEWAY (MINIMUM FOR ADA)
- 35. DRIVEWAY - 72' DRIVEWAY (MINIMUM FOR ADA)
- 36. DRIVEWAY - 74' DRIVEWAY (MINIMUM FOR ADA)
- 37. DRIVEWAY - 76' DRIVEWAY (MINIMUM FOR ADA)
- 38. DRIVEWAY - 78' DRIVEWAY (MINIMUM FOR ADA)
- 39. DRIVEWAY - 80' DRIVEWAY (MINIMUM FOR ADA)
- 40. DRIVEWAY - 82' DRIVEWAY (MINIMUM FOR ADA)
- 41. DRIVEWAY - 84' DRIVEWAY (MINIMUM FOR ADA)
- 42. DRIVEWAY - 86' DRIVEWAY (MINIMUM FOR ADA)
- 43. DRIVEWAY - 88' DRIVEWAY (MINIMUM FOR ADA)
- 44. DRIVEWAY - 90' DRIVEWAY (MINIMUM FOR ADA)
- 45. DRIVEWAY - 92' DRIVEWAY (MINIMUM FOR ADA)
- 46. DRIVEWAY - 94' DRIVEWAY (MINIMUM FOR ADA)
- 47. DRIVEWAY - 96' DRIVEWAY (MINIMUM FOR ADA)
- 48. DRIVEWAY - 98' DRIVEWAY (MINIMUM FOR ADA)
- 49. DRIVEWAY - 100' DRIVEWAY (MINIMUM FOR ADA)

SITE LEGEND	
SYMBOLS	DESCRIPTION
---	EXISTING CURB/ELEVATION
---	PROPOSED CURB/ELEVATION
---	EXISTING SIDEWALK
---	PROPOSED SIDEWALK
---	EXISTING DRIVEWAY
---	PROPOSED DRIVEWAY
---	EXISTING UTILITY PILE
---	PROPOSED UTILITY PILE
---	EXISTING FIRE HYDRANT
---	PROPOSED FIRE HYDRANT
---	EXISTING WATER METER
---	PROPOSED WATER METER
---	EXISTING WATER VALVE
---	PROPOSED WATER VALVE
---	EXISTING UTILITY POLE
---	PROPOSED UTILITY POLE

PAVEMENT AND CONCRETE LEGEND

- PROPOSED ASPHALT
- PROPOSED ASPHALT/GRANULAR FILL
- PROPOSED ASPHALT/GRANULAR FILL/GRASS
- PROPOSED ASPHALT/GRANULAR FILL/GRASS/STONE
- PROPOSED ASPHALT/GRANULAR FILL/GRASS/STONE/CONCRETE
- PROPOSED ASPHALT/GRANULAR FILL/GRASS/STONE/CONCRETE/GRASS
- PROPOSED ASPHALT/GRANULAR FILL/GRASS/STONE/CONCRETE/GRASS/STONE
- PROPOSED ASPHALT/GRANULAR FILL/GRASS/STONE/CONCRETE/GRASS/STONE/CONCRETE
- PROPOSED ASPHALT/GRANULAR FILL/GRASS/STONE/CONCRETE/GRASS/STONE/CONCRETE/GRASS/STONE/CONCRETE
- PROPOSED ASPHALT/GRANULAR FILL/GRASS/STONE/CONCRETE/GRASS/STONE/CONCRETE/GRASS/STONE/CONCRETE/GRASS/STONE/CONCRETE

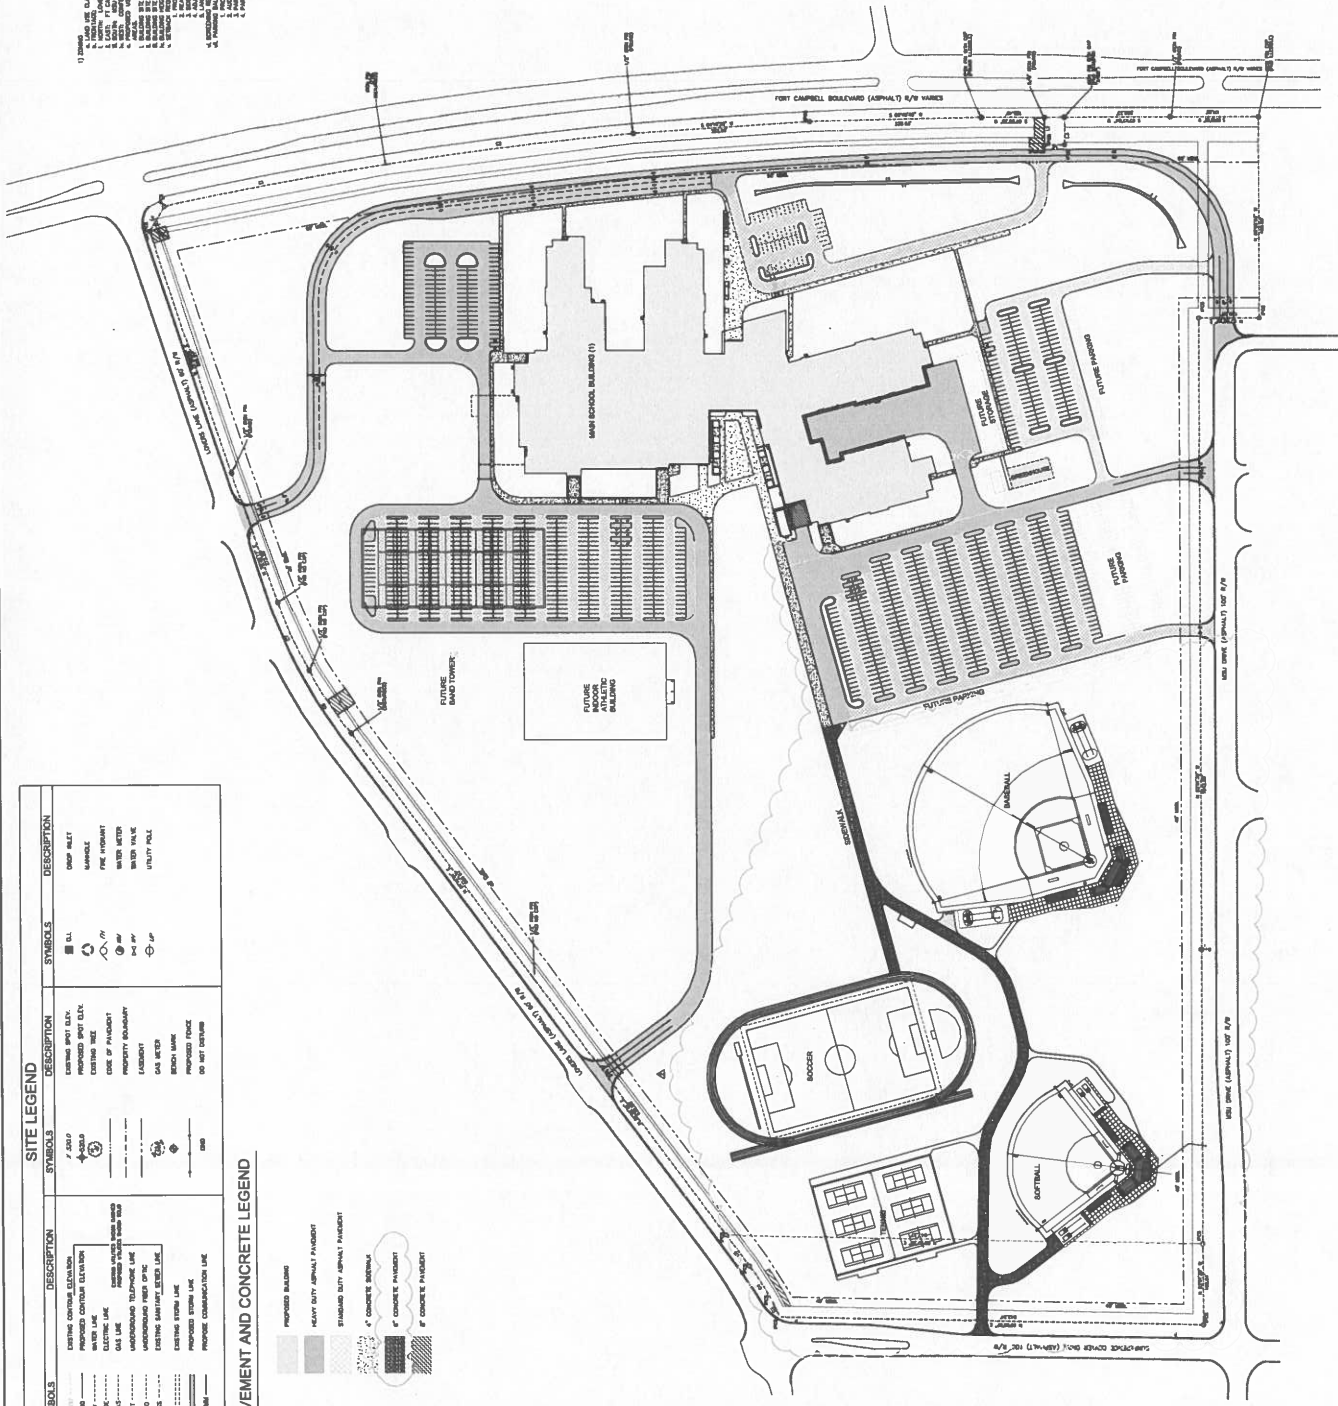

SITE PAVING AND SIGNAGE PLAN
 SCALE: 1" = 100'



BELL # 731-002

115 S. Main Street
 Hopkinsville, KY 40425
 Telephone: 270-241-1000

127 Parkside Drive
 Hopkinsville, KY 40425
 Telephone: 270-241-1000

124 Industrial Drive
 Hopkinsville, KY 40425
 Telephone: 270-241-1000

1000 S. Main Street
 Hopkinsville, KY 40425
 Telephone: 270-241-1000

100 S. Main Street
 Hopkinsville, KY 40425
 Telephone: 270-241-1000

100 S. Main Street
 Hopkinsville, KY 40425
 Telephone: 270-241-1000




NO.	REVISION	DATE
1	ISSUE FOR PERMIT	10/20/18

ENLARGED SITE PLAN
 AREA 3
 Architecture Project No: 2106-201
 Date: May, 2021
 Drawing No: BELL # 731-002

MSU DRIVE (ASPHALT) 100' R/W
 ENLARGED SITE PLAN - AREA 3
 SCALE: 1" = 40'

DETAIL LEGEND

NAME	REFERENCE
1. CURB AND UTILITY	1 / C/S
2. CONCRETE DRIVE	2 / C/S
3. ASPHALT DRIVE	3 / C/S
4. GRAVEL DRIVE	4 / C/S
5. HEAVY DUTY PAVING	5 / C/S
6. STANDARD DUTY PAVING	6 / C/S
7. LIGHT DUTY PAVING	7 / C/S
8. CONCRETE DRIVE	8 / C/S
9. ASPHALT DRIVE	9 / C/S
10. GRAVEL DRIVE	10 / C/S
11. HEAVY DUTY PAVING	11 / C/S
12. STANDARD DUTY PAVING	12 / C/S
13. LIGHT DUTY PAVING	13 / C/S
14. CONCRETE DRIVE	14 / C/S
15. ASPHALT DRIVE	15 / C/S
16. GRAVEL DRIVE	16 / C/S
17. HEAVY DUTY PAVING	17 / C/S
18. STANDARD DUTY PAVING	18 / C/S
19. LIGHT DUTY PAVING	19 / C/S
20. CONCRETE DRIVE	20 / C/S
21. ASPHALT DRIVE	21 / C/S
22. GRAVEL DRIVE	22 / C/S
23. HEAVY DUTY PAVING	23 / C/S
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25. LIGHT DUTY PAVING	25 / C/S
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28. GRAVEL DRIVE	28 / C/S
29. HEAVY DUTY PAVING	29 / C/S
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31. LIGHT DUTY PAVING	31 / C/S
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35. HEAVY DUTY PAVING	35 / C/S
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37. LIGHT DUTY PAVING	37 / C/S
38. CONCRETE DRIVE	38 / C/S
39. ASPHALT DRIVE	39 / C/S
40. GRAVEL DRIVE	40 / C/S
41. HEAVY DUTY PAVING	41 / C/S
42. STANDARD DUTY PAVING	42 / C/S
43. LIGHT DUTY PAVING	43 / C/S
44. CONCRETE DRIVE	44 / C/S
45. ASPHALT DRIVE	45 / C/S
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80. CONCRETE DRIVE	80 / C/S
81. ASPHALT DRIVE	81 / C/S
82. GRAVEL DRIVE	82 / C/S
83. HEAVY DUTY PAVING	83 / C/S
84. STANDARD DUTY PAVING	84 / C/S
85. LIGHT DUTY PAVING	85 / C/S
86. CONCRETE DRIVE	86 / C/S
87. ASPHALT DRIVE	87 / C/S
88. GRAVEL DRIVE	88 / C/S
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90. STANDARD DUTY PAVING	90 / C/S
91. LIGHT DUTY PAVING	91 / C/S
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93. ASPHALT DRIVE	93 / C/S
94. GRAVEL DRIVE	94 / C/S
95. HEAVY DUTY PAVING	95 / C/S
96. STANDARD DUTY PAVING	96 / C/S
97. LIGHT DUTY PAVING	97 / C/S
98. CONCRETE DRIVE	98 / C/S
99. ASPHALT DRIVE	99 / C/S
100. GRAVEL DRIVE	100 / C/S

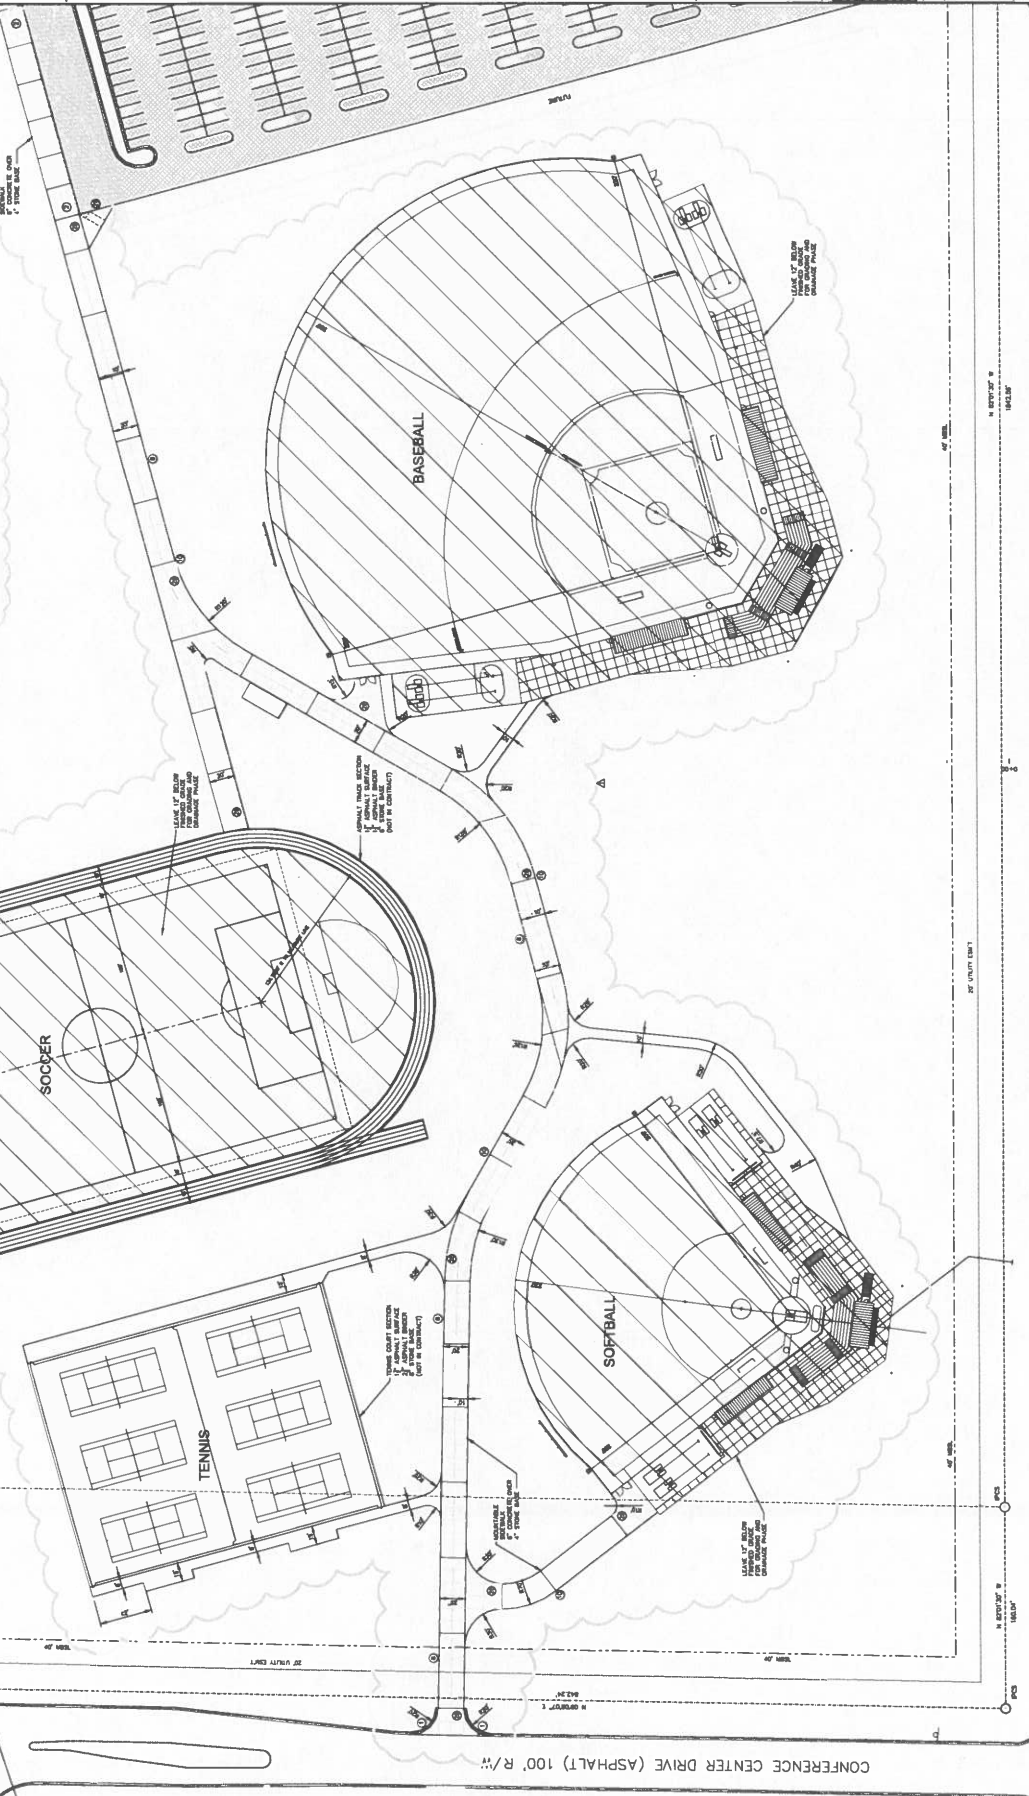

MSU DRIVE (ASPHALT) 100' R/W
 ENLARGED SITE PLAN - AREA 3
 SCALE: 1" = 40'


BELL # 731-002



DATE: 05/22/18

1848 FT CAMPBELL BLVD
 HOPKINSVILLE, KY 42240

















HAFER
 ARCHITECTS & ENGINEERS, L.P.
 1101 1/2 S. MAIN ST.
 HOPKINSVILLE, KY 42240
 TEL: 248-1311
 FAX: 248-1315
 WWW.HAFERARCHITECTS.COM

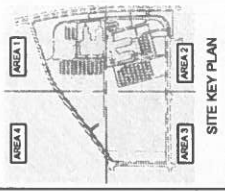

NO.	DATE	BY	DESCRIPTION
1	05/22/18	DLB	ISSUED FOR PERMIT

DETAILS
 Architects Project No.: 2108-201
 Date: May, 2012
 Drawing No.: C3.5

C3.5

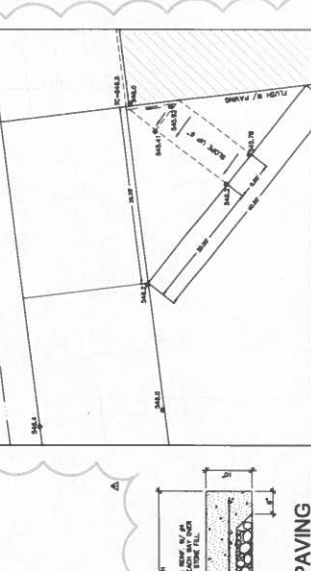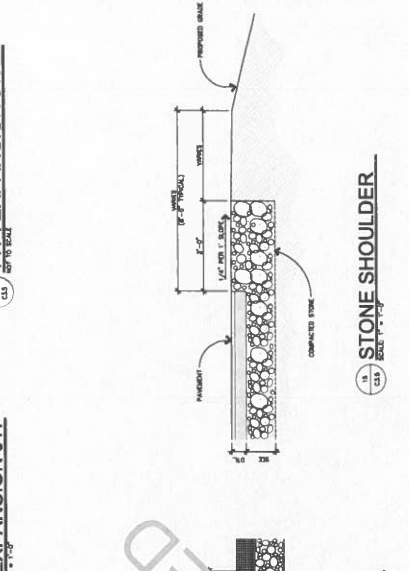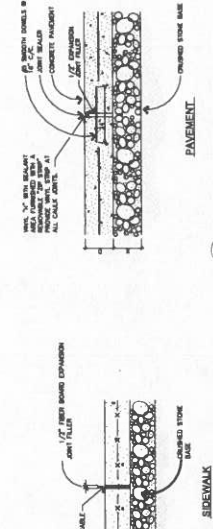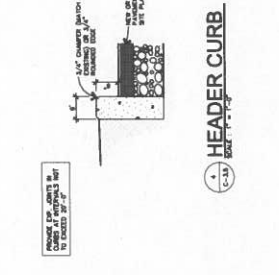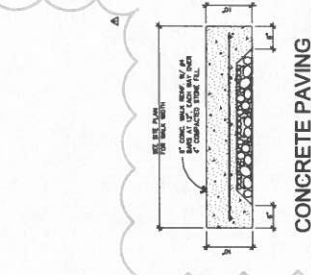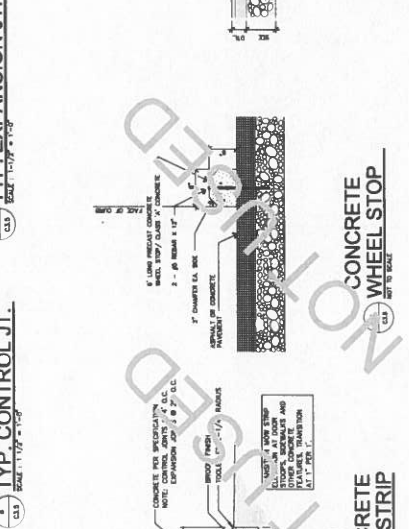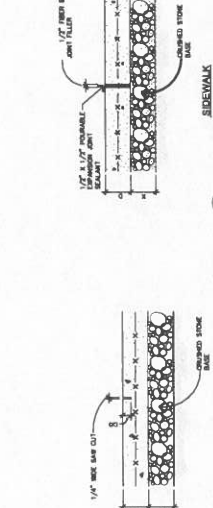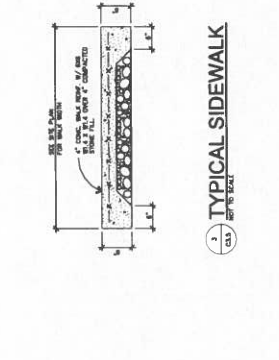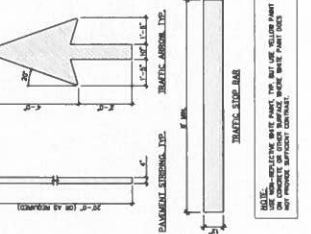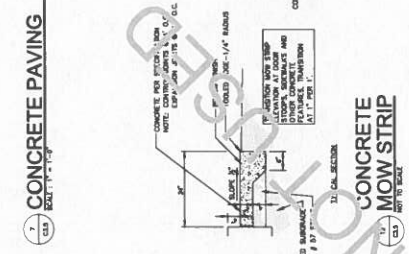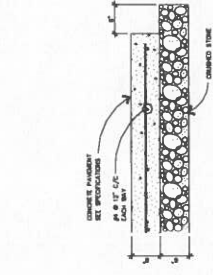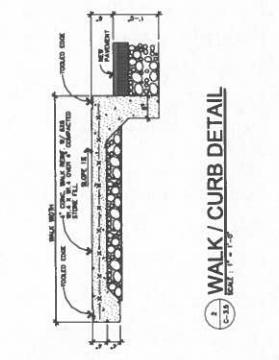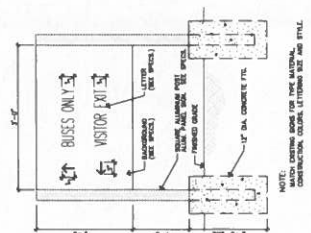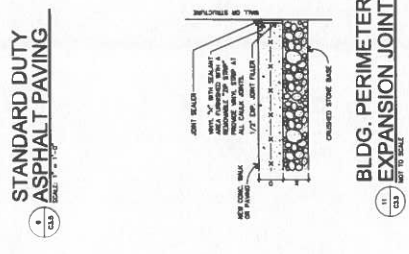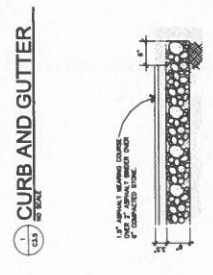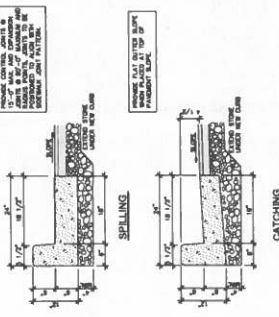

16. PAVEMENT MARKINGS
 SCALE: 1/4" = 1'-0"

17. DIRECTIONAL SIGN
 SCALE: 1/4" = 1'-0"

18. CONCRETE PAVING (MOUNTABLE SIDEWALK)
 SCALE: 1/4" = 1'-0"

19. HANDICAP RAMP DETAIL
 SCALE: 1/4" = 1'-0"

20. STONE SHOULDER
 SCALE: 1/4" = 1'-0"

21. TYP. EXPANSION JT.
 SCALE: 1/4" = 1'-0"


22. TYP. EXPANSION JT.
 SCALE: 1/4" = 1'-0"

23. WALK / CURB DETAIL
 SCALE: 1/4" = 1'-0"

24. TYPICAL SIDEWALK
 SCALE: 1/4" = 1'-0"

25. HEAVY DUTY ASPHALT PAVING
 SCALE: 1/4" = 1'-0"

26. BLDG. PERIMETER EXPANSION JOINT
 SCALE: 1/4" = 1'-0"

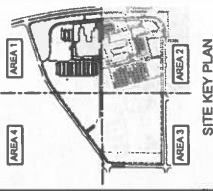


PROJECT NO.	2106-201
DATE	MAY, 2021
PROJECT NAME	HOPKINSVILLE - CHRISTIAN COUNTY ACADEMY
CLIENT	CHRISTIAN COUNTY PUBLIC SCHOOLS
DESIGNED BY	DAVID D. BELL
CHECKED BY	DAVID D. BELL
DATE	MAY, 2021

SITE GRADING AND DRAINAGE PLAN AREA 2
 Architects Project No. 2106-201
 Date: May, 2021
 Drawing No. C4.2

10' = 40'
 GRAPHIC SCALE

BELL # 731-002

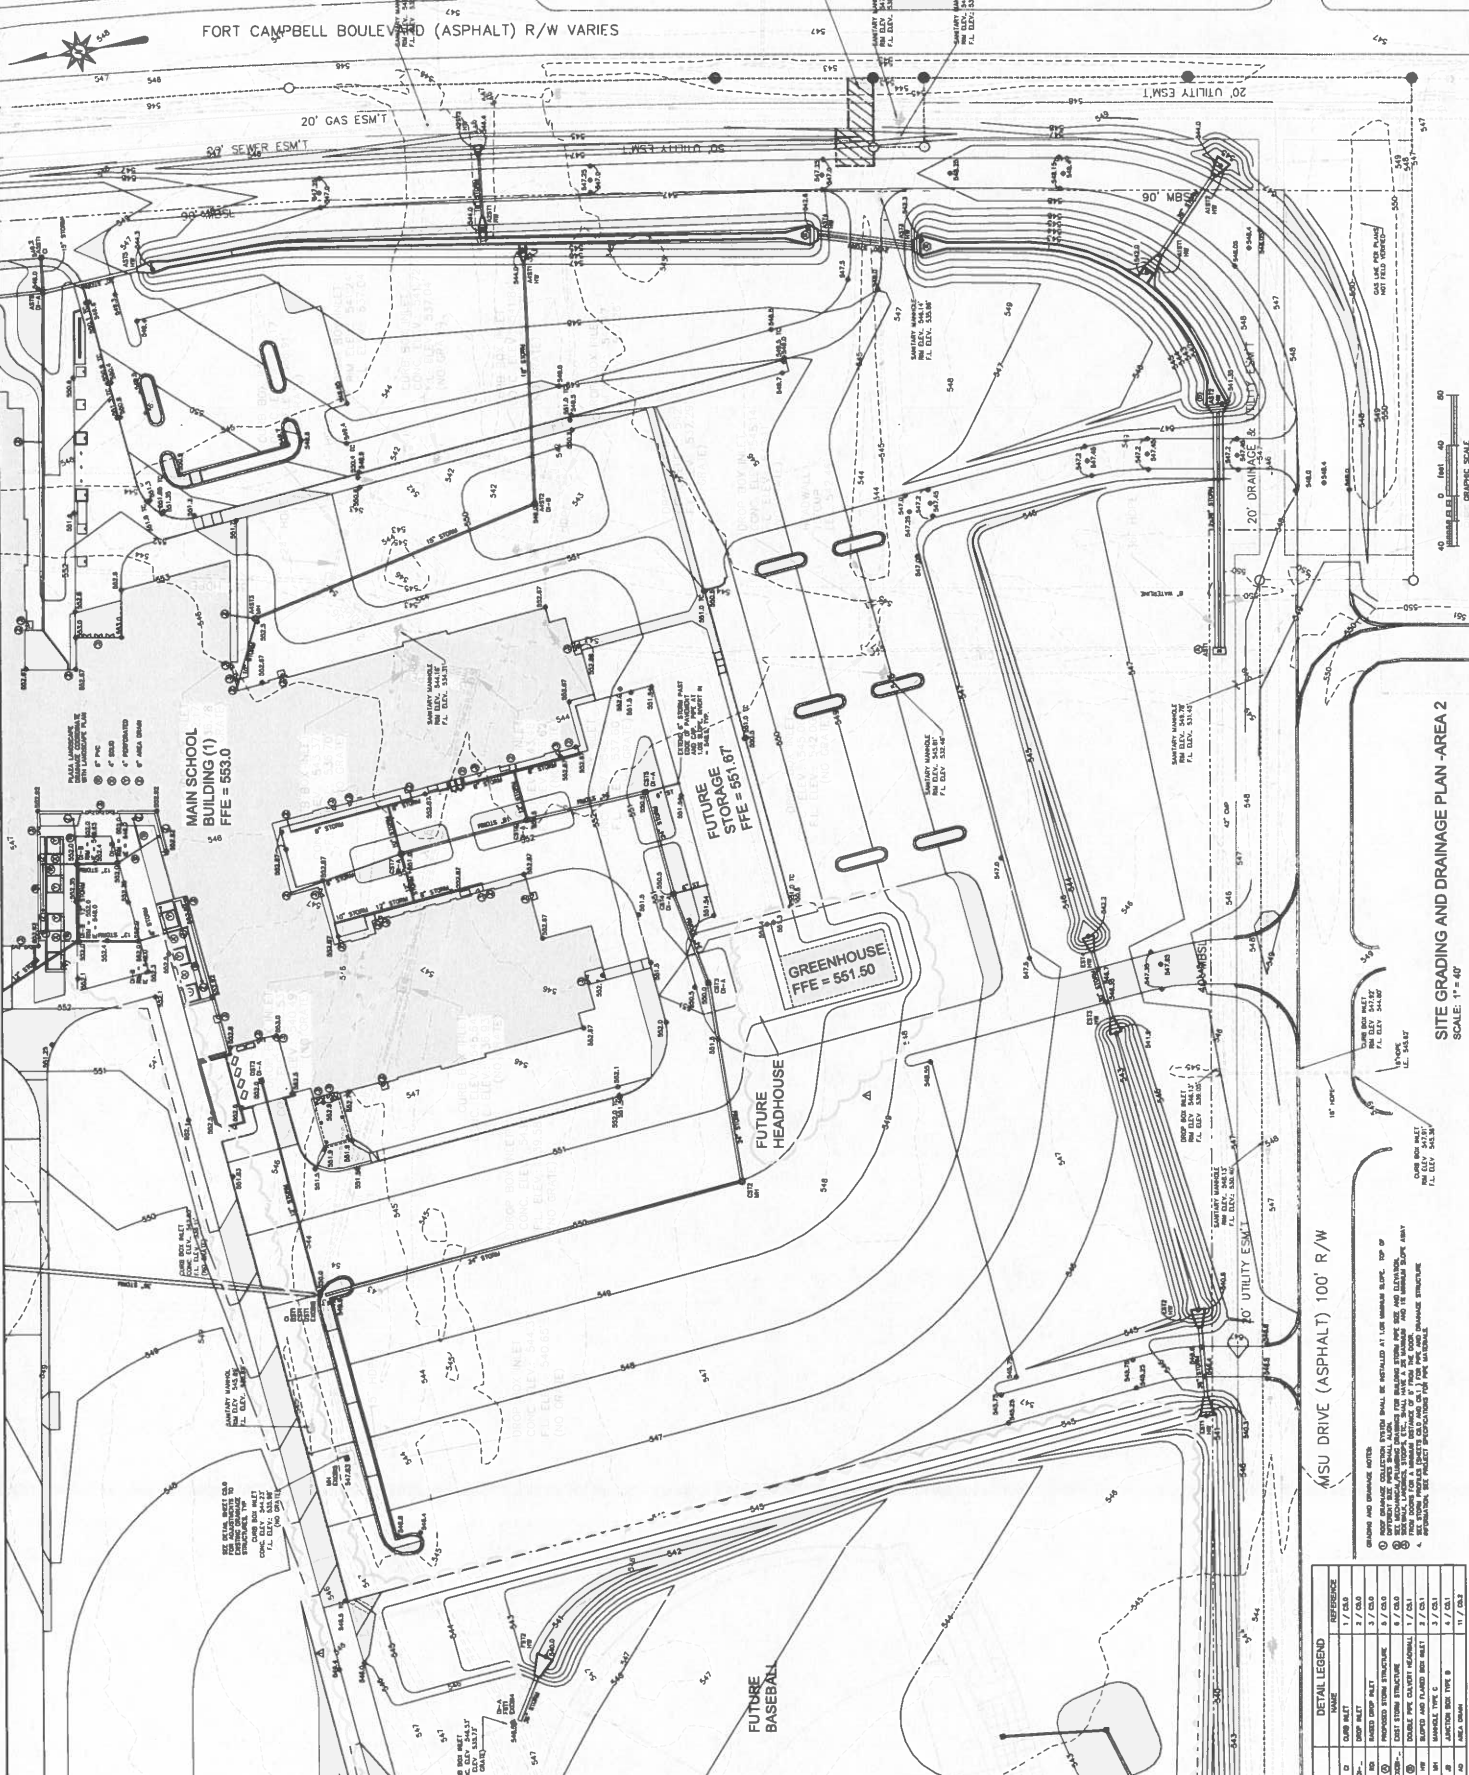


SYMBOL	NAME	REFERENCE
○	CONCRETE	1 / 01
○	ASPHALT	1 / 01
○	GRAVEL	1 / 01
○	PROPOSED STONE STRUCTURE	1 / 01
○	EXIST STONE STRUCTURE	1 / 01
○	EXIST CONC. CURB	1 / 01
○	EXIST CONC. DRIVE	1 / 01
○	EXIST CONC. SIDEWALK	1 / 01
○	EXIST CONC. DRIVE	1 / 01
○	EXIST CONC. SIDEWALK	1 / 01
○	EXIST CONC. DRIVE	1 / 01
○	EXIST CONC. SIDEWALK	1 / 01

DETAIL LEGEND

1. ALL NEW DRAINAGE COLLECTION SYSTEM SHALL BE INSTALLED AT THE MANHOLE BUMP. TOP OF MANHOLE SHALL BE AT THE FINISHED GRADE. ALL NEW DRAINAGE SHALL BE INSTALLED WITH THE EXISTING DRAINAGE SYSTEM. ALL NEW DRAINAGE SHALL BE INSTALLED WITH THE EXISTING DRAINAGE SYSTEM. ALL NEW DRAINAGE SHALL BE INSTALLED WITH THE EXISTING DRAINAGE SYSTEM.

SITE GRADING AND DRAINAGE PLAN - AREA 2
 SCALE: 1" = 40'

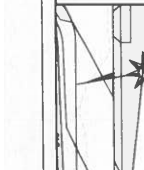

CHRISTIAN COUNTY PUBLIC SCHOOLS
409 N. CENTRAL ST., HOPKINSVILLE, TN 38301
PHONE: 779-881-1000 FAX: 779-881-1001
WWW.CPSK12.EDU

DATE: 05-14-2021
BY: [Signature]

PROJECT: HOPKINSVILLE - CHRISTIAN COUNTY ACADEMY
DRAWING: SITE GRADING AND DRAINAGE PLAN AREA 3

CLIENT: CHRISTIAN COUNTY ACADEMY
CONTACT: [Name]

SCALE: 1" = 40'
DRAWING NO: 2106-201

DATE: MAY 2021

PROJECT NO: [Number]

DRAWING NO: 2106-201





BELL# 731-002



NO.	REVISION	DATE	BY	CHKD BY
1	ISSUE FOR PERMIT	05/14/2021	[Signature]	[Signature]
2	ISSUE FOR PERMIT	05/14/2021	[Signature]	[Signature]



CONFERENCE CENTER DRIVE (ASPHALT) 100' R/W
MSU DRIVE (ASPHALT) 100' R/W

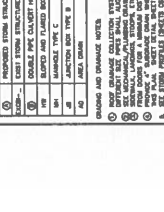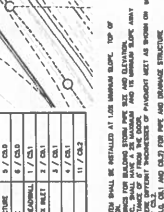
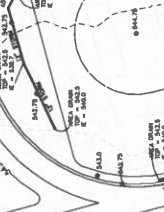
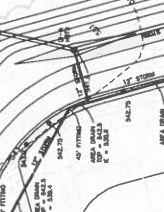



DETAIL LEGEND

SYMBOL	DESCRIPTION	REFERENCE
[Symbol]	EXISTING PROPOSED	1
[Symbol]	EXISTING PROPOSED	2
[Symbol]	EXISTING PROPOSED	3
[Symbol]	EXISTING PROPOSED	4
[Symbol]	EXISTING PROPOSED	5
[Symbol]	EXISTING PROPOSED	6
[Symbol]	EXISTING PROPOSED	7
[Symbol]	EXISTING PROPOSED	8
[Symbol]	EXISTING PROPOSED	9
[Symbol]	EXISTING PROPOSED	10
[Symbol]	EXISTING PROPOSED	11
[Symbol]	EXISTING PROPOSED	12
[Symbol]	EXISTING PROPOSED	13
[Symbol]	EXISTING PROPOSED	14
[Symbol]	EXISTING PROPOSED	15
[Symbol]	EXISTING PROPOSED	16
[Symbol]	EXISTING PROPOSED	17

NOTES:
 1. ALL ELEVATIONS ARE IN FEET UNLESS OTHERWISE NOTED.
 2. EXISTING PROPOSED
 3. EXISTING PROPOSED
 4. EXISTING PROPOSED
 5. EXISTING PROPOSED
 6. EXISTING PROPOSED
 7. EXISTING PROPOSED
 8. EXISTING PROPOSED
 9. EXISTING PROPOSED
 10. EXISTING PROPOSED
 11. EXISTING PROPOSED
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 16. EXISTING PROPOSED
 17. EXISTING PROPOSED


MSU DRIVE (ASPHALT) 100' R/W
 CONFERENCE CENTER DRIVE (ASPHALT) 100' R/W

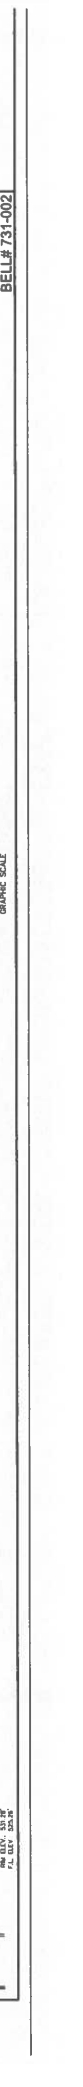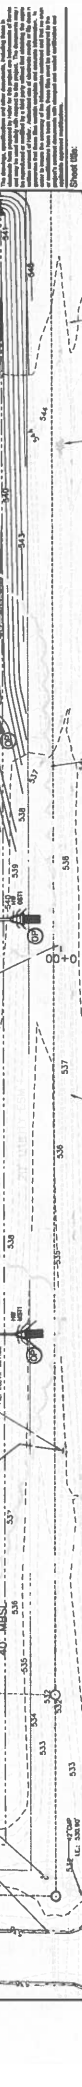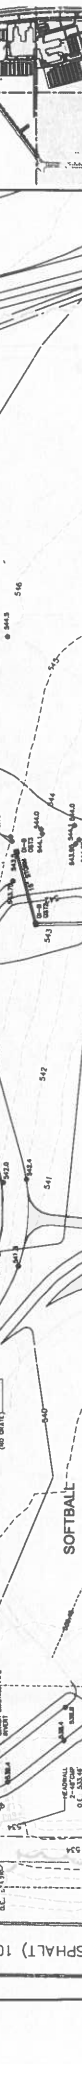

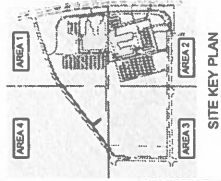


PROJECT NO.	2106-201
DATE	May, 202
PROJECT NAME	SITE GRADING AND DRAINAGE DETAILS
ARCHITECT	HAFER ENGINEERING
ENGINEER	DAVID L. SMITH
CHECKED BY	
DATE	


SITE GRADING AND DRAINAGE DETAILS
 Architect's Project No: 2106-201
 Date: May, 202
 Drawing No: C5.2

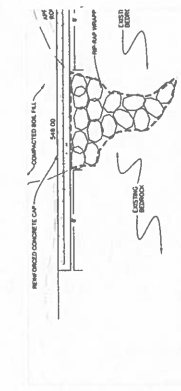


1.1 SINKHOLE REMEDIATION
 12" DEPTH

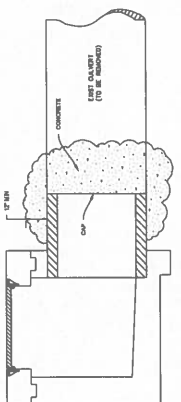


1.2 CONCRETE CAP
 12" DEPTH

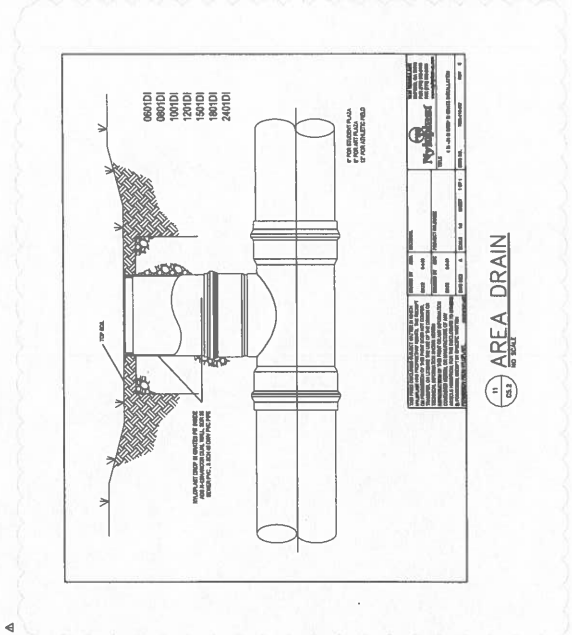


1.3 AREA DRAIN
 12" DEPTH

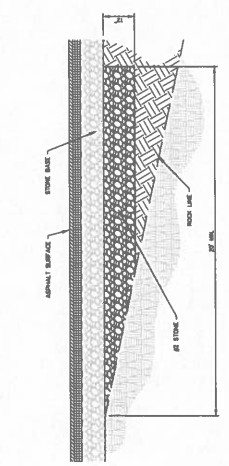

1.4 SUBGRADE TRANSITION FROM ROCK
 12" DEPTH

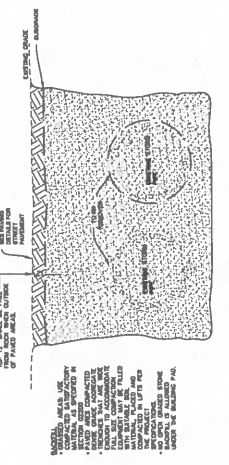

1.5 EXISTING STORM DRAIN REMOVAL DETAIL
 12" DEPTH

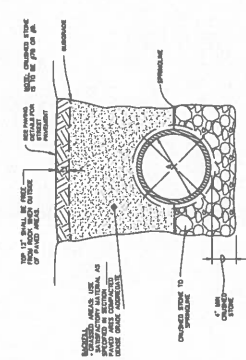

1.6 STORM DRAIN BEDDING & BACKFILL DETAIL
 12" DEPTH




KDE # 152-22-164

518 FT. CAMPBELL BLVD
HOPKINSVILLE, KY 42420

HAFER
1218 1/2 First Street
Hopkinsville, KY 42420
Phone: 202-232-1777
Fax: 202-232-1777
www.haferschools.com

 ALLIANCE 1115 S. Main Street Hopkinsville, KY 42420 Telephone: 270-886-4340	 bell 127 Adams Drive Hopkinsville, KY 42420 Telephone: 270-886-4340	 K&S Engineering, PLLC 124 Highway 100 Hopkinsville, KY 42420 Telephone: 812-471-6246	 WBW 1000 Highway 100 Hopkinsville, KY 42420 Telephone: 270-886-4340	 GT GTV Design and Equipment Co. 1114 S. Main Street Hopkinsville, KY 42420 Telephone: 812-471-6246
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NO.	DESCRIPTION	DATE
1	ISSUED FOR PERMIT	10/20/21

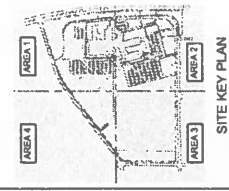
Prepared By: [Signature]
 Checked By: [Signature]
 Approved By: [Signature]

STORM DRAINAGE PROFILE

Architect's Project No: _____ Date: _____
 2106-201 May, 202

Drawing No: _____

C6.1

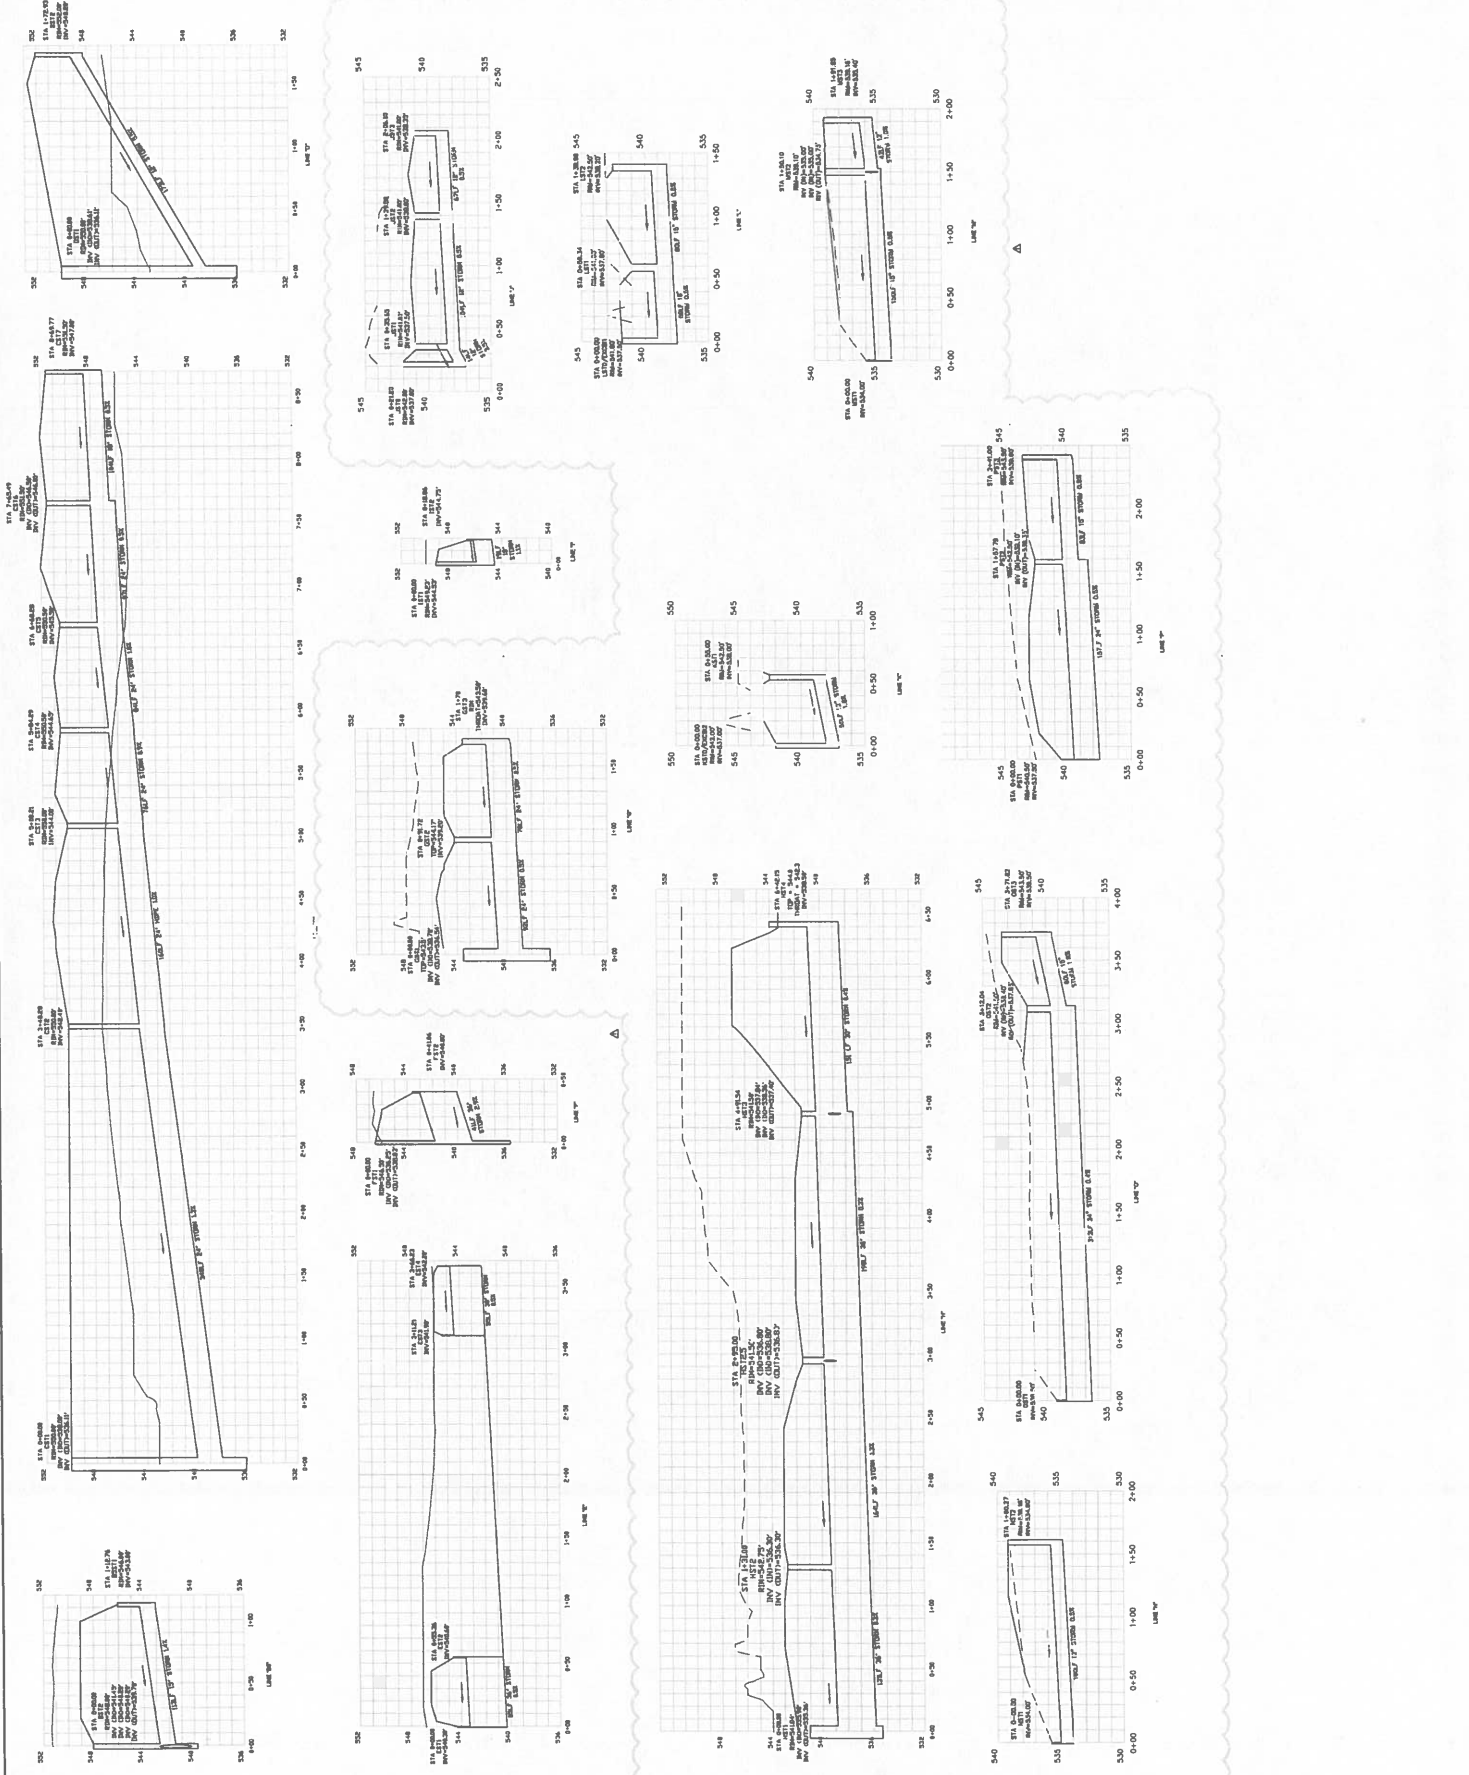



HERRING CONSTRUCTION INC.

1216 ST. RD. 373 N.
EDDYVILLE KY 42038

Phone
(270) 388-2657

Fax
(270) 388-6163

Mobil
(270)206-0628

Bid Sheet

Job Name CCHS
Hopkinsville

Date 17-Jan-25

Site Layout						\$	10,000.00	
Erosion/ Maintenance						\$	10,000.00	
Excavate/Spread		30,000	yds	\$	8.25	\$	247,500.00	
Outlet Protection		4		\$	525.00	\$	2,100.00	
Pipe								
	12 inch	460	ft	\$	51.50	\$	23,690.00	
	15 inch	380	ft	\$	66.25	\$	25,175.00	
	18 inch	60	ft	\$	83.00	\$	4,980.00	
	24 inch	640	ft	\$	105.00	\$	67,200.00	
	36 inch	644	ft	\$	160.00	\$	103,040.00	
Structures						\$	155,748.24	
					Total Bid	\$	649,433.24	

THANK YOU

Chris Garner (270)206-0628
HERRING CONSTRUCTION INC.

FACPAC Contract Change Order Supplemental Information Form (Ref# 61951)

Form Status: Saved

Tier 1 Project: Consolidated High School

BG Number: 22-104

Status: Active

District: Christian County (HB678) (115)

Phase: Project Initiation (View Checklist)

Contract: Herring Construction Co., Inc. , 0010, Site Excavation, Storm Drainage

Type: CM Bid Package

Proposed

Change Order Number	7
Time Extension Required	No
Date Of Change Order	3/13/2025
Change Order Amount To Date	Increase

Construction Contingency

Calculations below are project wide. Remaining negative Construction Contingency may require the submission of a revised BG1.

Current Approved Amount	\$6,320,436.60
Net Approved COs	\$310,172.52
Remaining After Approved COs	\$6,010,264.08
Net All COs	\$973,726.04
Remaining After All COs	\$5,346,710.56

This Requested Change Order Amount \$649,433.24

+/-

Change In A/E Fee This Change Order

+/-

Change In CM Fee This Change Order \$0.00

+/-

Remaining Construction Contingency \$5,346,710.56

Balance

Contract Change Requested By Architect/Engineer; Construction Manager; Local Board of Education; Contractor

Contract Change Reason Code Expansion of Scope

Change Order Description And Justification

Cost associated with athletic field site grading and storm drainage per PR #28R.

Cost Benefit To Owner

The cost of this change order has been reviewed and determined to be reasonable.

Contract unit prices have been utilized No to support the cost associated with this change order.

Detailed Cost Breakdown

Contract unit prices have not been utilized, provide a detailed cost breakdown which separates labor, material, profit and overhead.

Detail Item	Amount	Percent of Total
Labor	\$267,500.00	41.19%
Materials	\$381,933.24	58.81%

Profit and Overhead

0.00%

Bond Insurance

0.00%

Cost Breakdown Total:

\$649,433.24

Cost for this Change Order supported No
by an alternate bid or competitive price
quote

Explain Why

Executed contract with contractor.

**Change Order Supplemental Information Form Signature
Page (Online Form Ref# 61951)**

Architect

Date

Construction Manager

Date

Finance Officer

Date

Local Board of Education Designee

Date