

T ALTERNATE 1.DGN	INDEEX OF SHEET NO.         1       LAYOUT SHEET         2       TYPICAL SECTIONS         2A       GENERAL NOTE SHEET         3-7       GRADING PLAN SHEETS         3       SIGNING & STRIPING         14       MAINTENANCE OF TRAFFIC NOTE SHEET         15-16       DETAIL SHEETS         17       EROSION CONTROL NOTE SHEET         18       PIPE DRAINAGE SHEET	
FILE NAME: Z:\SITEDEVELOPMENT\2023 PROJECTS\ALLEN COUNTY SCOTTSVILLE SCHOOLS\SITEDEV\SHEETS\LAYOUT ALTERNATE	SHEETS NOT INCLUDED IN TOTAL SHEETS R2A	
ieptember 7, 2005	RDX-225-01 RGX-010-04 ALTERNATE 1 INCLUDES 2,277.43' (STA 150+22.57 TO S WIDENING AND OVERLAY. ALTERNATE 2 INCLUDES A 1	STA 173+00) OF ROAD PAVED PARKING LOT.
OpenRoads Designer v10.12.02.4 DATE PLOTTED: S	GEOGRAPHIC COORDINATES         LATITUDE       36         DEGREES       44         LONGITUDE       36         DEGREES       13         MINUTES       14         SECONDS WEST	ALLEN COUNTY SUPERINTENDE 570 OLIVER ST. SCOTTSVILLE, M CONTACT: TRAV TELEPHONE: (21)

# FOR ALTERNATES 1 & 2

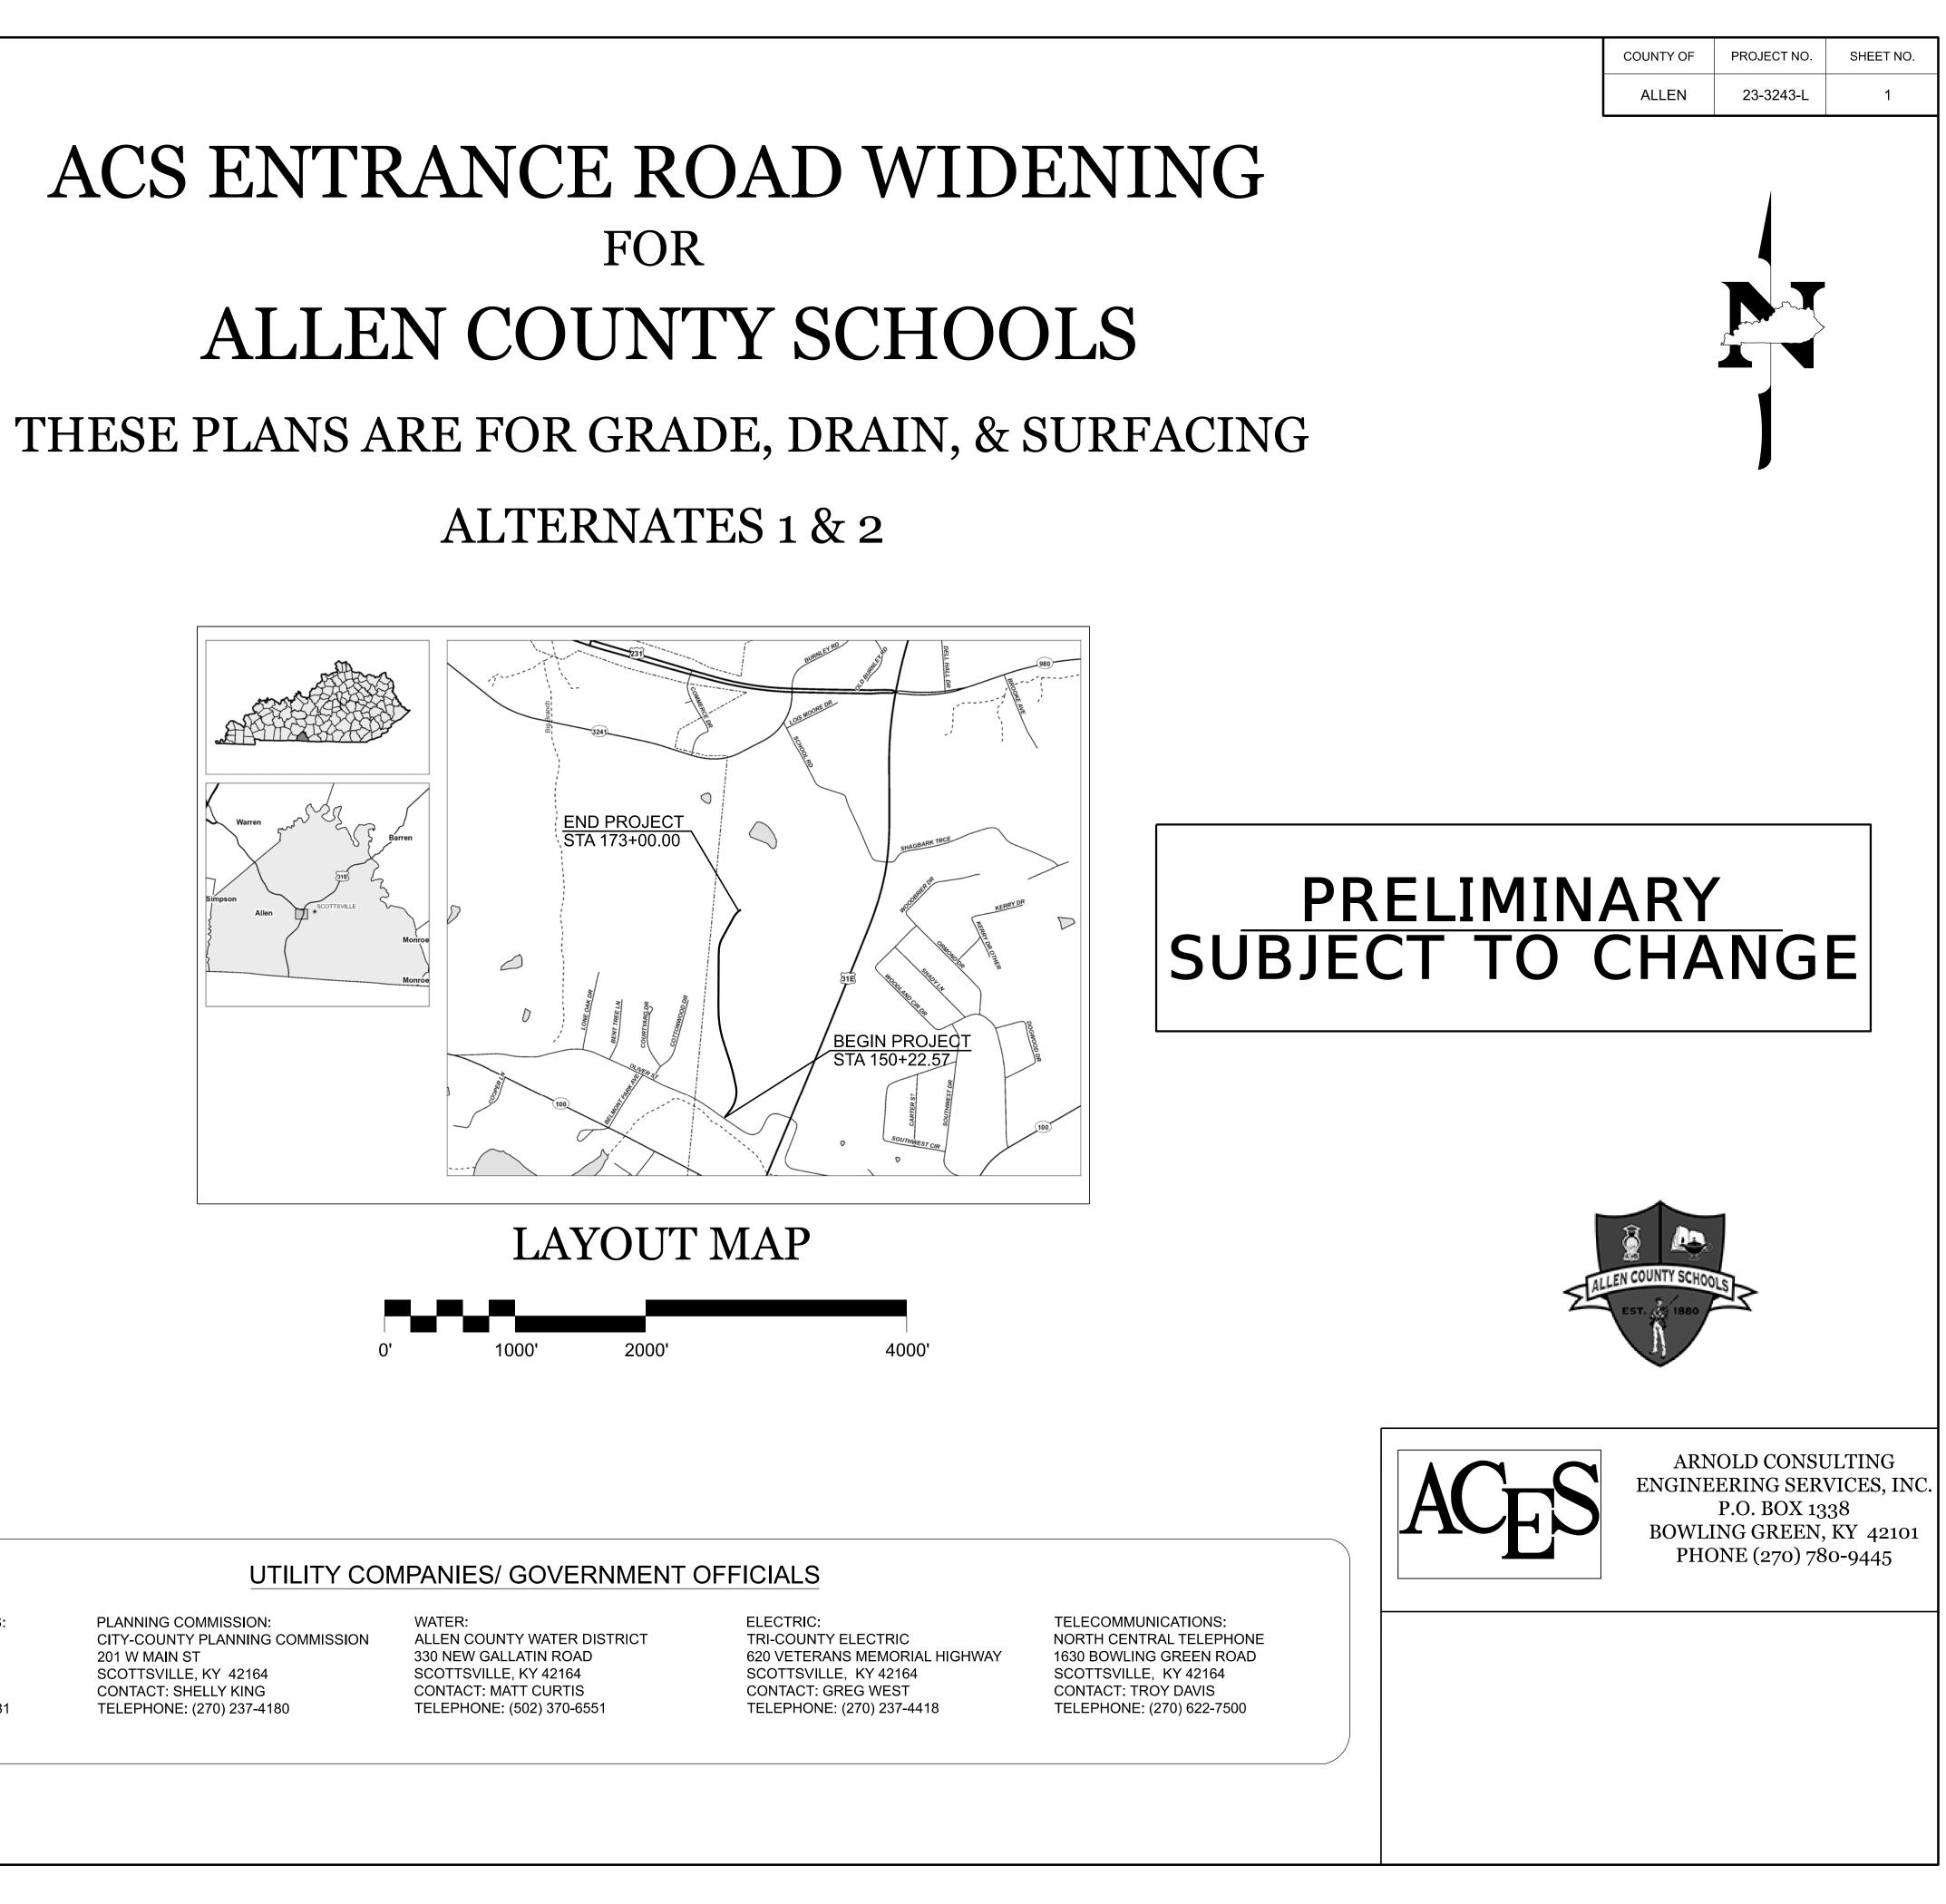

OUNTY SCHOOLS: TENDENT /ILLE, KY 42164

T: TRAVIS HAMBY DNE: (270) 618-3181 PLANNING COMMISSION: CITY-COUNTY PLANNING COMMISSION 201 W MAIN ST SCOTTSVILLE, KY 42164 CONTACT: SHELLY KING TELEPHONE: (270) 237-4180

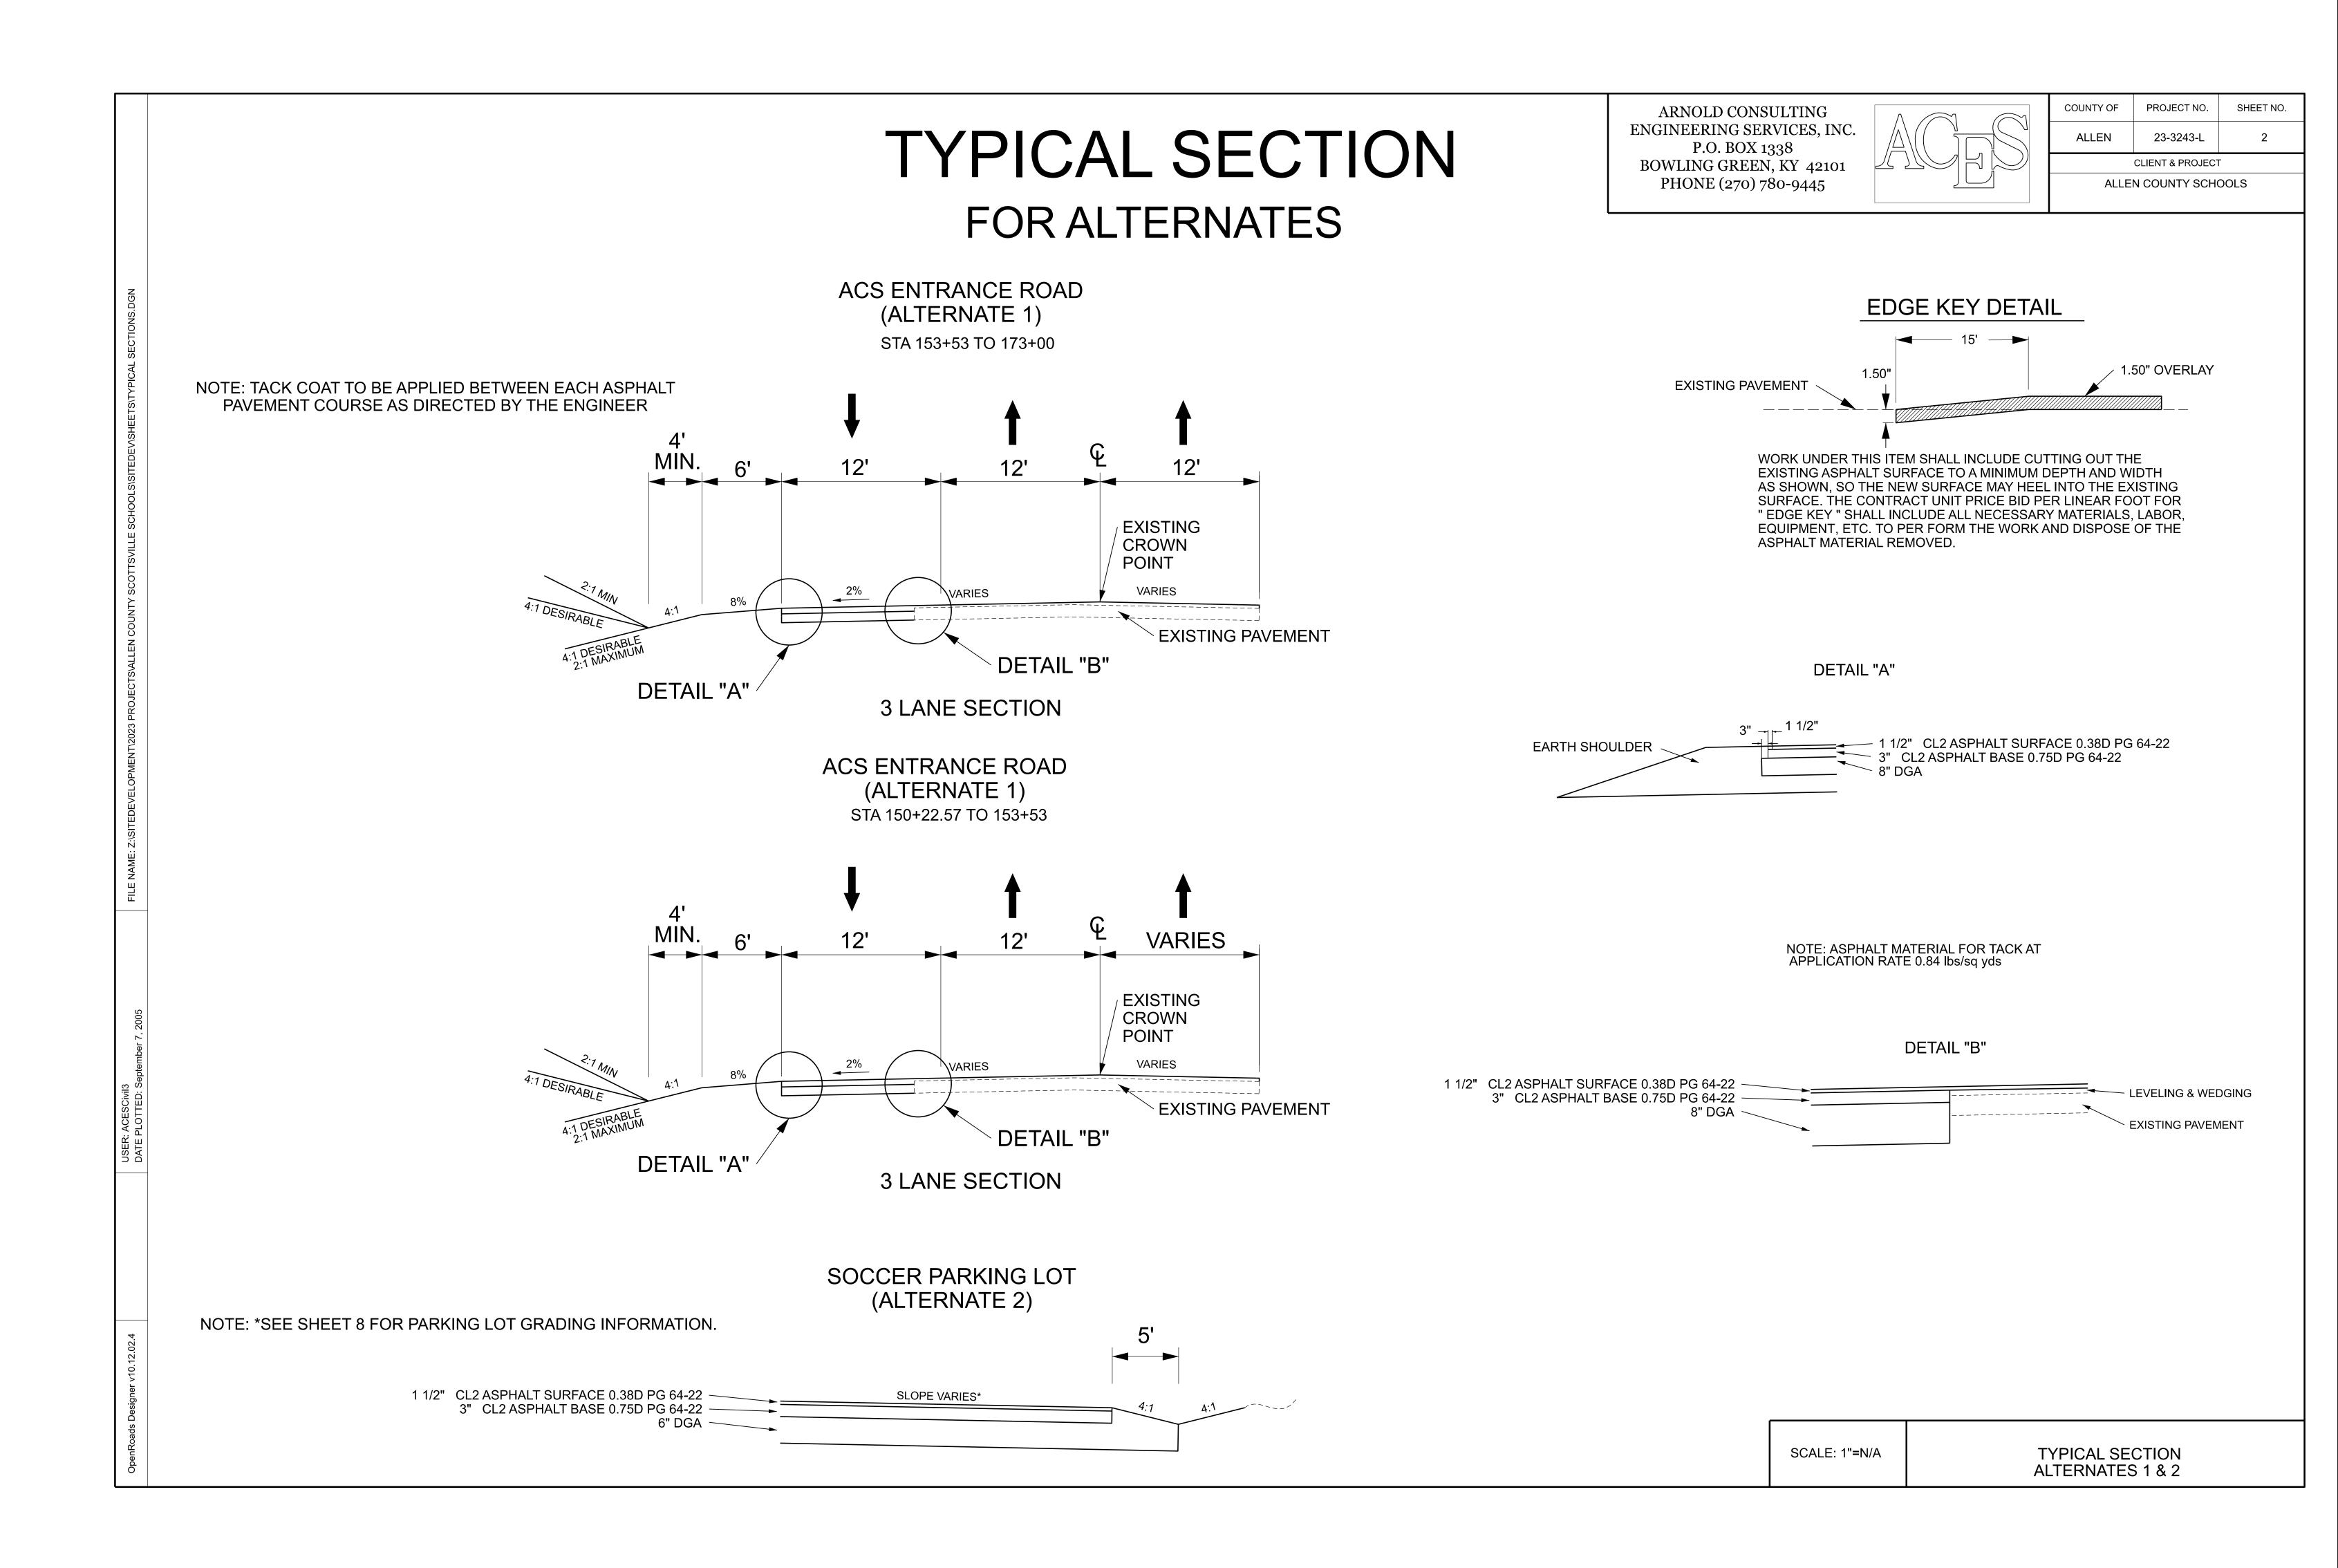

GRADING AND DRAINAGE NOTES:
1. CONTRACTOR SHALL NOTIFY ALL UTILITY COMPANIES HAVING UNDERGROUND UTILITIES ON SITE OR IN RIGHT-OF-WAY PRIOR TO EXCAVATION. CONTRACTOR SHALL NOTIFY BUD AT 1-800-752-6007 48 HOURS PRIOR TO EXCAVATION.
2. SITE GRADING SHALL NOT PROCEED UNTIL EROSION CONTROL MEASURES HAVE BEEN INSTALLED.
3. SITE GRADES AROUND THE PAVEMENT AREAS SHALL BE GRADED DURING CONSTRUCTION TO PREVENT PONDING. ANY SURFACE WATER ACCUMULATION IN THE PAVEMENT AREAS SHALL BE DRAINED IMMEDIATELY TO AVOID SATURATION OF THE SUBGRADE SOILS.
4. ALL EXCAVATIONS SHALL BE CONSTRUCTED IN ACCORDANCE WITH THE LATEST OSHA GUIDELINES AS MANDATED IN CURRENT FEDERAL, STATE AND LOCAL REGULATIONS. THE CONTRACTOR SHALL BE SOLELY RESPONSIBLE IN PROVIDING SAFE WORKING CONDITIONS IN CONNECTION WITH ANY EXCAVATION WORK.
5. ENGINEERED FILL SHALL BE COMPACTED TO 98% OF STANDARD PROCTOR DENSITY IN BUILDING PAD AREAS (PROPOSED AND FUTURE EXPANSION) AND TO 95% IN PARKING AND DRIVE AREAS. VEGETATED AREAS SHOULD BE COMPACTED TO A MINIMUM OF 92% OF STANDARD PROCTOR DENSITY.
6. STONE BASES SHOULD BE COMPACTED TO A DENSITY SATISFACTORY TO ENGINEER, TYPICALLY 84% OF SOLID VOLUME OR BY TEST STRIP METHODS.
7. GRADE LINES SHOWN ARE FINISHED GRADE. CONTRACTOR SHOULD SEE DETAIL SHEET FOR APPROPRIATE PAVEMENT TYPE TO DETERMINE SUB-GRADE ELEVATIONS FOR PAVING AREAS.
8. ALL MATERIALS AND CONSTRUCTION ON THIS PROJECT SHALL CONFORM TO THE 2019 EDITION OF THE KYTC STANDARD SPECIFICATIONS FOR ROAD AND BRIDGE CONSTRUCTION.
9. THE SITE SHALL BE CLEARED AND GRUBBED WITHIN THE LIMITS OF EXCAVATION. COMPLETELY DISPOSE OF ALL MATERIALS RESULTING FROM CLEARING AND GRUBBING OFF-SITE. BURNING SHALL NOT BE PERMITTED IN THE PROJECT AREA.
10. AREAS THAT EXHIBIT WEAK SOIL OR OTHERWISE UNSUITABLE CONDITIONS SHALL BE UNDERCUT TO A FIRM LEVEL OF SOIL FOLLOWED BY BACKFILLING THE UNDERCUT AREAS USING AN ENGINEERED FILL OR APPROVED STONE.
11. FILL SHALL BE SATISFACTORY MATERIAL FREE FROM ROOTS AND OTHER ORGANIC MATERIAL, FROZEN MATERIAL, AND TRASH. FILL MATERIAL SHALL ALSO BE FREE OF STONES LARGER THAN 6 INCHES IN DIAMETER.
12. UNSATISFACTORY SOILS INCLUDE MATERIALS THAT ARE TOO WET OR TOO SOFT, EXPANSIVE SOILS (PLASTICITY INDEX GREATER THAN OR EQUAL TO 30), AND SOILS CLASSIFIED AS PT, OH, AND OL.
13. DO NOT ALLOW WATER TO ACCUMULATE IN EXCAVATIONS OR POND ON-SITE. PROVIDE NECESSARY MEASURES TO KEEP THE SITE FREE-DRAINING.
14. TRENCH DESIGN AND SAFETY FOR PIPELINE CONSTRUCTION IS SOLELY THE RESPONSIBILITY OF THE CONTRACTOR AND SHALL CONFORM TO ALL LOCAL, STATE, AND OSHA REQUIREMENTS.
15. THE CONTRACTOR SHALL SHAPE DITCHES TO THE SPECIFIED DESIGN AS SHOWN IN THE PLANS. THIS WORK WILL NOT BE MEASURED AND PAID FOR DIRECTLY, BUT WILL BE CONSIDERED A PORTION OF THE EXCAVATION COST.
PAVEMENT PLACEMENT AND REPLACEMENT NOT AND REPLACEMENT AND CONCRETE ON THE PROJECT SHALL ADHERE TO KENTUCKY TRANSPORTATION CABINET STANDARD SPECIFICATIONS FOR ROAD AND BRIDGE CONSTRUCTION, LATEST EDITION AND TO THE THICKNESS SHOWN ON THE PLANS. 2. THE CONTRACTOR WILL BE RESPONSIBLE FOR ADJUSTING ALL EXISTING MANHOLES AND UTILITY VALVES IN THE PROJECT AREAS TO THE PROPOSED FINAL ELEVATIONS. 3. PROPER COMPACTION OF THE ASPHALT PAVEMENT WILL BE CRITICAL AT THE PAVEMENT/CURB AND GUTTER JOINT. ENSURE THAT SUFFICIENT MATERIAL IS PLACED IN THIS LOCATION TO ALLOW FOR PROPER COMPACTION AT THE JOINT.
4. ALL PAVING OPERATIONS ON THE MAINLINE SHALL BE PERFORMED IN THE DIRECTION OF THE CENTERLINE. PAVING TRANSVERSE TO THE MAINLINE IS PROHIBITED.
5. THE FINAL SURFACE ELEVATION TOLERANCES OF THE ASHPALT PAVEMENT AND THE CONCRETE CURB AND GUTTER SHALL ADHERE TO THE REQUIREMENTS SPECIFIED IN THE KENTUCKY TRANSPORTATION CABINET STANDARD SPECIFICATIONS FOR ROAD AND BRIDGE CONSTRUCTION, LATEST EDITION.

# GENERAL NOTE SHEET

## EROSION AND SEDIMENT CONTROL NOTES

1. THE CONTRACTOR SHALL BE RESPONSIBLE FOR FILING THE KENTUCKY POLLUTION DISCHARGE ELIMINATION SYSTEM (KPDES) KYR 10 PERMIT NOTICE OF INTENT (NOI) WITH THE KENTUCKY DIVISION OF WATER (DOW) AND ANY KPDES LOCAL MUNICIPAL SEPARATE STORM WATER SYSTEM (MS4) PROGRAM THAT HAS JURISDICTION. THE NOI SHALL NAME THE CONTRACTOR AS THE FACILITY OPERATOR.

2. THE CONTRACTOR SHALL PERFORM ALL TEMPORARY EROSION/SEDIMENT CONTROL FUNCTIONS INCLUDING: PROVIDING A BEST MANAGEMENT PRACTICE (BMP) PLAN, CONDUCTING REQUIRED INSPECTIONS, MODIFYING THE BMP PLAN DOCUMENTS AS CONSTRUCTION PROGRESSES AND DOCUMENTING THE INSTALLATION AND MAINTENANCE OF BMP IN CONFORMANCE WITH THE KPDES KYR 10 PERMIT.

3. THE CONTRACTOR SHALL BE RESPONSIBLE FOR APPLYING GOOD ENGINEERING PRACTICES AS REQUIRED BY THE KPDES PERMIT. THE CONTRACTOR MAY USE ANY TEMPORARY BMP'S WITH THE APPROVAL OF THE ENGINEER.

4. THE CONTRACTOR SHALL PROVIDE THE ENGINEER COPIES OF ALL DOCUMENTS REQUIRED BY THE KPDES PERMIT THE TIME THEY ARE PREPARED.

5. THE CONTRACTOR SHALL BE RESPONSIBLE FOR THE EXAMINATION OF THE SOILS ENCOUNTERED AND MAKE HIS OWN INDEPENDENT DETERMINATION OF THE TEMPORARY BMP'S THAT WILL BE REQUIRED TO ACCOMPLISH EFFECTIVE EROSION PREVENTION AND SEDIMENT CONTROL.

6. THE CONTRACTOR SHALL BE RESPONSIBLE FOR FILING THE KPDES PERMIT NOTICE OF TERMINATION (NOT) WITH THE KENTUCKY DIVISION OF WATER AND ANY LOCAL MS4 PROGRAM THAT HAS JURISDICTION. THE NOT SHALL BE FILED AFTER THE ENGINEER AGREES THAT THE PROJECT IS STABILIZED OR THE PROJECT HAS BEEN FORMALLY ACCEPTED.

## SPECIAL NOTES

1. ANY REFERENCES TO QUANTITIES ON ALL SHEETS IN THESE PLANS ARE FOR INFORMATIONAL PURPOSES ONLY. THE BIDDER IS RESPONSIBLE FOR DETERMINING THE ACTUAL QUANTITIES BID.

2. IN ACCORDANCE WITH SECTION 204 OF THE 2019 STD. SPECIFICATIONS FOR ROAD AND BRIDGE CONSTRUCTION ALL ROADWAY AND DRAINAGE EXCAVATION IS UNCLASSIFIED. ANY REFERENCES TO ROCK, EARTH OR ANY OTHER MATERIAL IS FOR INFORMATION ONLY AND IS NOT AN INDICATION OF CLASSIFIED EXCAVATION. THE BIDDER MUST DRAW HIS OR HER OWN CONCLUSIONS AS TO THE CONDITIONS ENCOUNTERED.

3. ALL MATERIALS USED AND WORK DONE ON THIS PROJECT SHALL CONFORM TO THE 2019 EDITION OF THE KENTUCKY STANDARD SPECIFICATIONS FOR ROAD AND BRIDGE CONSTRUCTION AND KYTC STD. DRAWINGS CURRENT EDITION.

4. THE CONTRACTOR SHALL BE RESPONSIBLE FOR OBTAINING WRITTEN PERMISSION FROM ALL ADJOINING PROPERTY OWNERS BEFORE WORKING OFF THE RIGHT OF WAY.

5. THE CONTRACTOR SHALL BE RESPONSIBLE FOR CONTACTING ALL ADJOINING PROPERTY OWNERS BEFORE STARTING WORK ON THIS PROJECT TO MAKE THEM AWARE OF THE PROPOSED CONSTRUCTION WHETHER IT BE ON OR OFF OF EXISTING RIGHT OF WAY.

6. ALL EXCAVATIONS SHALL BE CONSTRUCTED IN ACCORDANCE WITH THE LATEST OSHA GUIDELINES AS MANDATED IN CURRENT FEDERAL, STATE AND LOCAL REGULATIONS. THE CONTRACTOR SHALL BE SOLELY RESPONSIBLE IN PROVIDING SAFE WORKING CONDITIONS IN CONNECTION WITH ANY EXCAVATION WORK.

7. ASPHALT QUANTITIES ARE DETERMINED BASED ON WEIGHT OF 110 POUNDS PER INCH THICKNESS PER SQUARE YARD. CRUSHED STONE QUANTITIES ARE DETERMINED BASED ON WEIGHT OF 115 POUNDS PER INCH THICKNESS PER SQUARE YARD. THE CONTRACTOR MUST SUBMIT WEIGH SHEETS OR TICKETS TO VERIFY QUANTITIES PRIOR TO PAYMENT.

8. ALL WORK WILL BE SUBJECT TO INSPECTION BY ALLEN COUNTY SCHOOLS OR ITS AGENT.

9. ANY CONTRACTOR / SUBCONTRACTOR WORKING ON THIS PROJECT MUST BE LICENSED IN SCOTTSVILLE -ALLEN COUNTY, KENTUCKY AND BE PRE QUALIFIED WITH THE KENTUCKY TRANSPORTATION CABINET.

10. GRADING SHALL NOT PROCEED UNTIL EROSION CONTROL MEASURES HAVE BEEN INSTALLED. COSTS FOR EROSION CONTROL SHOULD BE INCLUDED IN THE RESPECTIVE BID ITEMS.

11. PRIOR TO COMMENCING ANY WORK, THE CONTRACTOR SHALL NOTIFY ALL UTILITY COMPANIES WITH UNDERGROUND UTILITIES ON SITE OR IN THE RIGHT OF WAY. CONTRACTOR SHALL NOTIFY 811 A MINIMUM OF 48 HOURS PRIOR TO EXCAVATION. THE UTILITY LOCATIONS SHOWN ON THE PLANS ARE APPROXIMATE AND FOR INFORMATIONAL PURPOSES ONLY.

12. IN ORDER TO PROTECT THE OWNERS INVESTMENT IN THIS PROJECT AND TO ASSURE THAT ALL PUBLIC IMPROVEMENTS (STREETS, WATER, SANITARY SEWER AND STORM SEWER) HAVE BEEN STAKED/CONSTRUCTED TO A TOLERANCE OF 0.05' HORIZONTAL AND 0.03' VERTICAL - ALL STAKING SHALL BE COMPLETED BY A PROFESSIONAL LAND SURVEYOR THAT HAS BEEN APPROVED BY THE DESIGN ENGINEER.

13. NOTHING IN THE GENERAL NOTES SHALL RELIEVE THE CONTRACTOR FROM THEIR RESPONSIBILITIES TOWARD THE SAFETY AND CONVENIENCE OF THE GENERAL PUBLIC AND THE RESIDENTS AND BUSINESS OWNERS ALONG THE PROPOSED CONSTRUCTION AREA.

14. THE CONTRACTOR SHALL PAY SPECIAL ATTENTION TO PROVIDING PEDESTRIAN SAFETY DURING THE DURATION OF THE PROJECT. APPROPRIATE MEASURES SUCH AS BARRICADES AND FENCING SHALL BE PROVIDED IN TO PROTECT PEDESTRIANS FROM OPEN EXCAVATIONS DURING CONSTRUCTION.

15. THE CONTRACTOR SHALL BE RESPONSIBLE FOR JOBSITE SAFETY AND EFFICIENCY OF THE PROJECT. THE CONTRACTOR SHALL PROVIDE EQUIPMENT AND CONSTRUCTION METHODS AND PROCEDURES WHICH ENSURE A SAFE WORKPLACE.

16. THE CONTRACTOR SHALL KEEP CONSTRUCTION WASTE AND RUBBISH GENERATED BY CONSTRUCTION ACTIVITIES MINIMIZED AND WITHIN THE LIMITS OF CONSTRUCTION. ALL CONSTRUCTION WASTE SHALL BE REMOVED DAILY FROM THE JOBSITE.

17. ALL CONSTRUCTION ACTIVITIES SHALL BE IN ACCORDANCE WITH THE 2019 EDITION OF THE KYTC STANDARDS AND SPECIFICATIONS.

18. THE CONTRACTOR WILL BE RESPONSIBLE FOR ALL REQUIRED CONSTRUCTION TESTING AND INSPECTION COORDINATION AND FEES.

19. THE LOCATION OF UNDERGROUND UTILITIES ARE BASED ON MARKINGS AND INFORMATION PROVIDED BY THE RESPECTIVE UTILITY AND SHOULD BE CONSIDERED APPROXIMATE. PRIOR TO BEGINNING WORK THE EXACT LOCATION OF UNDERGROUND

UTILITIES SHOULD BE DETERMINED AND CHECKED FOR CONFLICTS WITH ANY PROPOSED CONSTRUCTION. THE CONTRACTOR SHOULD CONTACT KY 811 (BUD) AT '811' OR '1-800-752-6007' A MINIMUM OF 48 HOURS PRIOR TO BEGINNING EXCAVATION. ARNOLD CONSULTING ENGINEERING SERVICES, INC. P.O. BOX 1338 BOWLING GREEN, KY 42101 PHONE (270) 780-9445



COUNTY OF	PROJECT NO.	SHEET NO.
ALLEN	23-3243-L	2A
CLIENT & PROJECT		

ALLEN COUNTY SCHOOLS

#### SPECIAL NOTE FOR BASE FAILURE REPAIR

Repair locations listed on the summary are approximate only. The Engineer will determine actual repair locations and dimensions at the time of construction. Prior to overall milling and/or leveling and wedging, excavate the designated base failure areas to a depth <u>12.5</u> inches below the existing asphalt pavement surface level. Dispose of the excavated materials at waste sites off the Right-of-Way obtained by the Contractor at no additional cost to the Department. See Special Note for Waste and Borrow.

Backfill the excavated areas with Class 2 Asphalt Base 0.75D PG 64 -22. Compact the asphalt base to the compaction required in Section 403.03.10. Seal the asphalt base with leveling and wedging. Perform all base failure repairs in such a manner that removal and replacement are completed on the same day. Do this work as one of the Contractor's first operations in order to allow further compaction by traffic. Do not mill or place new asphalt surface over repaired base failure areas until a minimum of 7 calendar days have elapsed after placement of the asphalt base. After a minimum of 7 calendar days and when the Engineer determines the base failure repair areas have sufficiently stabilized, begin milling and/or resurfacing operations. Prior to milling and/or constructing the new asphalt surface, level and wedge any settlement of the repair areas. Backfilled areas are to match proposed typical section of new pavement.

The bidder must draw conclusions as to the conditions encountered. The Department does not give any guarantee as to the accuracy of the data and will not consider any claim for additional compensation if the materials encountered that are not in accord with the classification shown.


Accept payment at the Contract unit prices per square yard for Base Failure repair and per ton for Leveling and Wedging as full compensation for all labor, materials, equipment, and incidentals for removing pavement and disposing of the materials, furnishing and placing asphalt base, leveling and wedging, and all other items necessary to complete the work according to these notes to the satisfaction of the Engineer.

1-3606basefailurerepairmillinlaypaybysy 01/02/2012

USE OF EXPLOSIVES

BLASTING IS PROHIBITED ON THIS PROJECT


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OpenR	NORTH POINT			

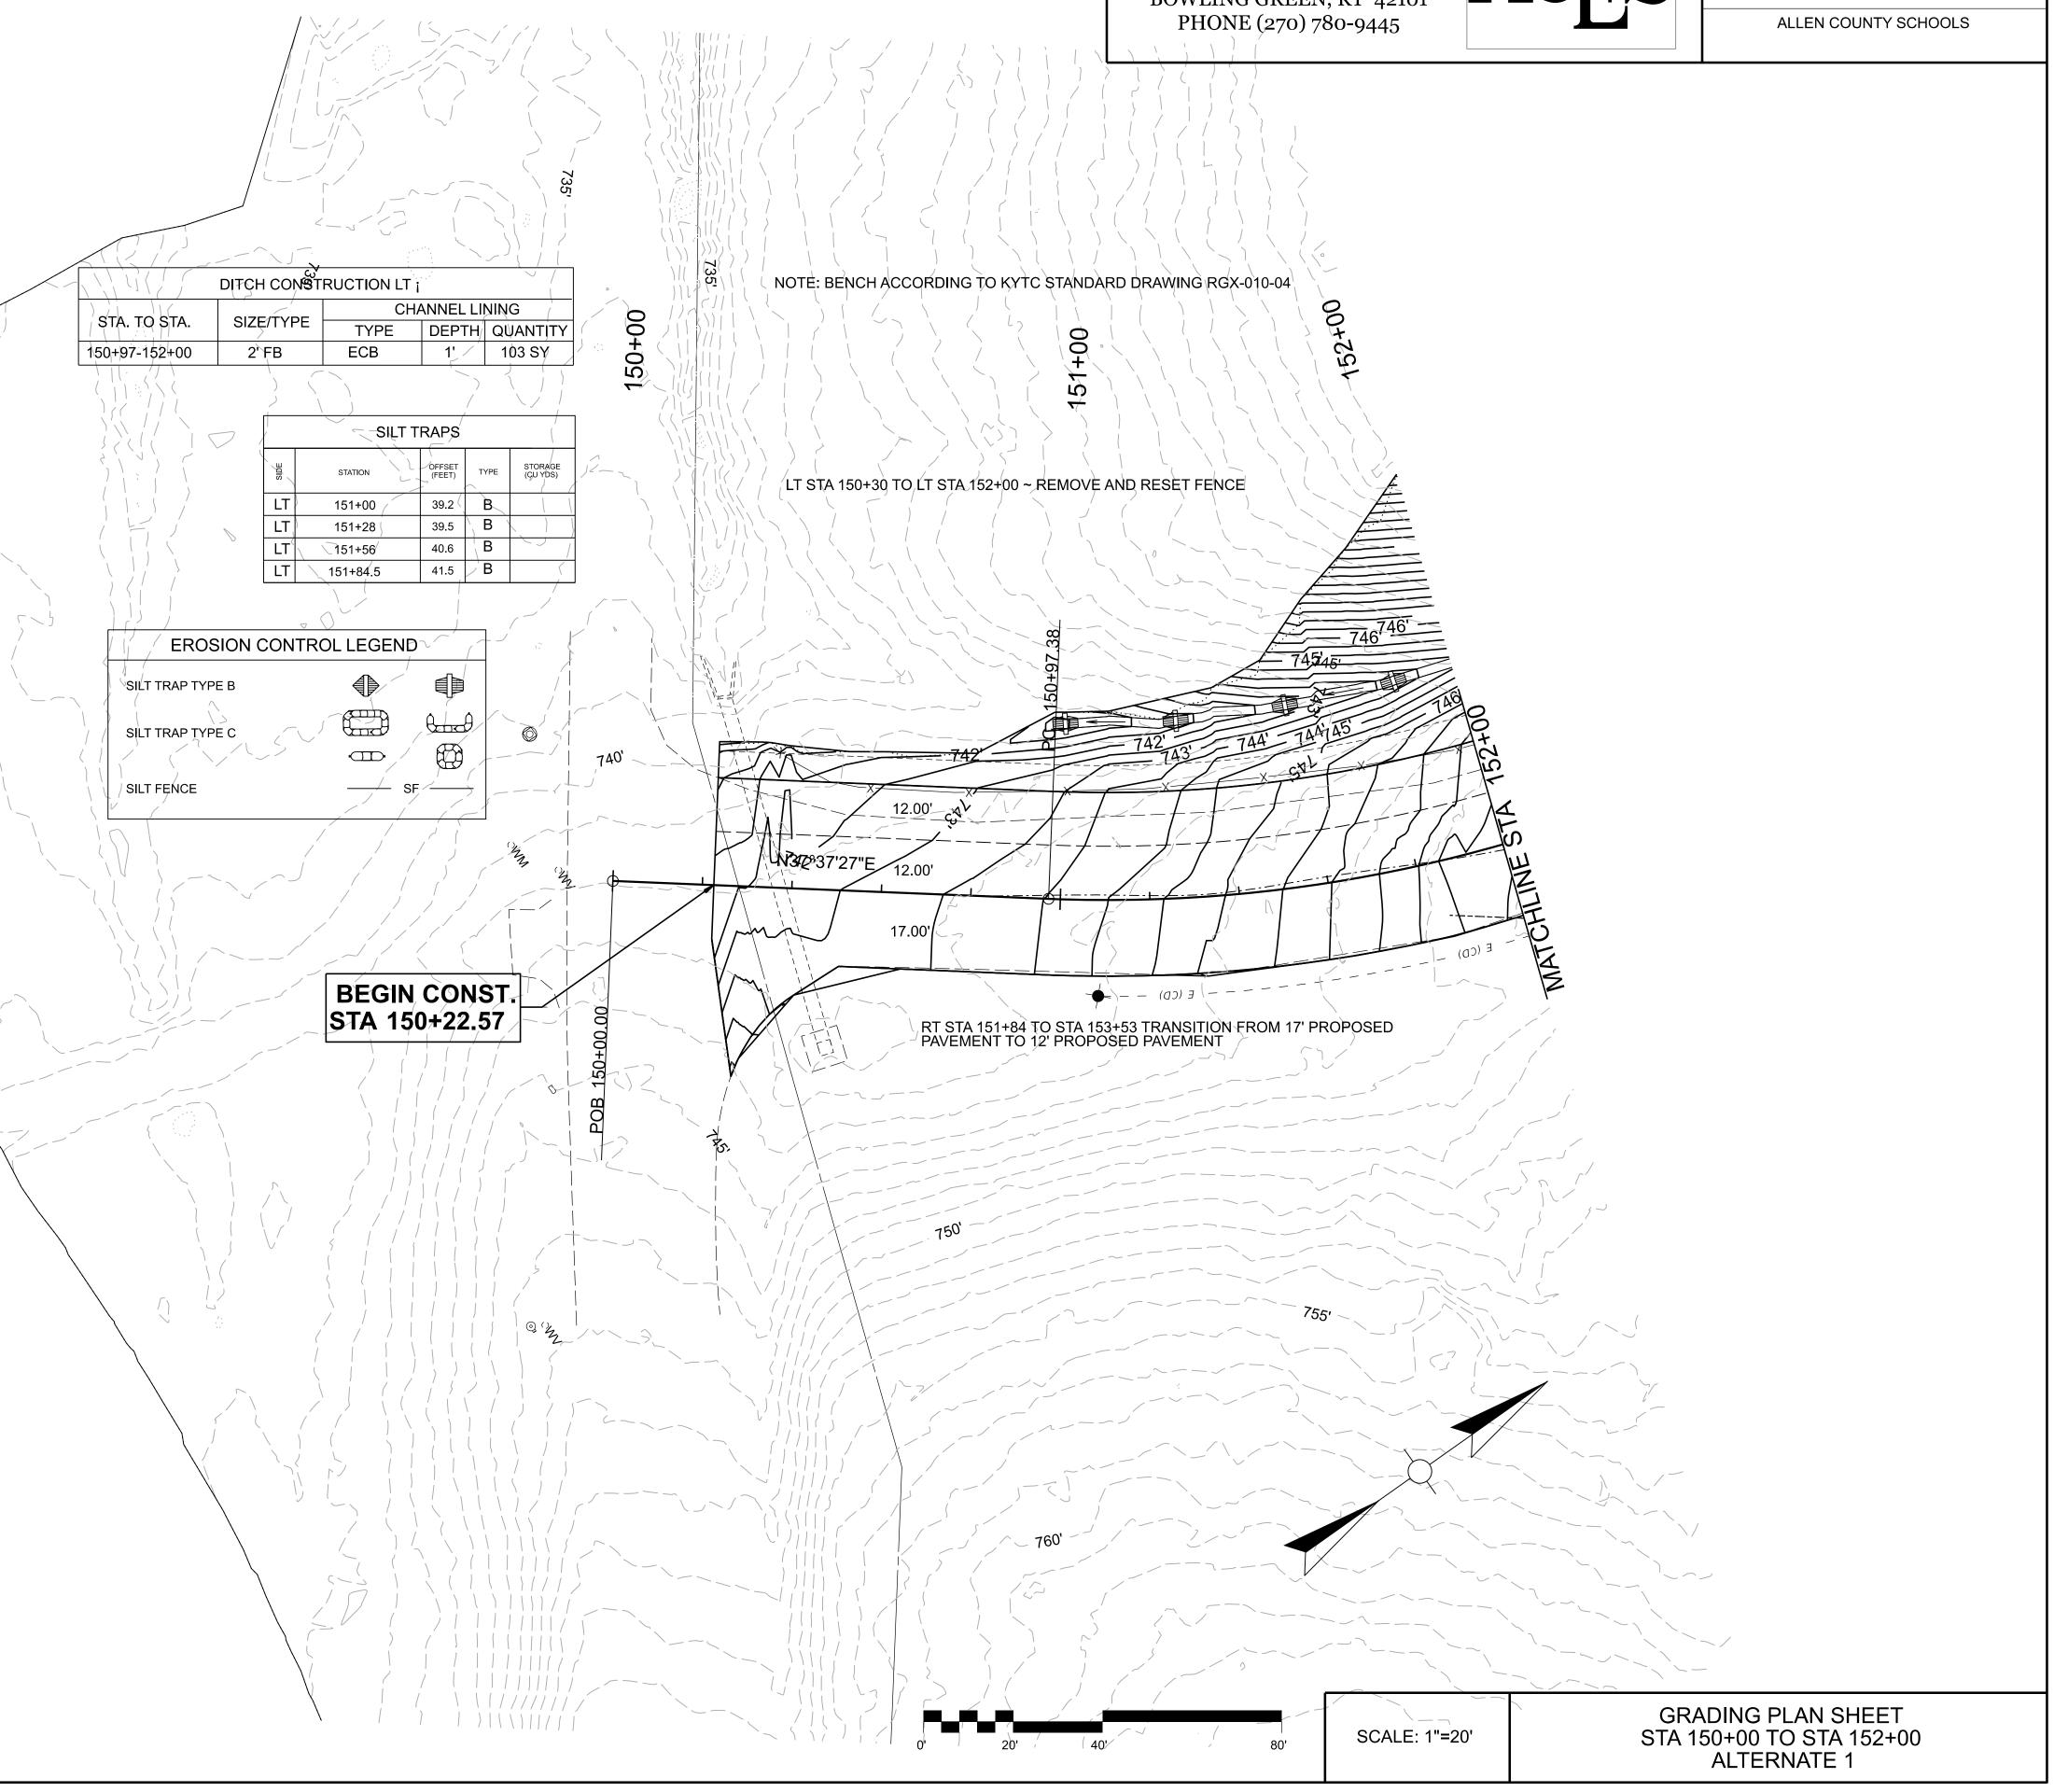






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ALLEN COUNTY SCHOOLS				

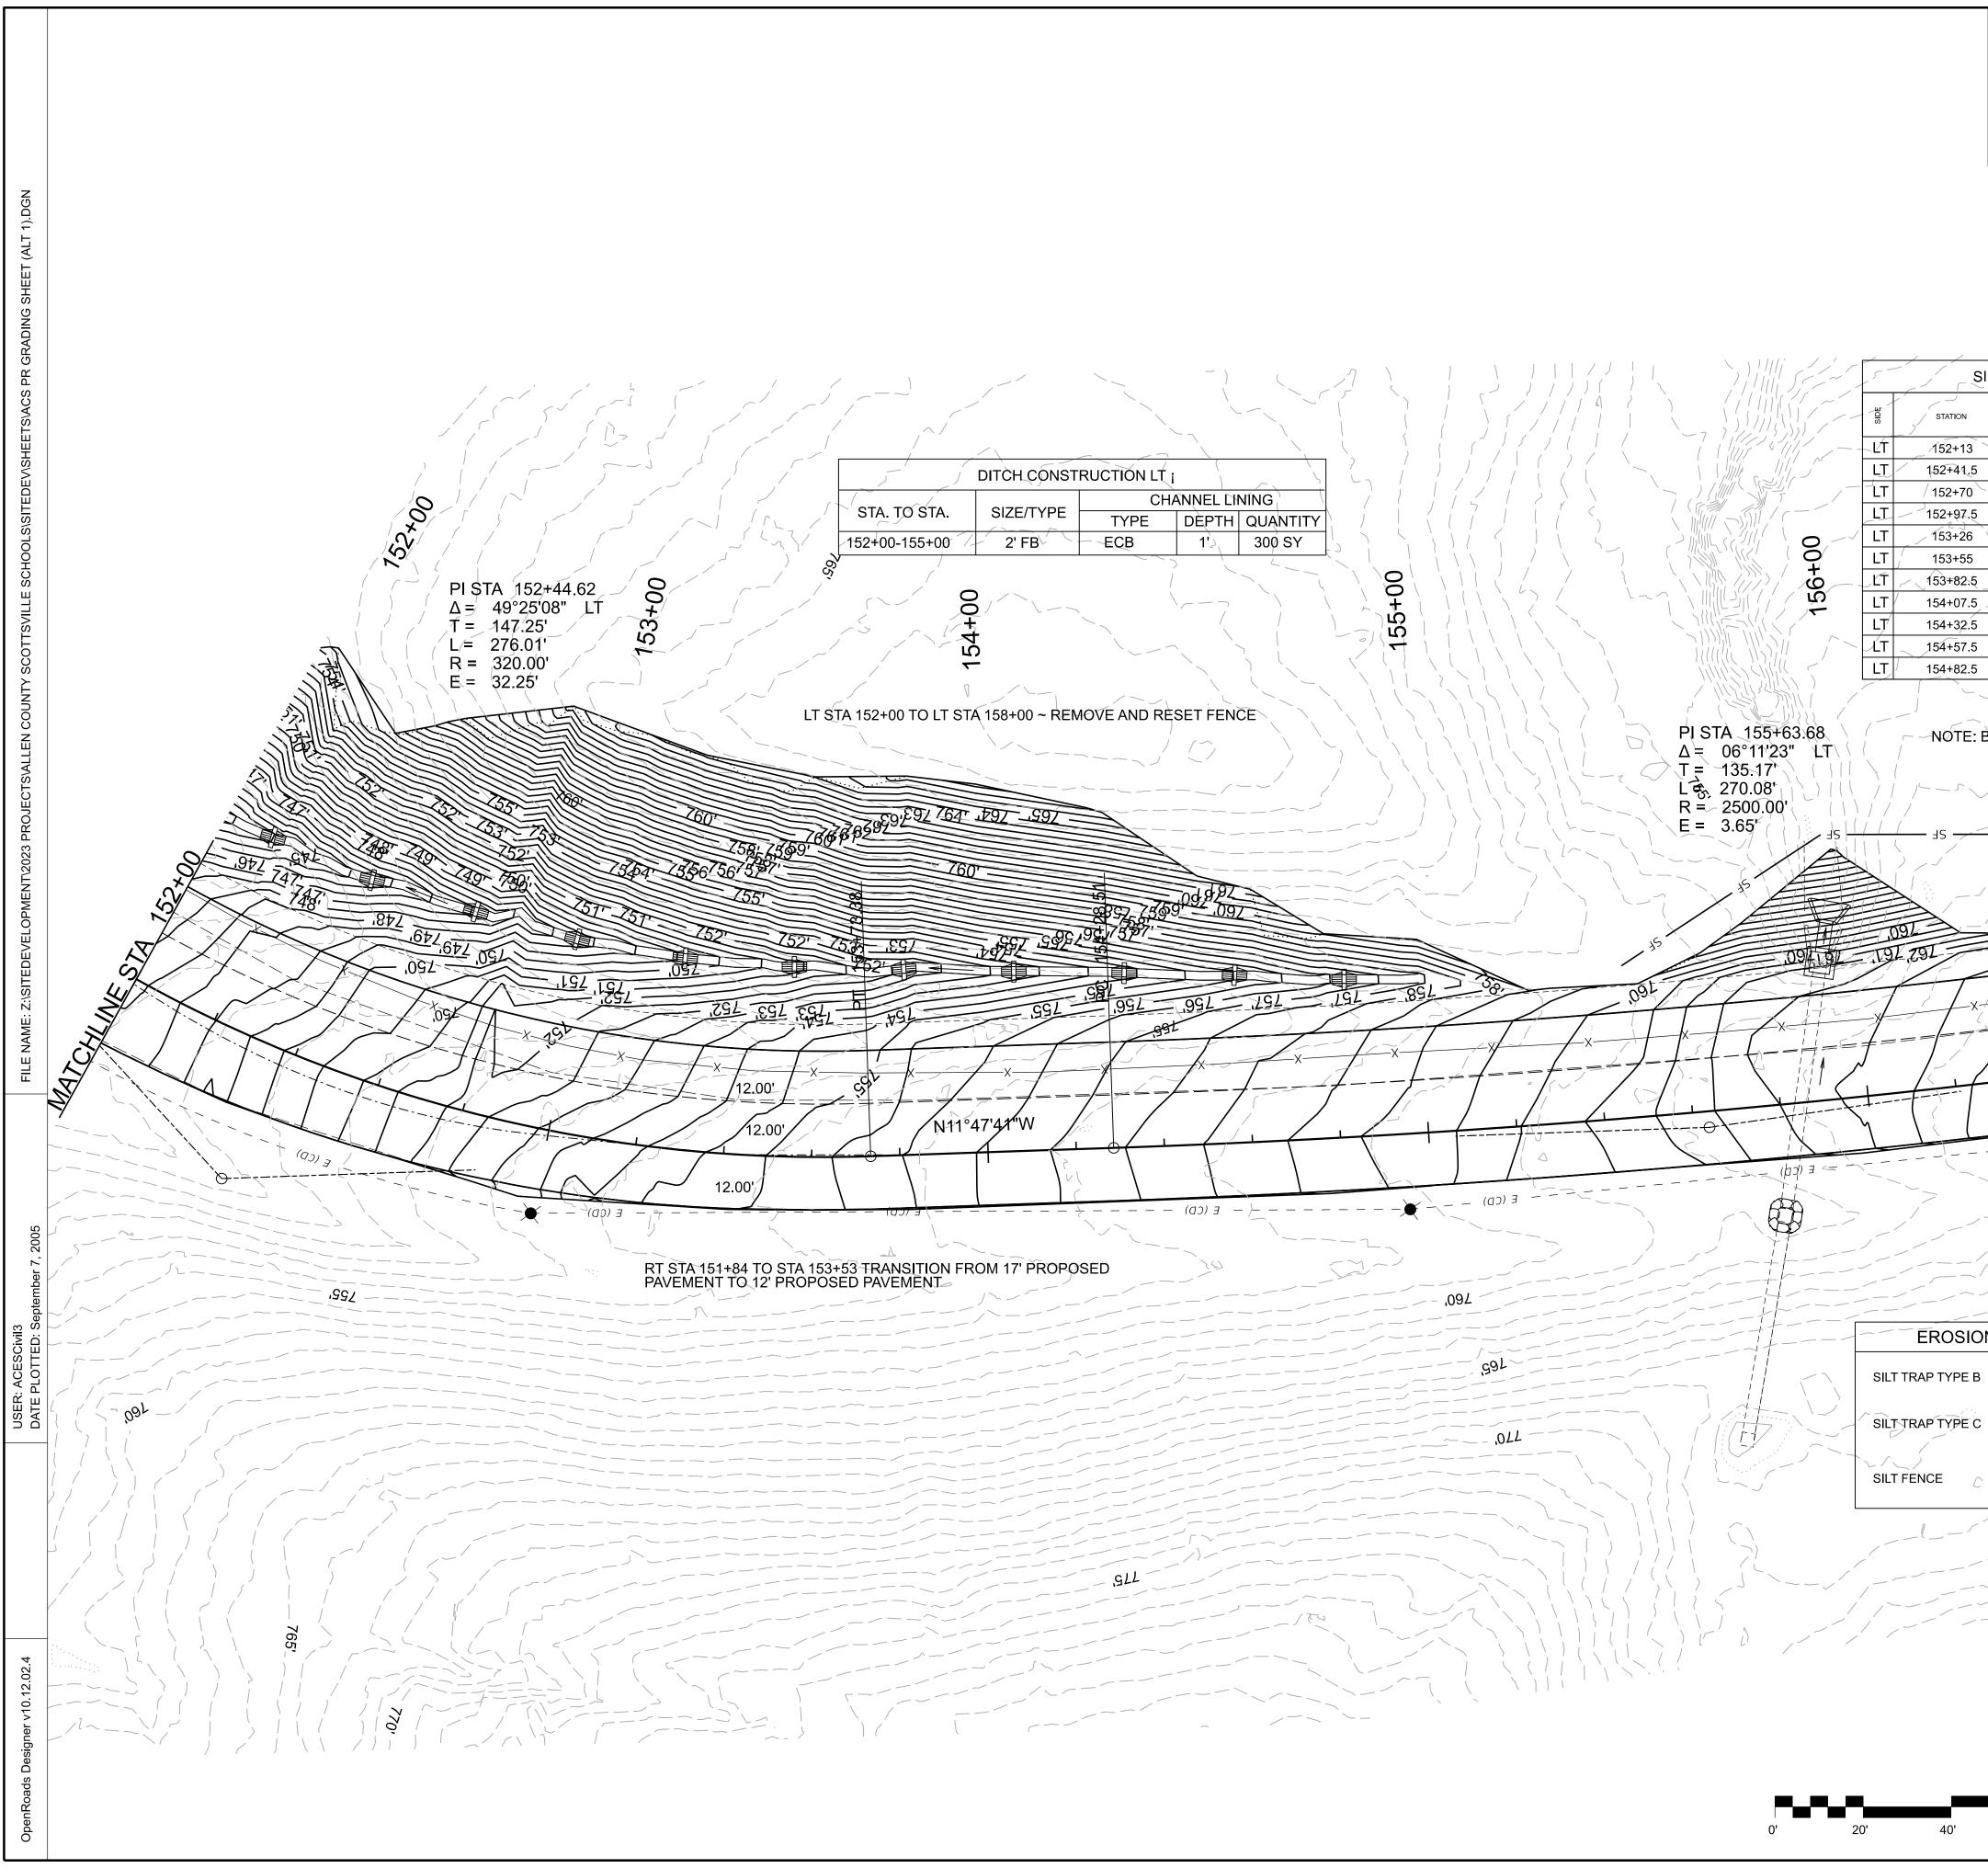



COUNTY OF PROJECT NO. SHEET NO. ARNOLD CONSULTING ENGINEERING SERVICES, INC. ALLEN 23-3243-L 4 P.O. BOX 1338 BOWLING GREEN, KY 42101 CLIENT & PROJECT PHONE (270) 780-9445 ALLEN COUNTY SCHOOLS SILT FENCE SILT TRAPS AREA CONTAINED (SQ FT) STORAGE (CU YDS) OFFSET (FEET) LENGTH (FEET) TYPE TYRE STATION 00 LT 155+46-158+00 261 SF 42.9 B 43.3 B 20 20 44.3 B 00 T 43.7 B. 43.3 B 57 42.9 B -42.1 B 40.8 B 39.5 B 38.1 B 35.8 / B NOTE: BENCH ACCORDING TO KYTC STANDARD DRAWING RGX-010-04 MATCHLINE E (CD) - E(CD) - - - [J] -SILT TRAPS STORAGE (CU YDS) OFFSET (FÉET) STATION TYPE RT 155+65.85 74.9 C **EROSION CONTROL LEGEND**  $\blacksquare$ tind) Ð 


GRADING PLAN SHEET STA 152+00 TO STA 158+00 ALTERNATE 1

SCALE: 1"=20'

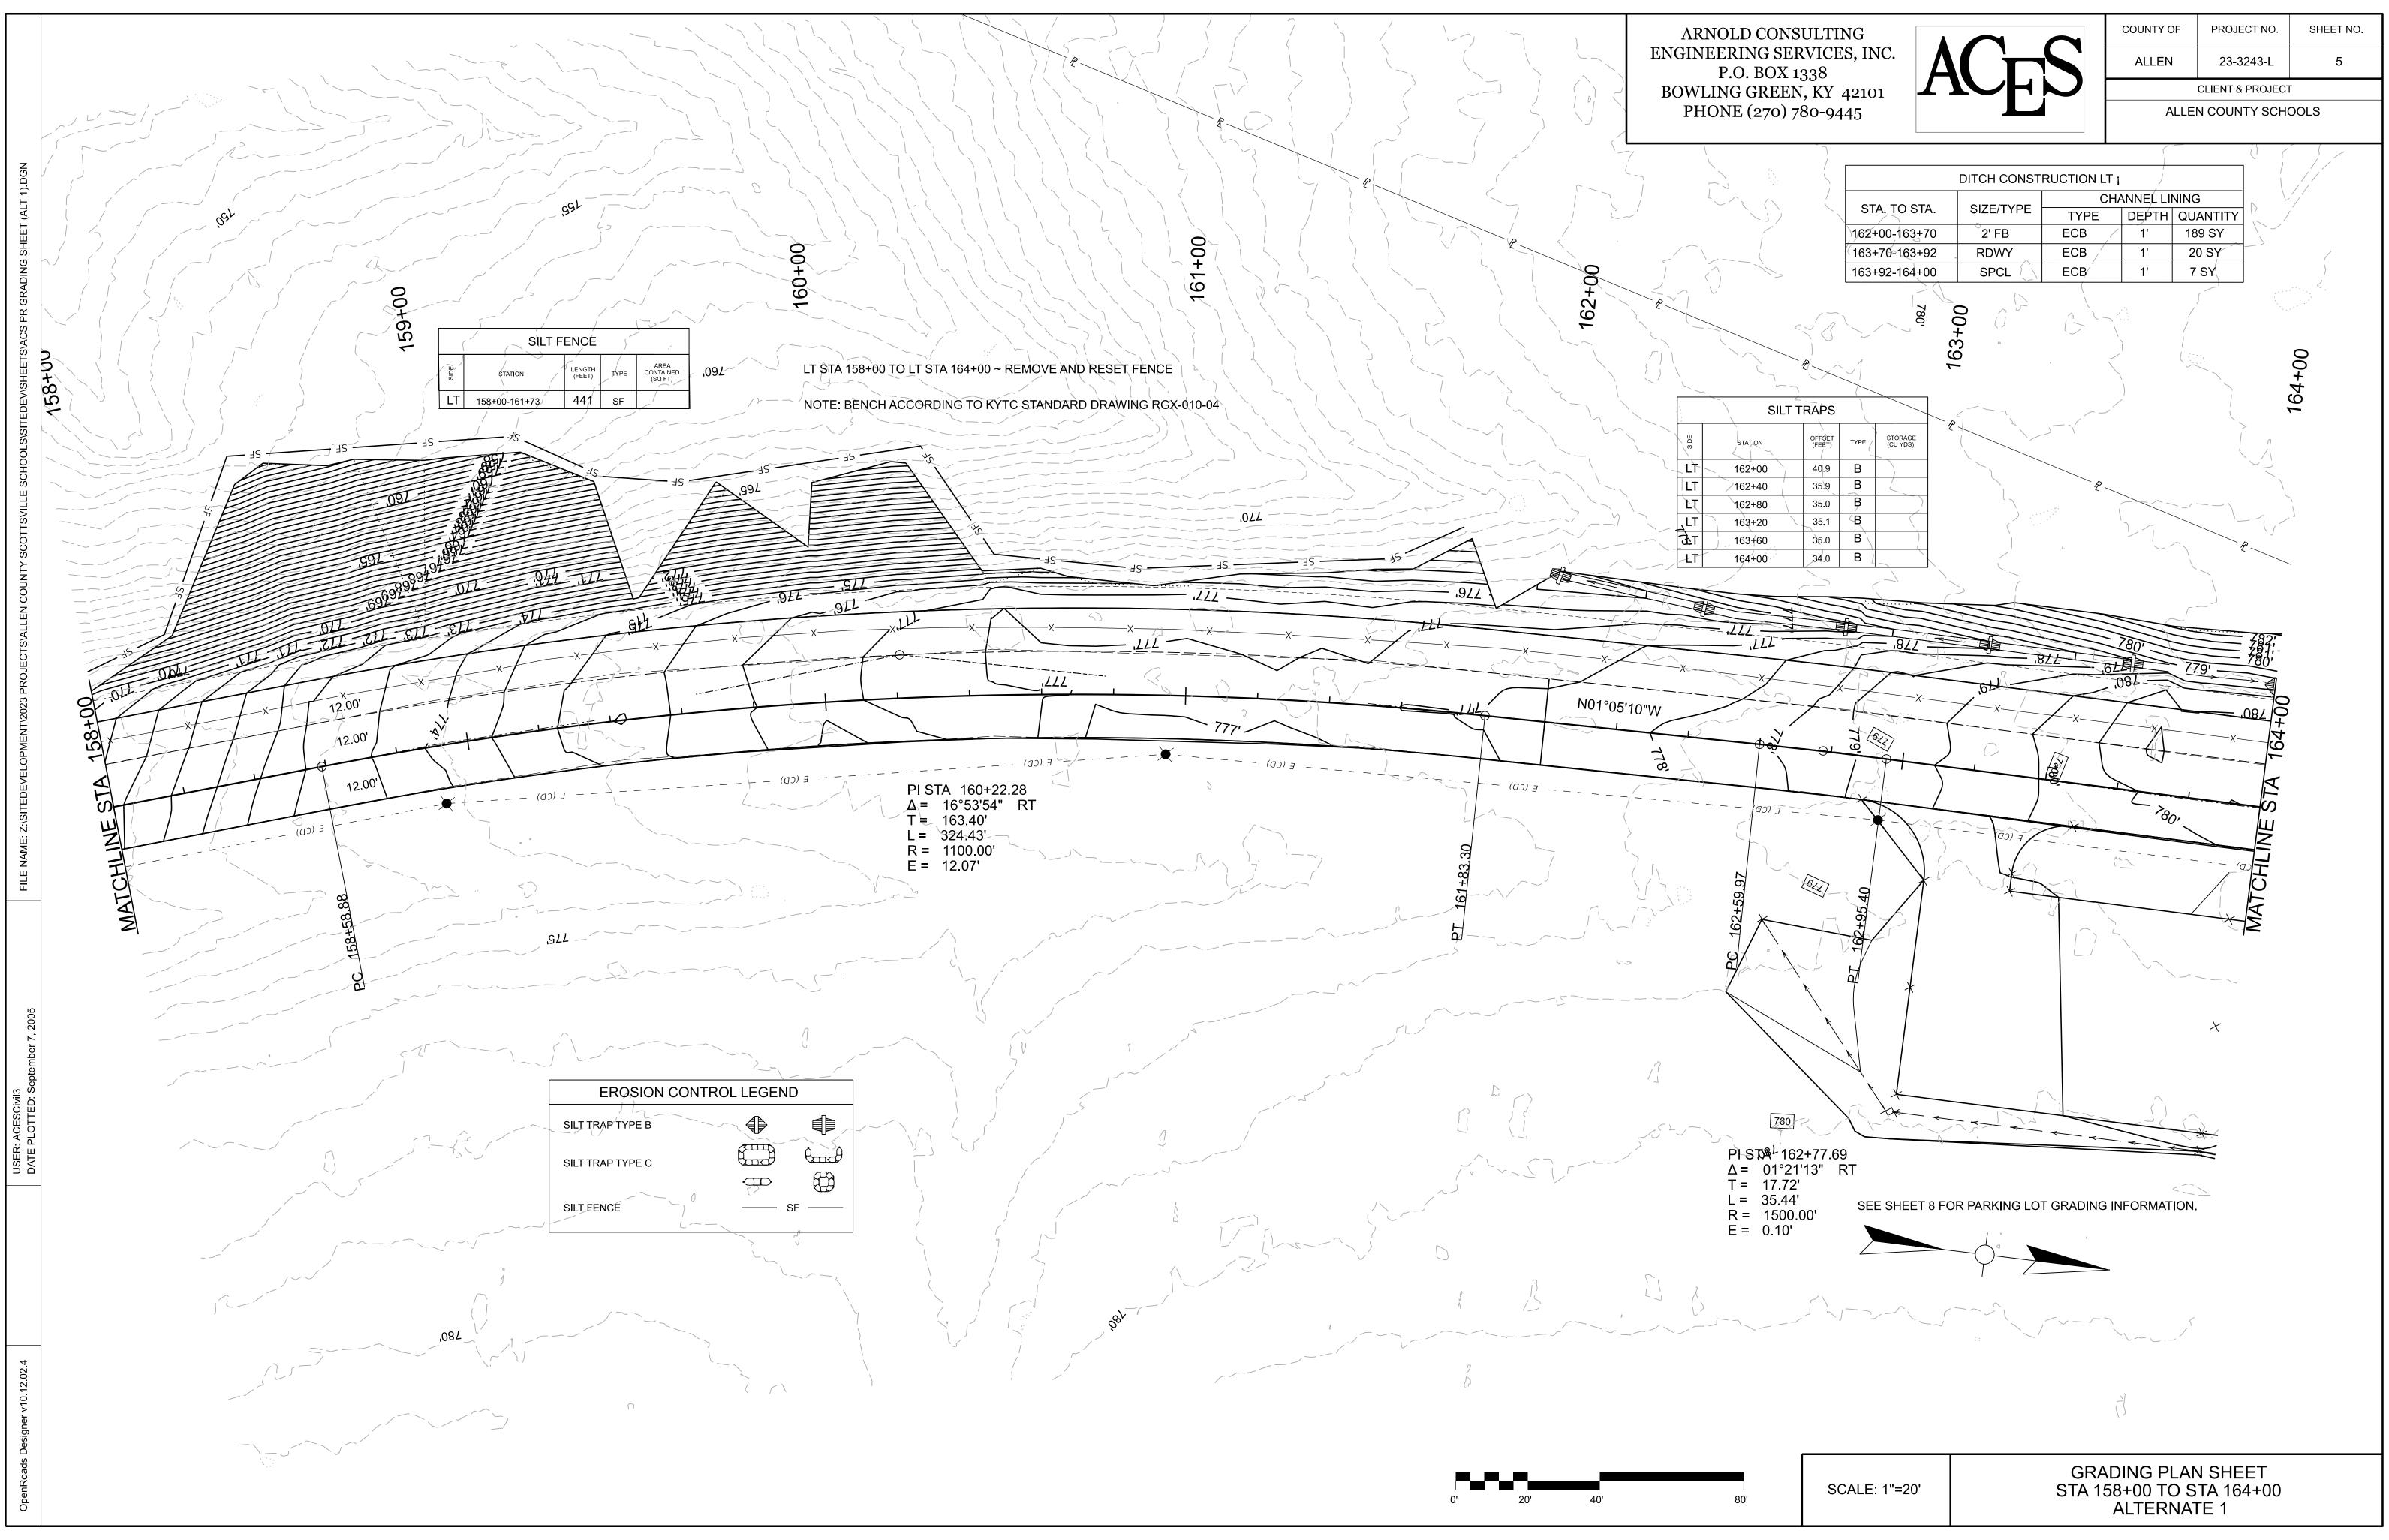


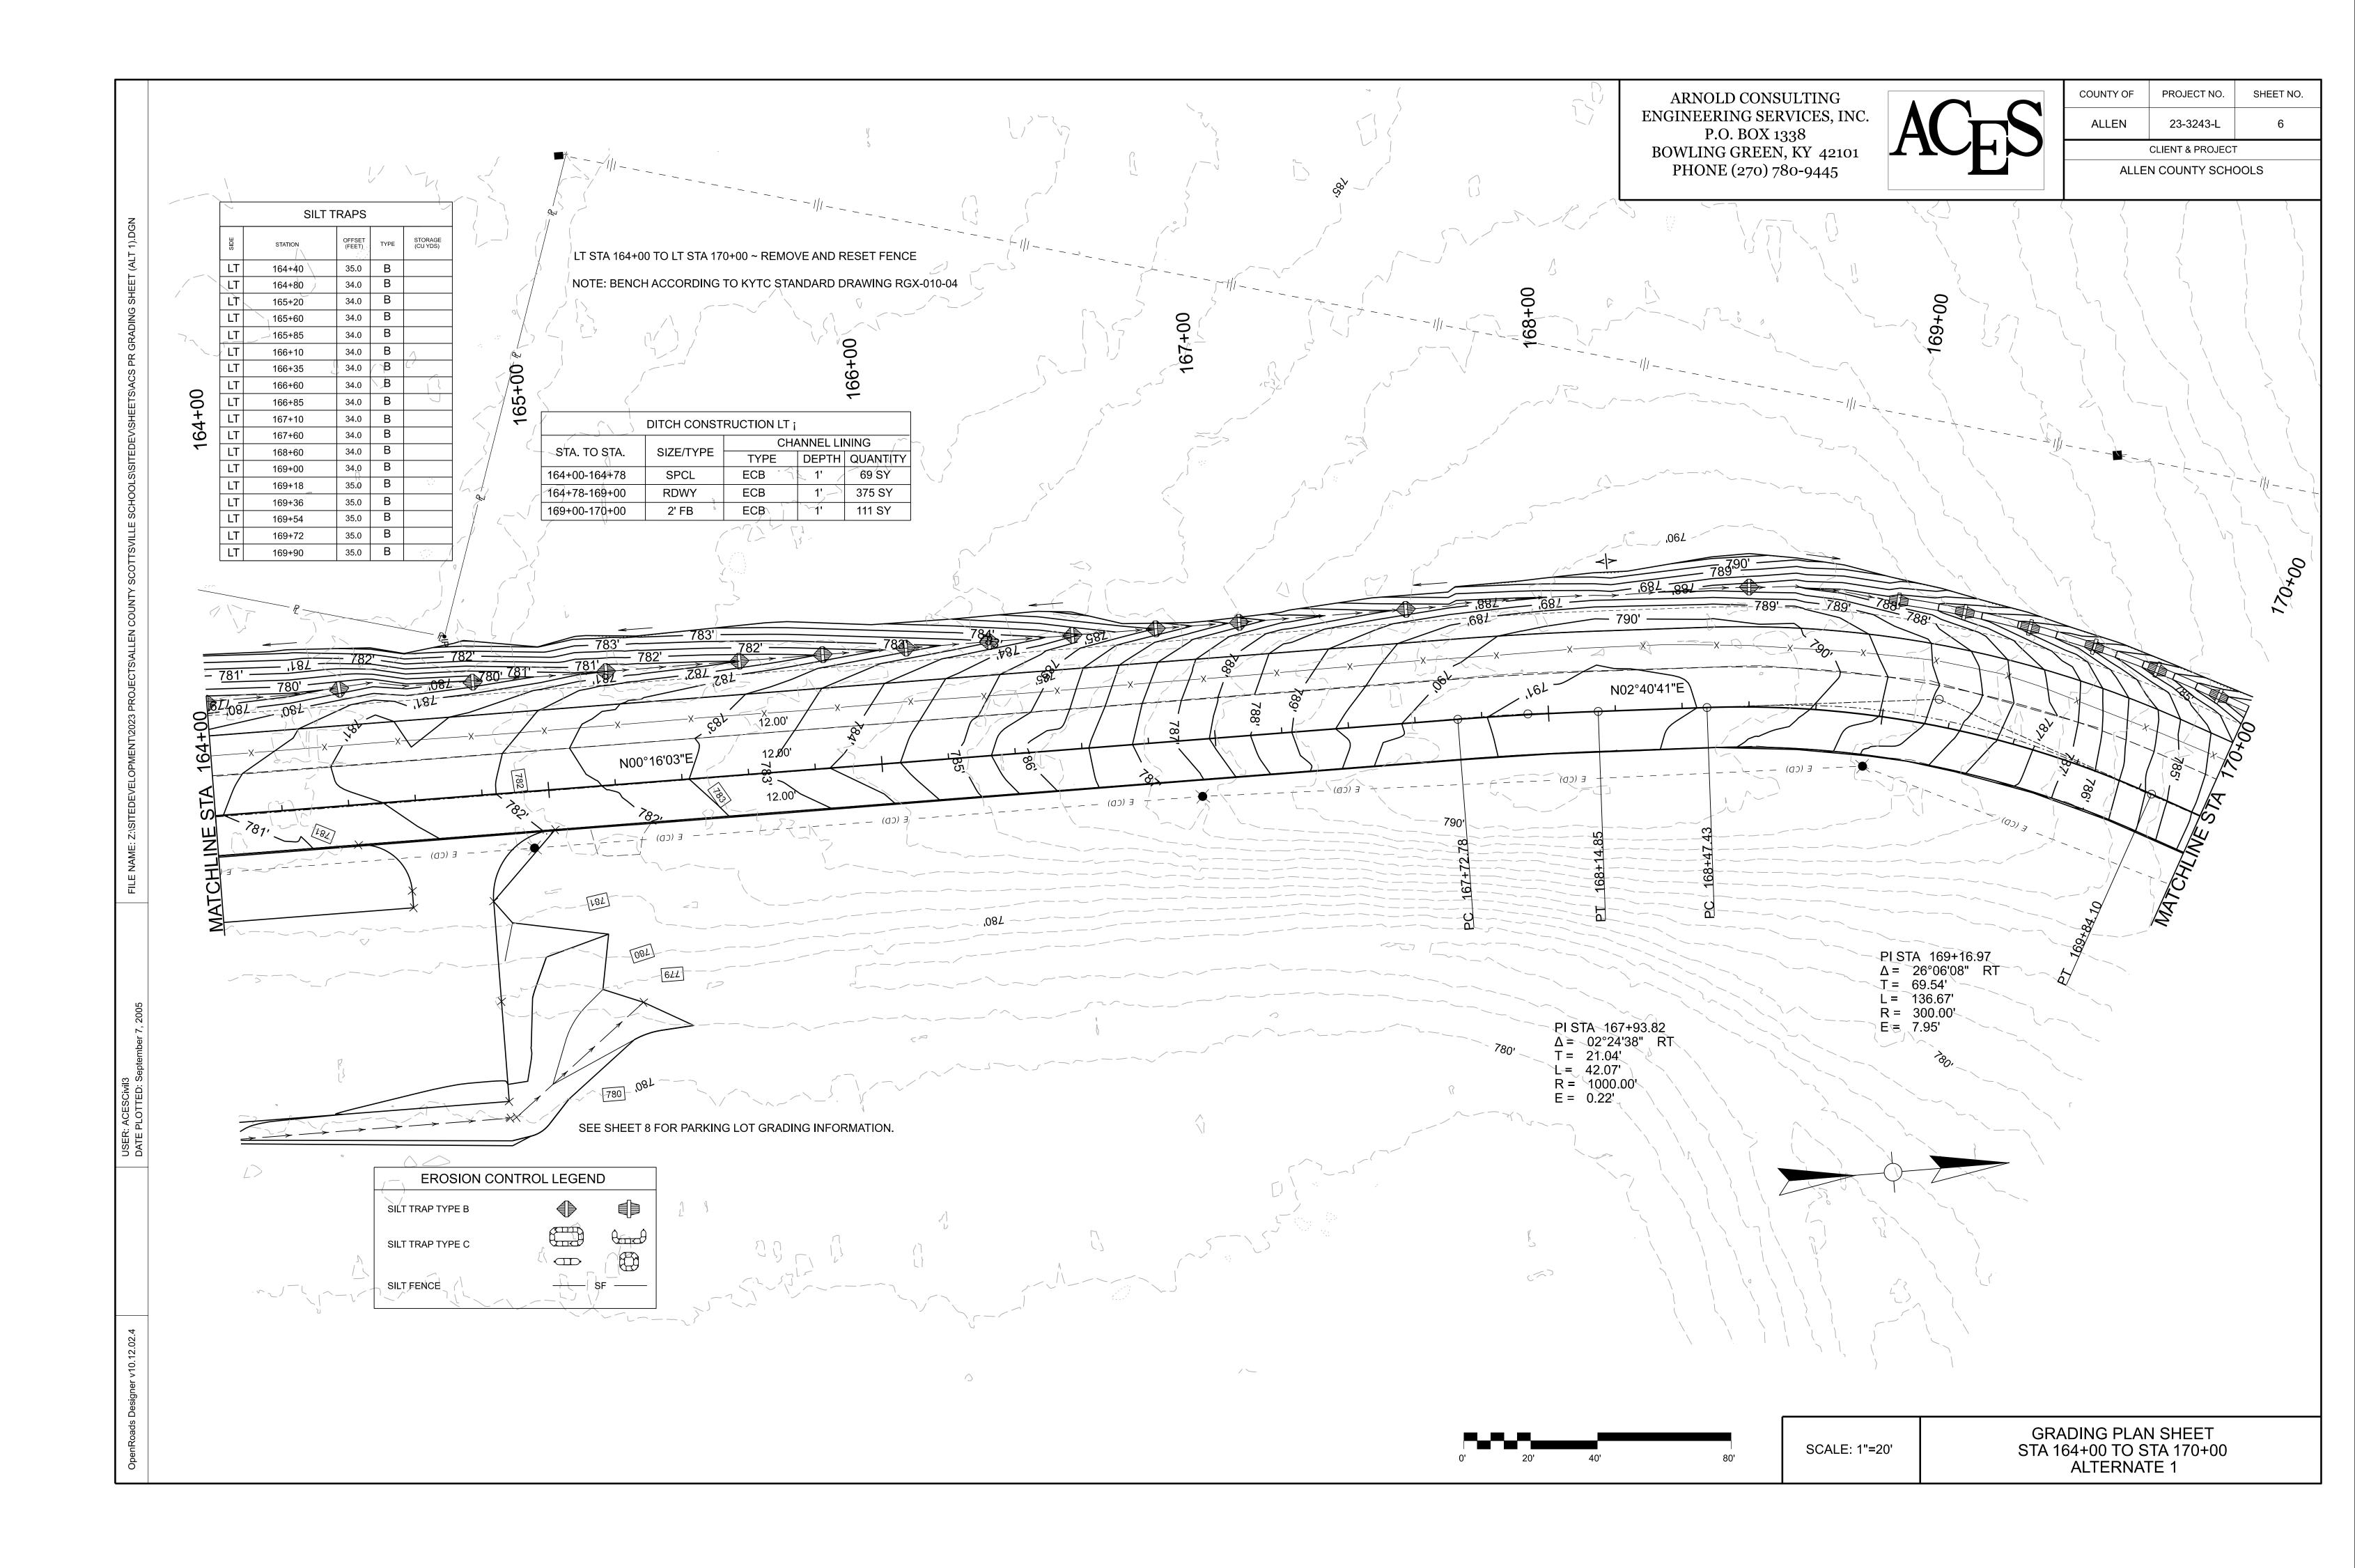

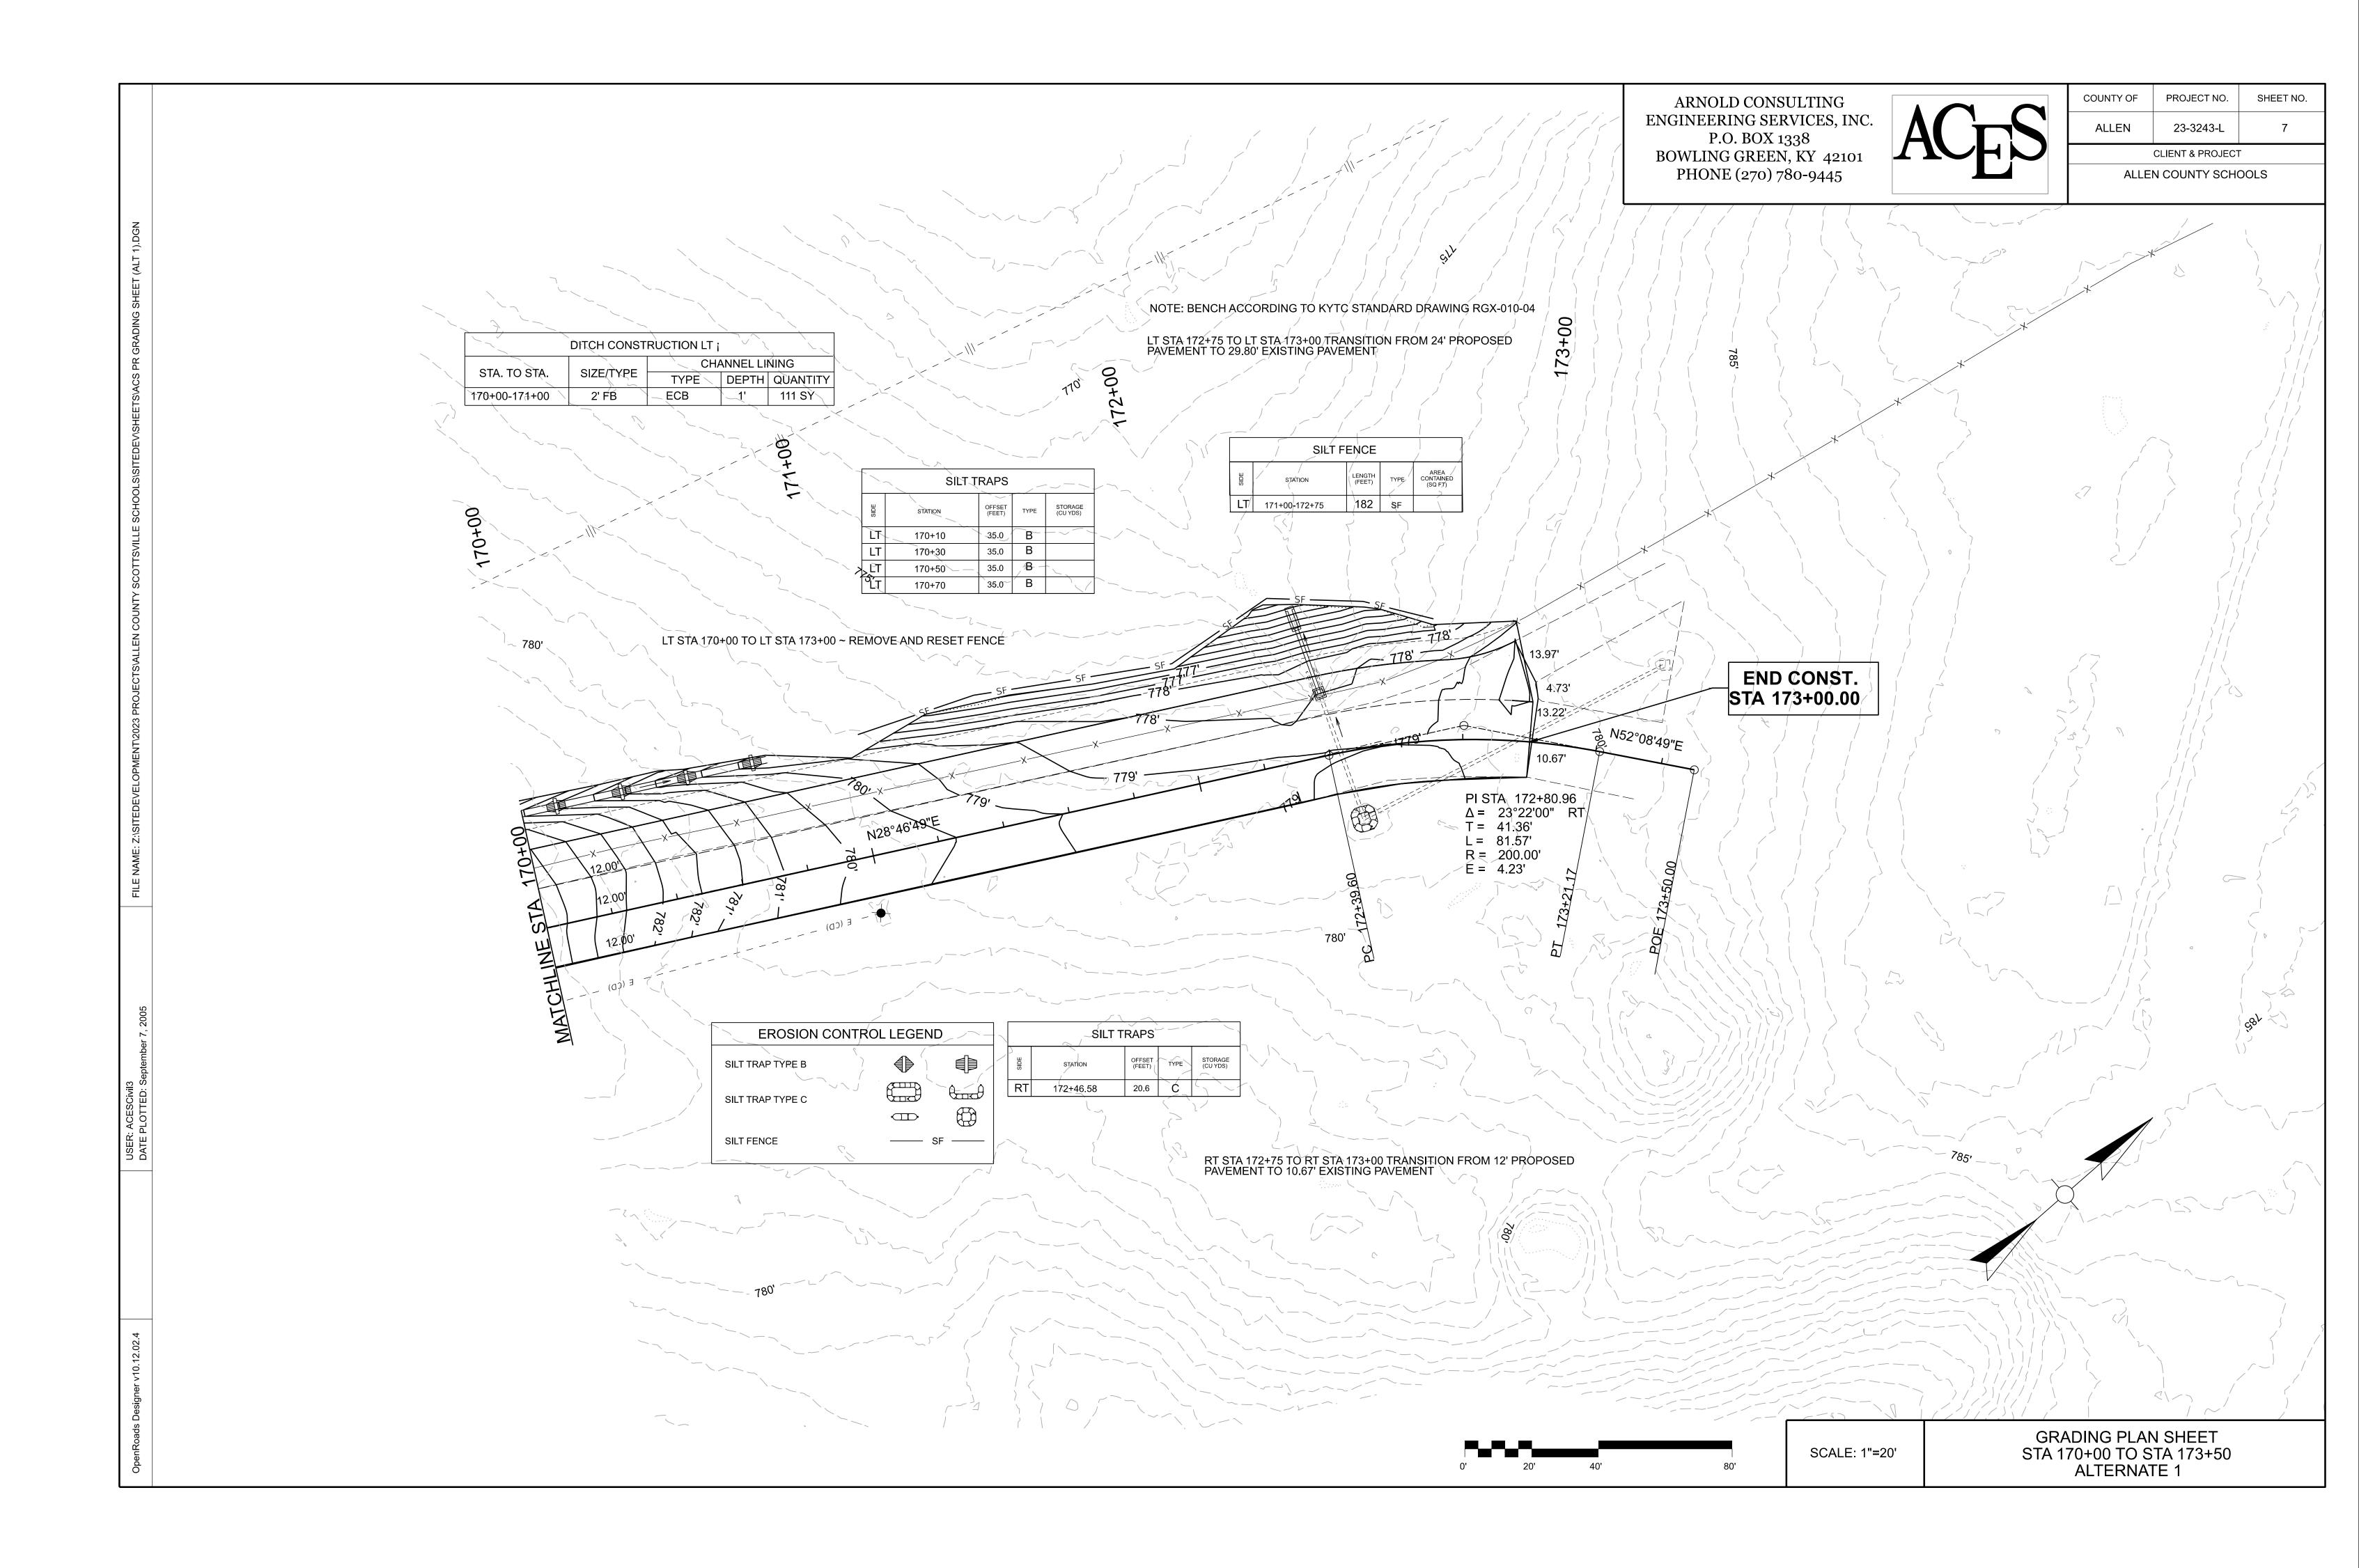

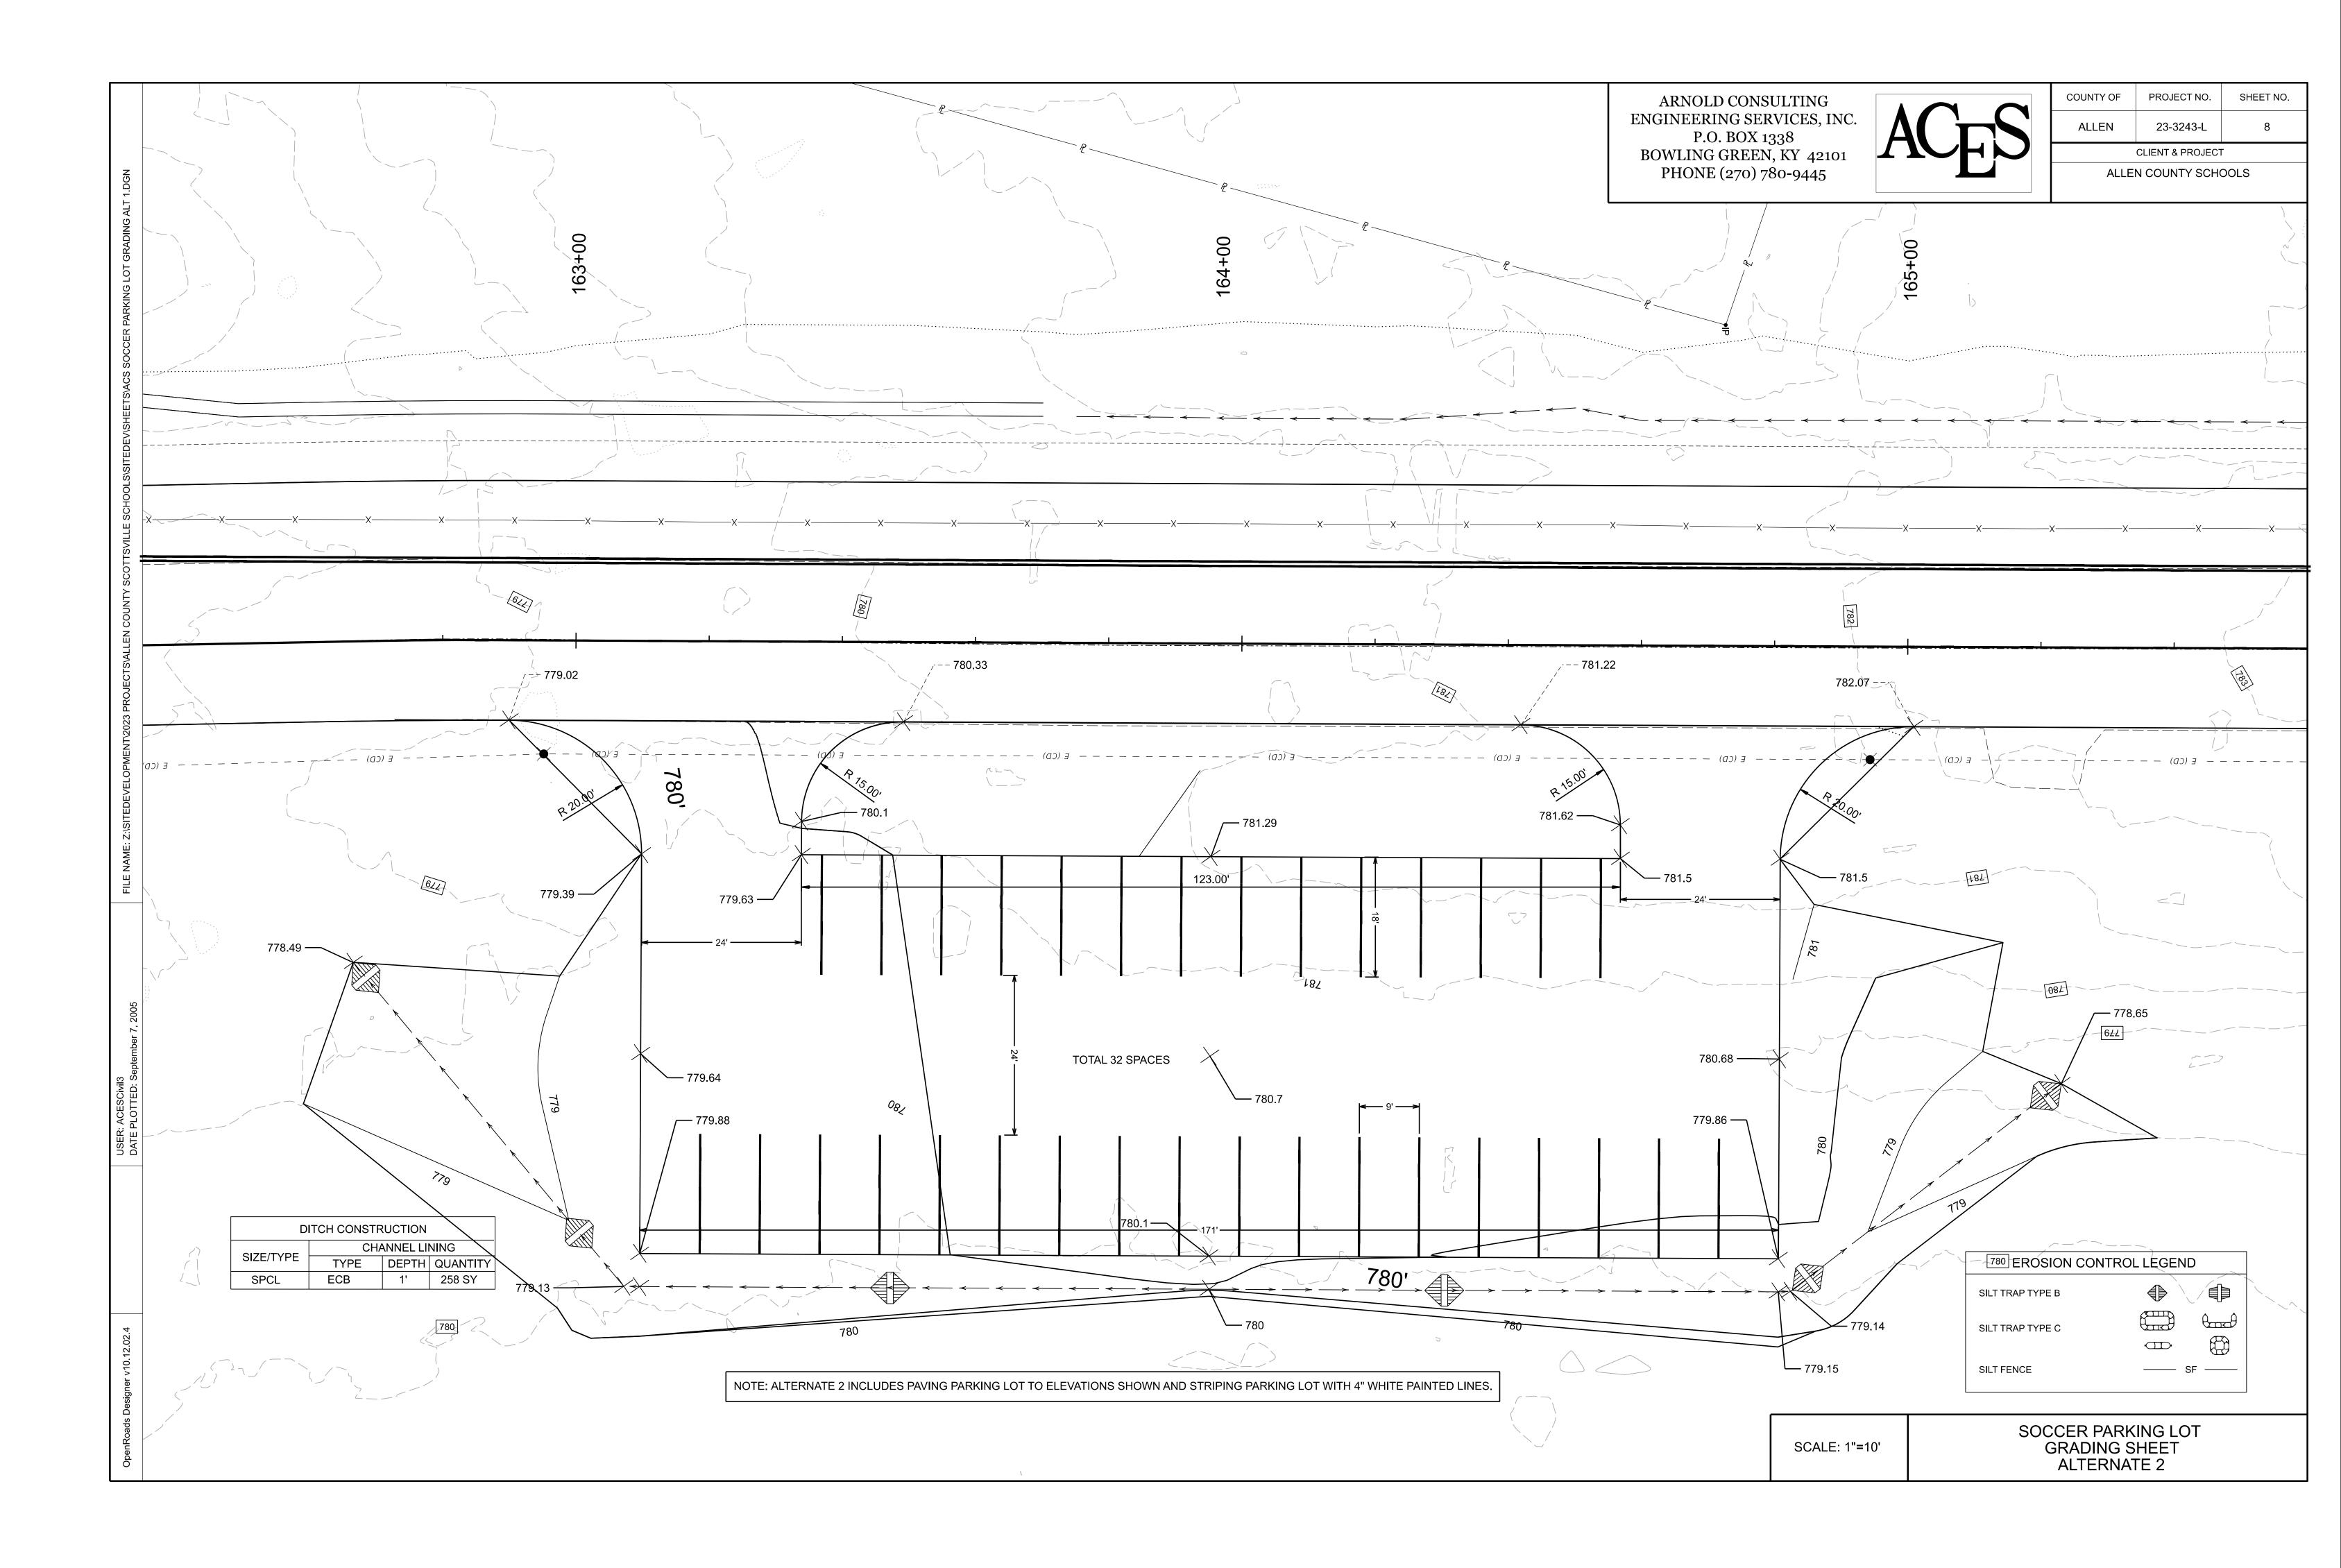


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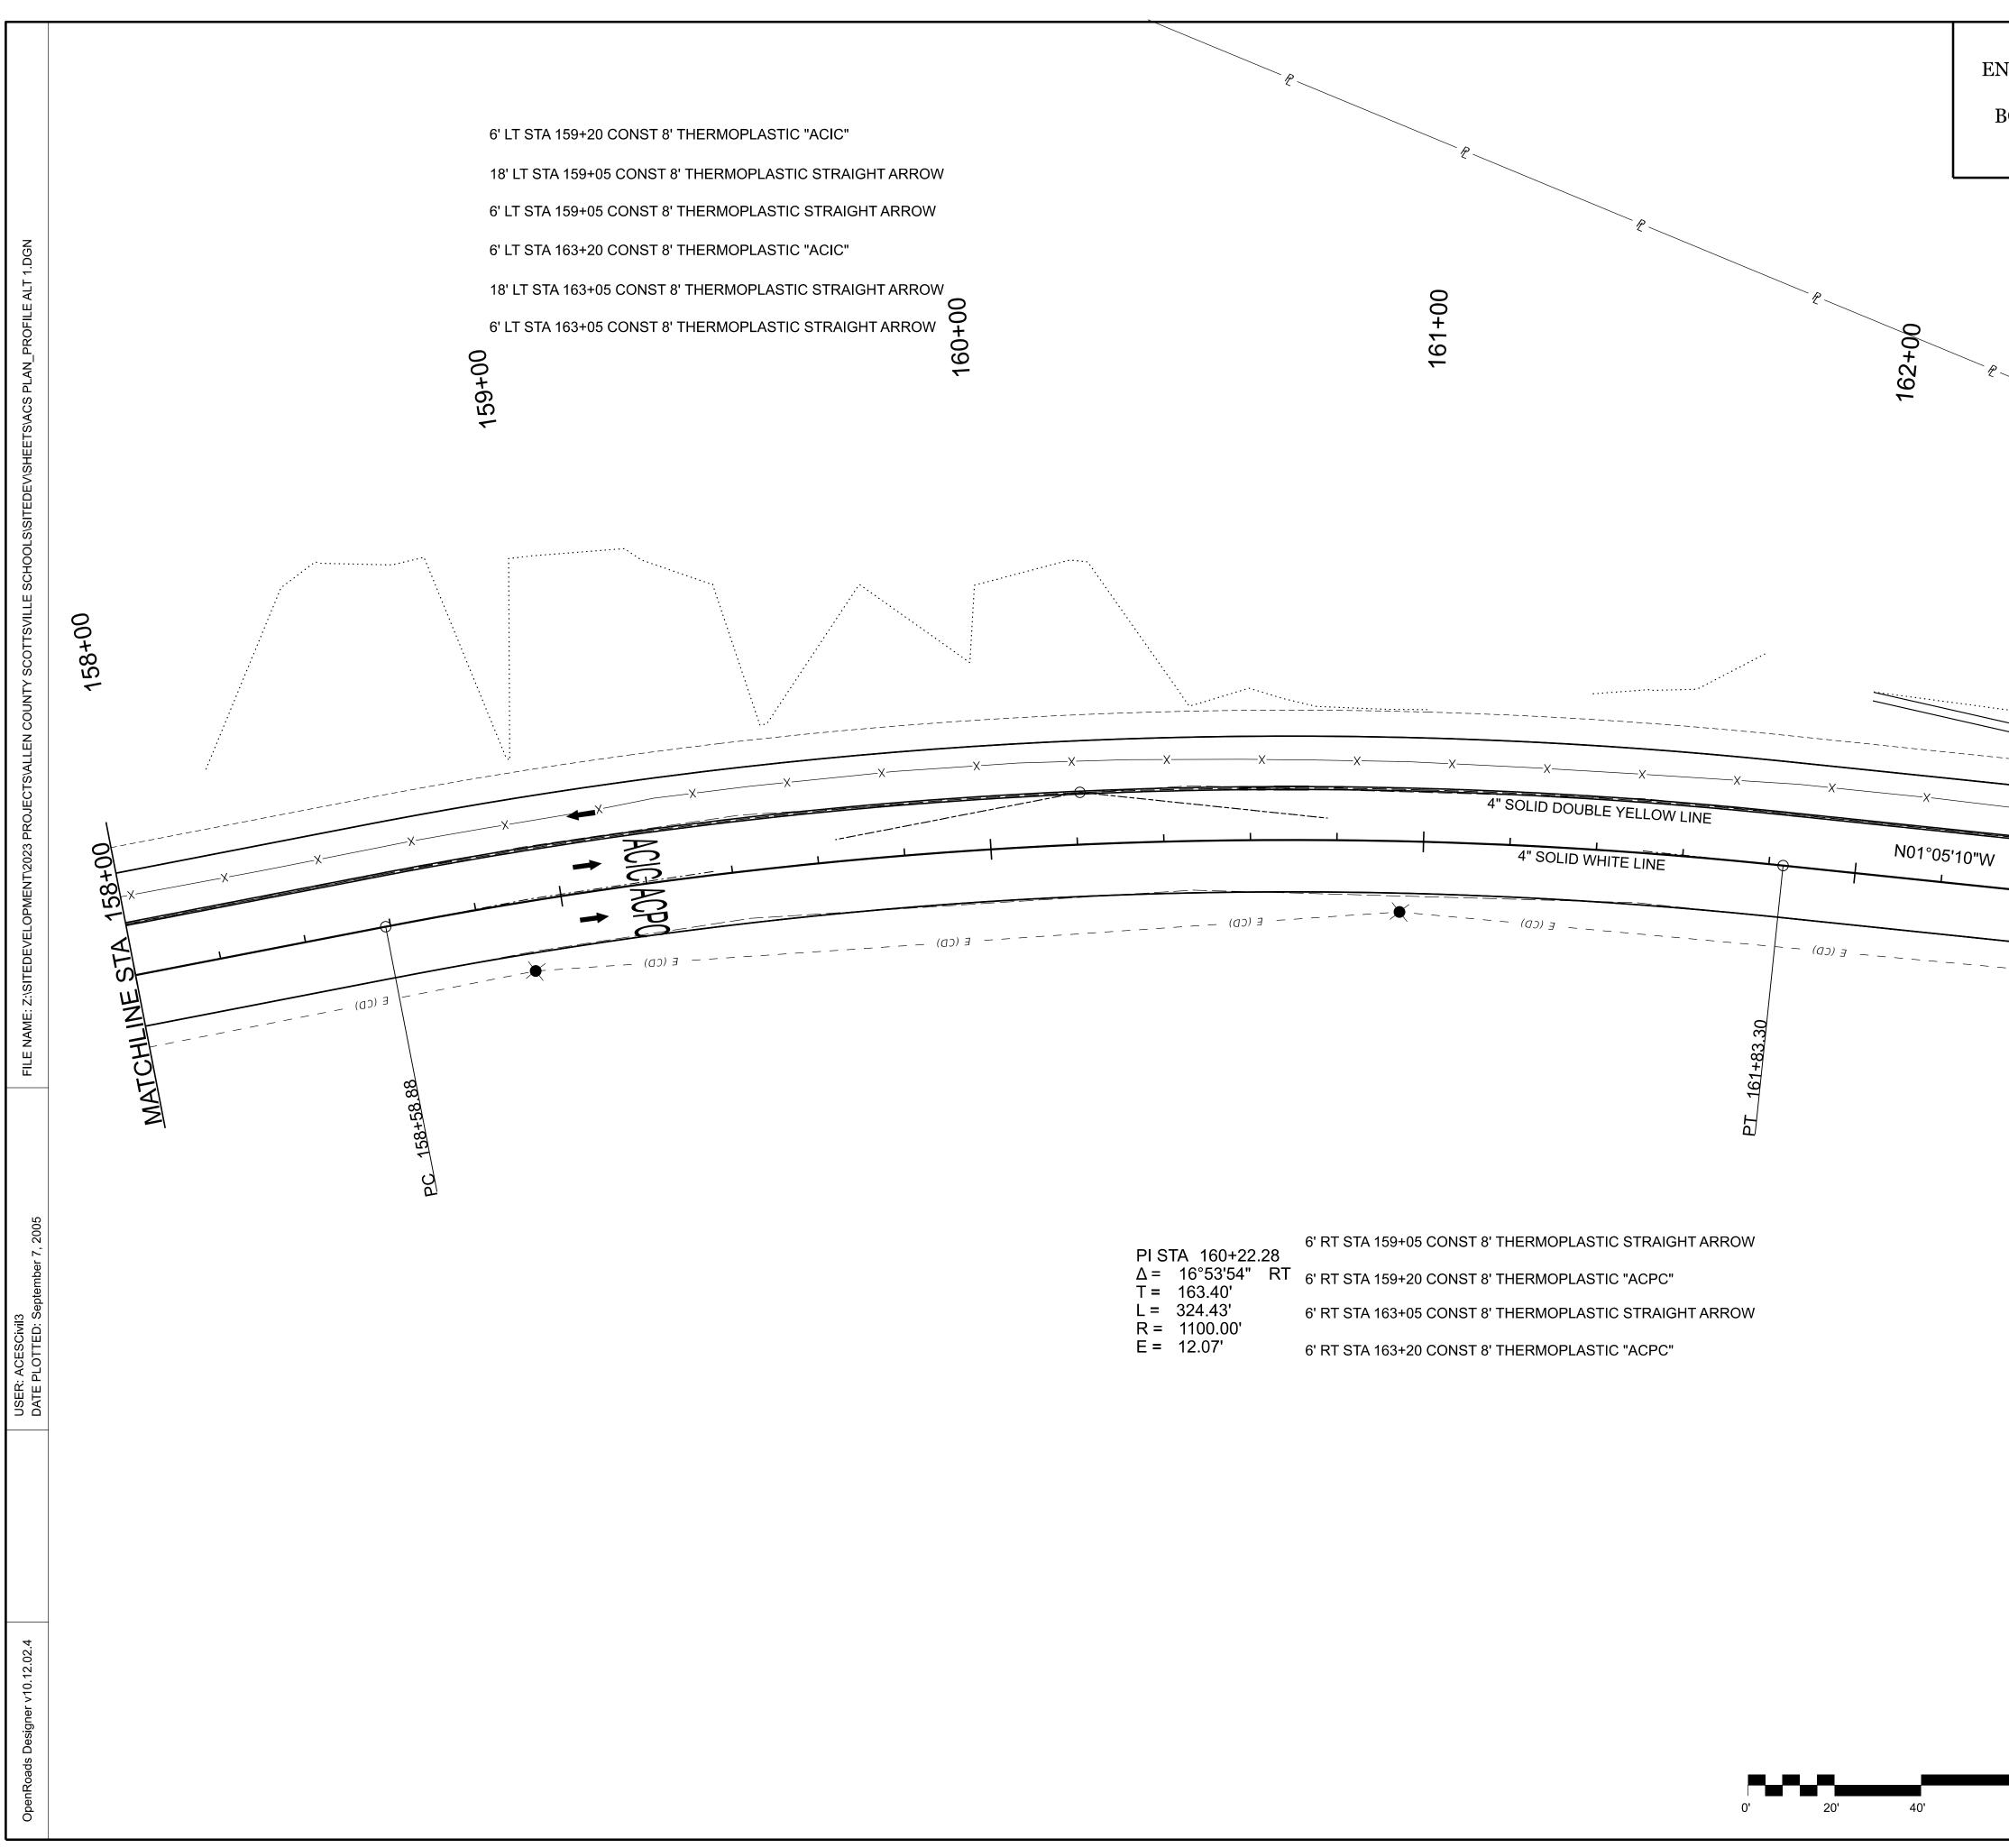
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CLIENT & PROJECT			
ALLEN COUNTY SCHOOLS			

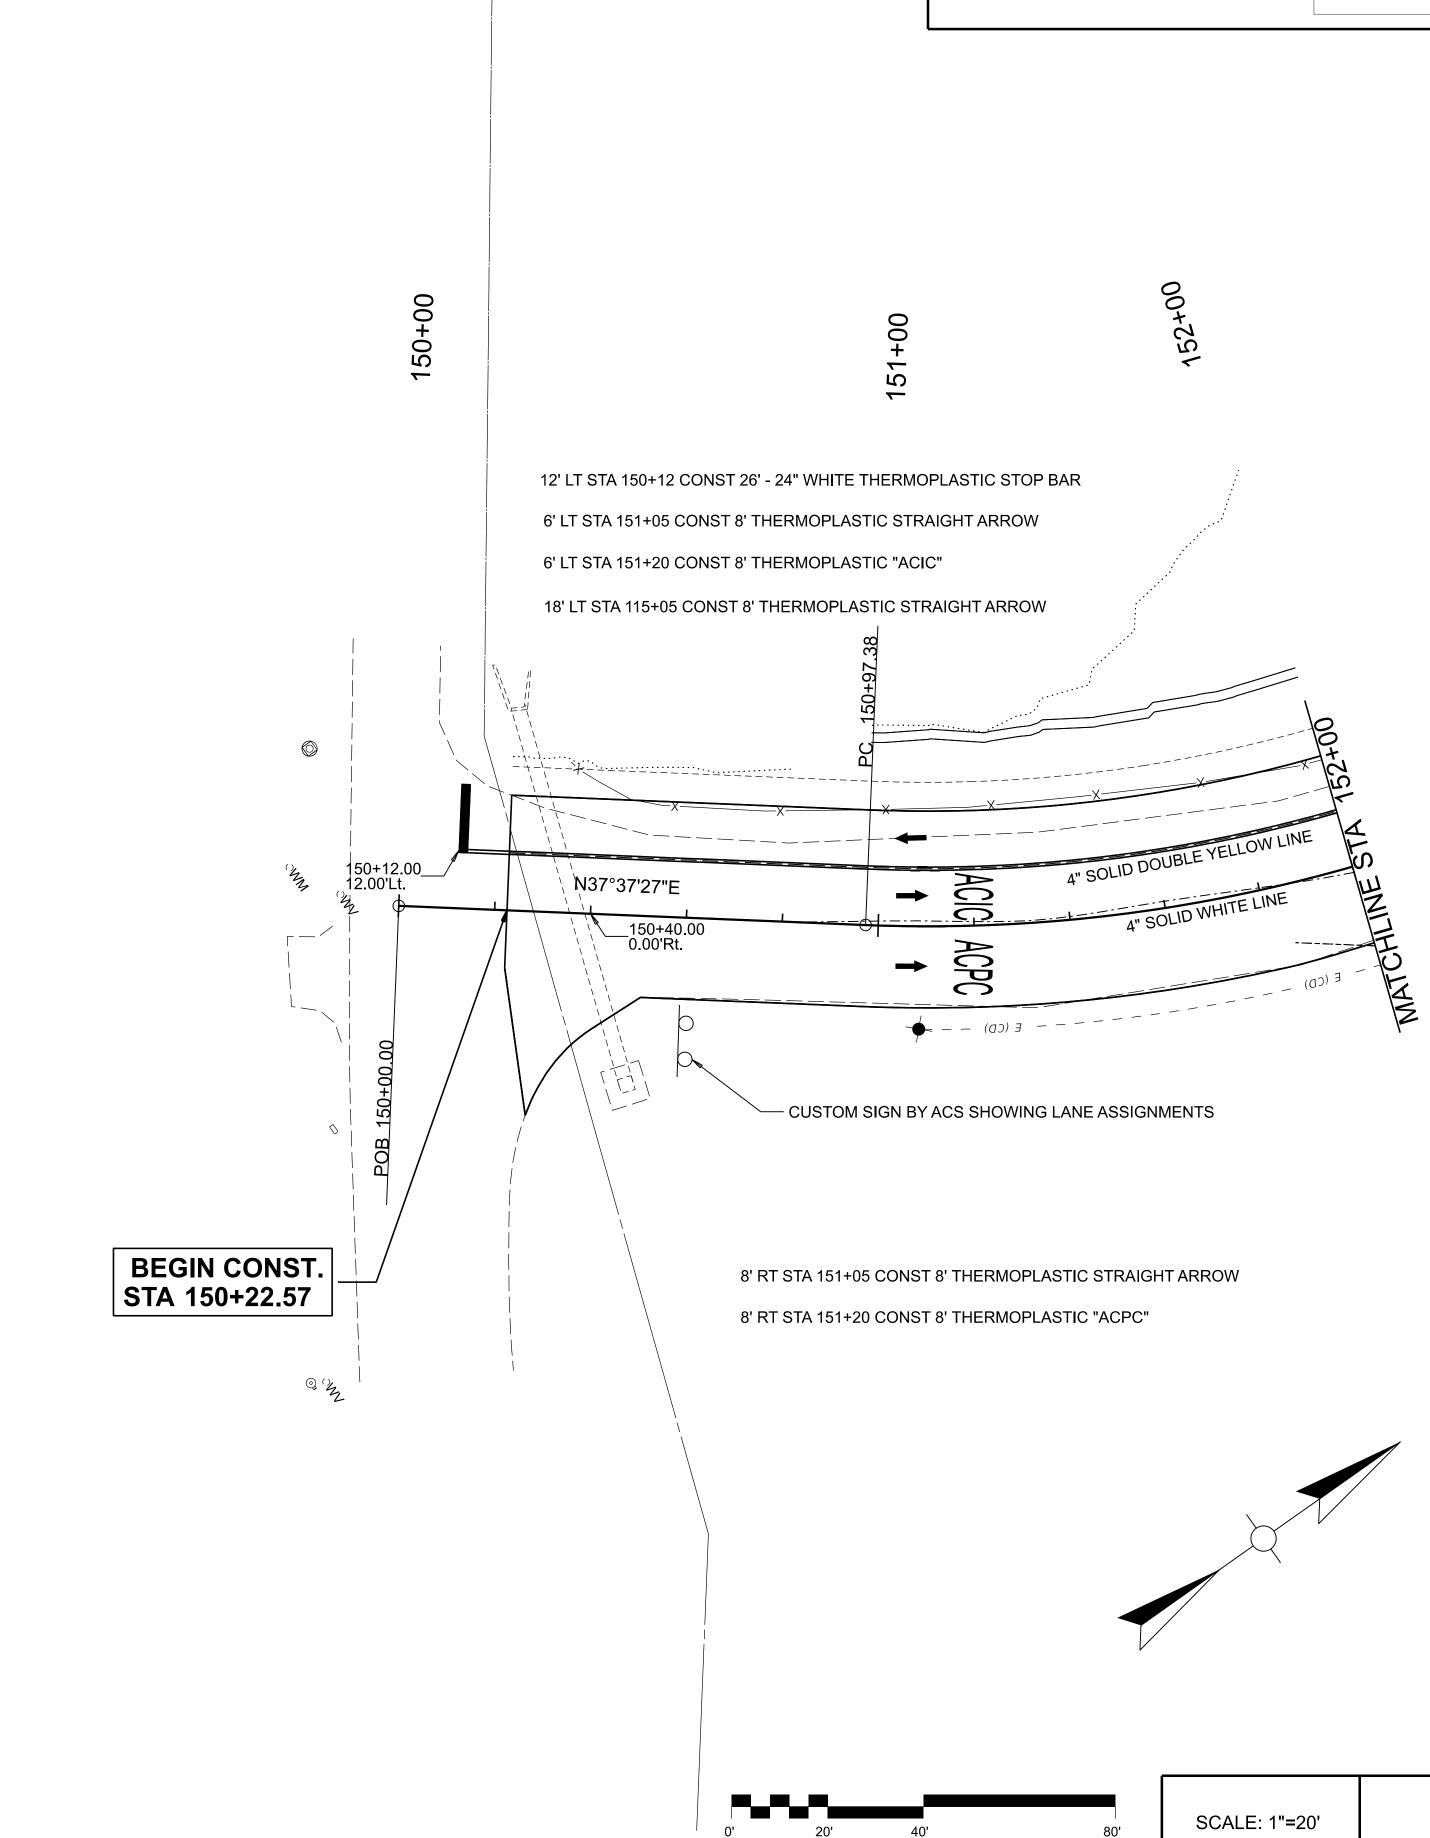





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ALLEN COUNTY SCHOOLS				

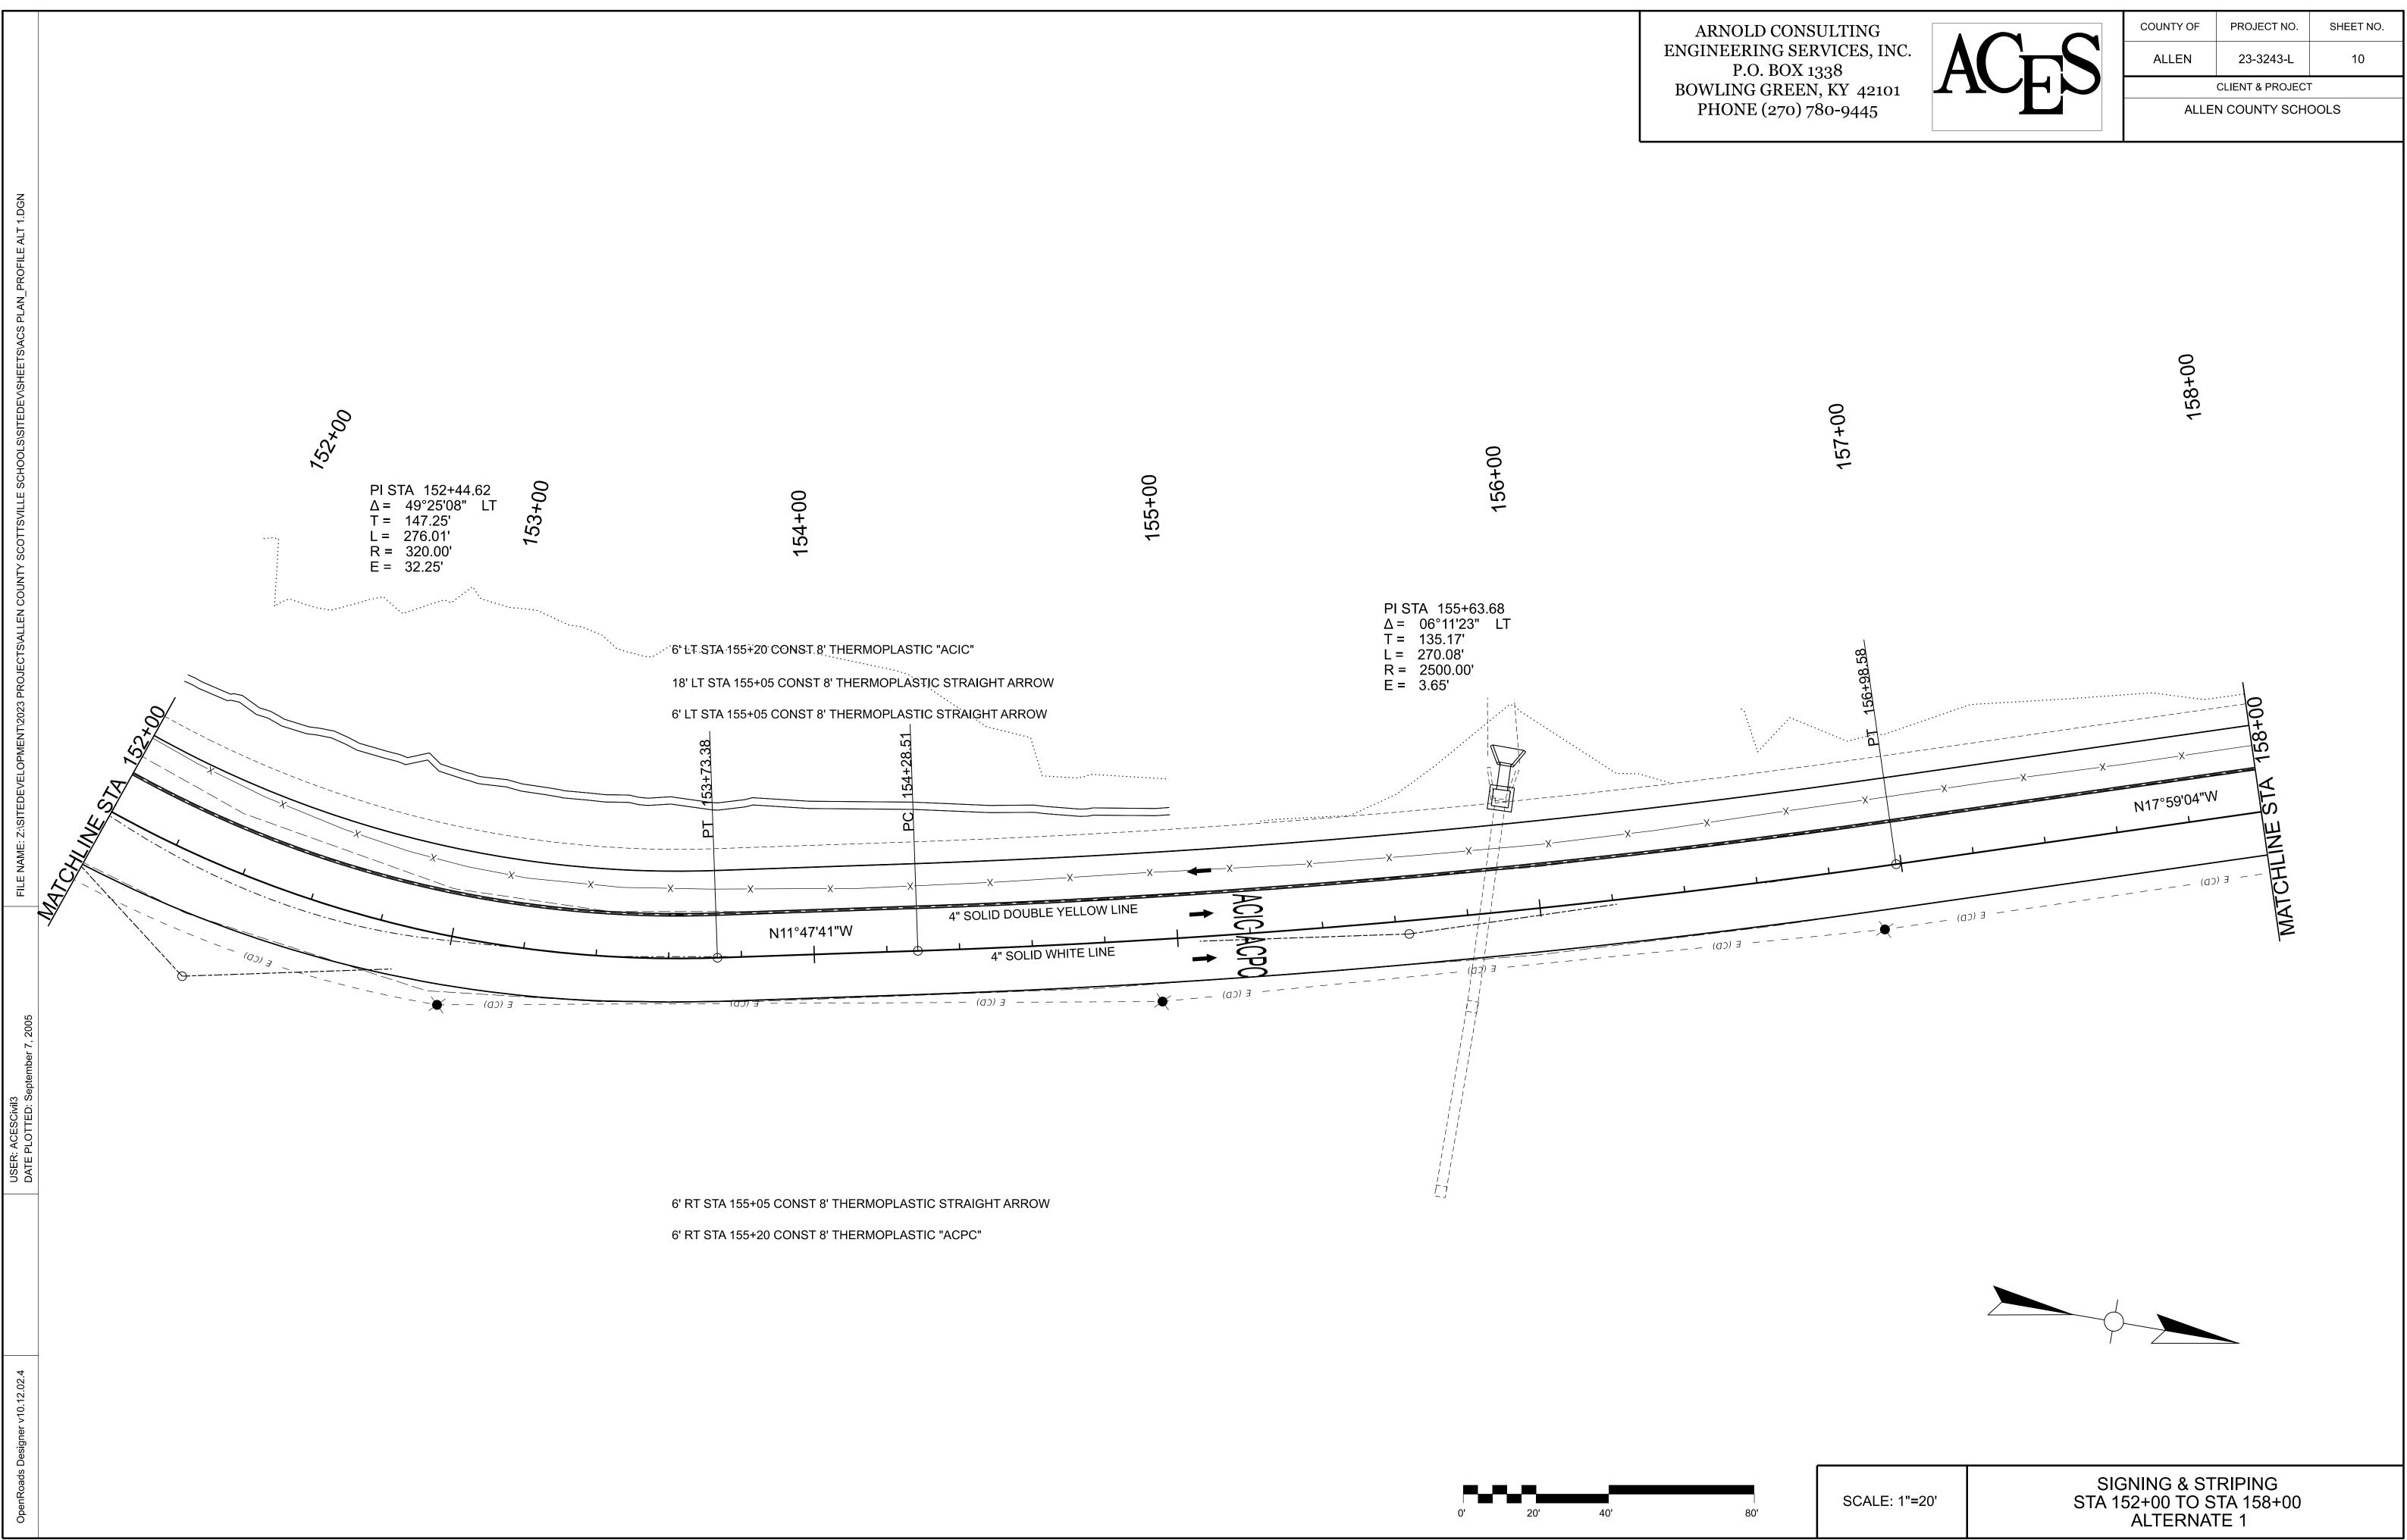


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18' LT STA 167+05 CONST 8' THERMOPLASTIC STRAIGHT ARROW

6' LT STA 167+05 CONST 8' THERMOPLASTIC STRAIGHT ARROW

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6' RT STA 167+05 CONST 8' THERMOPLASTIC STRAIGHT ARROW

6' RT STA 167+20 CONST 8' THERMOPLASTIC "ACPC"

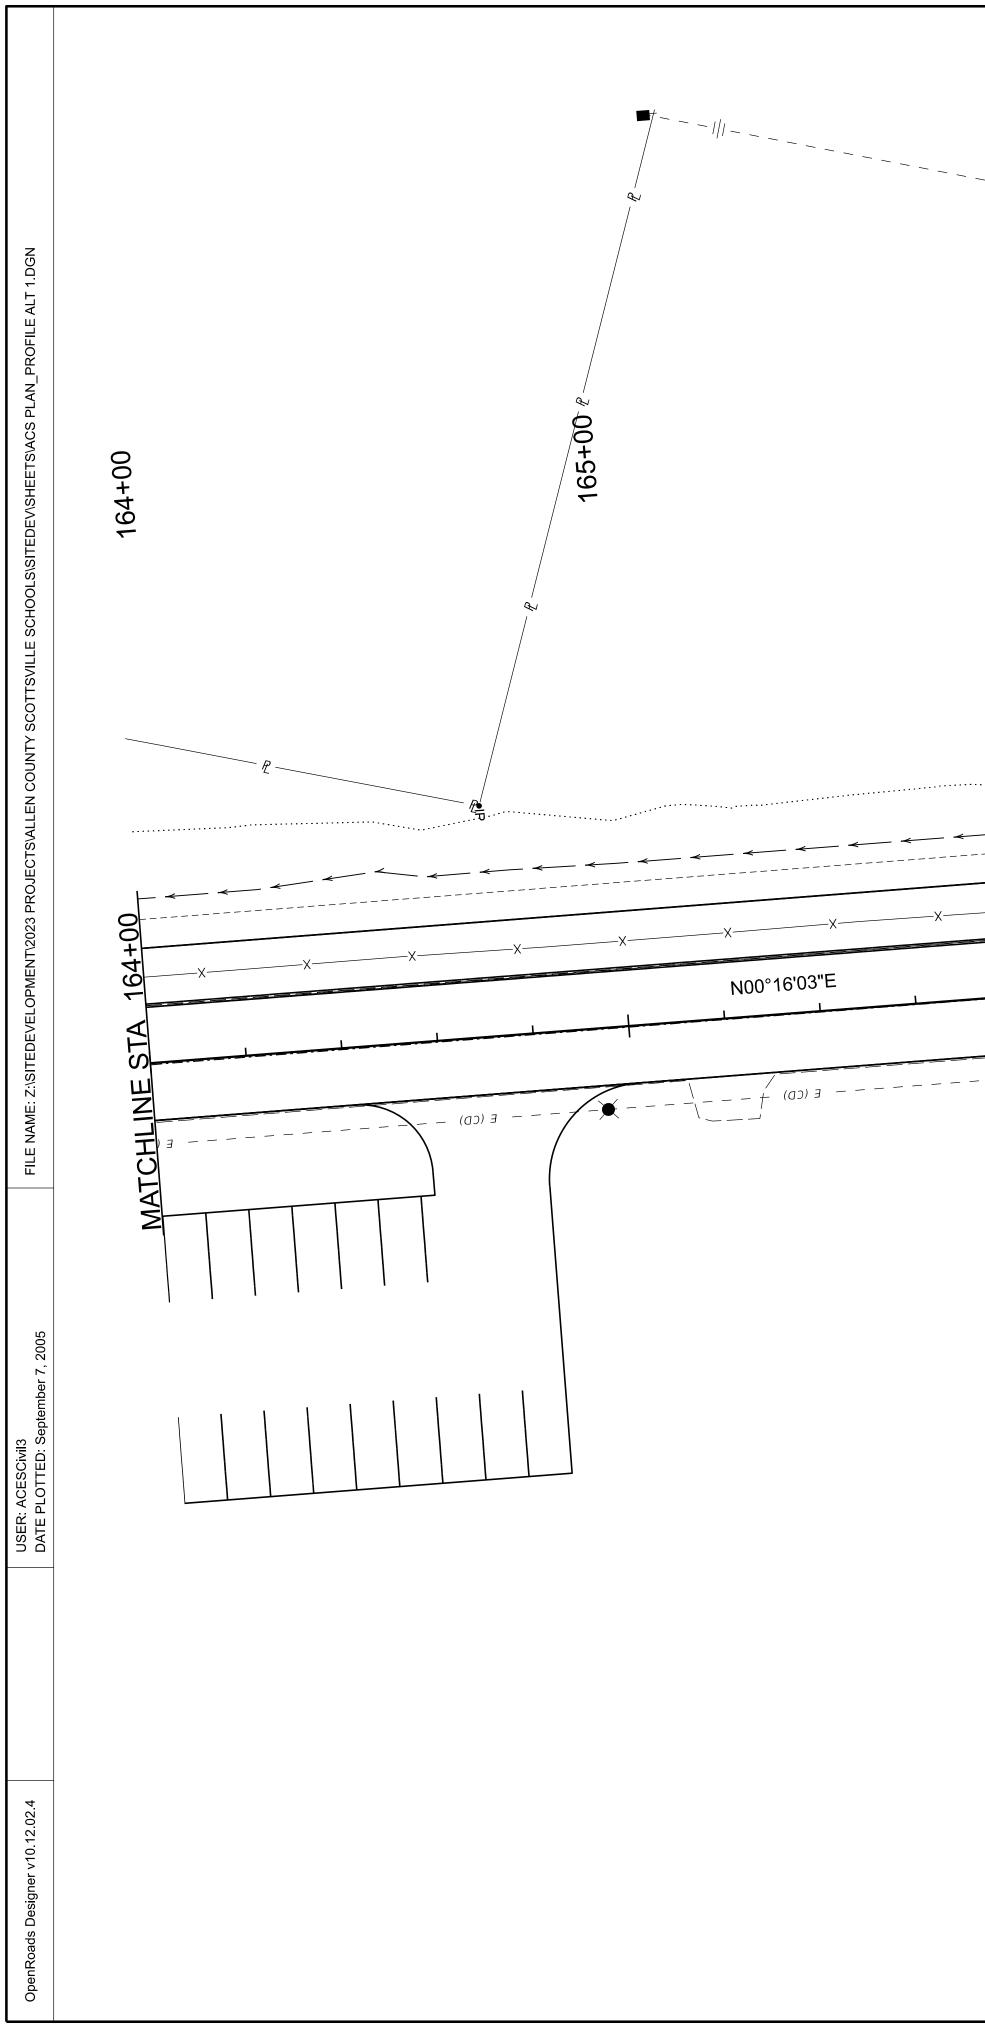0' 20' 40'

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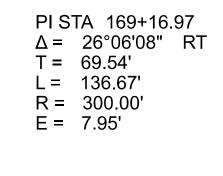
ARNOLD CONSULTING ENGINEERING SERVICES, INC. P.O. BOX 1338 BOWLING GREEN, KY 42101 PHONE (270) 780-9445




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COUNTY OF PROJECT NO. SHEET NO. ALLEN 23-3243-L 12 **CLIENT & PROJECT** ALLEN COUNTY SCHOOLS


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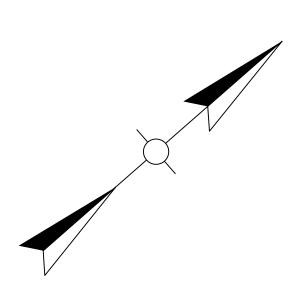
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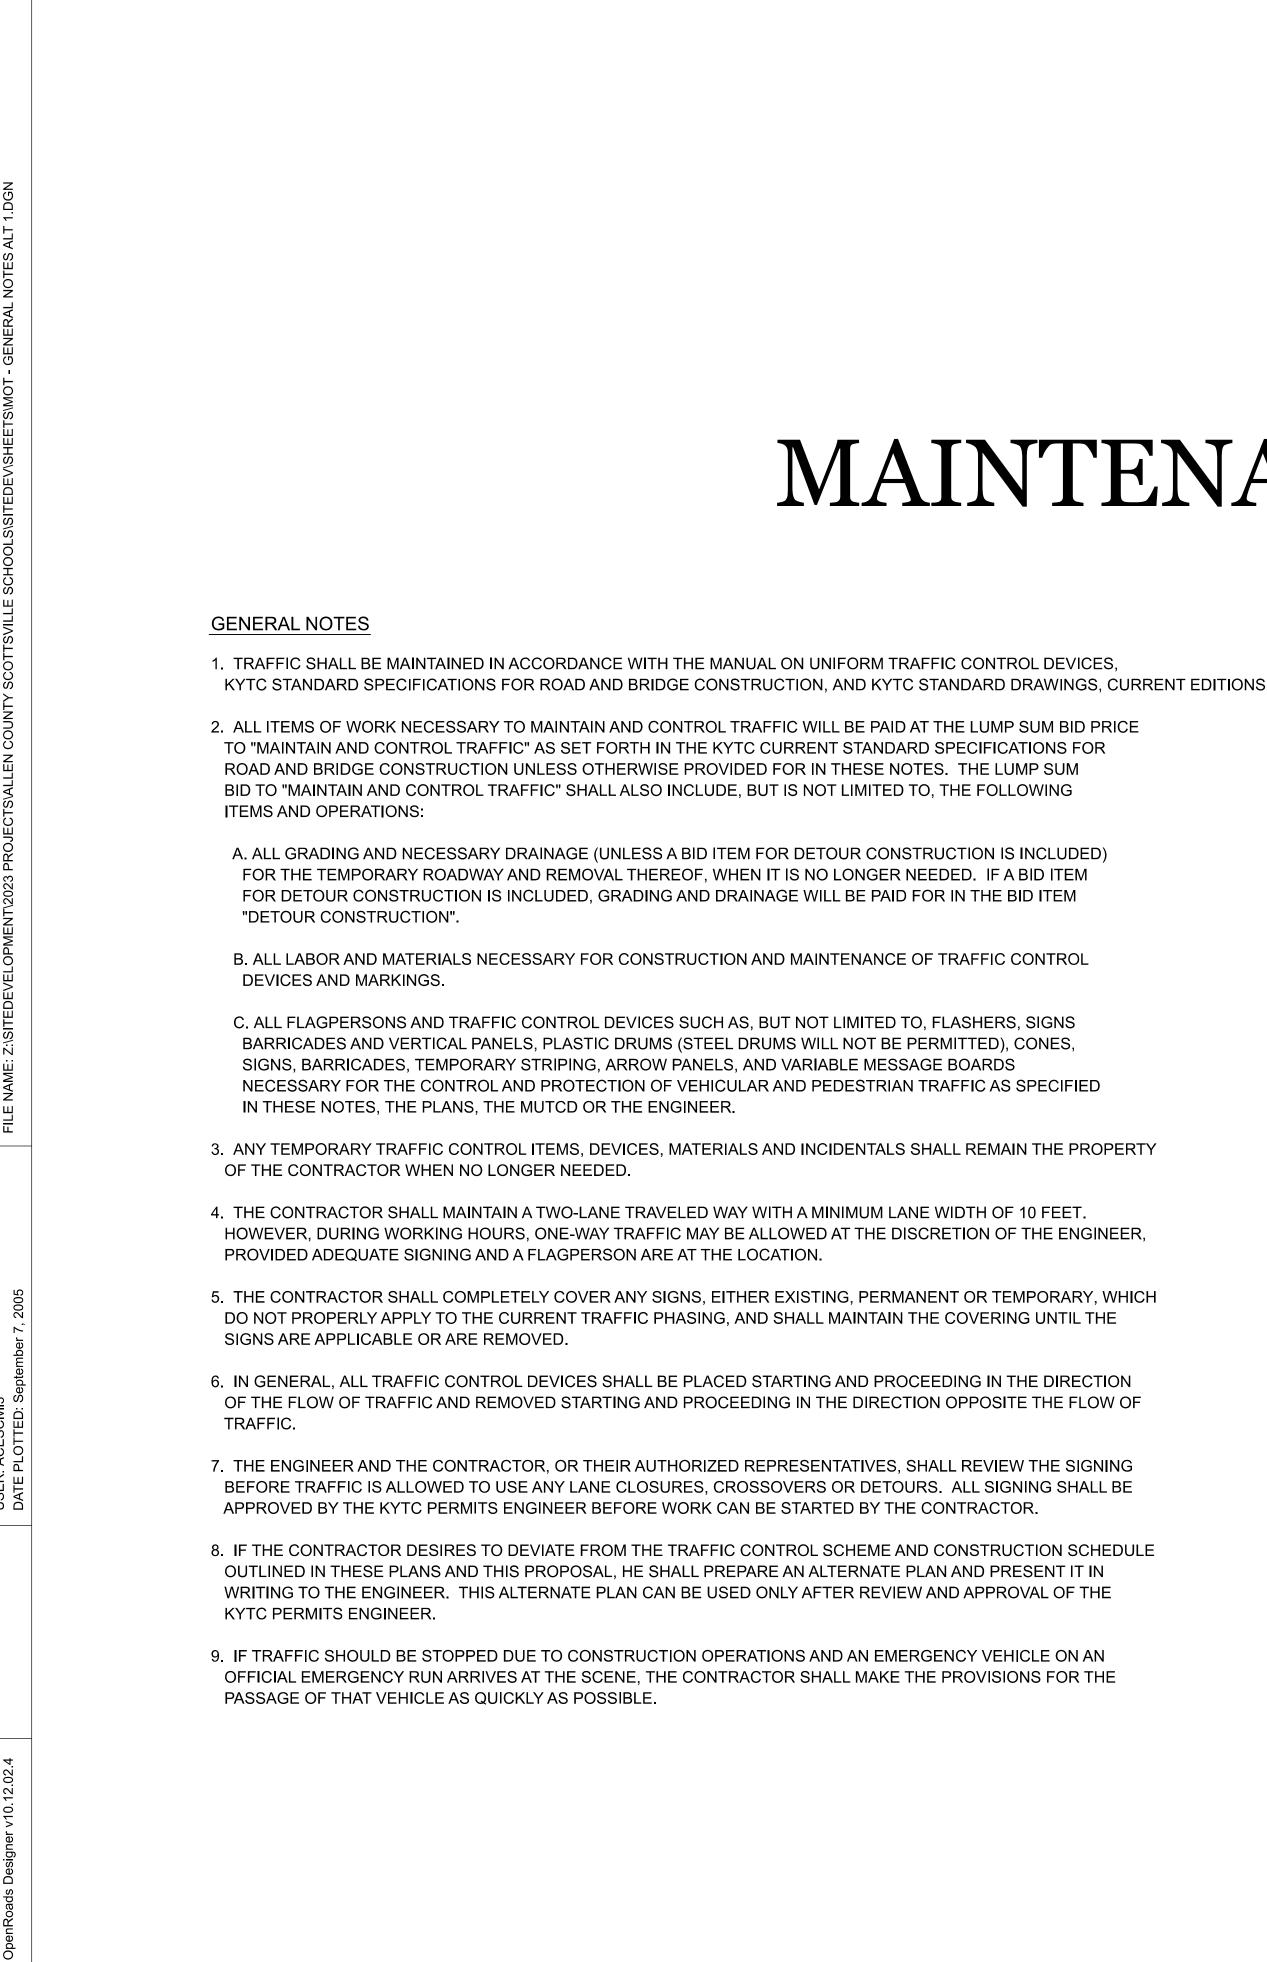
COUNTY OF	PROJECT NO.	SHEET NO.	
ALLEN	23-3243-L	13	
CLIENT & PROJECT			
ALLEN COUNTY SCHOOLS			





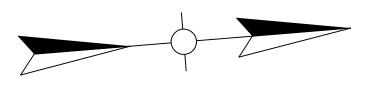

SCALE: 1"=20'

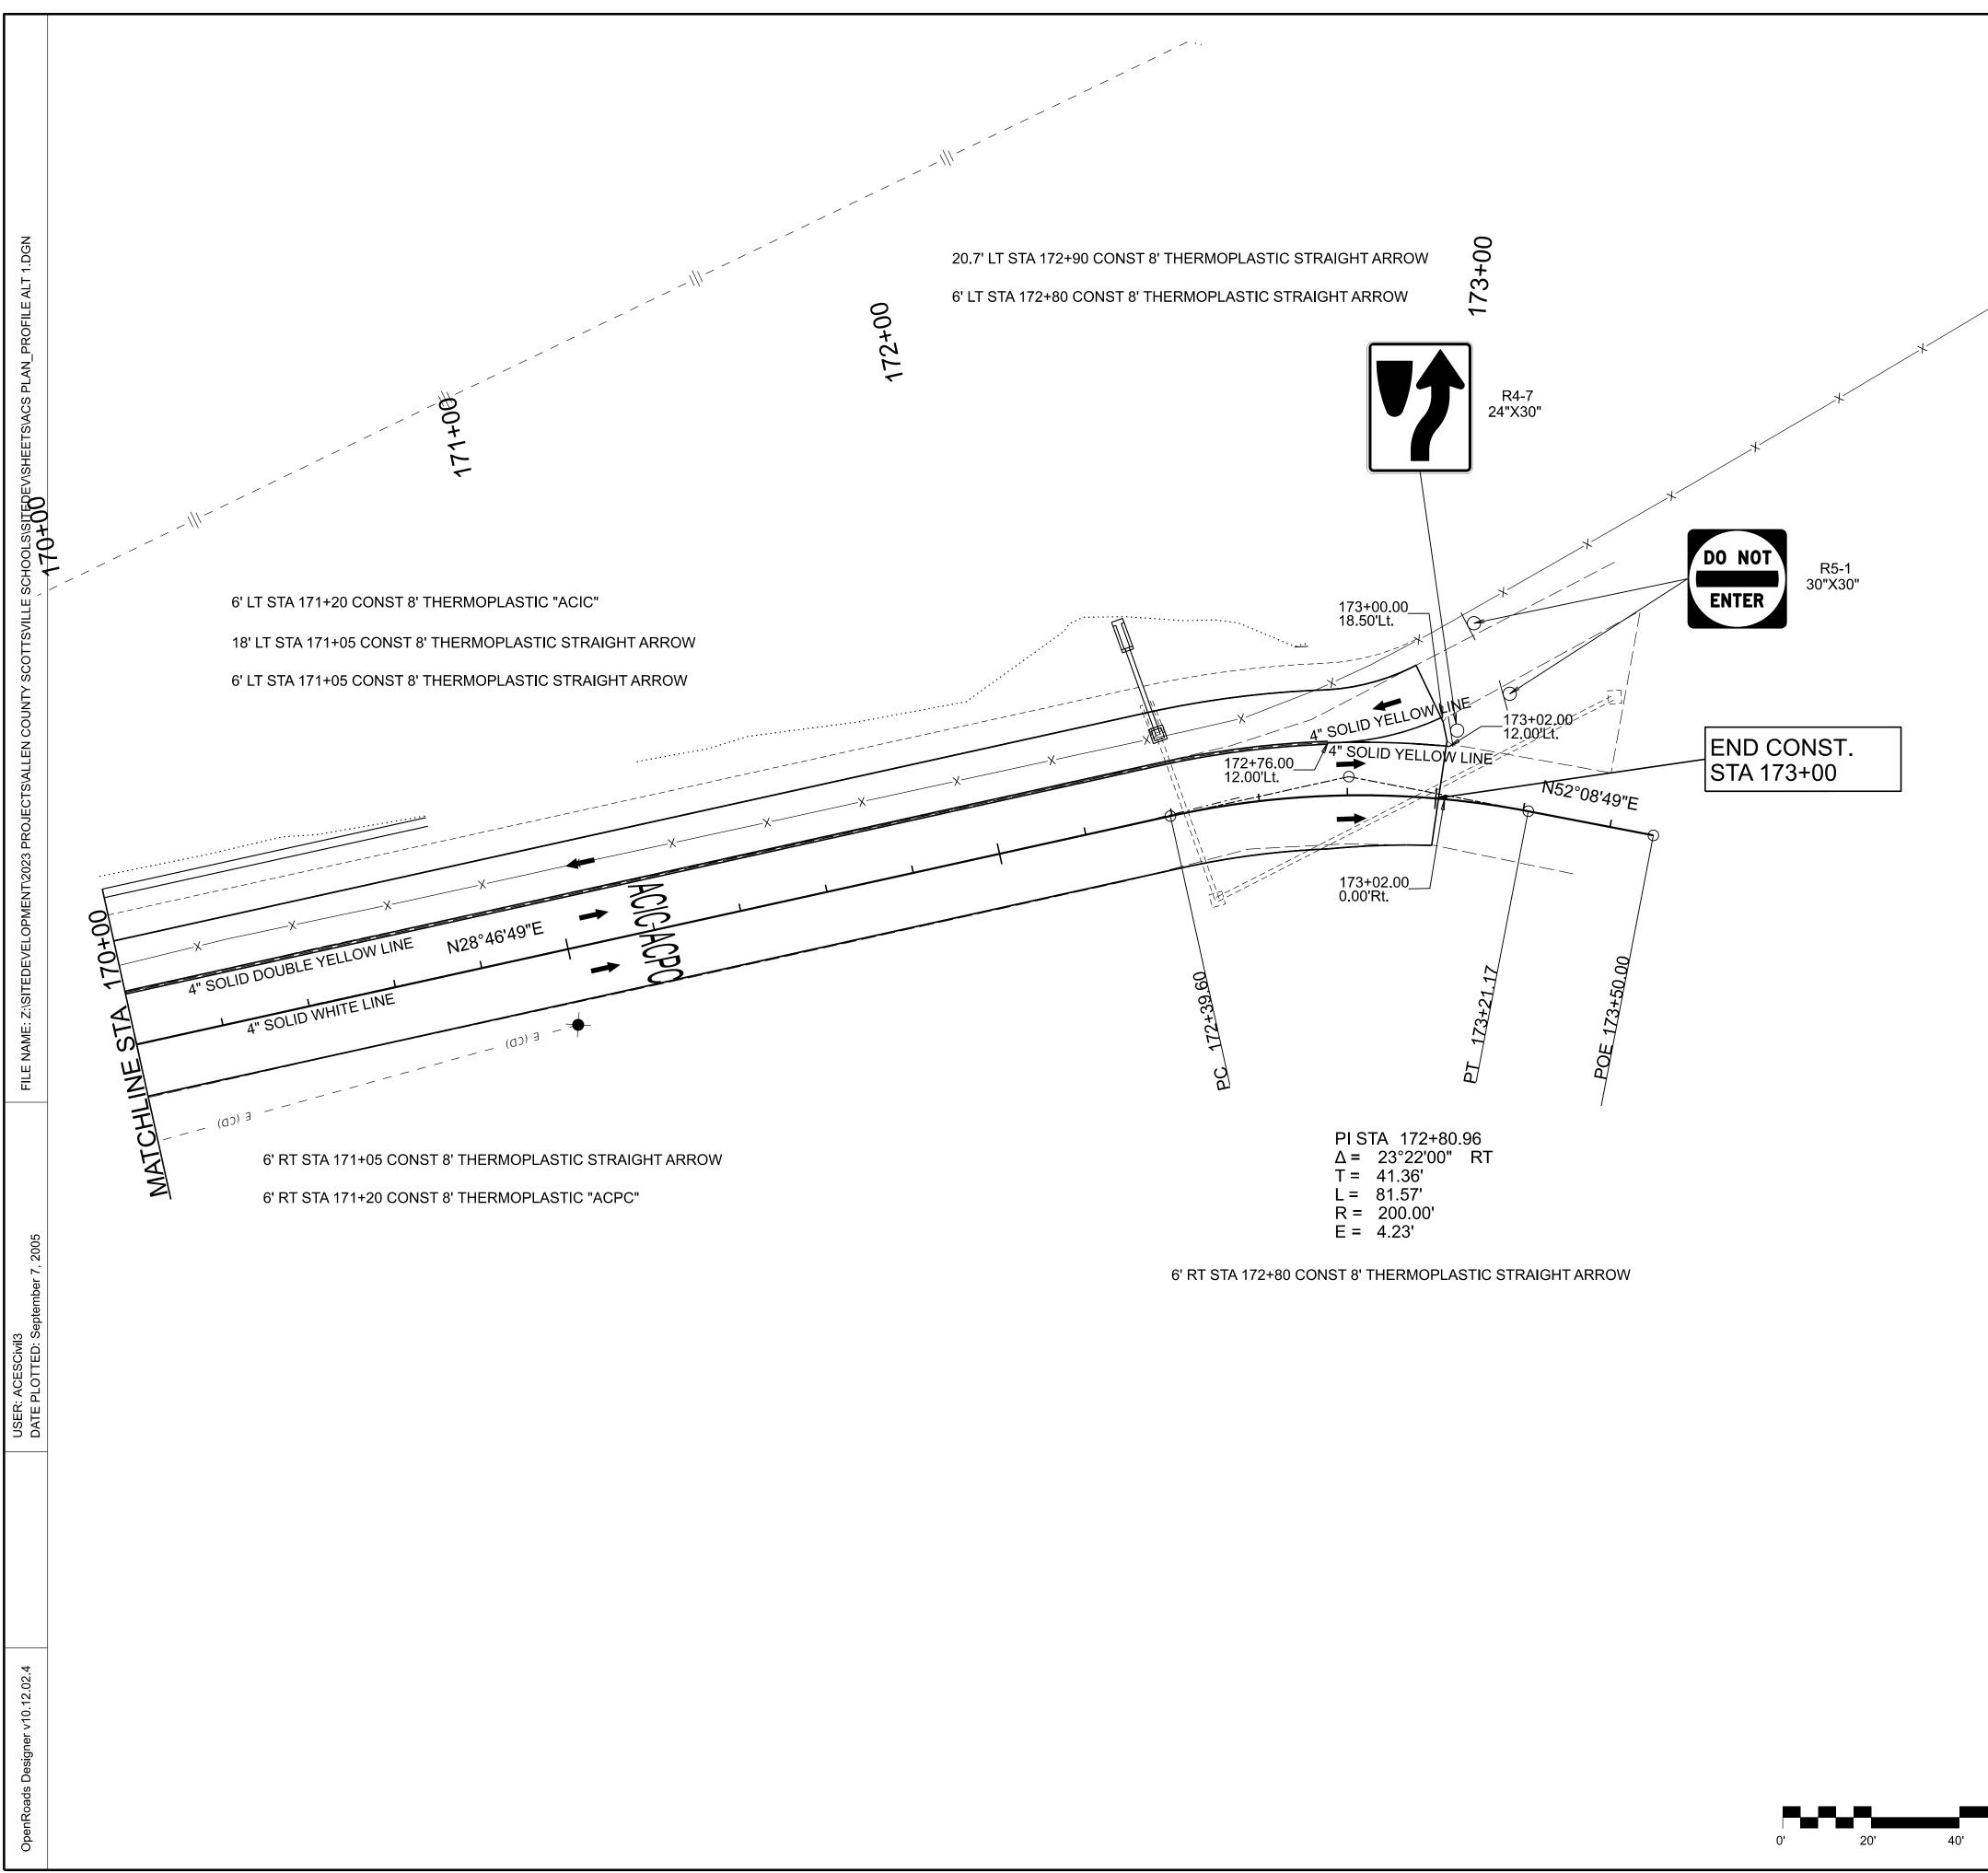

# MAINTENANCE OF TRAFFIC

#### PAVEMENT DROP-OFF

A PAVEMENT EDGE THAT TRAFFIC IS NOT EXPECTED TO CROSS, EXCEPT ACCIDENTALLY, SHOULD BE TREATED AS FOLLOWS:

- UNIFORM TRAFFIC CONTROL DEVICES, CURRENT EDITION.
- FOR OVERNIGHT INSTALLATIONS.

FOR TEMPORARY CONDITIONS. DROP-OFFS GREATER THAN FOUR INCHES MAY BE PROTECTED WITH PLASTIC DRUMS, VERTICAL PANELS OR BARRICADES FOR SHORT DISTANCES DURING DAYLIGHT HOURS WHILE WORK IS BEING DONE IN THE DROP-OFF AREA.

LESSER TREATMENTS THAN THOSE DESCRIBED ABOVE MAY BE CONSIDERED FOR LOW-VOLUME LOCAL STREETS.

PAYMENT WILL BE ALLOWED FOR DGA MATERIAL USED FOR WEDGING.

### TRAFFIC COORDINATOR

FURNISH A TRAFFIC COORDINATOR AS PER SECTION 112 IN THE CURRENT KENTUCKY STANDARD SPECIFICATIONS. THE TRAFFIC COORDINATOR SHALL INSPECT THE PROJECT MAINTENANCE OF TRAFFIC, AT LEAST THREE TIMES DAILY, OR AS DIRECTED BY THE ENGINEER, DURING THE CONTRACTOR'S OPERATIONS AND AT ANY TIME A LANE CLOSURE IS IN PLACE. THE PERSONNEL SHALL HAVE ACCESS ON THE PROJECT TO A RADIO OR TELEPHONE TO BE USED IN CASE OF EMERGENCIES OR ACCIDENTS. THE TRAFFIC COORDINATOR SHALL REPORT ALL INCIDENTS THROUGHOUT THE WORK ZONE TO THE ENGINEER ON THE PROJECT. THE CONTRACTOR SHALL FURNISH THE NAME AND TELEPHONE NUMBER WHERE THE TRAFFIC COORDINATOR CAN BE CONTACTED AT ALL TIMES.

PHASING

PHASE 1

CLOSE ACS ENTRANCE ROAD BY ERECTING TYPE III BARRICADES ACROSS ALL TRAVELED LANES AT STATIONS 150+10 AND 173+05.

ARNOLD CONSULTING ENGINEERING SERVICES, INC. P.O. BOX 1338 BOWLING GREEN, KY 42101 PHONE (270) 780-9445



COUNTY OF	PROJECT NO.	SHEET NO.	
ALLEN	23-3243-L	14	
CLIENT & PROJECT			
ALLEN COUNTY SCHOOLS			


\* LESS THAN TWO INCHES - NO PROTECTION REQUIRED. WARNING SIGNS SHOULD BE PLACED IN ADVANCE AND THROUGHOUT THE DROP-OFF AREA.

\* TWO TO FOUR INCHES - PLASTIC DRUMS, VERTICAL PANELS OR BARRICADES EVERY 100 FEET ON TANGENT SECTIONS FOR SPEEDS OF 50 MPH OR GREATER. CONES MAY BE USED IN PLACE OF PLASTIC DRUMS, PANELS AND BARRICADES DURING DAYLIGHT HOURS. FOR TANGENT SECTIONS WITH SPEEDS LESS THAN 50 MPH AND FOR CURVES, DEVICES SHOULD BE PLACED EVERY 50 FEET. SPACING OF DEVICES ON TAPERED SECTIONS SHOULD BE IN ACCORDANCE WITH THE MANUAL ON

\* GREATER THAN FOUR INCHES - POSITIVE SEPARATION OR WEDGE WITH 3:1 OR FLATTER SLOPE NEEDED. IF THERE IS FIVE FEET OR MORE DISTANCE BETWEEN THE EDGE OF THE PAVEMENT AND THE DROP-OFF, THEN DRUMS, PANELS, OR BARRICADES MAY BE USED. IF THE DROP-OFF IS GREATER THAN 12 INCHES. POSITIVE SEPARATION IS STRONGLY ENCOURAGED. IF CONCRETE BARRIERS ARE USED, SPECIAL REFLECTIVE DEVICES OR STEADY BURN LIGHTS SHOULD BE USED


SCALE: 1"= N/A
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#### MAINTENANCE OF TRAFFIC GENERAL NOTES AND PHASING ALTERNATE 1



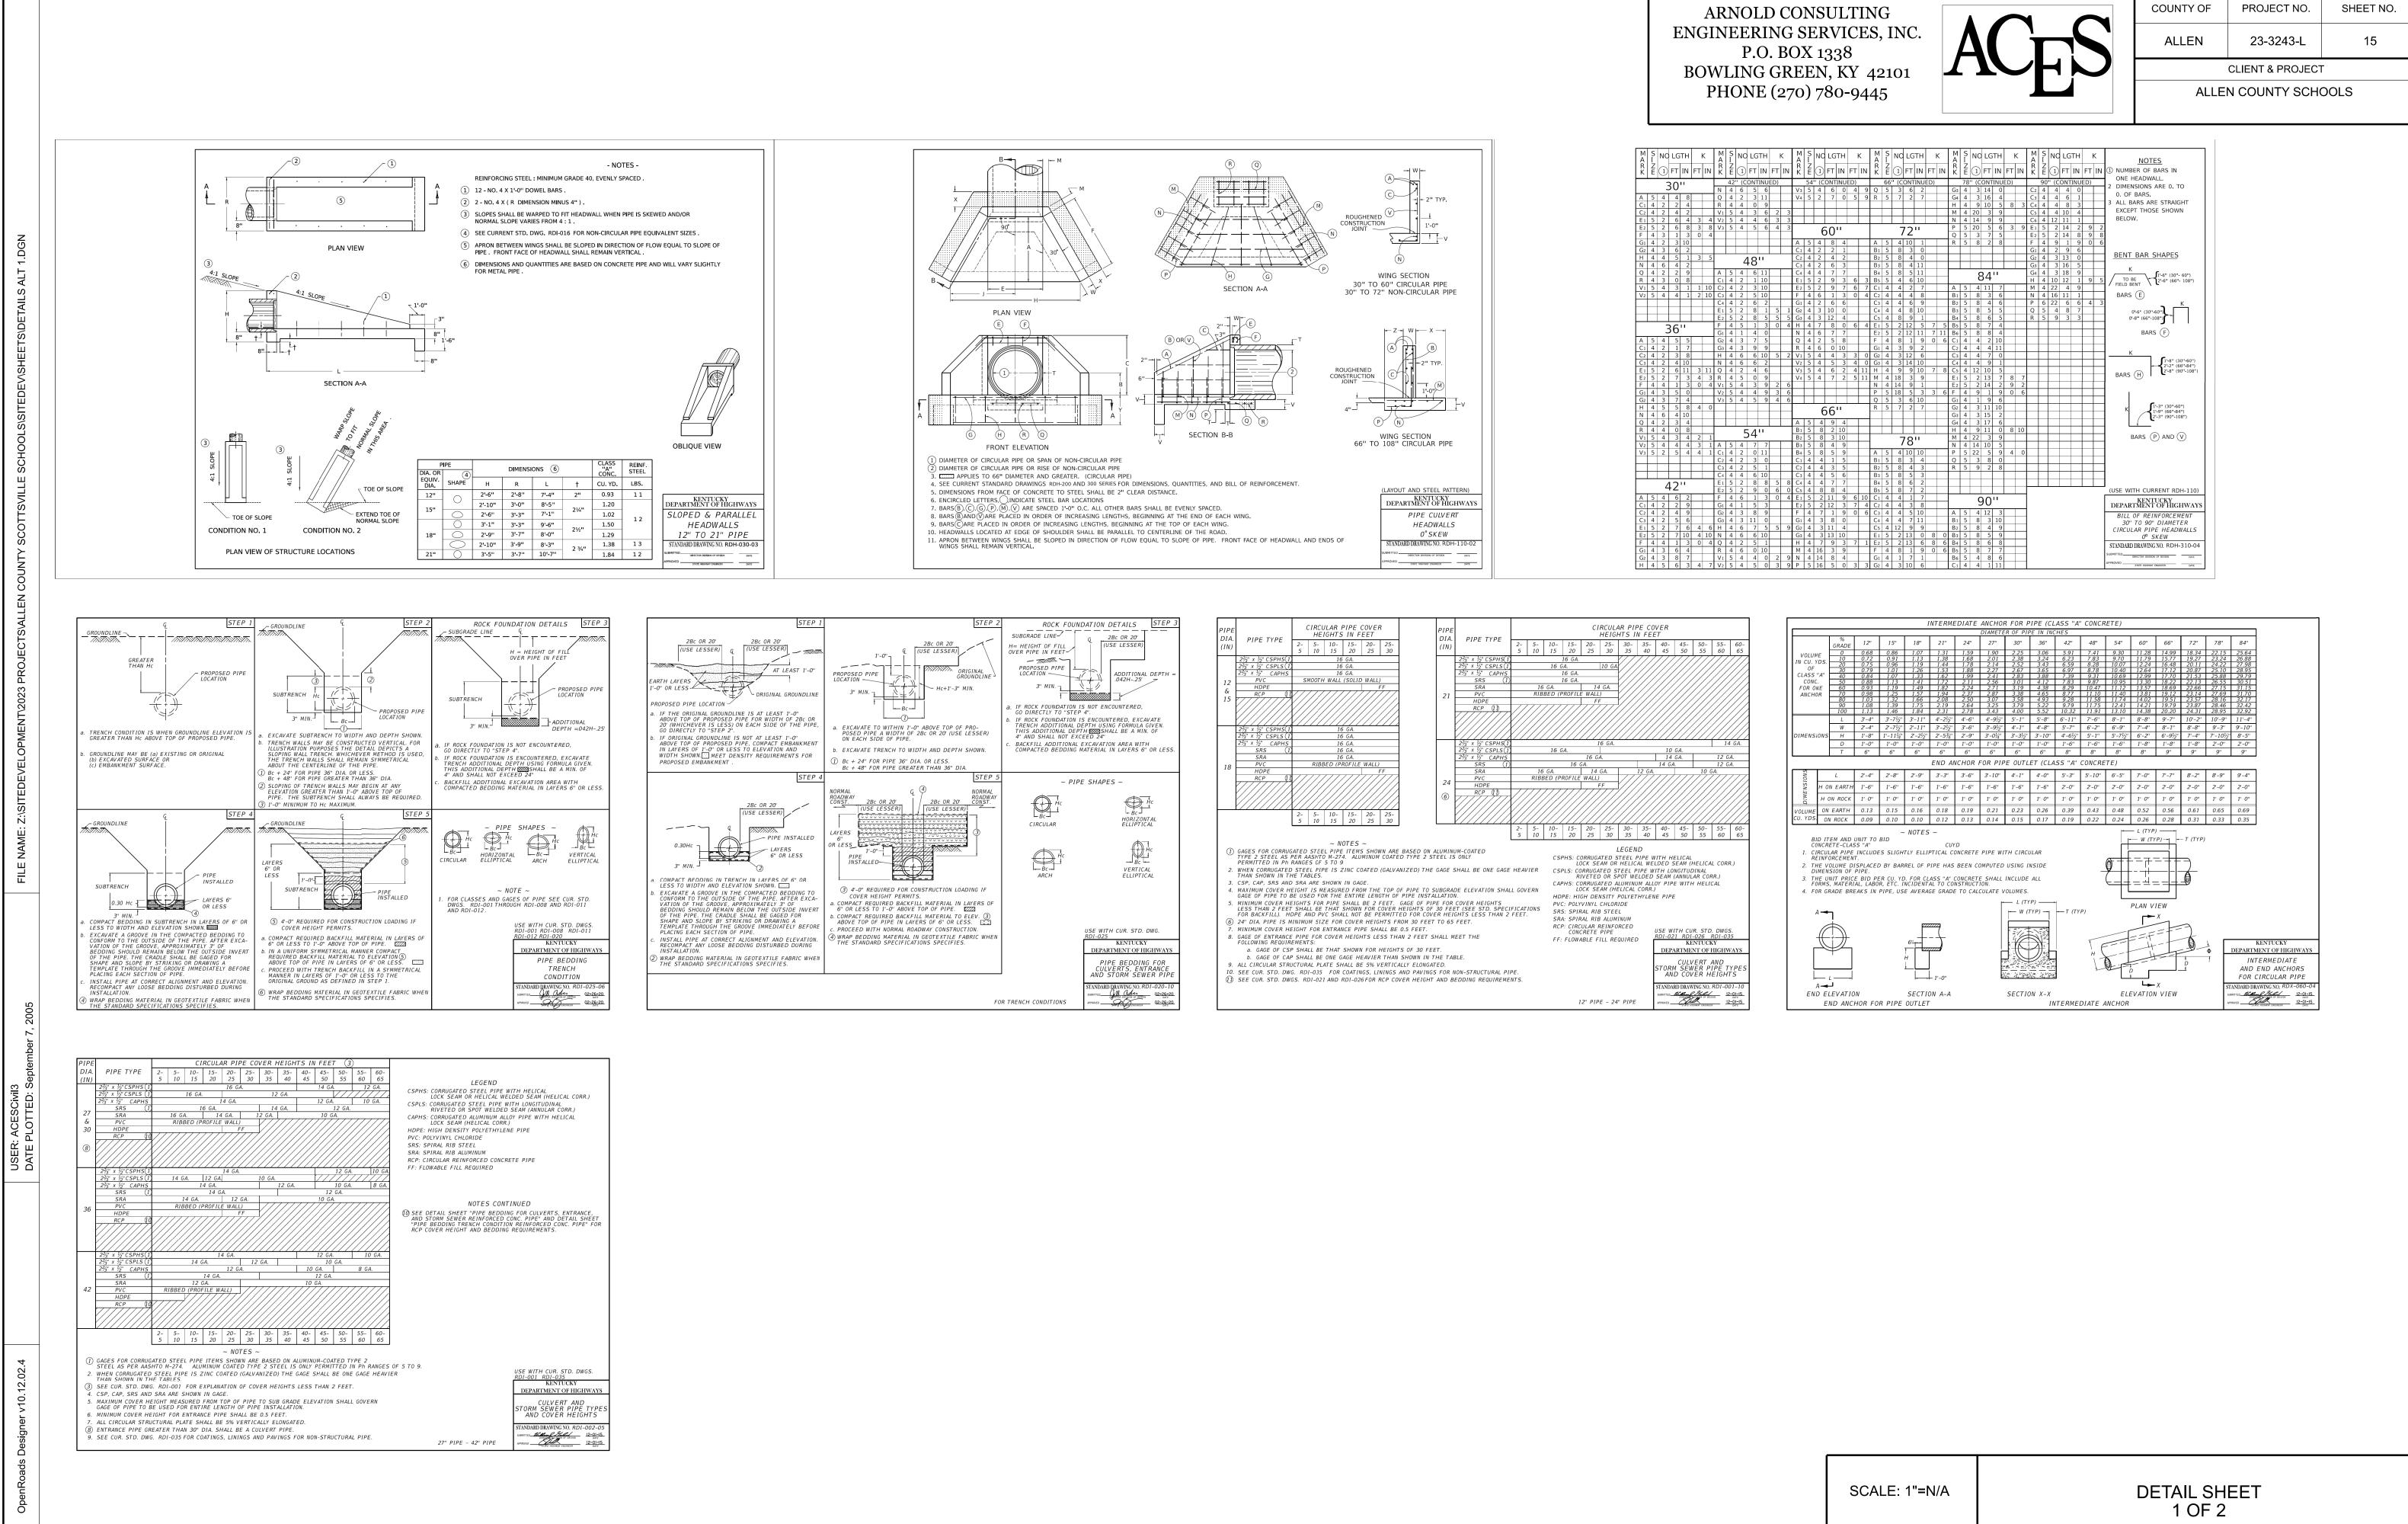

PROJECT NO.	SHEET NO.						
23-3243-L	15						
CLIENT & PROJECT							
ALLEN COUNTY SCHOOLS							
	23-3243-L CLIENT & PROJECT						



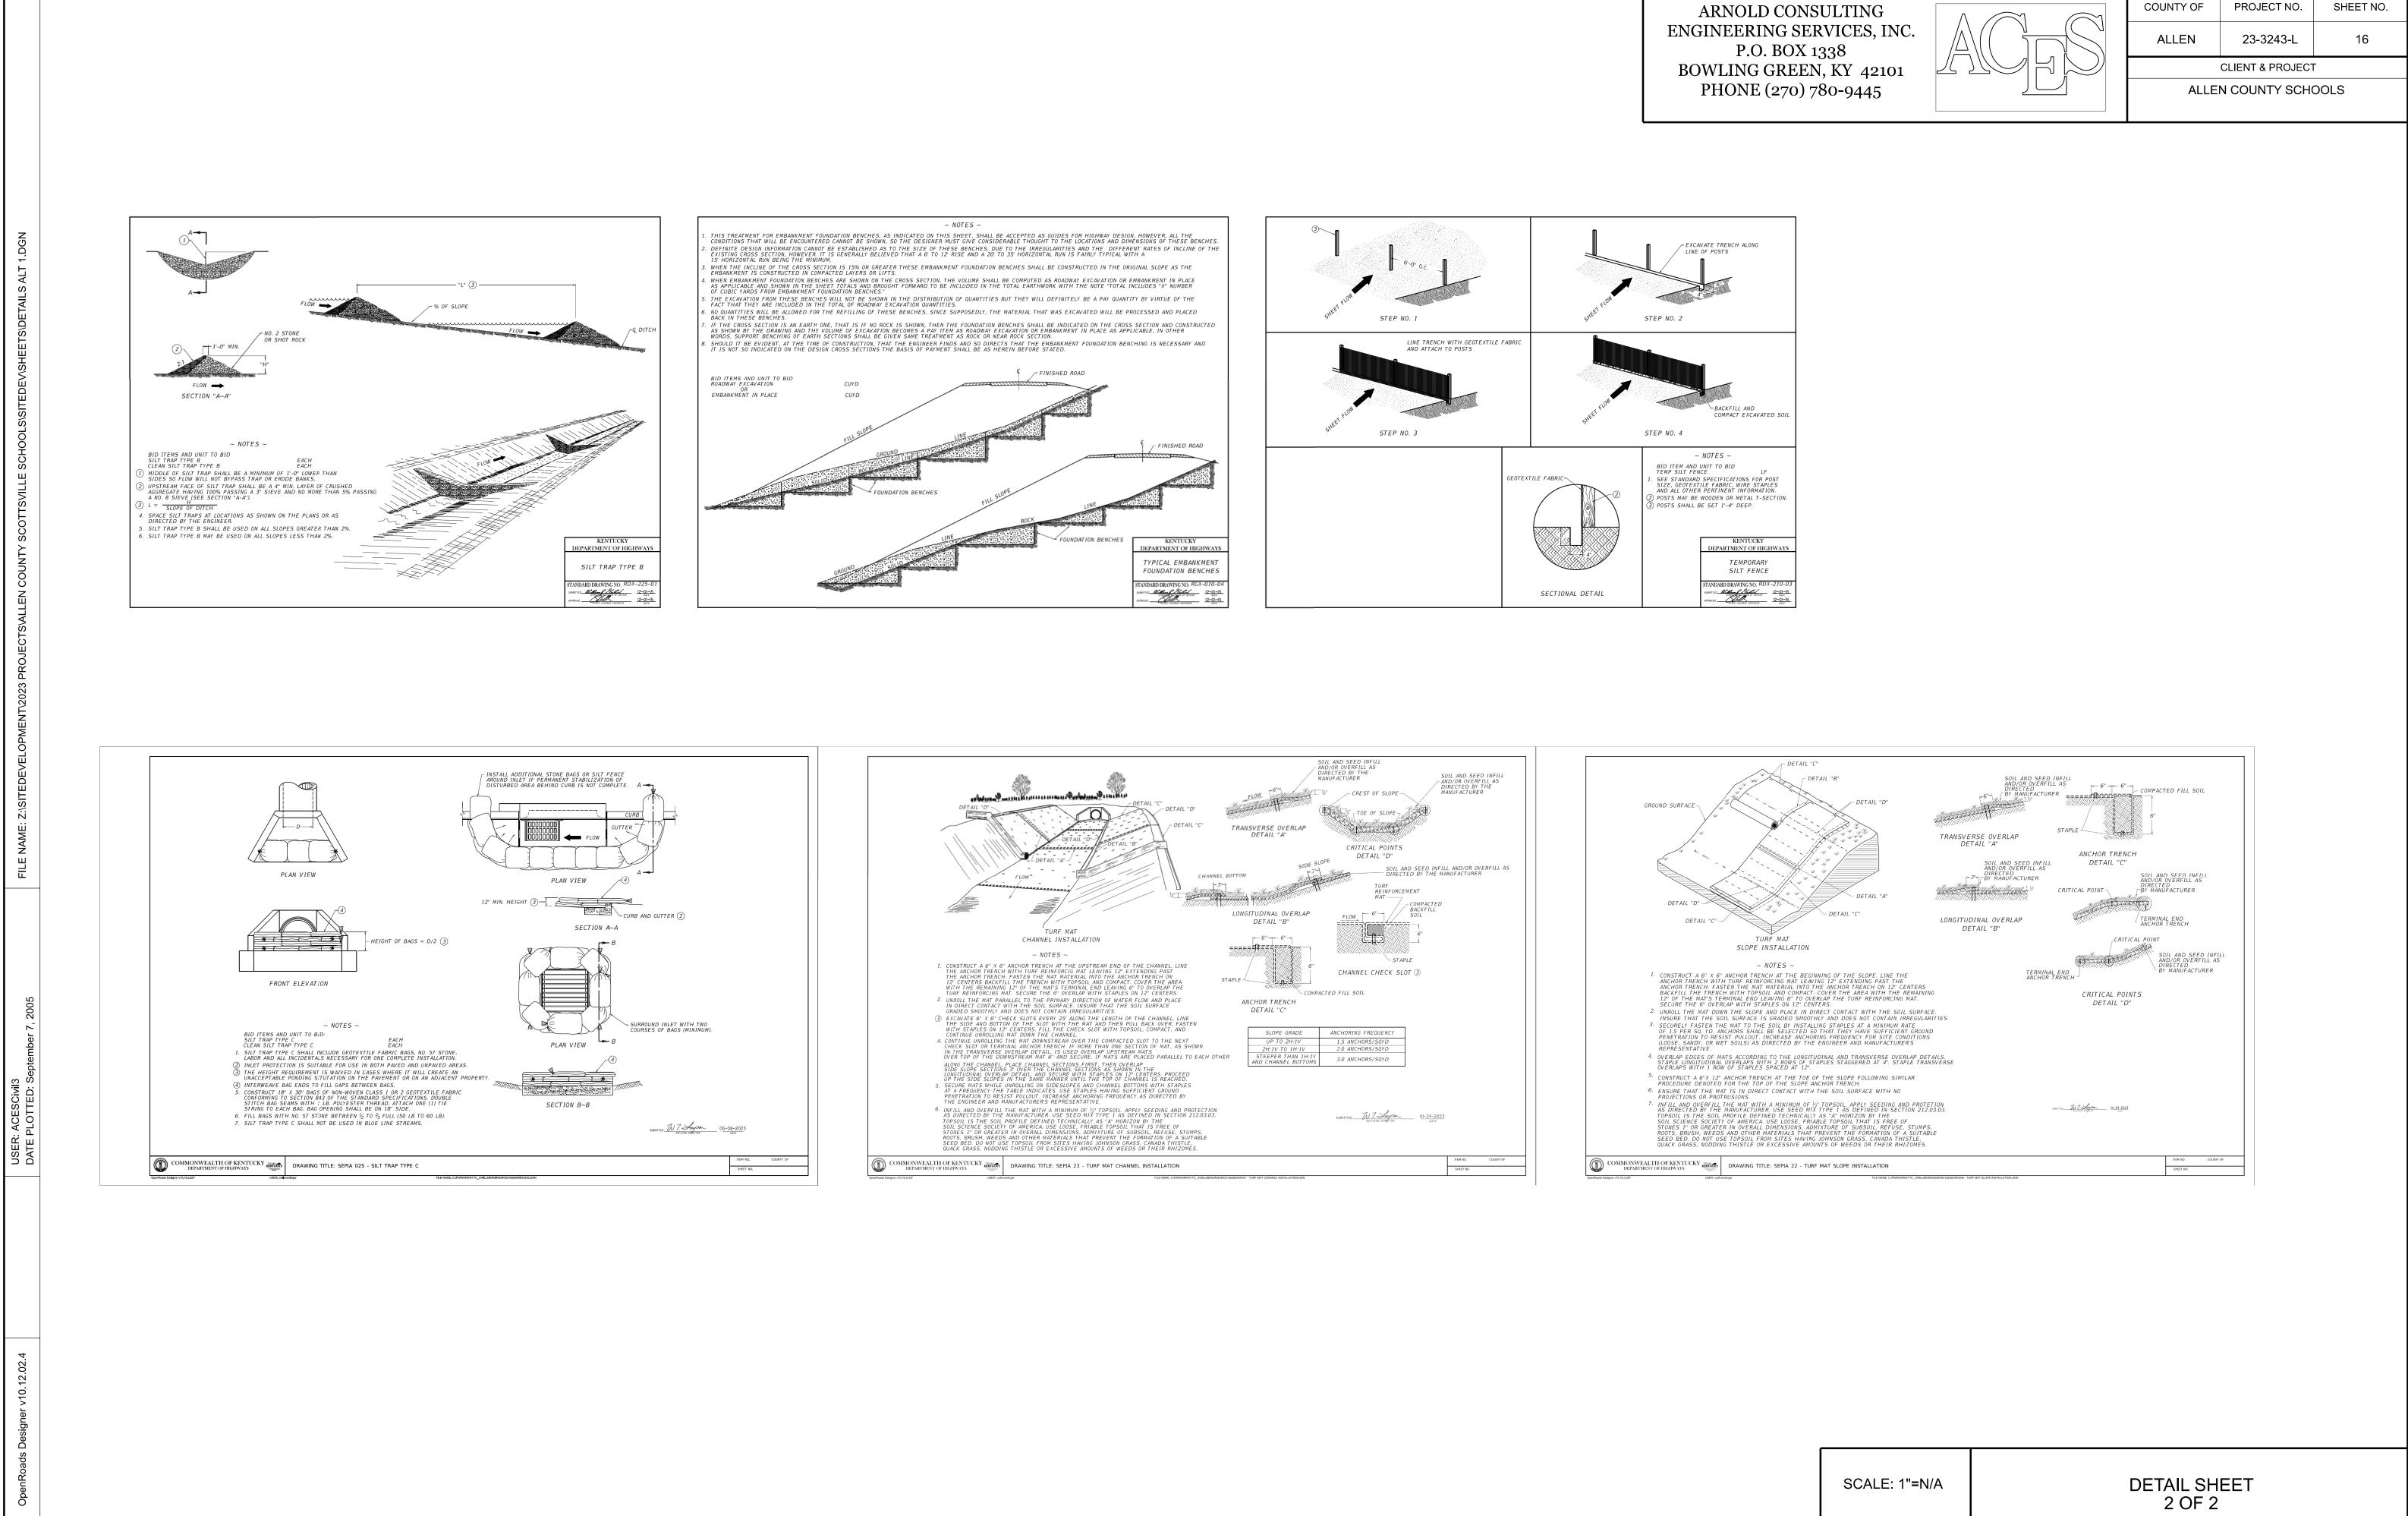

COUNTY OF	PROJECT NO.	SHEET NO.				
ALLEN	23-3243-L	16				
CLIENT & PROJECT						
ALLEN COUNTY SCHOOLS						

	EROSION CONTRO	)1.
1.DGN	SEED AND SOD NOTES	R HA
SHEET ALT	NOTED ON THE PLAN TO BE SEEDED SHALL BE SPREAD ALL AREAS TO E AND HAND RAKED. THE TOPSOIL LAYER SHALL BRING ALL TURF AREAS SURFACE AREA SHALL BE ROLLED TO REMOVE FOREIGN MATERIALS SU STICKS, REMOVED DURING CULTIVATION AND RAKING OPERATIONS.	BE DIS TO FI
ROL-NOTE	2. INSTALLATION OF SEED SHALL BE BETWEEN MARCH 1 TO OCTOBER 1 SEEDING IS DONE IN BETWEEN OCTOBER MARCH 1, A SEED BLEND WILL OF 20% ANNUAL RYE	
FILE NAME: Z:\SITEDEVELOPMENT\2023 PROJECTS\ALLEN COUNTY SCOTTSVILLE SCHOOLS\SITEDEV\SHEETS\EROSION CONTROL-NOTE SHEET ALT 1.DGN	3. GRASS SEED SHALL BE A TYPE WHICH WILL THRIVE IN THIS PROJECT SEED MIXTURE TO OWNER FOR APPROVAL. FERTILIZER SHALL BE 10-10 USE APPROXIMATELY 5 LBS. OF GRASS SEED, 10 LBS. OF FERTILIZER FO OF GROUND AREA TO BE SEEDED. COVER ALL SEEDED AREAS WITH 3 B FOR EACH 1000 SQ.FT. WATER DAILY FOR 15 DAYS OR AS REQUIRED BY AFTER SEED HAS GERMINATED, ALL THIN SPOTS SHALL BE RE-SEEDED.	-10 T OR EA ALES WEA
DEV\SHEE"	4. THE LANDSCAPE CONTRACTOR SHALL BE RESPONSIBLE FOR WATER MAINTENANCE TO SEEDED AREAS UNTIL THE PROJECT IS ACCEPTED BY OF 90% COVERAGE OF SOUND, HEALTHY GRASS SHALL BE REQUIRED F	Y THE
CHOOLS\SITE	5. EMBANKMENTS/SLOPES GREATER THAN 3:1 SHALL BE EITHER BE SEE AN EROSION CONTROL MAT (JUTE MESH ENKAMAT) OR INSTALLED WITH STABILIZATION. SOD TO BE STAKED WITH EITHER WOOD STAKES OR U-S FLUSH WITH GRADE.	I SOD
ILLE S(	6. SOD SHALL BE REGIONALLY GROWN AND OF A SPECIES THAT WILL TH	
CTTSV	7. HYDROSEED ALL NEW LAWN AREAS AS SPECIFIED UNLESS PLANS CA 8. MIX SEED, FERTILIZER AND PULVERIZED MULCH WITH WATER USING	
NTY SC	DESIGNED FOR HYDROSEED APPLICATION.	
EN COU	9. APPLY SLURRY UNIFORMLY TO ALL AREAS BEING SEEDED. RATE OF A TO OBTAIN SPECIFIED SEED SOWING RATE.	
JECTS/ALLE	10. THE SOD SHALL BE RELATIVELY FREE OF DISEASES AND WEEDS. ST ANY DIMENSION, PLANT ROOTS AND OTHER MATERIAL DETRIMENTAL TO SHOULD BE REMOVED. DELIVERED SOD THAT HAS BECOME DRY, MOLD OR HAS IRREGULARLY SHAPED PIECES THAT ARE TORN OR HAVE UNEV 11. THE SOD BED WILL BE LOOSENED TO A DEPTH OF 3" TO A SMOOTH, GRADED TO SUCH AN ELEVATION SO THE SOD, WHEN IN PLACE, SHALL SEEDED TURFED AREA, PAVEMENT, CURB OR OTHER STRUCTURES EXC 12. LAY SOD WITHIN 24 HOURS OF STRIPPING. DO NOT LAY DORMANT SO LAY SOD TO FORM A SOLID MASS WITH TIGHTLY FITTED JOINTS. DO NOT	) a he Y or
'\2023 PRO	11. THE SOD BED WILL BE LOOSENED TO A DEPTH OF 3" TO A SMOOTH, GRADED TO SUCH AN ELEVATION SO THE SOD, WHEN IN PLACE, SHALL SEEDED TURFED AREA, PAVEMENT, CURB OR OTHER STRUCTURES EXC	BE FL
DPMEN	12. LAY SOD WITHIN 24 HOURS OF STRIPPING. DO NOT LAY DORMANT SO LAY SOD TO FORM A SOLID MASS WITH TIGHTLY FITTED JOINTS. DO NO	
DEVELO	13. WATER SOD WITH FINE SPRAY IMMEDIATELY AFTER PLANTING. DURI DAILY OR MORE FREQUENTLY AS NECESSARY TO MAINTAIN MOIST SOIL	
ME: Z:\SITE	14. PRIOR TO PLACING THE SOD, FERTILIZER 10-10-10 TYPE 1 GRADE A SOD SECTIONS SHALL BE HARROWED, RAKED OR OTHERWISE INCORPO BED, WHEN DRY, SHALL BE MOISTENED TO THE LOOSENED DEPTH.	
FILE NA	15. SOD SHALL BE WETTED THOROUGHLY, ROLLED AND TAMPED SUFFIC ROOTS INTO THE SOD BED AND TO ENSURE TIGHT JOINTS BETWEEN TH	
	16. ALL SODDED AREAS SHALL BE MAINTAINED, WATERED AND REPAIRE LANDSCAPE CONTRACTOR UNTIL FINAL ACCEPTANCE OF THE PROJECT	
	17. THE LANDSCAPE CONTRACTOR SHALL GUARANTEE ALL SEEDED OR OF ONE YEAR FROM THE DATE OF COMPLETION. LANDSCAPE CONTRAC ACTS OF NATURE THAT MAY CAUSE EROSION, NEGLECT BY THE OWNER OR MACHINES.	TOR
2005	GENERAL NOTES	
USER: ACESCivil3 DATE PLOTTED: September 7, 2005	1. ALL MEASURES INSTALLED FOR SEDIMENT CONTROL SHALL BE CHEC END OF EACH DAY WHEN CONSTRUCTION IS OCCURRING TO ASCERTAIN IN PLACE AND FUNCTIONING PROPERLY. ANY DAMAGE OBSERVED WILL OF THAT WORKING DAY. MEASURES SHALL BE MAINTAINED UNTIL THE L	N THA BE R
ACESCIA	OFFICIAL DETERMINES THAT THEY ARE NO LONGER NEEDED. 2. ALL EROSION AND SEDIMENT CONTROL PRACTICES WILL BE CONSTR	UCTE
USER: / DATE P	ACCORDING TO THE STANDARDS OF STATE AND FEDERAL LAWS. 3. A COPY OF THE APPROVED EPSC (EROSION PREVENTION SEDIMENT)	CONT
	MAINTAINED AT THE PROJECT SITE AT ALL TIMES. THIS COPY SHALL BE OF SCOTTSVILLE'S REPRESENTATIVES UPON REQUEST.	PRES
	4. PRIOR TO COMMENCING LAND-DISTURBING ACTIVITIES IN ANY AREA I PLAN, THE CONTRACTOR SHALL SUBMIT A SUPPLEMENTARY EPSC PLAN FOR APPROVAL.	ΙΤΟΊ
	5. ALL EPSC MEASURES ARE TO BE PLACED PRIOR TO OR AS THE FIRST THE CONTRACTOR IS RESPONSIBLE FOR ANY ADDITIONAL EROSION CO TO PREVENT EROSION AND SEDIMENTATION AS DETERMINED BY THE CI DURING DEWATERING OPERATIONS WATER MUST BE PUMPED THROUGH THE CITY OF SCOTTSVILLE MAY SUSPEND DEWATERING OPERATIONS IF	NTRO ITY S H AN J
jr v10.12.02.4	6. THE CONTRACTOR SHALL INSPECT ALL EROSION AND SEDIMENT CON A WEEK AND AT LEAST ONCE A DAY DURING RAINFALL EVENTS. THE CON ANY REPAIRS OR MAINTENANCE IMMEDIATELY IN ORDER TO ENSURE EF CONTROL. THE CONTRACTOR SHALL MAINTAIN A RECORD OF ALL INSPE ACTIVITIES AT THE PROJECT SITE. THIS RECORD SHALL BE MADE AVAIL CITY OF SCOTTSVILLE.	NTRA FEC CTIO
OpenRoads Designer v10.12.02.4	7. ALL AREAS DISTURBED SHALL BE STABILIZED ACCORDINGLY. WHEN T GRADE IT MUST BE STABILIZED WITHIN 14 DAYS. DISTURBED AREAS NO STABILIZED WITHIN 21 DAYS.	

# L NOTES

- HARD THE AREA DISKED, LEVELED, FINISH GRADE. H AS ROCKS, LIMBS,
- IF ANY PARTIAL BE USED CONSISTING
- UBMIT PROPOSED 0 TYPE 1 GRADE A. 8 EACH 1000 SQ.FT. ES OF WHEAT STRAW /EATHER CONDITIONS.
- G, MOWING AND OTHER THE OWNER. A MINIMUM R ACCEPTANCE.
- ED AND COVERED WITH SOD FOR PROPER APED METAL PINS
- IVE IN THE PROJECT AREA.
- FOR SOD.
- QUIPMENT SPECIFICALLY
- PLICATION AS REQUIRED
- NES LARGER THAN 1 1/2" IN A HEALTHY STAND OF TURF OR YELLOW FROM HEATING, N ENDS SHALL BE REJECTED.
- /EN SURFACE AND SHALL BE E FLUSH WITH ANY ADJACENT PT WHEN OTHERWISE NOTED.
- D OR IF GROUND IS FROZEN. OVERLAP.
- G FIRST WEEK, WATER O DEPTH OF 4 INCHES.
- HALL BE APPLIED UNIFORMLY. RATED INTO THE SOIL. THE SOIL
- ENTLY TO INCORPORATE THE SECTIONS OR STRIPS.
- AS NECESSARY BY THE
- ODDED AREAS FOR A PERIOD OR IS NOT RESPONSIBLE FOR OR DAMAGED BY ANIMALS
- ED AT THE BEGINNING AND THAT THE MEASURES ARE E REPAIRED BY THE END CAL APPLICABLE CODE
- CTED AND MAINTAINED
- ONTROL) PLANS SHALL BE RESENTED TO THE CITY
- OT ON THE APPROVED EPSC TO THE CITY OF SCOTTSVILLE
- STEP IN CLEARING AND GRADING. TROL MEASURES NECESSARY Y SCOTTSVILLE. AN APPROVED FILTERING DEVICE. POLLUTION IS OBSERVED.
- ROL DEVICES AT LEAST ONCE TRACTOR SHALL PERFORM ECTIVE EROSION AND SEDIMENT TIONS AND MAINTENANCE BLE UPON REQUEST TO THE
- E SITE IS BROUGHT TO FINAL AT FINAL GRADE MUST BE

#### SEEDING RATES AND MIXTURES

#### 1. TEMPORARY SEEDING

WHEN ROUGH GRADE AREAS ARE TO BE LEFT UNDISTRIBUTED FOR 21 DAYS OR MORE, TEMPORARY SEEDING WILL BE REQUIRED. THE AREA SHOULD HAVE LIME AND FERTILIZER APPLIED AS NEEDED AND IT SHOULD BE WORKED INTO THE SOIL WITH A DISC OR HARROW TO A DEPTH OF 2 INCHES. SEED SHOULD BE APPLIED AND WORKED INTO THE SOIL TO A DEPTH OF <sup>57</sup>/<sub>64</sub>" TO <sup>59</sup>/<sub>64</sub>". THE CHART BELOW SHOWS THE RECOMMENDED SEEING RATES.

SEEDING RATES								
March 1 to Oct. 31	Per 1000 SF	Per Acre						
Oats	3 lbs	120 lbs						
Perennial Ryegrass	1 lbs	40 lbs						
Tall Fescue	1 lbs	40 lbs						
Wheat	1 lbs	40 lbs						
Annual Rye	3 lbs	120 lbs						
Nov. 1 to Feb. 28	Per 1000 SF	Per Acre						
Annual Rye	3 lbs	120 lbs						
Wheat	3 lbs	120 lbs						
Perennial Ryegrass	1 lbs	40 lbs						
Tall Fescue	3 lbs	120 lbs						

2. PERMANENT SEEDING

- ONCE FINAL GRADES HAVE BEEN ACHIEVED, PERMANENT SEEING SHALL TAKE PLACE AS SOON AS IS PRACTICAL AND SHOULD FOLLOW THE GUIDELINES BELOW.
- A. ANALYZE THE SOIL FOR LIME AND FERTILIZER REQUIREMENTS. APPLY AGRICULTURAL LIMESTONE AT A RATE OF 1 TON/ACRE AND 10-10-10 FERTILIZER AT A RATE OF
- 800 LBS/ACRES OR AS RECOMMENDED SOIL TESTING.B. WORK THE LIME AND FERTILIZER INTO THE SOIL TO A DEPTH OF 4 INCHES WITH A DISC OR SPRINGTOOTH HARROW.
- C. APPLY SEED BY EITHER BROADCAST, DRILLING OR HYDROSEEDING AT THE RATES IN THE TALE LISTED BELOW.

Suggested Seeding Rates

Recommended Seed Blends For Kentucky								
Seed Species and Mixtures	Seeding Rate/Acre	Per 1000 sq. ft.						
Seed and Seed Mixtures for Relative Flat or Slightly Sloping Areas								
Perennial Ryegrass	25 to 35 lbs.	1 lb.						
+ Tall Fescue	15 to 30 lbs.	1 lb.						
Tall Fescue	40 to 50 lbs.	1.5 lbs.						
+ Ladino or White Clover	1 to 2 lbs.	2 oz.						
Steep Slopes, Banks, Cuts, and Other Low M	laintenance Areas (not mov	wed)						
Smooth Bromegrass	25 to 35 lbs.	1 lb.						
+ Red Clover	10 to 20 lbs.	0.5 lb.						
Tall Fescue	40 to 50 lbs.	1 lbs.						
+ White or Ladino Clover	1 to 2 lbs.	2 oz.						
Orchardgrass	20 to 30 lbs.	1 lb.						
+ Red Clover	10 to 20 lbs.	0.5 lb.						
+ Ladino Clover	1 to 2 lbs.	2 oz.						
Crownvetch	10 to 12 lbs.	0.25 lb.						
+ Tall Fescue	20 to 30 lbs.	1 lb.						
Lawns and Other High Traffic or High	Maintenance Areas (mowed	d)						
Bluegrass	105 to 140 lbs.	3 lbs.						
Perennial Ryegrass (turf)	45 to 60 lbs.	2 lbs.						
+ Bluegrass	70 to 90 lbs.	2.5 lbs.						
Tall Fescue (Turf Type)	130 to 170 lbs.	4 lbs.						
+ Bluegrass	20 to 30 lbs.	1 lb.						
Ditches and Other Areas of Cone	centrated Water Flows							
Perennial Ryegrass	100 to 150 lbs.	3 lbs.						
+ White or Ladino Clover	1 to 2 lbs.	2 oz.						
Kentucky Bluegrass	20 lbs.	0.5 lb.						
+ Smooth Bromegrass	10 lbs.	0.25 lb.						
+ Switchgrass	3 lbs.	2 oz.						
+ Timothy	4 lbs.	0.25 lb.						
+ Perennial Ryegrass	10 lbs.	0.25 lb.						
+ White or Ladino Clover	1 to 2 lbs.	2 oz.						
Tall Fescue	100 to 150 lbs.	3 lbs.						
+ Ladino or White Clover	1 to 2 lbs.	2 oz.						
Tall Fescue	100 to 150 lbs.	3 lbs.						
+ Perennial Ryegrass	15 to 20 lbs.	0.5 lb.						
+ Kentucky Bluegrass	15 to 20 lbs.	0.5 lb.						



COUNTY OF	PROJECT NO.	SHEET NO.					
ALLEN	23-3243-L	17					
CLIENT & PROJECT							


ALLEN COUNTY SCHOOLS

#### Source: Kentucky ESPC Field Guide

3. MULCH SHALL BE APPLIED TO ALL DISTURBED AREAS IN THE CONSTRUCTION LIMITS RECEIVING PERMANENT SEEDING (I.E. ANY DISTURBED AREA NOT STABILIZED WITH PAVEMENT OR SIDEWALK). THE MULCH SHALL CONSIST OF EITHER BLOWN STRAW APPLIED AT A RATE OF 1<sup>5%</sup>4 TONS/ACRE OR HYDRAULIC MULCH APPLIED AT A RATE OF 1<sup>5%</sup>4 TO 2 TONS/ACRE. ANY AREAS THAT REQUIRE ADDITIONAL STABILIZATION SUCH AS STEEP SLOPES, DITCH CHANNEL, AND STORM SEWER OUTLETS ARE SHOWN ON THE PLANS WITH THE PARTICULAR STABILIZATION MEASURE TO BE APPLIED.

> ALL CBI'S, DBI'S, DRY WELLS, AND PIPE INLETS W/HDWLS SHALL USE SILT TRAP TYPE C

## **EROSION CONTROL NOTES**

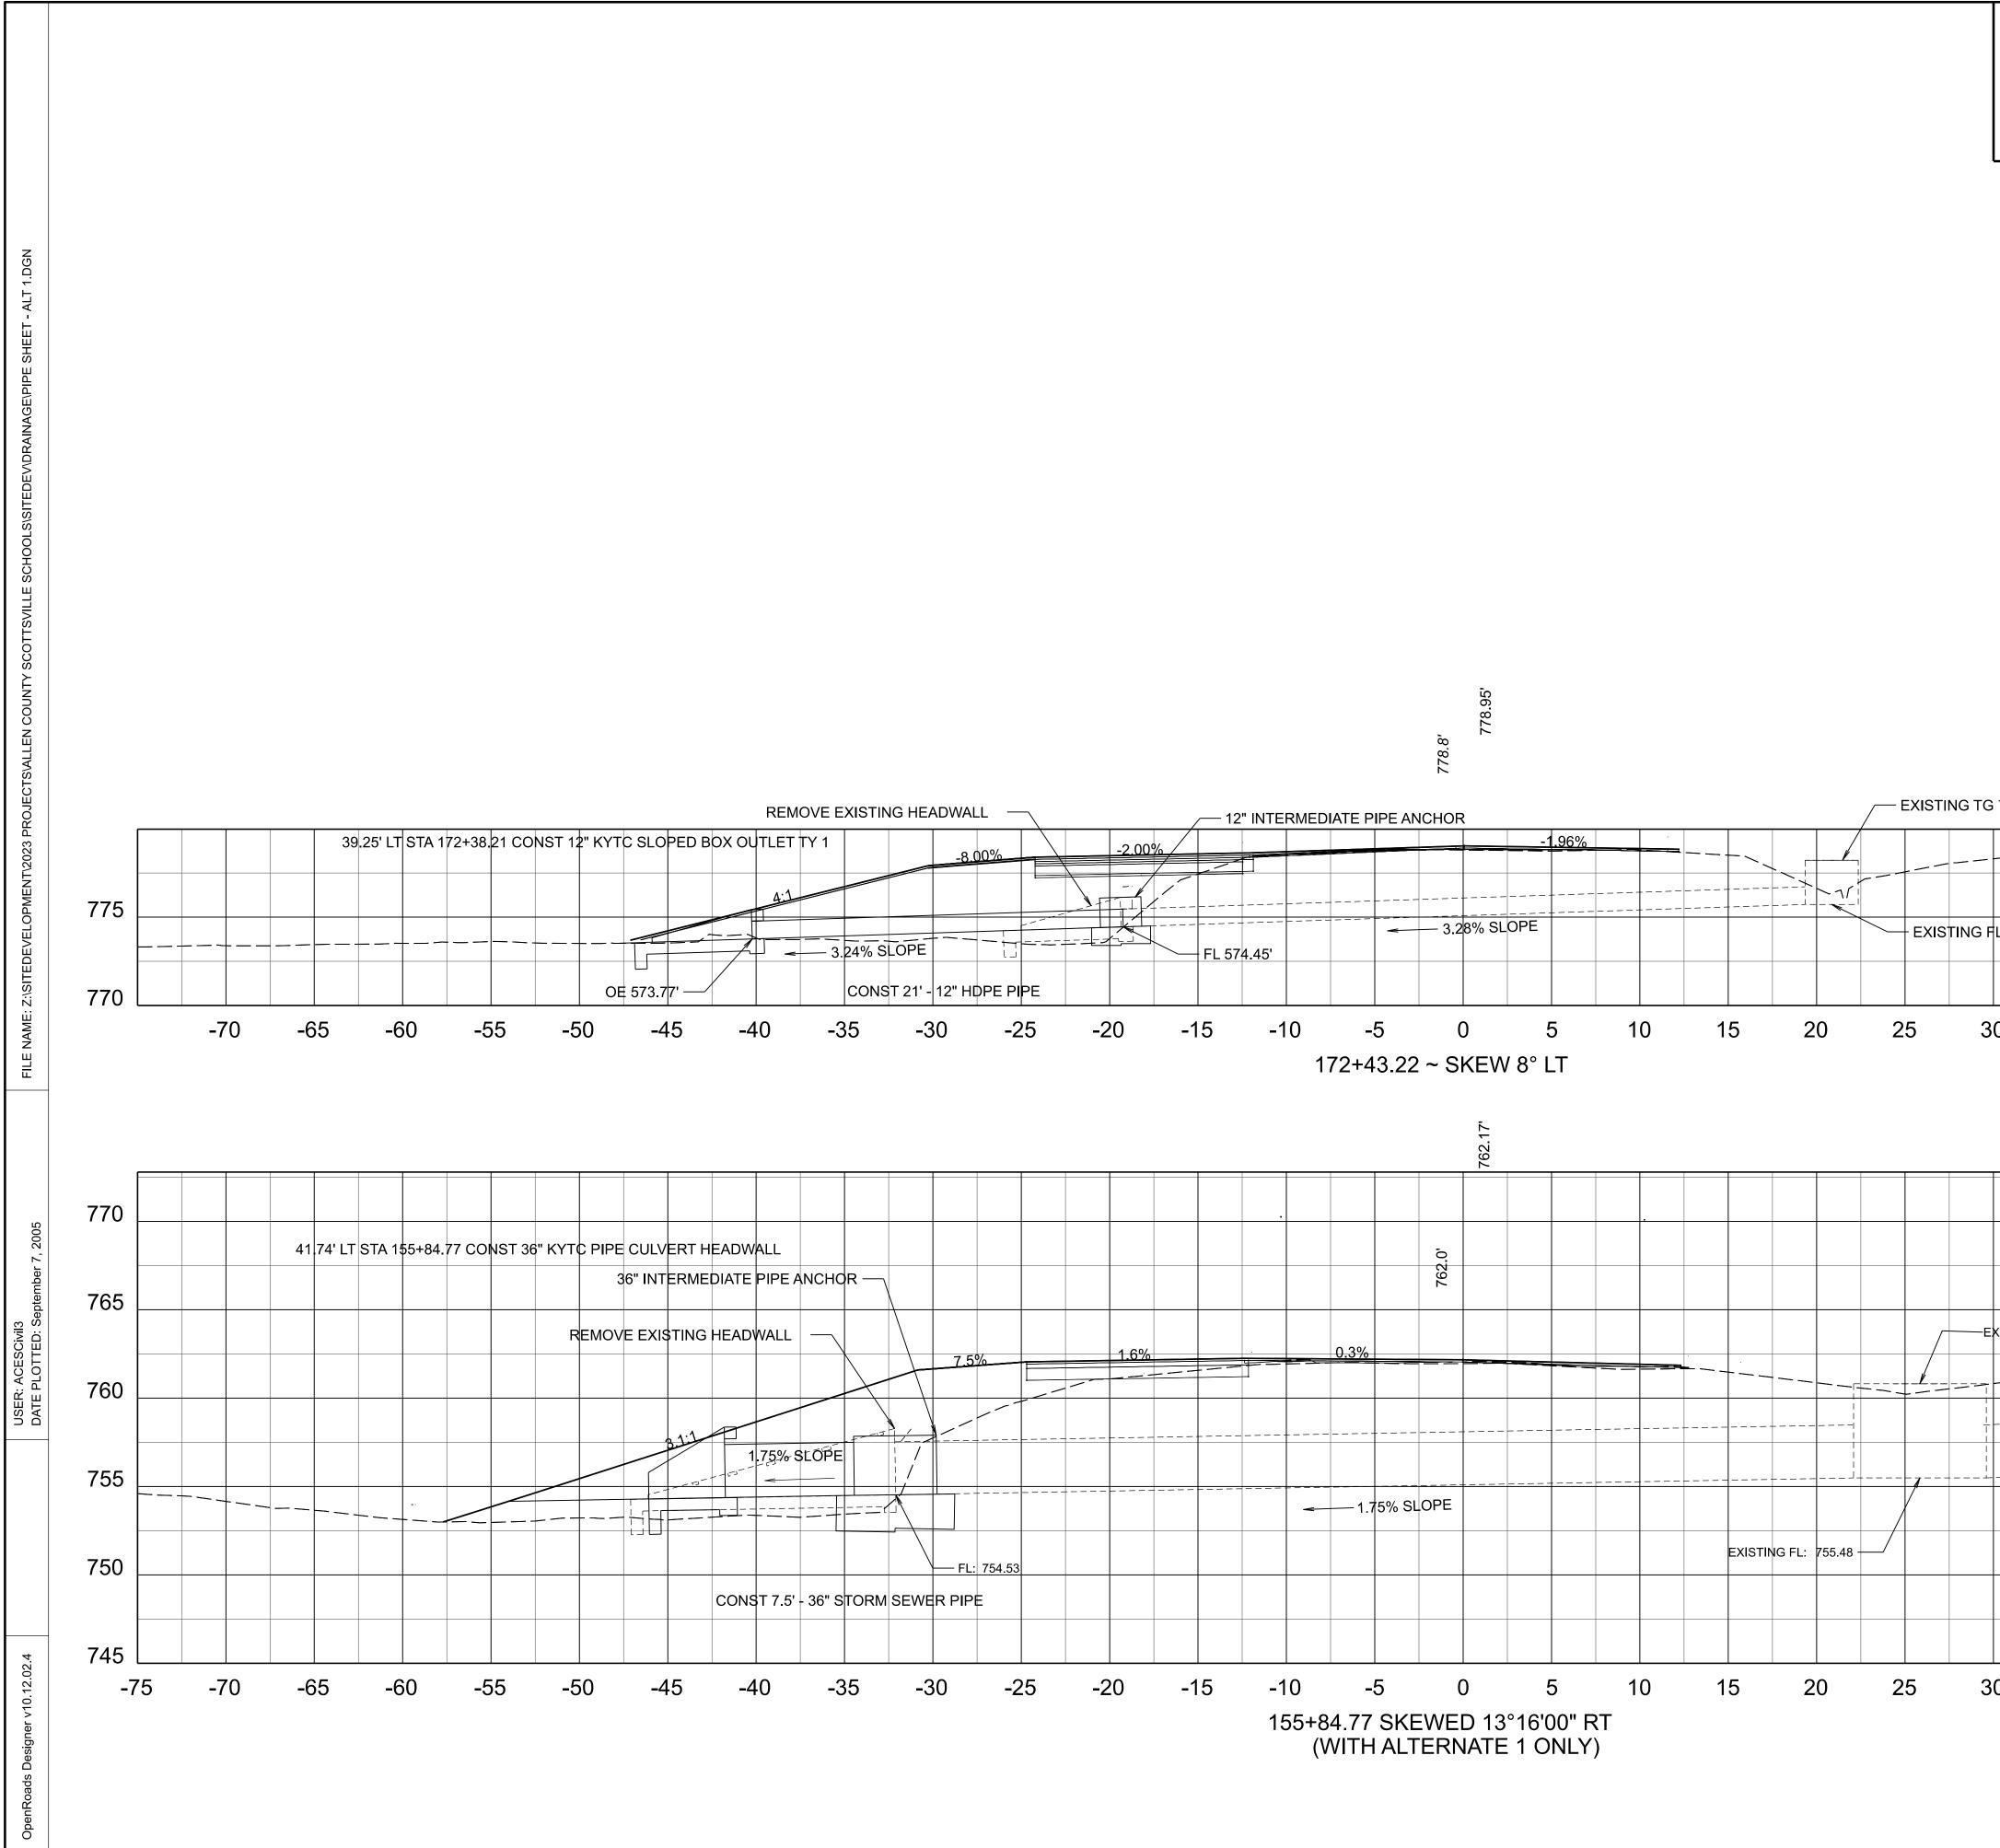

22'	ı												
5.72	2'												775
		<b>-</b>		<u> </u>	4.5						05	70	770
	3	5	4(	)	45	5	0	55	ł	50	65	70	75
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1G -	TG: 7	60.81											765
													760
								 5.10% SL	 OPE				755
											EXISTIN	IG FL: 757.73 -	
													750
													745
	3	5	4(	)	45	5	0	55	(	60	65	70	75
				SC	CALE: 1"	= 5' HOF	RIZ.				PIPF	SHEET	
					4"-6	5' VERT.		I					



COUNTY OF	PROJECT NO.	SHEET NO.						
ALLEN	23-3243-L	18						
CLIENT & PROJECT								
ALLEN COUNTY SCHOOLS								