INDEX TO DRAWINGS

```
SD2.0 OVERALL SITE GRADING AND DRAINAGE PLAN
SD2.1 SITE GRADING AND DRAINAGE PLAN
SD2.2 SITE GRADING AND DRAINAGE PLAN
SD2.3 SITE GRADING AND DRAINAGE PLAN
SD2.4 SITE GRADING AND DRAINAGE PLAN
S1.3 FOUNDATION PLAN AREA B
S1.9 SECOND FLOOR FRAMING PLAN AREA (
 S3.0 TYPICAL BAR JOIST, METAL DECK AND STEEL FRAMING DETAILS STEEL BEAM SCHEDULE
S3.4 LIGHT GAUGE METAL FRAMING DETAILS
S4.4 TYPICAL ICF WALL SECTIONS AND DETAILS
S7.1 MISC. HOLLOW CORE PLANK AND OPEN-WEB BAR JOISTS SECTIONS AND DETAILS
C0.2 TORNADO SHELTER REQUIREMENTS
      ABBREVIATIONS, SYMBOL LEGEND, GENERAL NOTES AND PARTITION TYPES
D1.1 DEMOLITION PLANS
D1.2 ENLARGED DEMO PLAN
A0.1 FIRST FLOOR OVERALL PLAN
A0.2 SECOND FLOOR OVERALL PLAN
A1.1 FIRST FLOOR PLAN - AREA A
A1.2 FIRST FLOOR PLAN - AREA B
A1.3 FIRST FLOOR PLAN - AREA C
A1.4 FIRST FLOOR PLAN - AREA D
A1.5 SECOND FLOOR PLAN & MECHANICAL PLATFORM
A2.1 ENLARGED PLANS
A2.2 ENLARGED PLANS
A2.3 ENLARGED PLANS
A2.4 ENLARGED KITCHEN PLAN
A2.5 ENLARGED RESTROOM PLANS
A2.6 ENLARGED STAIRS & ELEVATOR PLANS & DETAILS
A2.7 ENLARGED PLANS, CASEWORK NOTES & DETAILS
A3.1 BUILDING ELEVATIONS
A3.2 BUILDING ELEVATIONS
A4.1 ROOF PLAN & DETAILS
A4.2 ROOF DETAILS
A4.3 ROOF DETAILS
A5.1 BUILDING SECTIONS
A5.2 ENTRANCE CANOPY DETAILS
A5.3 REAR ENTRANCE CANOPY DETAILS
A6.1 TYPICAL PLAN DETAILS
A6.2 TYPICAL MISCELLANEOUS DETAILS
A7.1 FIRST FLOOR REFLECTED CEILING PLAN - AREA A
A7.2 FIRST FLOOR REFLECTED CEILING PLAN - AREA B
A7.3 FIRST FLOOR REFLECTED CEILING PLANS - AREA C AND AREA D
A7.4 SECOND FLOOR REFLECTED CEILING PLAN
A8.1 DOOR SCHEDULE AND DOOR AND FRAME ELEVATIONS
A8.2 FRAME ELEVATIONS AND DETAILS
A8.3 MEDIA CENTER WINDOW DETAILS
A8.4 FRAME DETAILS
A8.5 FRAME DETAILS
A9.1 FIRST FLOOR PATTERN AND SIGNAGE PLAN
FP0.1 FIRE PROTECTION LEAD SHEET
FP1.1 FIRE PROTECTION FIRST FLOOR PLAN AREA
FP1.2 FIRE PROTECTION FIRST FLOOR PLAN AREA B
FP1.3 FIRE PROTECTION FIRST FLOOR PLAN AREA (
FP1.4 FIRE PROTECTION FIRST FLOOR PLAN AREA D
FP1.5 FIRE PROTECTOIN SECOND FLOOR PLAN
P1.1 PLUMBING FIRST FLOOR PLAN AREA A
P1.2 PLUMBING FIRST FLOOR PLAN AREA B
P1.3 PLUMBING FIRST FLOOR PLAN AREA C
P1.4 PLUMBING FIRST FLOOR PLAN AREA D
P1.5 PLUMBING SECOND FLOOR PLAN
P1.6 PLUMBING SUPPLIES FIRST FLOOR PLAN AREA A
P1.7 PLUMBING SUPPLIES FIRST FLOOR PLAN AREA B
P1.8 PLUMBING SUPPLIES FIRST FLOOR PLAN AREA C
P1.9 PLUMBING SUPPLIES FIRST FLOOR PLAN AREA D
P1.10 PLUMBING SUPPLIES SECOND FLOOR PLAN
P3.1 PLUMBING DWV DIAGRAM
P3.2A DOMESTIC WATER DIAGRAM
P5.1 PLUMBING SCHEDULES
H1.1 HVAC FIRST FLOOR PLAN - AREA A
H1.2 HVAC FIRST FLOOR PLAN - AREA E
H1.3 HVAC FIRST FLOOR PLAN - AREA (
H1.4 HVAC FIRST FLOOR PLAN - AREA D
H1.5 HVAC SECOND FLOOR PLAN
H1.6 HVAC FIRST FLOOR OA AND EA PLAN - AREA
H1.7 HVAC FIRST FLOOR OA AND EA PLAN - AREA B
H1.8 HVAC FIRST FLOOR OA AND EA PLAN - AREA C
H1.9 HVAC FIRST FLOOR OA AND EA PLAN - AREA D
H1.10 HVAC SECOND FLOOR OA AND EA PLAN
H4.1 HVAC DETAILS
H4.2 HVAC DETAILS
H4.3 HVAC DETAILS
H5.1 HVAC SCHEDULES
H5.2 HVAC SCHEDULES
H5.3 HVAC SCHEDULES
ME1.1 MECHANICAL ELECTRICAL ROOF PLAN
ME4.1 MECHANICAL - ELECTRICAL STORM SHELTER DETAILS AND NOTES
E1.1 LIGHTING FIRST FLOOR PLAN AREA A
E1.2 LIGHTING FIRST FLOOR PLAN AREA B
E1.3 LIGHTING FIRST FLOOR PLAN AREA C
F1.4 LIGHTING FIRST FLOOR PLAN AREA D
E1.5 LIGHTING SECOND FLOOR PLAN
E1.6 POWER & SPECIAL SYSTEMS FIRST FLOOR PLAN - AREA A
E1.7 POWER & SPECIAL SYSTEMS FIRST FLOOR PLAN - AREA B
E1.8 POWER & SPECIAL SYSTEMS FIRST FLOOR PLAN - AREA (
E1.9 POWER & SPECIAL SYSTEMS FIRST FLOOR PLAN - AREA D
E1.10 POWER & SPECIAL SYS SECOND FLOOR PLAN
E3.1 ELECTRICAL RISER DIAGRAM
E4.1 ELECTRICAL DETAILS
E4.2 ELECTRICAL DETAILS
E4.3 ELECTRICAL DETAILS
E5.1 ELECTRICAL SCHEDULES
E5.2 ELECTRICAL SCHEDULES
E5.3 ELECTRICAL SCHEDULES
```

SOUTH HOPKINS SCHOOL RENOVATION

BG# 23-030

CONSTRUCTION DOCUMENTS

SEPT 18, 2023

SOUTH HOPKINS SCHOOL 9220 HOPKINSVILLE ROAD NORTONVILLE, KENTUCKY 42442

OWNER:

HOPKINS COUNTY BOARD OF EDUCATION

SCB PROJECT NUMBER: 2246

AMY SMITH - SUPERINTENDENT
SHANNON EMBRY - CHAIRPERSON
JOHN OSBORNE - VICE CHAIRMAN
KERRI SCISNEY - MEMBER
STEVE FAULK - MEMBER
NICK FOSTER - MEMBER
KEITH CARTWRIGHT - BOARD ATTORNEY



SHERMAN CARTER BARNHART ARCHITECTS, PLLC

PROJECT MANAGER: ANDREW H. OWENS AIA, CID

144 TURNER COMMONS WAY
SUITE #110

LEXINGTON, KY 40508 PHONE: 859.224.1351 FAX: 859.224.8446

www.scbarchitects.com

CIVIL ENGINEER

SHERMAN CARTER BARNHART ARCHITECTS, PLLC 144 TURNER COMMNOS WAY SUITE 110 LEXINGTON, KY 40508 P (859) 224-1351

STRUCTURAL ENGINEER


SHERMAN CARTER BARNHART ARCHITECTS, PLLC 9300 SHELBYVILLE ROAD HURSTBOURNE PLACE, SUITE 502 LOUISVILLE, KY 40222 P (502) 721-6100


MECHANICAL/ELECTRICAL ENGINEER

MARCUM ENGINEERING, LLC 500 SOUTH 17TH ST. PADUCAH, KY 42003 P (270) 444-9274

UTILITY ENGINEER

BACON FARMER WORKMAN ENGINEERING AND TESTING, INC. 500 SOUTH 17TH STREET PADUCAH, KY 42002 P (270) 443-1995

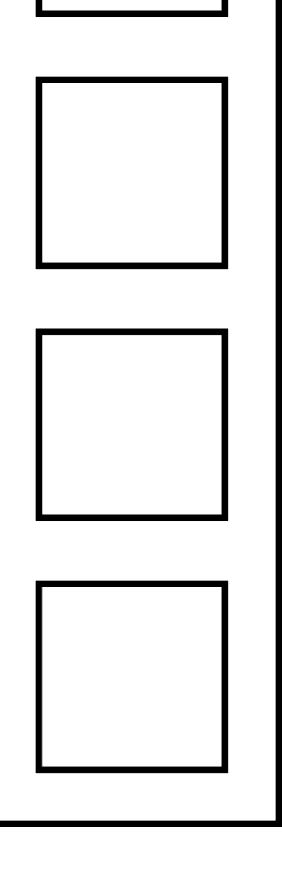

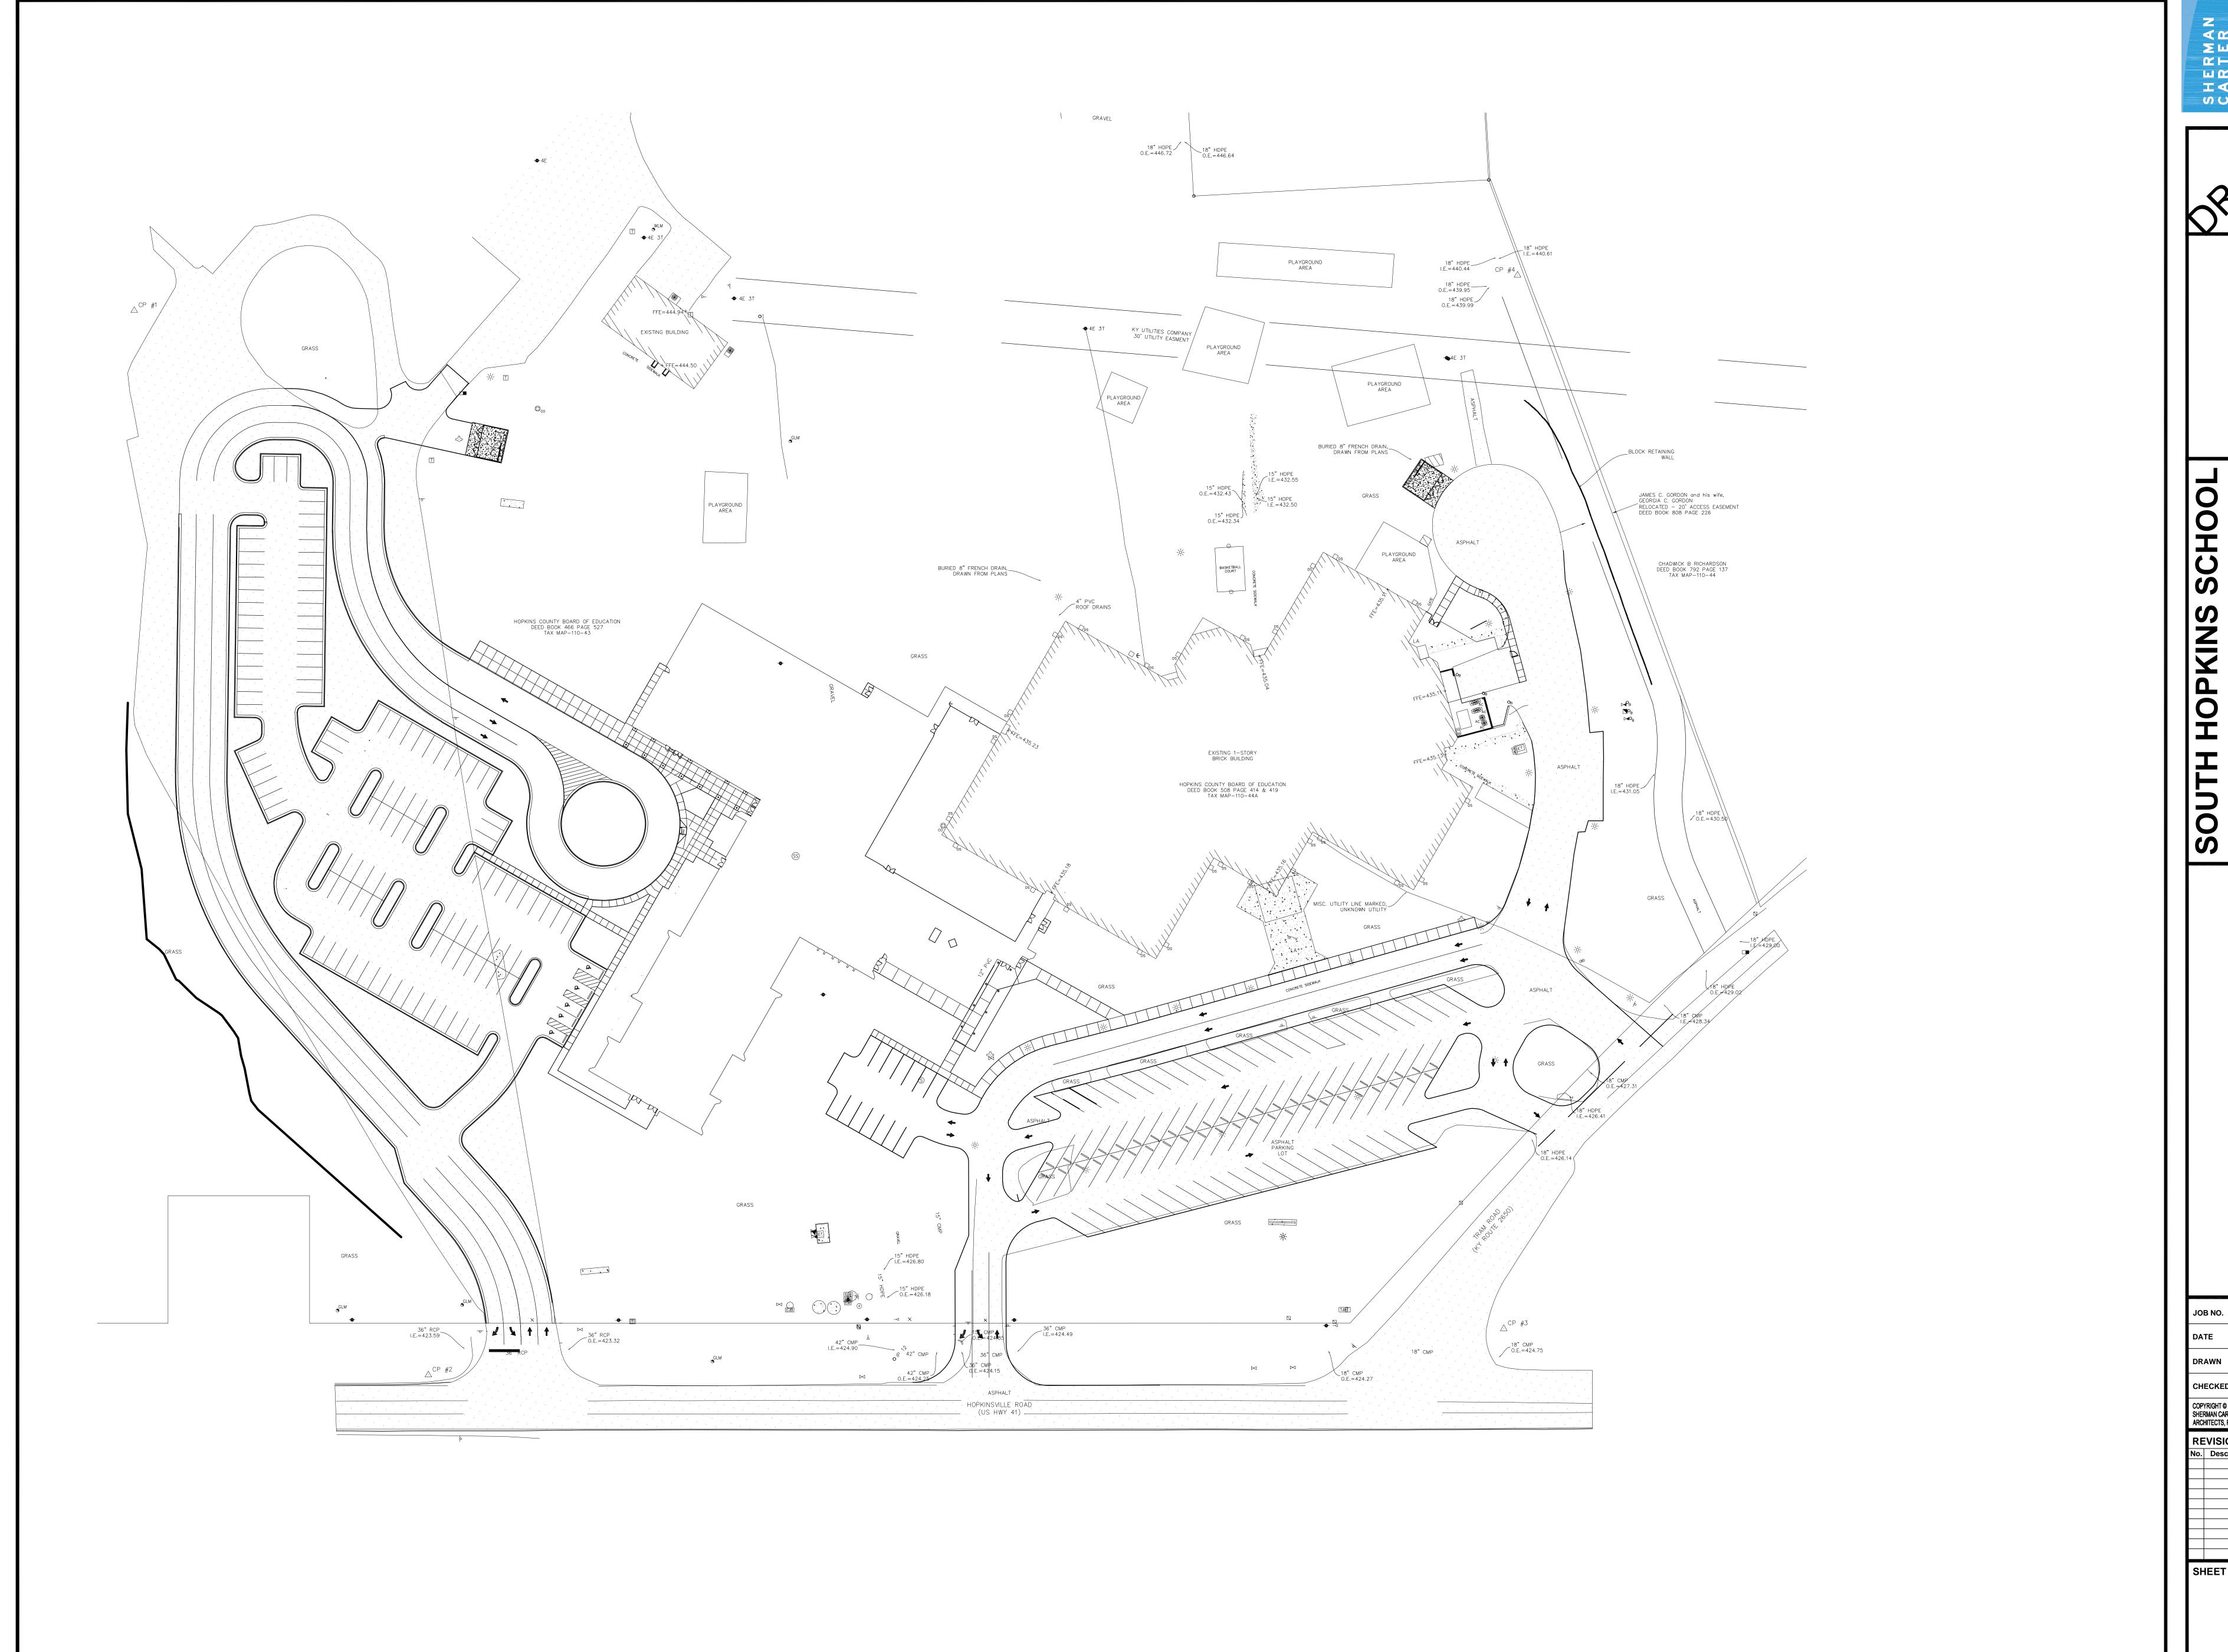

ᄪᅂᅂᆍ Idd von ₹

9220 HOPKINSVILLE ROAD HOPKINSVILLE, KENTUCKY

DRAWN CHECKED COPYRIGHT © 2023 SHERMAN CARTER BARNHART ARCHITECTS, PLLC REVISIONS



GRADING SITE LEGEND REFER TO TOPOGRAPHIC SURVEY FOR EXISTING UTILITIES LEGEND REFER TO SITE DEVELOPMENT PLANS FOR SITE LEGEND EXISTING/PROPOSED PROPERTY LINE EXISTING CONTOUR MINOR **EXISTING CONTOUR MAJOR** CONTOUR MINOR EXISTING SPOT ELEVATION **■ 979.55** SPOT ELEVATION (AT GUTTER LINE ADD 6" FOR TOP OF CURB ELEVATION) CHANNEL FLOW LINE ELEVATION ■ 979.55 HP SPOT ELEVATION HIGH POINT @ BREAKLINE SPOT ELEVATION TOP OF CURB/CONCRETE SPOT ELEVATION BOTTOM CURB/GUTTER LINE SPOT ELEVATION CONCRETE WALK EXISTING FIELD VERIFIED SPOT ELEVATION (AT GUTTER LINE ADD 6" FOR CURB ELEVATION) SPOT ELEVATION FLUSH AT GUTTER LINE FINISH FLOOR ELEVATION **⋈**979.55 FF CURB CUT ELEVATION SPOT ELEVATION TOP OF WALL SPOT ELEVATION BOTTOM WALL AT GRADE **■ 979.55 AS** | SPOT ELEVATION TOP OF ASPHALT SPOT ELEVATION TOP OF TRACK/RUBBER SURFACE SPOT ELEVATION TOP OF INFILL RUBBER ₩979.55 SG | SPOT ELEVATION FOOTBALL FIELD SUBGRADE 8" PERFORATED HDPE. SMOOTH INTERIOR SUBSURFACE UNDERDRAIN UD/SD4.1 BACKFILL W/ #57 STONE REFER TO PLAN FOR DIA. 6" X 1-1/4" "MULTIFLOW" FLAT PIPE W/ FILTER FABRIC 15' O.C. ST/SD3.2 DROP INLET DI/SD4.0 CURB INLET CI/SD4.0 STORM MANHOLE MH/SD4.0 CANOPY DRAINS ARE SHOWN FOR REFERENCE ONLY SEE ARCHITECTURAL DRAWINGS FOR EXACT LOCATION (PROVIDE 4" DIA PE DOWNSPOUT EXTENSION (TYP) CD/SD4.0 NEW BUILDING AND CANOPY DOWNSPOUTS ARE SHOWN FOR REFERENCE ONLY REFER TO ARCHITECTURAL DRAWINGS FOR EXACT LOCATION PROVIDE BOOTS PER 4" DIA BRASS STORM SEWER CLEAN OUT CO/SD4.0 ROOF LEADERS ARE SHOWN FOR REFERENCE ONLY. SEE PLUMBING DRAWINGS FOR EXACT LOCATION, SIZE AND INVERTS DRAIN BASIN W/ LOCKING GRATE 1299CGPL NYLOPLAST OR EQ. ID/SD4.0 DB 1299CGPL STANDARD HEADWALL SHW/SD4.1 FLARED END CONCRETE SECTION SD4.0 4" PERFORATED SMOOTH INTERIOR PIPE W/ FILTER FABRIC SUBSURFACE DRAINAGE PUD/SD4.0 OR SIM _____ST ____ STORM SEWER ST/SD4.1 EXISTING STORM SEWER — UD — 4" DIA SUBSURFACE UNDER DRAIN W/FILTER FABRIC UD/SD4.1 FD ------ 4" DIA FOUNDATION DRAIN SMOOTH INTERIOR FD/SD4.

> GRADING AND DRAINAGE NOTES: 1. ALL EARTHWORK FOR THIS PROJECT SHALL BE UNCLASSIFIED EXCAVATION TO PLAN BOTTOM DEPTH, PLAN BOTTOM DEPTH I DEFINED AS THE LOWEST ELEVATION OF EXCAVATION. THIS INCLUDES BOTTOM OF EXCAVATION FOR FOUNDATIONS, UTILITIES, ROADS. PARKING, SIDEWALKS, REQUIRED UNSUITABLE SOILS UNDERCUTTING AND ROCK REMOVAL AS INDICATED OR NOTED ON DRAWINGS OR GEOTECHNICAL REPORT.

FIELD VERIFY EXISTING CONDITIONS AND ADJUST ACCORDINGLY

GRADE/SLOPE

RUNOFF FLOW ARROW

HANDICAPPED RAMP MAX SLOPE 8.33%

2. AREAS THAT WILL SUPPORT FOUNDATIONS, FLOORS, PAVEMENTS AND SYNTHETIC TURF, SHALL BE PROPERLY PREPARED AS SPECIFIED IN ACCORDANCE WITH GEOTECHNICAL EXPLORATION REPORT PREPARED BY SOLID GROUND CONSULTING ENGINEERS, PLLC DATED JANUARY 04, 2022, ADDENDUM LETTER DATED MARCH 27 2023 AND SHALL BE APPROVED BY ON-SITE THE GEOTECHNICAL ENGINEER/TESTING AGENCY.

3. PRIOR TO CONSTRUCTION OR THE PLACEMENT OF NEW ENGINEERED FILL, THE EXPOSED SUBGRADE SHALL BE EVALUATED BY THE ON-SITE GEOTECHNICAL ENGINEER. THE EVALUATION SHALL INCLUDE PROOFROLLING OF THE EXPOSED SUBGRADE. IF UNSUITABLE MATERIALS AREA DISCOVERED, AN APPROPRIATE REMEDIAL MEASURE WOULD BE RECOMMENDED BY THE GEOTECHNICAL ENGINEER AT THAT TIME.

4. CARE MUST BE EXERCISED DURING GRADING AND FILL PLACEMENT OPERATIONS. THE COMBINATION OF CONSTRUCTION EQUIPMENT TRAFFIC AND EXCESS SURFACE MOISTURE CAN CAUSE PUMPING AND DETERIORATION OF THE NEAR SURFACE SOIL THE SEVERITY OF THIS POTENTIAL PROBLEM DEPENDS TO A GREAT EXTENT ON THE WEATHER CONDITIONS PREVAILING DURING CONSTRUCTION. THE CONTRACTOR MUST EXERCISE DISCRETION WHEN SELECTING EQUIPMENT SIZES AND ALSO MAKE A CONCERTED EFFORT TO CONTROL SURFACE WATER WHILE THE SUBGRADE SOILS ARE EXPOSED. IF SUCH PROBLEMS DO ARISE

THE GEOTECHNICAL ENGINEER SHOULD BE CONTACTED TO EVALUATE THE CONDITION. 5. ENGINEERED FILL PLACEMENT AND COMPACTION OPERATIONS SHALL BE MONITORED BY THE GEOTECHNICAL ENGINEER OR HIS REPRESENTATIVE. FIELD DENSITY TESTS MUST BE PERFORMED ON EACH LIFT AS NECESSARY TO CHECK THAT THE SPECIFIED COMPACTION IS BEING ACHIEVED

6. THE CONTRACTOR SHALL VERIFY HORIZONTAL AND VERTICAL LOCATION OF ALL EXISTING STORM SEWER STRUCTURES, PIPES, AND ALL OTHER UTILITIES PRIOR TO CONSTRUCTION, AND SHALL CLOSELY MONITOR UTILITY INSTALLATION BY OTHER IT IS RECOMMENDED TO INSTALL GRAVITY STORM AND SANITARY LINES PRIOR TO ELECTRICAL COMMUNICATION AND WATER

7. EXCAVATION, ROCK REMOVAL, TOPSOIL STOCKPILES, DETENTION POND BERMS, UTILITY TRENCHES, AND OTHER ASPECTS OF CONSTRUCTION SHALL COMPLY WITH THE REQUIREMENTS OF THE OSHA REGULATIONS 1926,650-652. 8. THE CONTRACTOR SHALL IMMEDIATELY NOTIFY THE PROJECT CIVIL ENGINEER OF ANY DISCREPANCIES FOUND BETWEEN

THESE PLANS AND FIELD CONDITIONS PRIOR TO CONSTRUCTION. 9. THE PRINCIPLES OF POSITIVE DRAINAGE SHALL BE APPLIED UNIVERSALLY ACROSS THE SITE. WATER SHALL BE MOVED AWAY FROM THE BUILDINGS. WATER SHOULD NOT BE ALLOWED TO POND AT LOW POINTS OR IN LOW AREAS. FINISH SUBGRADE TO

REQUIRED ELEVATION WITHIN THE FOLLOWING TOLERANCES: LAWN OR UNPAVED AREAS: PLUS OR MINUS 0.1FT.

PAVEMENT: PLUS OR MINUS 0.05FT. GRADING INSIDE BUILDING LINE TO A TOLERANCE OF 0.05 FT WHEN TESTED WITH A 10 FOOT STRAIGHTEDGE

10. AFTER COMPLETION OF CONSTRUCTION, THE CONTRACTOR SHALL PERFORM SITE CLEANUP TO REMOVE ALL TRASH, DEBRIS, EXCESS MATERIALS, EQUIPMENT, AND OTHER DELETERIOUS MATERIALS ASSOCIATED WITH CONSTRUCTION. THE SITE CONTRACTOR IS EXPRESSLY RESPONSIBLE FOR ENSURING THE SITE IS CLEAN AND IN OPERABLE CONDITION AT THE TIME OF

FINAL ACCEPTANCE. 11. PROPOSED ROAD AND PARKING AREAS ARE NOT DESIGNED TO ACCOMMODATE HIGH LOADS CREATED BY CONSTRUCTION VEHICLES. CONTRACTOR SHALL MAINTAIN, STABILIZE AND REPAIR SUBGRADE/STONE BASE AND EXISTING ASPHALT PAVEMENT DAMAGED BY CONSTRUCTION TRAFFIC AS REQUIRED AT NO ADDITIONAL COST TO THE OWNER. CONTRACTOR IS RESPONSIBLE

12. ALL VALVE, METERS AND MANHOLE COVERS SHALL BE ADJUSTED TO MATCH THE PROPOSED GRADES. (TYP)

DRAINAGE STRUCTURE NOTES:

1. ALL LENGTHS OF STORM SEWER PIPING ARE APPROXIMATE. CONTRACTOR SHALL PROVIDE PIPE MATERIALS AND FITTINGS AS NECESSARY TO COMPLETE THE STORM SEWER SYSTEM AS INDICATED OR REQUIRED

2. PROVIDE PIPE SUPPLIED BY PRODUCER THAT IS LISTED ON THE LIST OF APPROVED MATERIALS PUBLISHED BY KENTUCKY TRANSPORTATION CABINET AND IN ACCORADNCE WITH SECTION 810 KTC STANDARD SPECIFICATION FOR ROAD AND BRIDGE CONSTRUCTION EDITION OF 2008. ENSURE ALL FITTINGS AND PIPE ARE MADE FROM THE SAME TYPE OF MATERIAL PE-THEPMOPLASTIC PIPE, PROVIDE "ADS" N-12 IBWT PIPE, CORRUGATED HIGH DENSITY POLYETHELENE PIPE (HDPE OR CPEP) WITH SMOOTH INTERIOR WALL W/ WATER-TIGHT JOINTS OR EQUIVALENT, MEETING AASHTO STANDARD M-294. INSTALL AND BACKFILL HDPE PIPE IN STRICT ACCORDANCE WITH MANUFACTURER'S SPECIFICATIONS.

3. RCP-REINFORCED CONCRETE PIPE CONFORMING AASHTO M-170 CLASS III.

4. ALL PIPES ENTERING STORM SEWER STRUCTURES SHALL BE GROUTED TO ASSURE CONNECTION AT STRUCTURE IS WATER

5. ADJUST ALL SEWER AND DRAIN FRAMES AND GRATES OR COVERS TO FINISH GRADE AND ENSURE THAT GRATES AND FRAMES

6. PROVIDE 4000 PSI @ 28 DAYS CONCRETE CEMENT TYPE 1 OR TYPE 2 FOR ALL CONCRETE DRAINAGE STRUCTURES. 7. PLACE PIPE TO THE GRADES AND ALIGNMENT AS SHOWN ON DRAWINGS WITH THE FOLLOWING TOLERANCES: HORIZONTALLY ± 0.10'

VERTICALLY. ± 0.05' 8. . PROVIDE CONSISTENT SLOPE TO STORM DRAINAGE STRUCTURES. INTENT IS TO AVOID ABRUPT GRADE

ROCK REMOVAL
CONTRACTOR SHALL ANTICIPATE ROCK REMOVAL AS REQUIRED TO CONSTRUCT FINISH GRADE, NEW STRUCTURES AND INSTAIL UTILITIES. IN LAWN AREAS ROCK SHALL BE REMOVED TO MINIMUM 12 " BELOW FINAL GRADES. BLASTING WILL NOT BE ALLOWED ON THE SCHOOL PROPERTY.

FIELD QUALITY CONTROL:
OWNER WILL ENGAGE A QUALIFIED TESTING AGENCY TO PERFORM THE SPECIAL INSPECTION AND QUALITY ASSURANCE TESTING AS REQUIRED IN ACCORDANCE WITH THE LATEST EDITION OF KENTUCKY BUILDING CODE CHAPTER 17 AND EARTHWORK SPECIFICATION. CONTRACTOR IS RESPONSIBLE FOR QUALITY CONTROL SCHEDULING, PLANNING AND INSPECTION TO ENSURE PROPER TESTING BY OWNER'S TESTING AGENCY IN ACCORDANCE WITH GEOTECHNICAL RECOMMENDATIONS AND EARTHWORK SPECIFICATION.

IMPORT SOILS
CONTRACTOR SHALL INCLUDE ALL LABOR AND MATERIALS TO IMPORT SOIL FILL IN ACCORDANCE WITH THE GEOTECHNICAL REPORT RECOMMENDATION AS REQUIRED TO ACHIEVE PROPOSED ELEVATION. PRIOR TO BRINGING SOIL MATERIALS ON SITE, ANY OFF-SITE SOILS SHALL BE TESTED AND APPROVED BY THE OWNER TESTING AGENCY. IMPORT SOIL FILL SHALL BE UNIFORM

> SCALE IN FEET SCALE: 1" =40'-0"

INCLUDE AN ALLOWANCE BASED ON THE FOLLOWING WORK SCOPE: THE CONTRACTOR SHALL INCLUDE IN THE BASE BID, AN ALLOWANCE TO REMOVE AND DISPOSE OFF-SITE AN ADDITIONAL 2000 CY OF UNSUITABLE SOIL, WHICH MAY BE ENCOUNTERED BELOW PLAN BOTTOM DEPTH. THE ALLOWANCE PRICE SHALL INCLUDE REPLACEMENT WITH 2000 CY OF DGA PLACED AND COMPACTED IN ACCORDANCE WITH THE PROJECT GEOTECHNICAL REPORT AND ON-SITE TESTING AGENCY RECOMMENDATIONS. THE ALLOWANCE PRICE SHALL ALSO INCLUDE 28000 SF OF 6 OZ NON-WOVEN FILTER FABRIC. ACTUAL VOLUMES IN THE ALLOWANCE SHALL BE MEASURED BY THE ON-SITE TESTING AGENCY AND THE CONTRACT WILL BE ADJUSTED USING UNIT PRICES. THE ALLOWANCE SHALL BE INCLUDED IN THE BASE BID WITH A LINE ITEM SHOWN ON THE BID FORM.

 $\Sigma \sqcup T$

 $\alpha \vdash Z$

шкк

onom ∢


X/XX/2023

COPYRIGHT © 2023 SHERMAN CARTER BARNHART ARCHITECTS, PLLC REVISIONS No. Description Date 1 ADDENDUM #2 5/11/2023





JOB NO. DATE X/XX/2023 DRAWN CHECKED COPYRIGHT © 2023 SHERMAN CARTER BARNHART ARCHITECTS, PLLC REVISIONS
No. Description Date

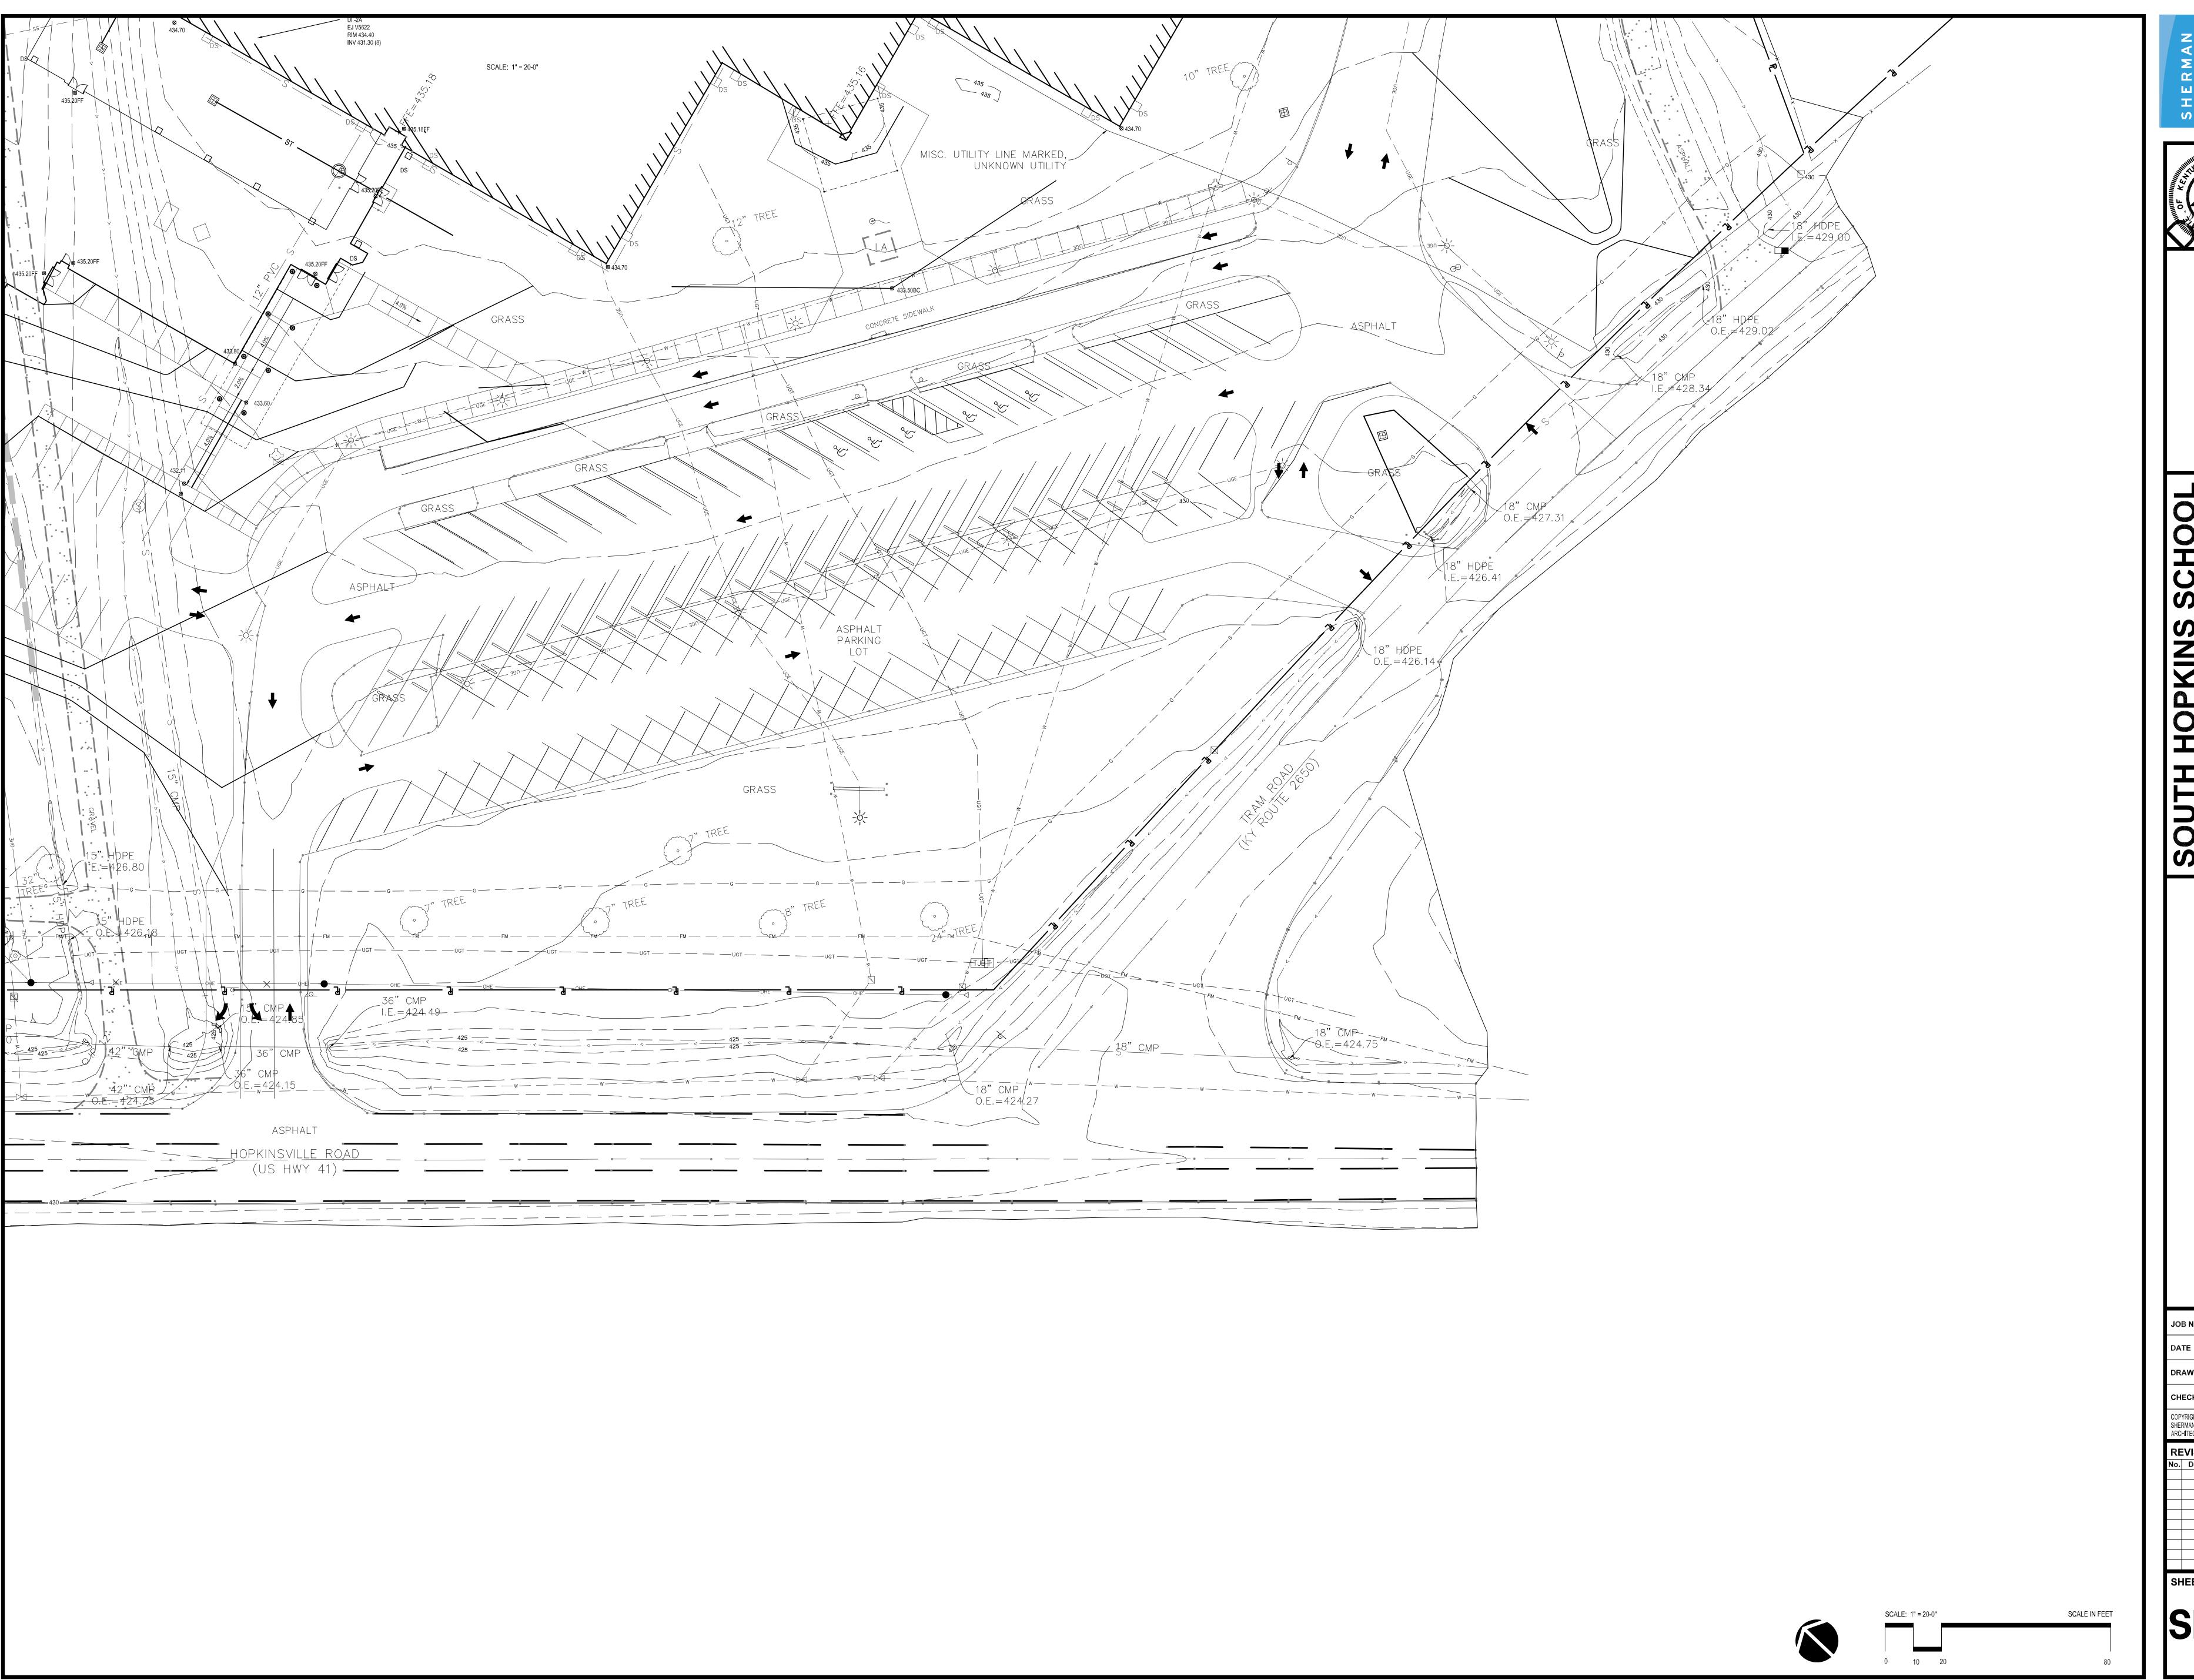


SHERMAN CARTER BARNHART ARCHITECTS



DATE X/XX/2023 DRAWN CHECKED COPYRIGHT © 2023 SHERMAN CARTER BARNHART ARCHITECTS, PLLC REVISIONS
No. Description Date



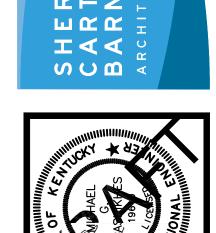

JOB NO. X/XX/2023 DRAWN

CHECKED COPYRIGHT © 2023 SHERMAN CARTER BARNHART ARCHITECTS, PLLC REVISIONS No. Description Date




SHERMAN CARTER BARNHART

X/XX/2023

COPYRIGHT © 2023 SHERMAN CARTER BARNHART ARCHITECTS, PLLC REVISIONS
No. Description Date

ZC

AUA 4 Σ \square Γ $\alpha \vdash z$ шкк I 4 4 0

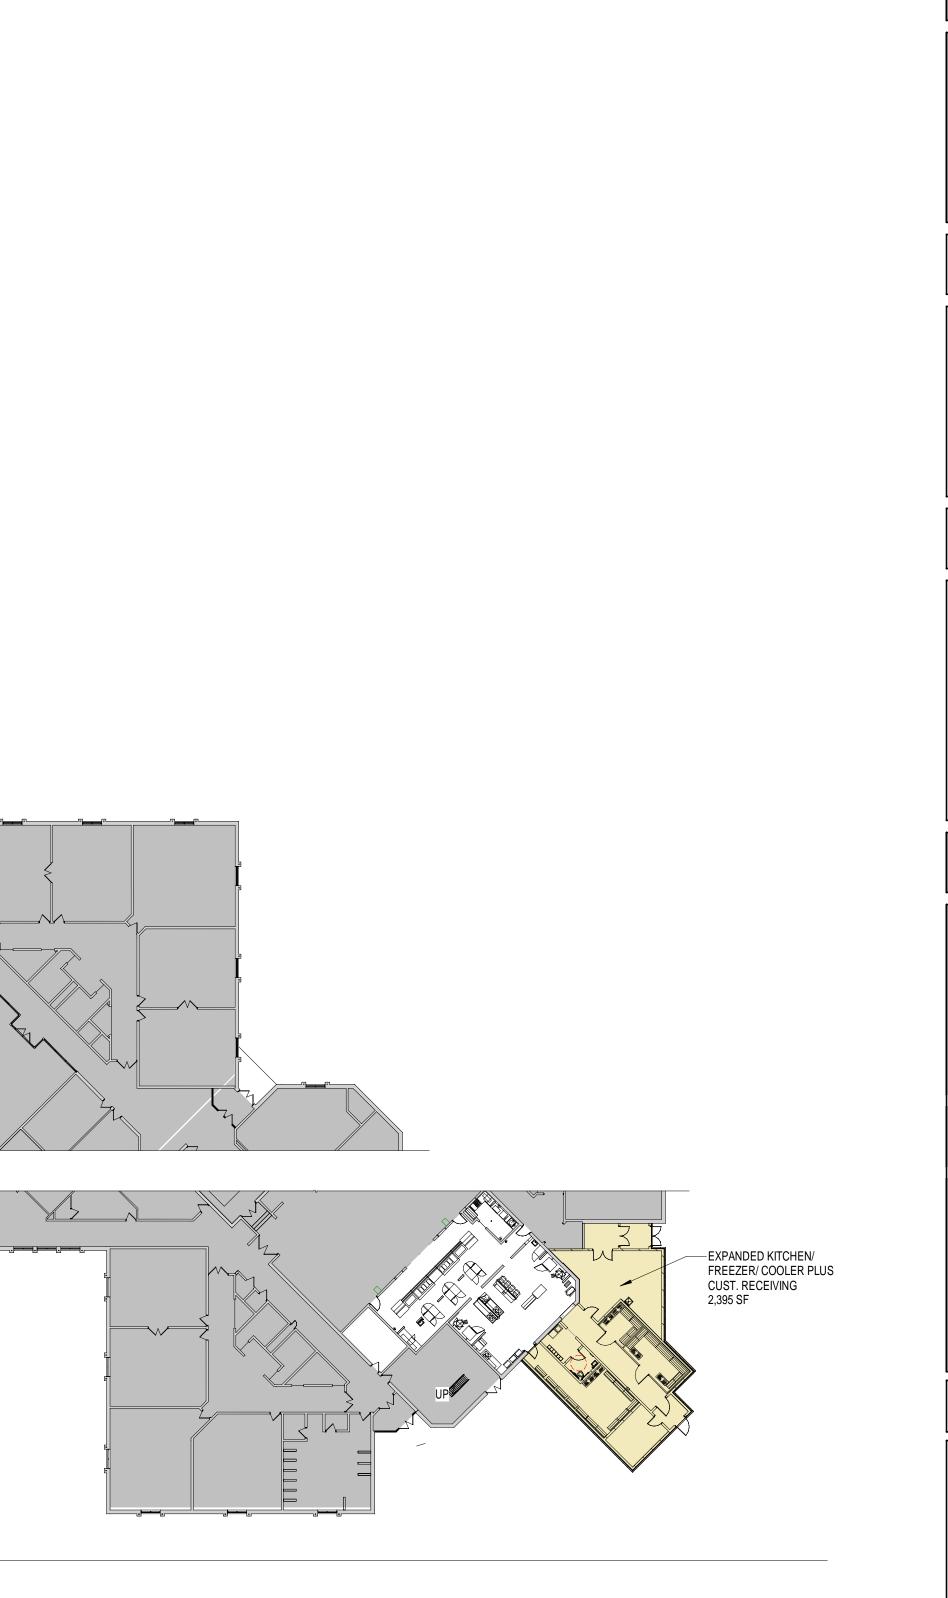

TO BELOW ROOF OPEN TO MEDIA CENTER COURTYARD

ROOF

CANOPY

39' - 7 7/8"

PROJECT SUMMARY

PROJECT CONSISTS OF THE CONSTRUCTION OF A MIDDLE SCHOOL OF APPROXIMATELY 69,000 TOTAL SF CONNECTED TO AN EXISTING ELEMENTARY SCHOOL BY 2 PEDESTRIAN WALKWAYS. THE NEW SCHOOL IS NOT REQUIRED TO BE SEPARATED FROM THE EXISTING BUILDING BY A FIRE WALL DUE TO A FIRE SEPARATION DISTANCE OF 40'-0".

SEISMIC DESIGN CRITERIA

(REFER TO SHEET SO.1 FOR ADDITIONAL INFORMATION)

SEISMIC OCCUPANCY CATEGORY SITE CLASS SEISMIC DESIGN CATEGORY

OCCUPANCY LOAD CALCULATIONS - KBC TABLE 1004.2.1

BUILDING CALCULATIONS ASSEMBLY AREAS <u>CLASSROOMS</u> 1:20 = 17,837 / 20 = 892 <u>OFFICES</u> 1:20 = 2,309 / 20 = 115

EGRESS PROVIDED 288 INCHES / .15 = 1,920 MAX. OCCUPANTS FLOOR BLEACHERS = 850 <u>GYMNASIUM EXERCISE ROOM</u> 1:50 = 6995 / 50 = 140 GYMNASIUM FLOOR = 140 TOTAL GYMNASIUM SEATING = 990

BLEACHER SEATING = 850
MEDIA CENTER = 151
2,148 OCCUPANTS = 4 EXITS REQUIRED, 6 EXITS PROVIDED AT 2,880 CAPACITY (432" / EGRESS PROVIDED 144 INCHES / .15 = 960 MAX. OCCUPANTS UNCONCENTRATED SEATING = 3,015 / 20 = 151 TOTAL MEDIA CENTER SEATING = 151 MEDIA CENTER

BUILDING AREA:

CODE COMPLIANCE INFORMATION

GENERAL INFORMATION : CODE: KENTUCKY BUILDING CODE 2018 SECOND EDITION USE GROUP: E (EDUCATION) CONSTRUCTION TYPE: 1992 CONSTRUCTION: 2C (EQUIVALENT 2B 2018) NEW CONSTRUCTION: 2B `

FIRE PROTECTION: FULLY SPRINKLERED PER NFPA 13 WITH VOICE ALARM, EXISTING AND NEW BUILDING HEIGHT CALCULATIONS: TABLES 504.3 AND 504.4

ALLOWABLE HEIGHT = 3 STORIES / 75'-0" (TABLE 504) ACTUAL BUILDING HEIGHT = 2 STORIES / 36'-0"

(> 20 FT. ABOVE FLOOR):

TRAVEL DISTANCES:

TRAVEL DISTANCE TO EXIT: ACTUAL MAXIMUM TRAVEL DISTANCE: 197'-4" (MAXIMUM ALLOWABLE TRAVEL DISTANCE: 250'-0" (PER TABLE 1016) DEAD-END CORRIDOR ALLOWED = 50 FEET, MAXIMUM DESIGNED = 30 FEET

<u>ALLOWABLE AREAS</u> (TABLE 506.2) = 106,000 PER FLOOR (EXISTING BUILDING) 79,500 PER FLOOR (NEW BUILDING) **BUILDING AREAS**: FIRST FLOOR (EXISTING): 59,245 SQ. FT. FIRST FLOOR (NEW): 46,795 SQ. FT SECOND FLOOR (NÉW): 17,844 SQ. FT. STORM SHELTER AREA" 13,538 SQ. FT. (INCL. IN FIRST FLOOR) TOTAL BUILDING AREA: 64,639 SQ. FT.

MINIMUM FIRE RESISTANCE ASSEMBLY RATINGS RATINGS (PER TABLES 601 AND 602) STRUCTURAL FRAME : 0 HR 8" CMU WALL: 1 HOUR, UL NO. U906 BEARING WALLS EXTERIOR 8" CMU WALL: 2 HOUR, UL NO. U905 BEARING WALLS INTERIOR 1 HOUR, UL NO. U906 0 HR > 30' DISTANCE NON-BEARING EXTERIOR WALLS I HOUR, UL NO. U930 NON-BEARING INTERIOR WALLS: 0 HR RECORDS ROOM: 2-HOUR FIRE RESISTANT (KDE REQUIREMENT) 1-HOUR FIRE BARRIER (SECTOIN 713.4) FLOOR CONSTRUCTION ELEVATOR SHAFT: ROOF CONSTRUCTION TORNADO SHELTER: 2-HOUR FIRE BARRIER (SECTION 713.4) (< 20 FT. ABOVE FLOOR) : ROOF CONSTRUCTION

SPECIAL INSPECTIONS PER CHAPTER 17 OF THE KENTUCKY BUILDING CODE

NOTE: IN ADDITION TO OTHER TESTS AND INSPECTIONS REQUIRED BY THE SPECIFICATIONS, THE OWNER SHALL PROVIDE THE SERVICES OF QUALIFIED THIRD-PARTY INSPECTORS TO PERFORM ALL REQUIRED SPECIAL INSPECTIONS AS FOLLOWS:


SECTION	<u>ITEM</u>		ED?	<u>REMARKS</u>
		YES	NO_	
1704.2.5	FABRICATORS	X		STEEL FABRICATION SPECIAL INSPECTION IS REQUIRED THE FABRICATOR IS NOT A.I.S.C. OR AWS CERTIFIED.
1704.2.3	STRUCTURAL OBSERVATIONS			SEE SECTION 1704.6.1 FOR SEISMIC AND SECTION 1406.2
1704.0	SPECIAL CASES - TORNADO SHELTER	X		FOR WIND REQUIREMENTS
				OTDUOTUDAL OTESL AND IOIOTO DED TABLE 4705 0.0
1705.2	STEEL	<u>X</u>		STRUCTURAL STEEL AND JOISTS, PER TABLE 1705.2.2
1705.3	CONCRETE	X		PER TABLE 1705.3
1705.4	MASONRY	X		PER TMS 402 / TMS 602
1705.5	WOOD		X	NONE
1705.6	SOILS	X		PER TABLE 1705.6
1705.7	DRIVEN DEEP FOUNDATION		X	NONE
1705.8	CAST-IN-PLACE DEEP FOUNDATIONS		X	NONE
1705.9	HELICAL PILE FOUNDATIONS		X	NONE
1705.10	INSPECTIONS FOR WIND RESISTANCE		X	Vasd 93 MPH
1705.10	FABRICATED ITEMS	X		PER SECTION 1704.2.5
1705.11.1	WIND - STRUCTURAL WOOD		X	NONE
1705.11.2	WIND - COLD-FORMED STEEL FRAMING		X	NONE
1705.11.3	WIND - WIND RESISTING COMPONENTS		X	NONE
1705.12.1	SEISMIC - STRUCTURAL STEEL			SEISMIC DESIGN CATEGORY "D"
1705.12.2	SEISMIC - STRUCTURAL WOOD		X	SEISMIC DESIGN CATEGORY "D"
1705.12.3	SEISMIC - COLD FORMED STEEL FRAMING		X	NONE
1705.12.4	DEDICATED SEISMIC SYSTEMS		X	SEISMIC DESIGN CATEGORY "D"
1705.12.5	SEISMIC - ARCHITECTURAL COMPONENTS - INTERIOR / EXTERIOR NON-LOAD BEARING WALLS AND VENEER IN STRUCTURES		X	SEISMIC DESIGN CATEGORY "D"
1705.12.6	SEISMIC - MECHANICAL AND ELECTRICAL COMPONENTS	Χ		SEISMIC DESIGN CATEGORY "D"
1705.12.7	SEISMIC - STORAGE RACKS AND ACCESS FLOORS		X	NONE
1705.12.8	SEISMIC - SEISMIC ISOLATION SYSTEMS		X	NONE
1705.12.9	SEISMIC - COLD-FORMED STEEL SPECIAL BOLTED MOMENT FRAMES		X	NONE
1705.13.1.1	SEISMIC TESTING - SEISMIC FORCE RESISTING SYSTEMS		Χ	NONE
1705.13.1.2	SEISMIC TESTING - STRUCTURAL STEEL ELEMENTS	X		NONE
1705.13.2	SEISMIC TESTING - NONSTRUCTURAL COMPONENTS		X	NONE
1705.13.3	SEISMIC TESTING - DESIGNATED SEISMIC SYSTEMS		X	NONE
1705.13.4	SEISMIC TESTING - SEISMIC ISOLATION SYSTEMS		X	NONE
1705.14	SPRAYED FIREPROOFING		X	NONE
1705.15	MASTIC AND INTUMESCENT FIRE-RESISTANT COATINGS		X	NONE
1705.16	E.I.F.S.		X	NONE
1705.17	FIRE RESISTANT PENETRATIONS AND JOINTS			PER 1705.17.1 AND 1705.17.2
1705.18	SMOKE CONTROL		X	NONE

2246 SOUTH HOPKINS SCHOOL 9/11/2023 2:56:56 PM

2 SECOND FLOOR PLAN
1" = 30'-0"

1 FIRST FLOOR NEW WORK PLAN

1" = 30'-0"

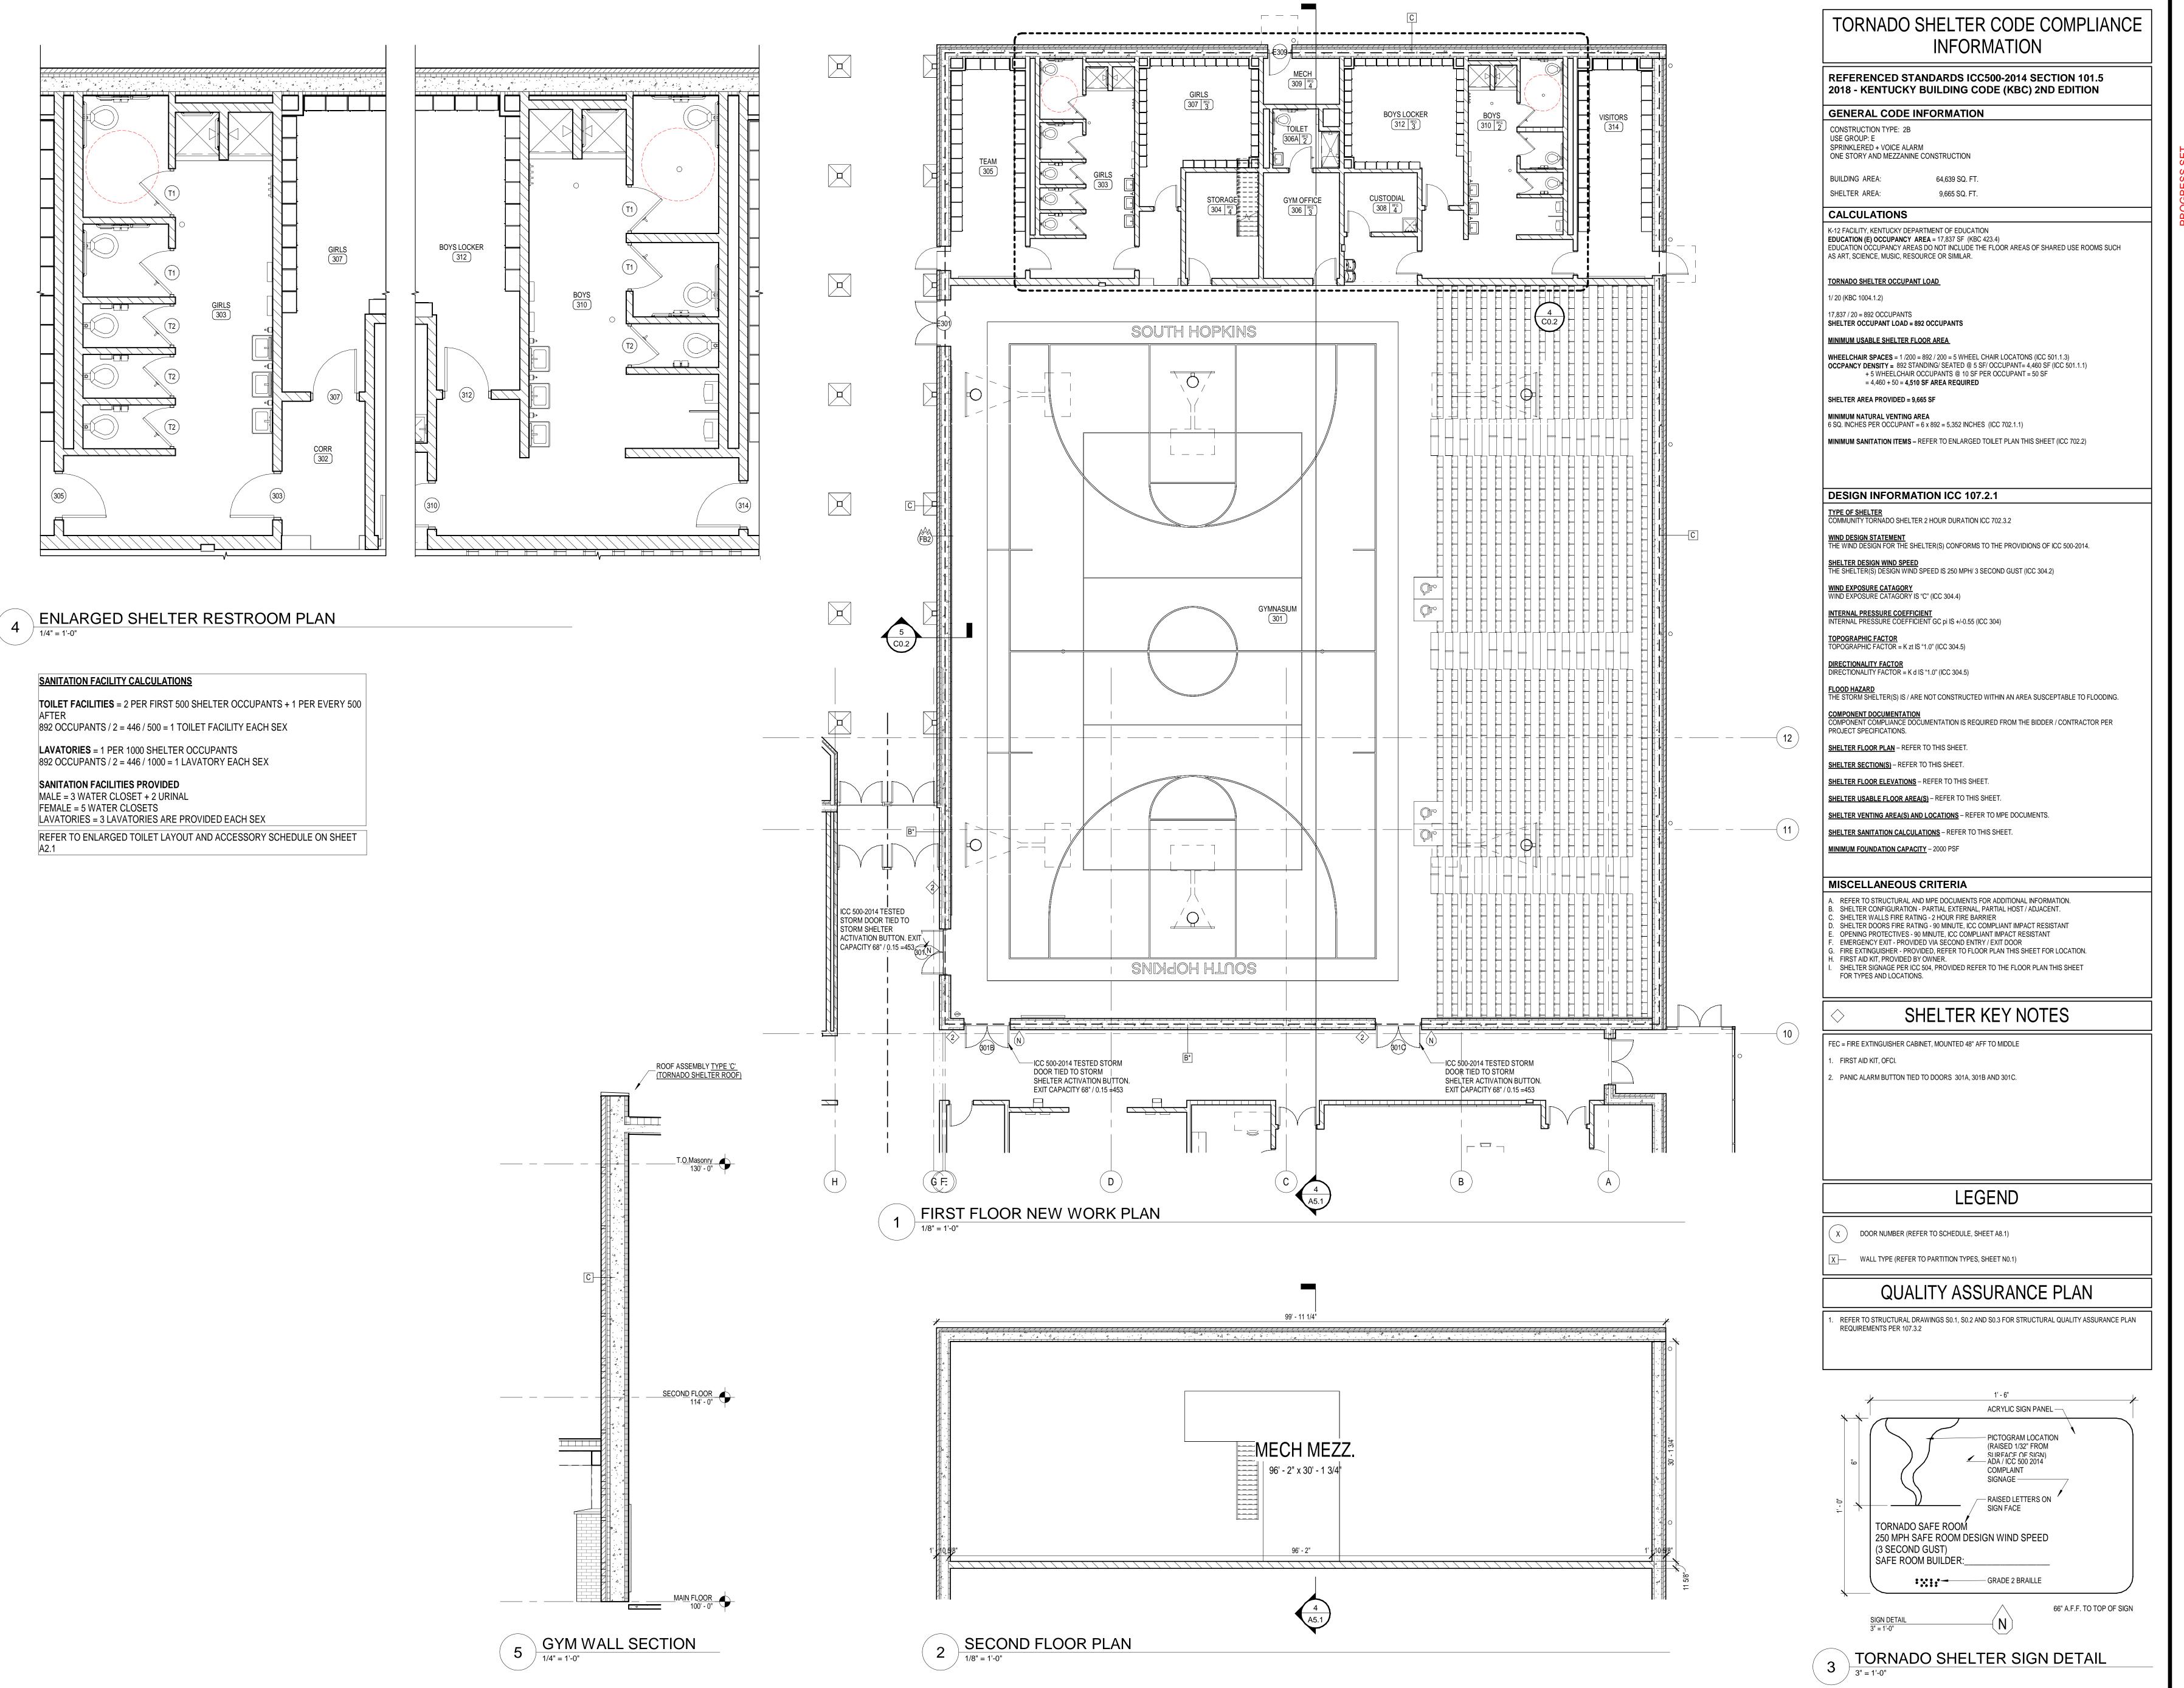

Z AMA $\Sigma \sqcup \mathbf{I}$ $\alpha \vdash z$ шсс IV


20 HOF NORT

REQUIREMENTS **TORNADO**

JOB NO. SEPT 11,2023 DRAWN CHECKED

SHERMAN CARTER BARNHAF ARCHITECTS, PLLC **REVISIONS**

SHEET

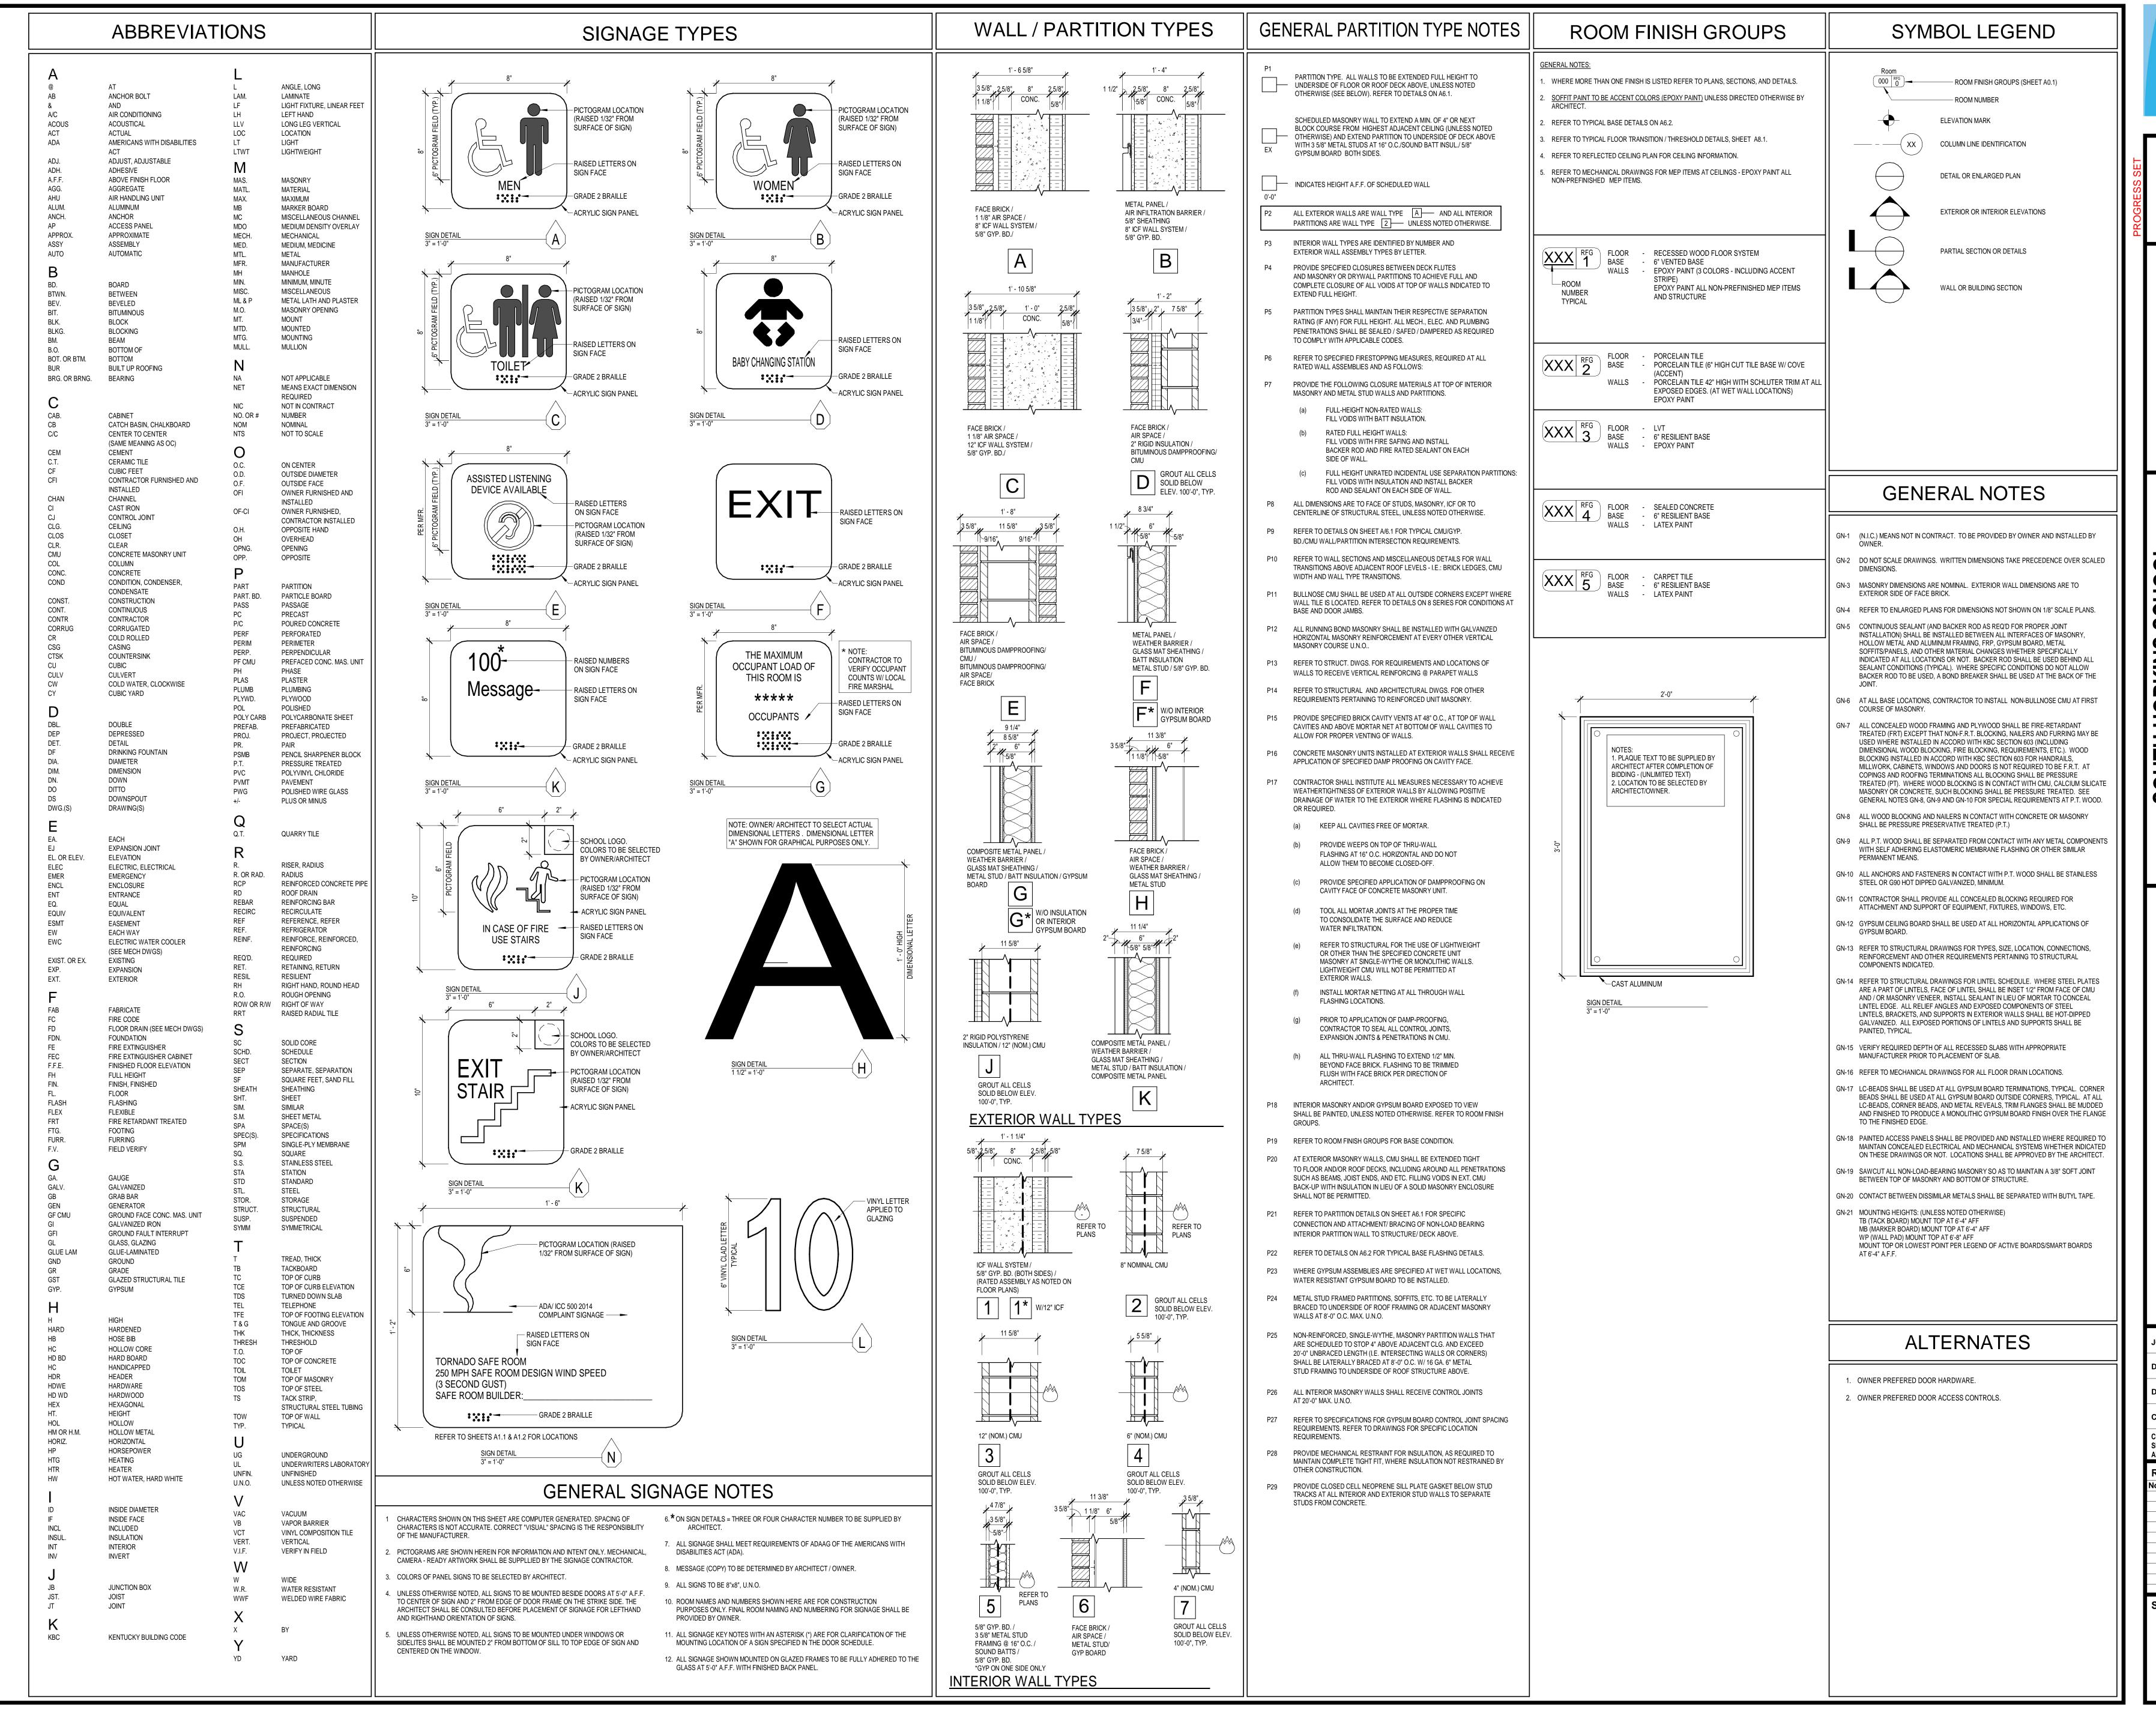

Z AMA $\Sigma \sqcup I$ $\alpha \vdash z$ шсс IVV S D M <

20 HOI NORT

LEGEND OL PA MB TION 9 BREV ENER

AN, DTB DRAWN CHECKED COPYRIGHT © 2023 SHERMAN CARTER BARNHAF ARCHITECTS, PLLC **REVISIONS** Description Date

FIRST FLOOR OVERALL PLAN - DEMO CALLOUTS

GENERAL DEMOLITION NOTES

- DEMOLITION REFERENCE NOTES FOR THIS PROJECT ARE INTENDED TO GENERALLY IDENTIFY THE SELECTIVE REMOVAL OF EXISTING ITEMS AT LOCATIONS WHERE REQUIRED BUT, SHALL IN NO WAY RELIEVE THE CONTRACTOR OF THE FULL RESPONSIBILITY FOR EXAMINING AND VERIFYING THE FULL EXTENT OF EXISTING CONDITIONS PRIOR TO BIDDING THE PROJECT
- THE INTENT OF THE DEMOLITION NOTES IS TO PROVIDE A GENERAL OUTLINE FOR THE CONTRACTOR OF ITEMS TO BE REMOVED AND/OR TURNED OVER TO THE OWNER AND TO ALLOW FOR THE NEW CONSTRUCTION AS OUTLINED ELSEWHERE IN THE CONTRACT DOCUMENTS. THE CONTRACTOR SHALL BE RESPONSIBLE FOR ALL DEMOLITION AND REMOVAL OF ITEMS TO ALLOW FOR NEW CONSTRUCTION SHOWN OR NOT SHOWN ON DEMOLITION PLANS AS MAY BE REQUIRED.
- CAVITY WALLS AND SPACES BEHIND EXTERIOR FINISHES OR PARTIALLY REMOVED WALLS/ROOFS, ETC. SHALL BE PROTECTED FROM EXPOSURE TO WEATHER BY THE CONTRACTOR. WALLS/ROOFS, ETC. SHALL BE PROTECTED. THE CONTRACTOR SHALL BE RESPONSIBLE FOR ANY DAMAGED WALLS, ROOFS, EQUIPMENT, ETC. CAUSED BY THIS DEMOLITION OR WEATHER EXPOSURE OF ITEMS THAT ARE TO REMAIN.
- INFORMATION AND DRAWINGS INCLUDED IN THESE CONTRACT DOCUMENTS PERTAINING TO HOPKINS COUNTY CENTRAL HIGH SCHOOL HAVE BEEN OBTAINED FROM ORIGINAL DRAWINGS PROVIDED BY HOPKINS COUNTY PUBLIC SCHOOLS. THIS INFORMATION IS INCLUDED HEREIN WITH THE INTENT TO PROVIDE THE CONTRACTOR WITH A BASIC UNDERSTANDING OF EXISTING CONDITIONS. ACTUAL CONDITIONS AND DIMENSIONS MAY VARY FROM THOSE INDICATED ON ORIGINAL DRAWINGS.
- REFER TO MECHANICAL AND/OR ELECTRICAL DRAWINGS AND SPECIFICATIONS FOR SPECIFIC REQUIREMENTS PERTAINING TO THE REMOVAL, RELOCATION AND/OR MODIFICATION OF ITEMS RELATED TO EXISTING MECHANICAL AND ELECTRICAL SYSTEMS.
- SHOULD THE CONTRACTOR ENCOUNTER ANY MATERIALS DURING SELECTIVE DEMOLITION AND NEW WORK WHICH ARE SUSPECTED BY THE CONTRACTOR TO BE OF AN UNKNOWN OR QUESTIONABLE COMPOSITION WITH RESPECT TO CONTAINING CONTAMINANTS, TOXIC MOLDS OR FUNGI WHICH MAY BE HAZARDOUS TO HUMAN HEALTH, THE CONTRACTOR SHALL IMMEDIATELY NOTIFY THE OWNER OF SUCH FINDINGS.
- WHERE AN EXISTING CMU WALL IS REMOVED AND NO NEW WALL IS SHOWN TO BE INSTALLED, REMOVE EXISTING CMU WALL TO 8 INCHES BELOW ADJACENT FLOOR SLAB. PATCH AND REPAIR SLAB AS REQUIRED FOR INSTALLATION OF NEW FLOOR FINISH. REFER TO NEW WORK PLANS.
- ALL AREAS LEFT EXPOSED AS A RESULT OF DEMOLITION AND/OR EQUIPMENT REMOVAL SHALL BE PATCHED AND REPAIRED TO RESULT IN A FLUSH SMOOTH SURFACE PREPARED TO RECEIVE NEW FINISHES AS SCHEDULED. ANY AREAS / OPENINGS IN MASONRY WALLS LARGER THAN 2" EXPOSED TO VIEW SHALL BE PATCHED WITH SOAPED IN CMU UNITS TOOTHED-IN INTO EXISTING MASONRY.
- CONTRACTOR SHALL BE RESPONSIBLE FOR ALL PATCHING AND REPAIRING DUE TO DEMOLITION AND/OR REMOVAL OF EQUIPMENT TO CREATE A FLUSH, SMOOTH SURFACE PROPERLY PREPARED TO RECEIVE NEW FINISHES AS SCHEDULED. CONTRACTOR SHALL SOAP IN NEW CMU TO MATCH EXISTING ADJACENT AREAS.
- . THE CONTRACTOR SHALL COORDINATE SPECIFIC DEMOLITION AND ASSOCIATED DATES WITH THE OWNER, REFER TO MECHANICAL / ELECTRICAL
- . UNLESS INDICATED OTHERWISE, ALL EXISTING FLOOR SLABS SHALL MEET NEW FLOOR SLABS AT THE SAME ELEVATION, WHERE NEW FINISHES SHALL BE INSTALLED FLUSH. CONTRACTOR SHALL VERIFY ALL EXISTING FLOOR SLABS FOR COMPLIANCE PRIOR TO PLACING NEW SLABS AT ASSUMED ELEVATIONS INDICATED.
- 2. REFER TO ROOF PLANS FOR ADDITIONAL ROOF DEMOLITION NOTES. 13. ALL EXISTING WORK TO BE SHADED.

DEMOLITION KEY NOTES

- REMOVE DOOR AND HARDWARE. HOLLOW METAL FRAME TO REMAIN. PREPARE FRAME FOR NEW WORK.
- DEMOLISH DOOR AND ALL ASSOC. COMPONENTS.
- AT NEW DOOR LOCATIONS NEW DOOR MASONRY OPENING TO INCLUDE DEMOLITION / REMOVAL OF EXISTING WALL TO 8-INCHES HIGHER AND WIDER AT EACH SIDE OF FRAME FOR NEW LINTEL INSTALLATION. ALSO SEE NEW WORK NOTES.
- DEMOLISH WALL & ASSOC. COMPONENTS.
- DEMOLISH EXISTING COOLER-LINED WALLS & ASSOC. COMPONENTS.
- DEMOLISH, PATCH, REPAIR, & PAINT EXIST. WALL AS REQUIRED FOR NEW CONDUIT INSTALLATION / PENETRATIONS. REFER TO MP&E DWGS.
- DEMOLISH EXISTING FIXTURE.
- REMOVE EXISTING CEILING, LIGHTING, SPRINKLER HEADS, & CLG. DIFFUSERS / DEVICES IN THIS AREA. REPLACE W/ 2'x2' SUSP. ACOUSTICAL CLG. SYSTEM & LIGHTING AS DESIGNATED.
- DEMOLISH EXISTING FLOOR MATERIAL TO EXISITNG SLAB & PREP. FOR NEW
- D. PREP. EXISTING WALL FOR NEW CONSTRUCTION.
- 2. SALVAGE EXISTING KITCHEN EQUIPMENT TO BE REUSED IN NEW WORK.

. REMOVE EXISTING KITCHEN EQUIPMENT AS REQ.

3. DEMOLISH EXISTING SOFFIT, FASCIA, GUTTER & PREP. FOR NEW WORK.

HAZARDOUS MATERIALS & TOXIC SUBSTANCES NOTES

UE TO THE AGE OF THE EXISTING BUILDINGS, IT IS POSSIBLE HAZARDOUS MATERIALS OR TOXIC SUBSTANCES / MOLDS MAY EXIST. THIS INCLUDES BUT IS NOT LIMITED TO ASBESTOS PRODUCTS, POLYCHLORINATED BIPHENYL (PCB), AND OTHER TOXIC SUBSTANCES. IF ANY WORK PERSON ENCOUNTERS ANY MATERIAL OR SUBSTANCE WHICH THEY SUSPECT MIGHT BE HAZARDOUS OR TOXIC, THEY SHALL IMMEDIATELY ADVISE THE OWNER. THE CONTRACTOR SHALL TAKE IMMEDIATE AND APPROPRIATE ACTION TO PROTECT THE BUILDING USERS AND WORKERS IN ACCORDANCE WITH EDERAL, STATE AND LOCAL LAWS, CODES AND REGULATIONS. THE ARCHITECT AND ARCHITECT'S CONSULTANTS SHALL HAVE NO RESPONSIBILITY FOR THE DISCOVERY, PRESENCE, HANDLING, REMOVAL OR DISPOSAL OF OR EXPOSURE OF PERSONS TO HAZARDOUS MATERIALS OR TOXIC SUBSTANCES IN ANY FORM AT THE PROJECT SITE, NCLUDING BUT NOT LIMITED TO ASBESTOS, ASBESTOS PRODUCTS, POLYCHLORINATEI BIPHENYL (PCB), OTHER TOXIC SUBSTANCES, OR TOXIC MOLDS.

- THE CONTRACTOR IS HEREBY ADVISED THAT SHERMAN-CARTER-BARNHART, PLLC IS NOT A DESIGN PROFESSIONAL IN THE DETERMINATION OF THE PRESENCE OF HAZARDOUS MATERIALS, NOR IS SHERMAN-CARTER-BARNHART, PLLC A DESIGN PROFESSIONAL INVOLVED IN MAKING RECOMMENDATIONS REGARDING THE TESTING, REMOVAL, ENCAPSULATION
- OR OTHER CORRECTIVE MEASURES PERTAINING TO HAZARDOUS MATERIALS OR TOXIC MOLDS / SUBSTANCES. IF THE WORK WHICH IS TO BE PERFORMED UNDER THE CONTRACT INTERFACES IN ANY WAY WITH THE EXISTING COMPONENTS WHICH CONTAIN HAZARDOUS MATERIALS OR TOXIC SUBSTANCES, IT IS THE CONTRACTOR'S RESPONSIBILITY TO CONTACT THE OWNER'S ENVIRONMENTAL CONSULTANT

REGARDING THE PROPER MEANS AND METHODS TO BE UTILIZED IN DEALING

- WITH HAZARDOUS MATERIALS AND SUBSTANCES. BY EXECUTION OF THE CONTRACT FOR CONSTRUCTION, THE CONTRACTOR HEREBY AGREES TO BRING NO CLAIM FOR NEGLIGENCE, BREACH OF CONTRACT, INDEMNITY OR OTHERWISE AGAINST THE ARCHITECT, HIS PRINCIPALS, EMPLOYEES, AGENTS OR CONSULTANTS IF SUCH A CLAIM IN ANY WAY WOULD INVOLVE THE INVESTIGATION OF OR REMEDIAL WORK RELATED
- TO HAZARDOUS MATERIALS OR TOXIC SUBSTANCES IN THE PROJECT. BY EXECUTION OF THE CONTRACT FOR CONSTRUCTION, THE CONTRACTOR FURTHER AGREES TO DEFEND, INDEMNIFY AND HOLD THE ARCHITECT, HIS PRINCIPALS, EMPLOYEES, AGENTS AND CONSULTANTS HARMLESS FROM ANY SUCH ASBESTOS, OTHER HAZARDOUS MATERIALS, OR TOXIC SUBSTANCES / MOLD RELATED CLAIMS THAT MAY BE BROUGHT BY THE CONTRACTOR'S SUBCONTRACTORS, SUPPLIERS OR OTHER THIRD PARTIES WHO MAY BE ACTING UNDER THE DIRECTION OF THE CONTRACTOR PURSUANT TO THIS

DEMOLITION SYMBOL LEGEND

DEMOLITION KEY NOTE

EXISTING WALL / CONSTRUCTION TO REMAIN

= \(\triangle \) EXISTING CONSTRUCTION TO BE REMOVED - FULL HEIGHT U.N.O. SEE SELECTIVE DEMOLITION NOTES

& EXISTING DOOR / DOOR & FRAME TO REMAIN

EXISTING DOOR / DOOR & FRAME TO BE REMOVED, U.N.O. LIMITED TO NO ARCHITECTURAL WORK. EXISTING FINISHES TO

REMAIN U.N.O. REFER TO MEP FOR MEP WORK THAT MAY BE

SAWCUT EXISTING CONCRETE SLAB FOR NEW MECHANICAL WORK. CONTRACTOR TO ASSURE THAT ADEQUATE SOIL COMPACTION IS ACHIEVED BEFORE PLACING NEW

WORK. PROVIDE NEW REINFORCEMENT, SUBGRADE AND CONCRETE PER STRUCTURAL RECOMMENDATIONS.

ZC ARA ΣWΙ $\alpha \vdash z$ шкк IV S C M <


9220 HOF NORT

DEMOLITION

CRG DRAWN CHECKED

COPYRIGHT © 2023 SHERMAN CARTER BARNHART ARCHITECTS, PLLC REVISIONS No. Description Date

SHEET

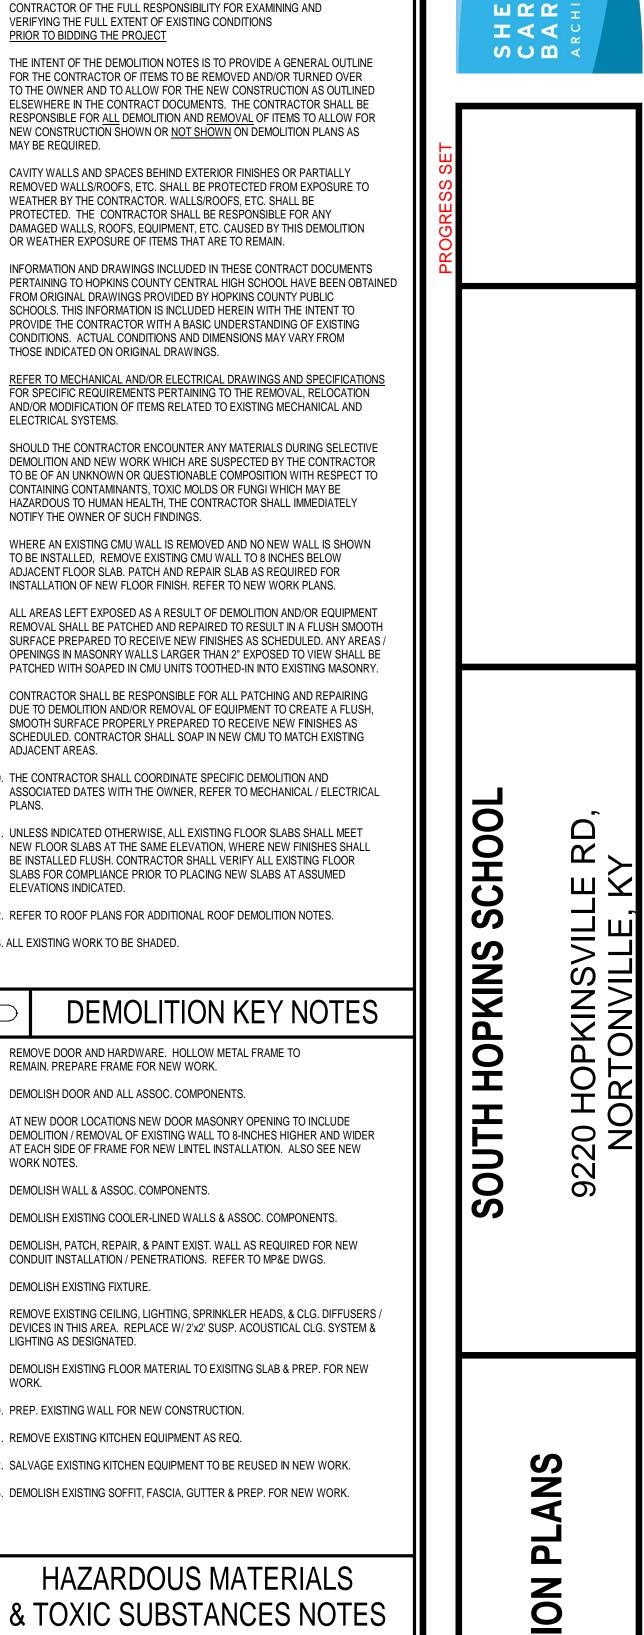

Z

AMA

 $\Sigma \sqcup \mathbf{I}$

 $\alpha \vdash z$

GENERAL DEMOLITION NOTES

DEMOLITION REFERENCE NOTES FOR THIS PROJECT ARE INTENDED TO

GENERALLY IDENTIFY THE SELECTIVE REMOVAL OF EXISTING ITEMS AT

LOCATIONS WHERE REQUIRED BUT, SHALL IN NO WAY RELIEVE THE


PRIOR TO BIDDING THE PROJECT

EXISTING FOOD SERVICE

EQUIPMENT SCHEDULE


NO. DESCRIPTION


WALK-IN COOLER/FREEZER

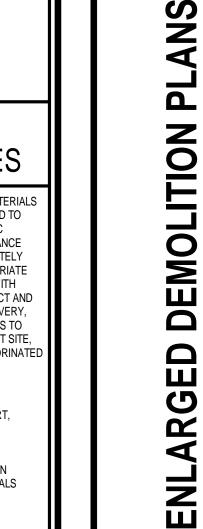


SEPT 11,2023 CRG DRAWN CHECKED COPYRIGHT © 2023 SHERMAN CARTER BARNHART ARCHITECTS, PLLC REVISIONS No. Description Date

SHEET

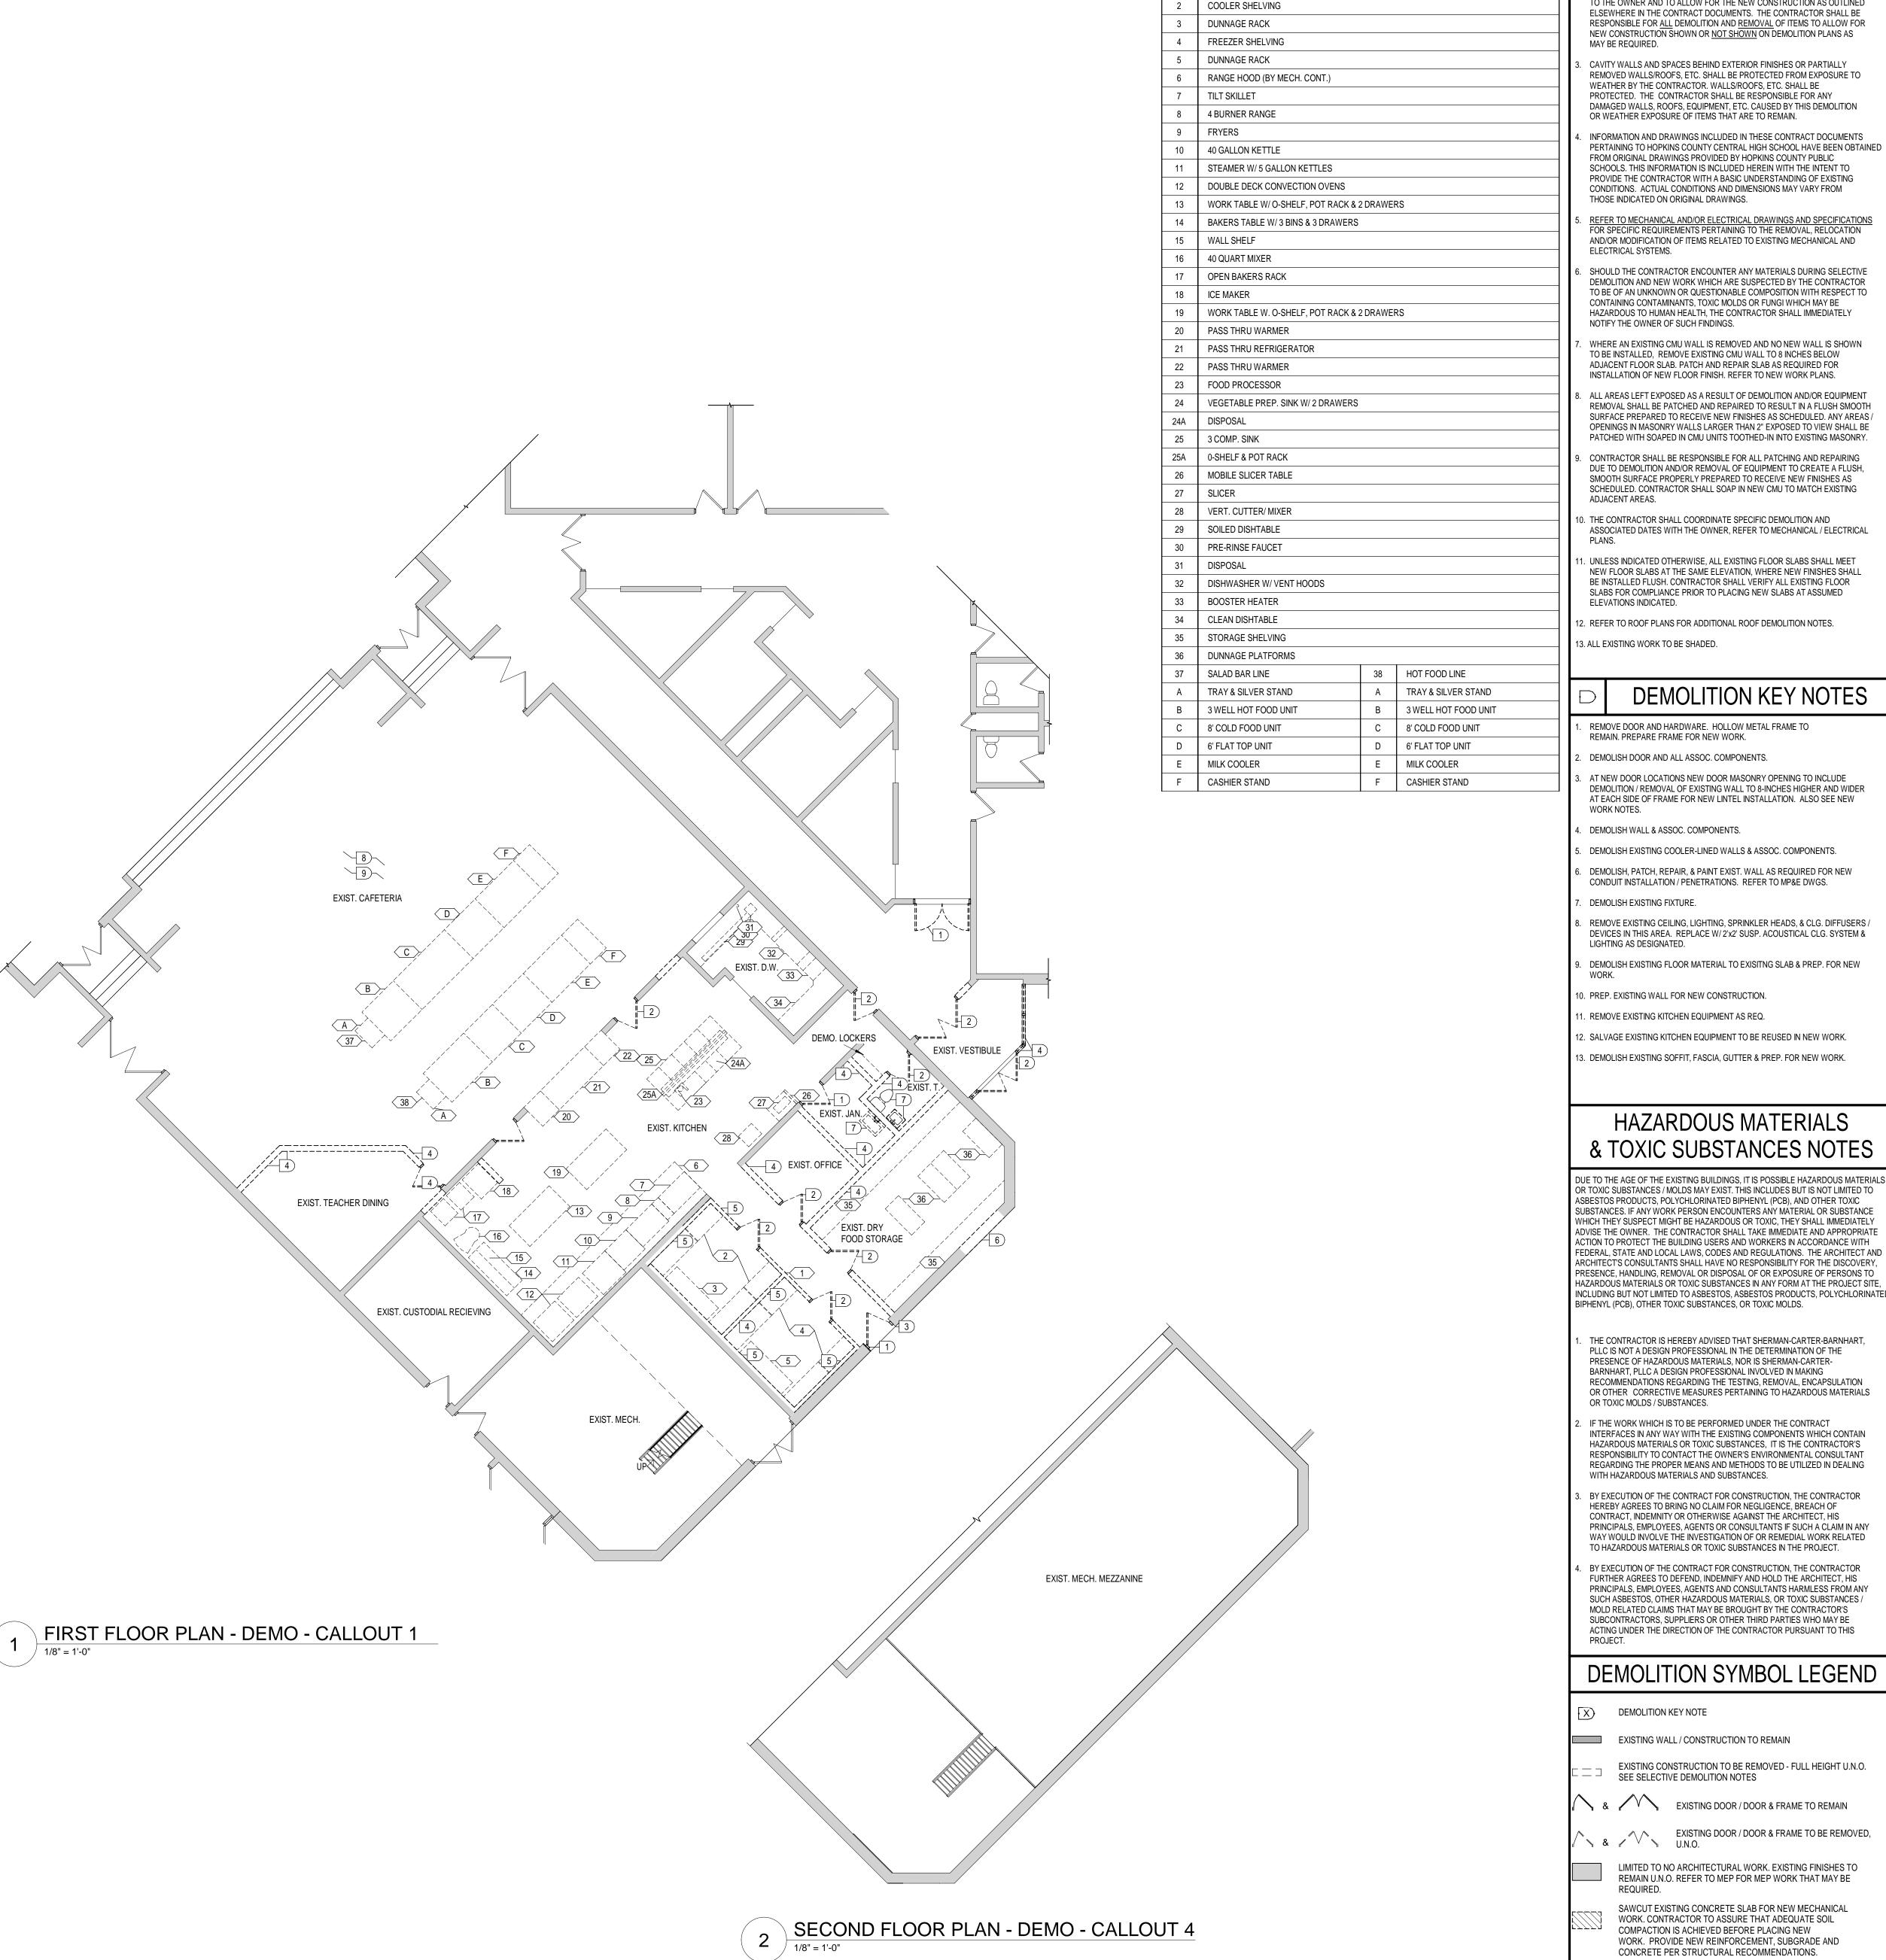

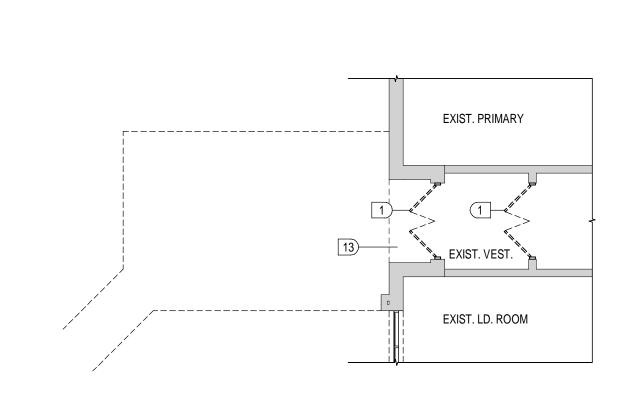


FIRST FLOOR PLAN - DEMO - CALLOUT 2

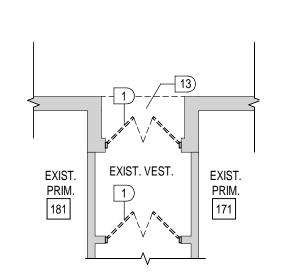


FIRST FLOOR PLAN - DEMO - CALLOUT 3

1/8" = 1'-0"

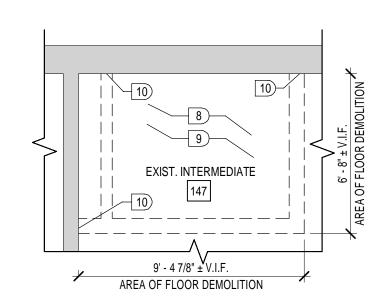


5 FIRST FLOOR PLAN - DEMO - CALLOUT 5

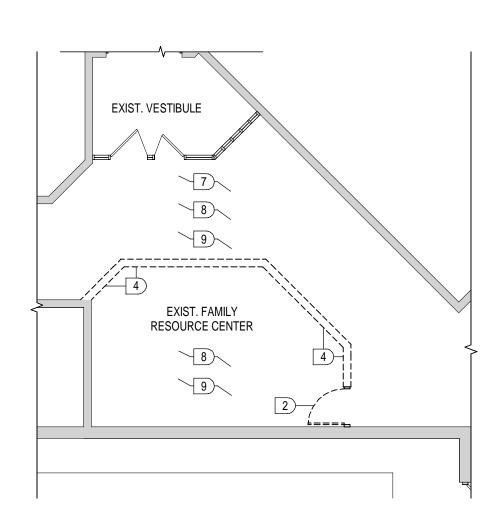

6 FIRST FLOOR PLAN - DEMO - CALLOUT 6

2246 SOUTH HOPKINS SCH 9/11/2023 2:57:18 PM

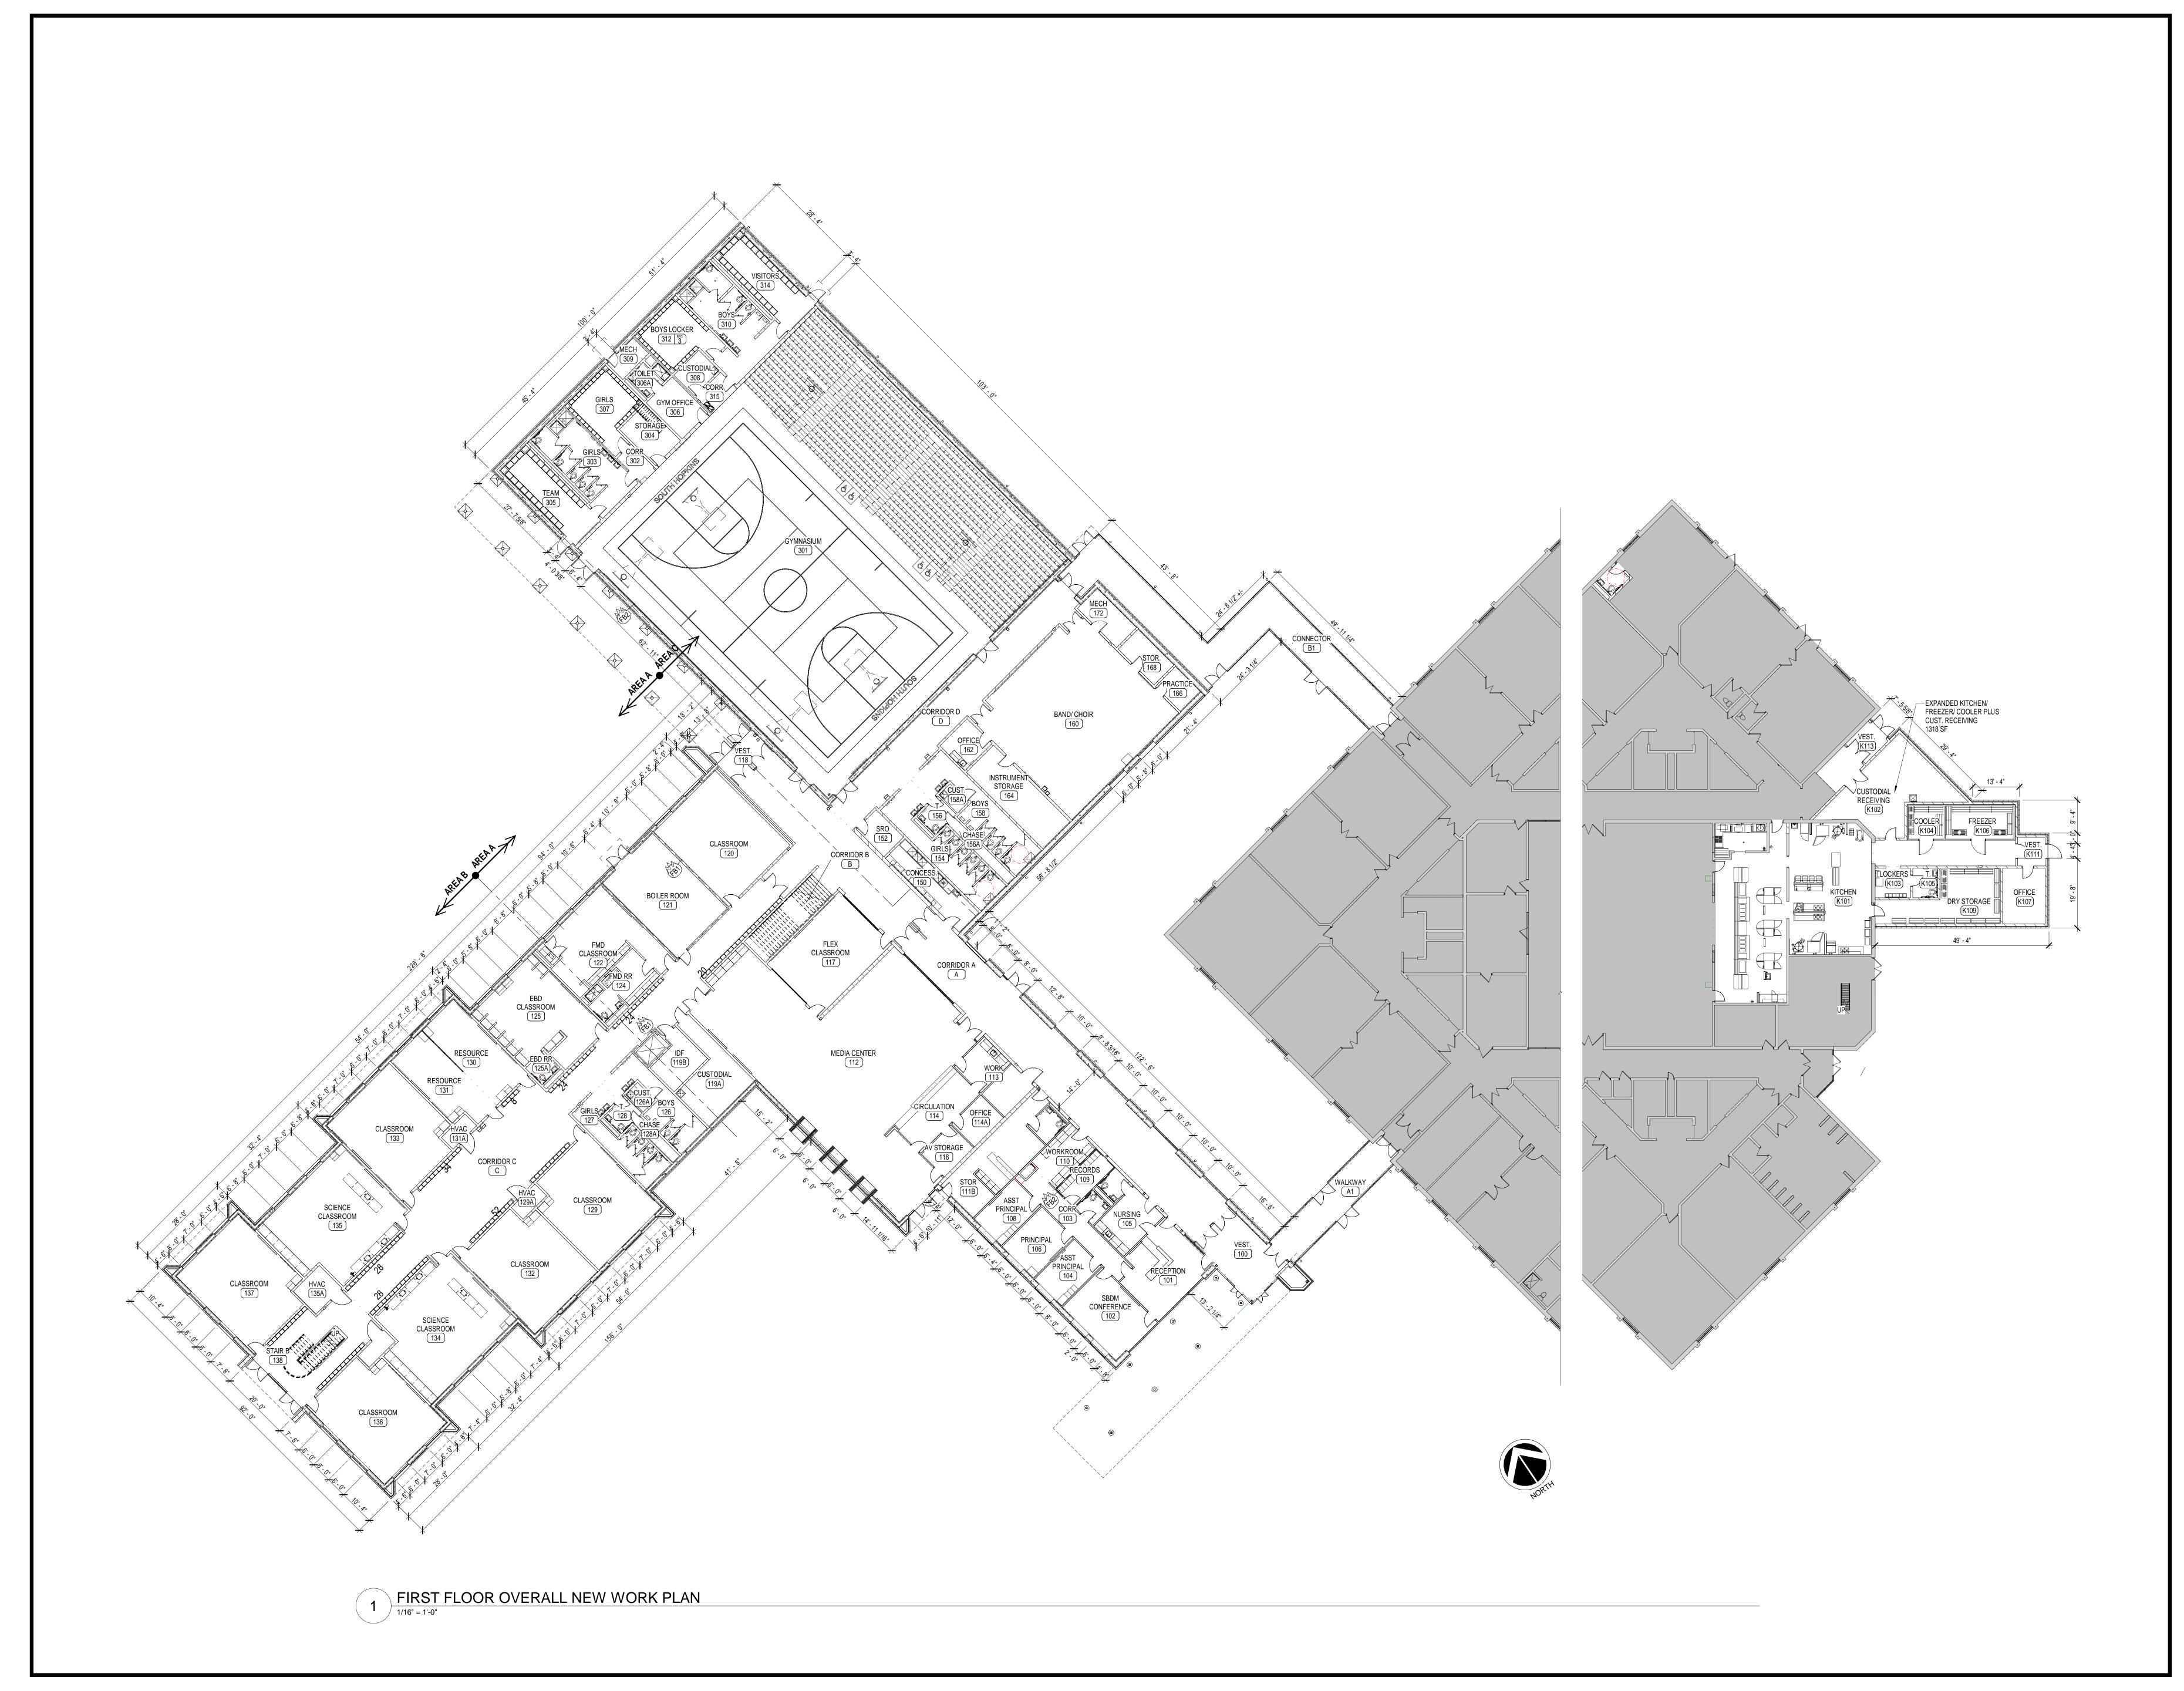

2246 SOUTH HOPKINS SCHOOL 9/11/2023 2:57:43 PM SHERMAN CARTER BARNHART ARCHITECTS

9220 HOPKINSVILLE R

FIRST FLOOR OVERALL PLA

JOB NO. 2246

DATE SEPT 11,2023

DRAWN AN

CHECKED AHO

COPYRIGHT © 2023
SHERMAN CARTER BARNHART
ARCHITECTS, PLLC

REVISIONS

No. Description Date

1 ASI Date 1

SHEET

A0.1



1 SECOND FLOOR OVERALL NEW WORK PLAN

1/16" = 1'-0"

2246 SOUTH HOPKINS SCHOOL 9/11/2023 2:57:49 PM SHERMAN CARTER BARNHART ARCHITECTS

SOUTH HOPKINS SCHOOL
9220 HOPKINSVILLE RD,
NORTONVILLE, KY

SECOND FLOOR OVERALL PLAN

JOB NO. 2246

DATE SEPT 11,2023

DRAWN AN

CHECKED AHO

COPYRIGHT © 2023
SHERMAN CARTER BARNHART
ARCHITECTS, PLLC

REVISIONS

No. Description Date

SHEET

A0.2



- REFER TO MECH./ELEC. DRAWINGS FOR SPECIFIC NOTES REGARDING MECH/ELEC.
- ITEMS NOT SHOWN ON THIS SHEET. 2. REFER TO ROOF PLAN AND MECH. DRAWINGS FOR ADDITIONAL INFORMATION
- REGARDING WORK AT ROOF.
- 3. REFER TO SHEET N0.1 FOR GENERAL NOTES AND PARTITION TYPES.
- 4. REFER TO DETAILS ON SHEET A6.1 FOR TYPICAL WALL INTERSECTION DETAILS.
- 5. REFER TO SHEET A2.5 FOR TOILET ACCESSORY SCHEDULE.
- 6. REFER TO A2.7 FOR CASEWORK LEGEND AND NOTES.

PLAN KEY NOTES

- NOTE: NOT ALL KEYNOTES MAY APPLY TO THIS SHEET.
- . GYP. BD. BULKHEAD OR SOFFIT ABOVE. REFER TO REFLECTED CLG. PLANS.
- . LINE OF BLEACHERS IN RETRACTED POSITION. . FLOOR TRANSITION. REFER TO SHEET A9.1 FOR DETAILS. 4. LINE OF PRE-ENG. PRE-FIN. ALUM. CANOPY ABOVE OR BELOW. REFER TO DETAIL
- 5. SHELVING / FURNISHINGS / EQUIPMENT PROVIDED BY OWNER, N.I.C.6. FIRE ALARM PANEL. REFER TO ELECTRICAL DWGS.
- BASKETBALL GOAL ABOVE, REFER TO SPECS AND REFLECTED CEILING PLAN FOR MOUNTING CONDITION. ALL EXPOSED BLOCKING REQUIRED FOR GOAL.
- ATTACHMENT SHALL BE PAINTED TO MATCH ADJACENT WALL COLOR. 9. WASHER/DRYER, N.I.C. 10. FOLDABLE WALL PARTITION. REFER TO DETAIL ON A7.1 FOR CEILING CONDITION.
- 12. ELECTRICALLY OPERATED FOLDING BLEACHERS, REFER TO SPECIFICATIONS AND DETAIL 4/A1.2.
- 13. SCORERS TABLE (N.I.C.) 14. ADULT CHANGING TABLE
- 15. ATHLETIC WALL PADS FOR LIMITS SHOWN, REFER TO SPECIFICATIONS. ROOF ABOVE.
- 17. WALL MOUNTED COUNTERTOP, REFER TO DETAIL 14/A2.7. 18. COMPUTER STATION, N.I.C. REFER TO ELECTRICAL DWGS. FOR DATA AND
- 19. HIGH/LOW WATER FOUNTAIN UNIT. REFER TO MECH./ELEC. DRAWINGS. 20. INDUSTRIAL STAIR PER OSHA STANDARDS. REFER TO REFERENCED DETAIL AND
- 21. SCOREBOARD ABOVE AT 11'-0" A.F.F. (TO B.O. SCOREBOARD). REFER TO
- SPECIFICATIONS AND ELECTRICAL DRAWINGS.
 22. ROOF HATCH ABOVE. SEE DETAIL _____.
- 23. MECHANICAL LOUVER. REFER TO DETAIL 8/A6.2.
- 24. RECESSED CONCRETE FLOOR SLAB IN THIS AREA. REFER TO STRUCTURAL DWGS. 25. ELECTRIC PUSH-BUTTON ADA DOOR OPERATOR. REFER TO ELEC. DWGS.
- 26. DOOR ACCESS CONTROL LOCATION.27. VOLLEYBALL FLOOR INSERTS, FLUSH WITH WOOD FLOOR.
- 28. PRE-FIN. ALUM. FIXED WALL LADDER. REFER TO _______ 29. DOUBLE TIER STUDENT LOCKERS.
- ATHLETIC LOCKERS. 31. SINGLE TIER LOCKERS.
- 32. RETRACTABLE GYMNASIUM DIVIDER, REFER TO SPECIFICATIONS. 33. AREA OF NEW FLOOR INFILL. REFER TO STRUCTURE. 34. PAINT EXISTING WALL MATCHING THE EXISITNG WALL COLOR.
- 35. CANOPY ABOVE. REFER TO SHEET A5.2. 36. ADULT CHANGING TABLE, N.I.C.

SYMBOLS LEGEND

Name

101 # ROOM FINISH GROUPS (REFER TO SHEET N0.1)

- ROOM NUMBER

DOOR NUMBER (DOOR SCHEDULE SHEET A8.1)

NEW WORK KEY NOTES (SHEETS A1.1 THROUGH A2.2)

WALL TYPE (SCHEDULE SHEET N-1) ALUMINUM OR HOLLOW METAL FRAME OR STOREFRONT TYPE (REFER TO

FLOOR PLANS AND SCHEDULE SHEETS A8.1-A8.2)

TOILET ACCESSORIES (SCHEDULE SHEET A2.2)

ELEVATION KEY NOTE (SHEET A3.1-A3.3) ROOF KEY NOTE (SHEET A4.1)

CEILING PLAN KEY NOTE (SHEETS A7.1-A7.6)

SIGNAGE KEY NOTE (SHEETS A0.1) DASHED LINE INDICATES WALL TILE AT RESTROOMS

— — AND BRADLEY SINK WALLS - SHOWN ON RESTROOM PLANS. (TILE WALL DETAIL 21/A2.4)

FB2 2 HOUR FIRE BARRIER FW2 2 HOUR FIRE WALL


CONTROL JOINT, REFER TO EXTERIOR ELEVATIONS FOR EXTERIOR

BOARD SCHEDULE

TB - TACKBOARD, IN CONTRACT.

MB - MARKERBOARD, IN CONTRACT.

- IB INTERACTIVE BOARD, OFCI. COORDINATE LOCATION & SIZE WITH OWNER.
- TV TELEVISION, OFCI. COORDINATE LOCATION & SIZE WITH OWNER. MOUNT MULTIMEDIA BOX AT HEIGHT INDICATED, 5'-0" A.F.F. U.N.O.
- VW VIDEO WALL, OFCI, COORDINATE LOCATION & SIZE WITH OWNER. REFER TO ELECTRICAL.

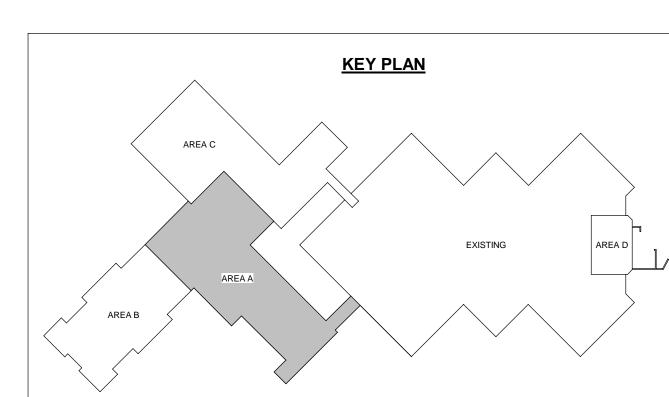

ΣШΙ $\alpha \vdash z$ шкк I 4 4 0 S C M ∠

ZC **444**

.00R

DRAWN CHECKED COPYRIGHT © 2023 SHERMAN CARTER BARNHAF ARCHITECTS, PLLC

REVISIONS

ZC

шкк


Iddo

S C M ∠

SHEET

DRAWN

SHEET **A1.2**

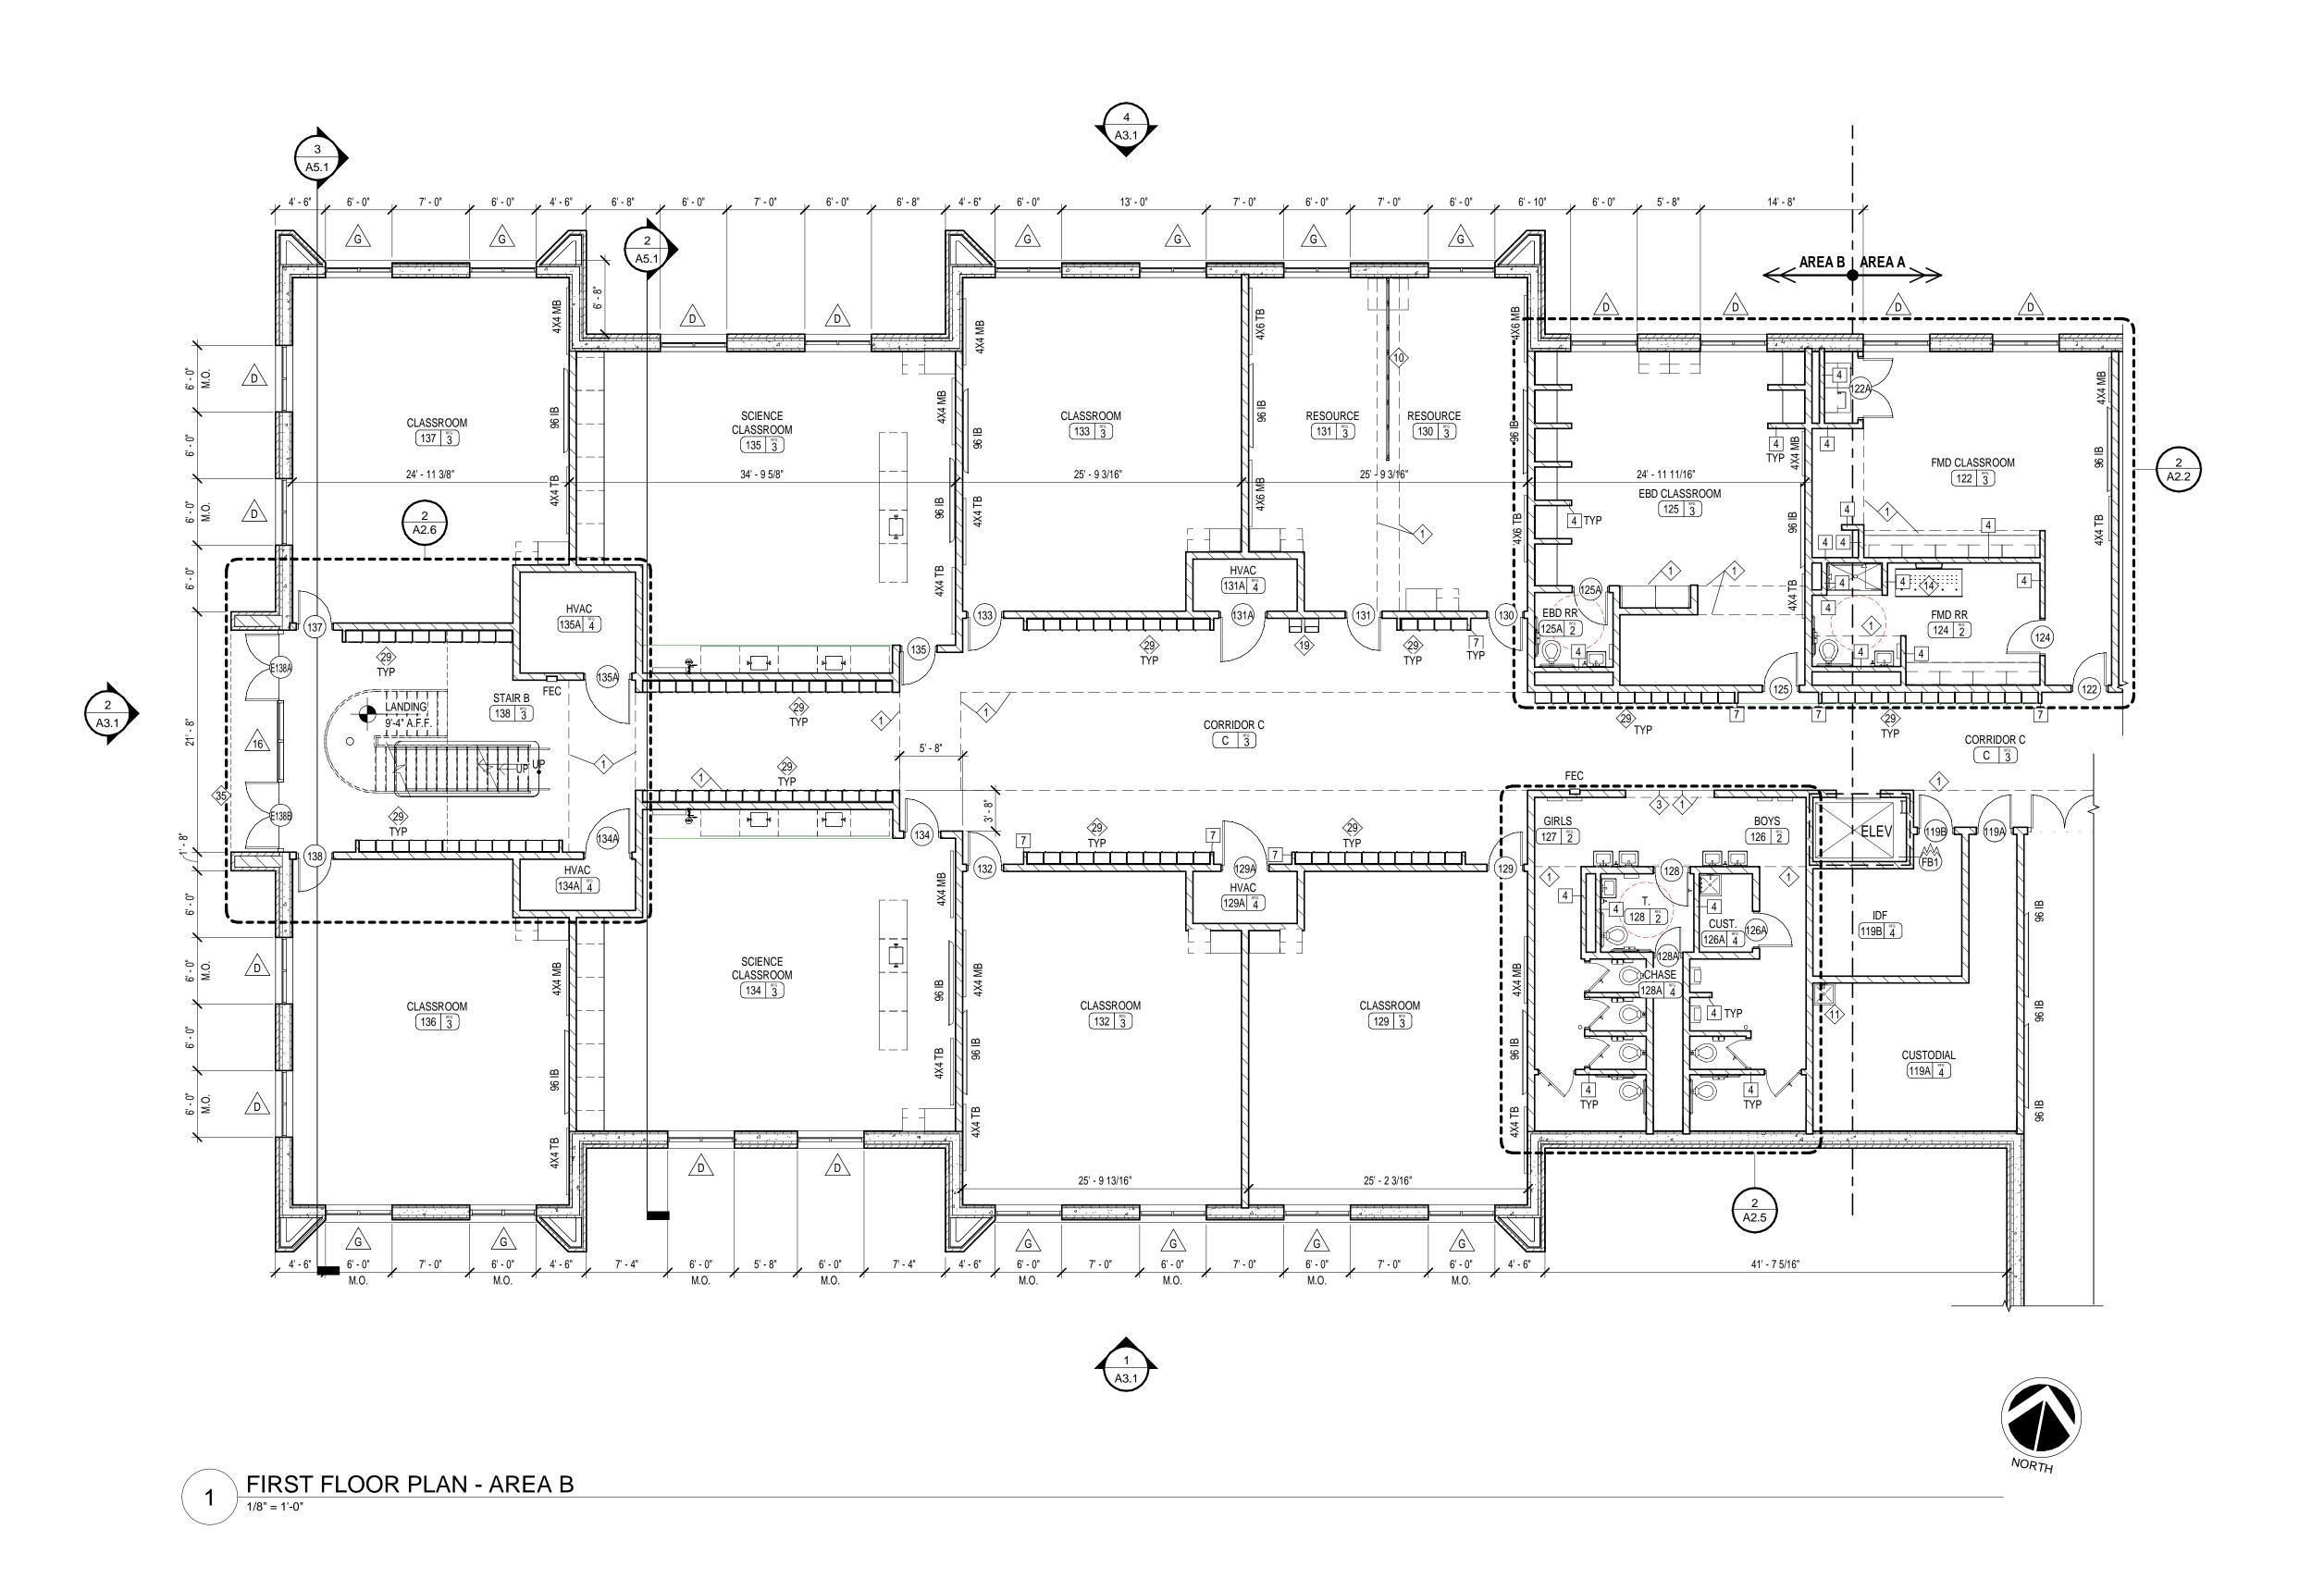

2246 SOUTH HOPKINS SCHOOL 9/11/2023 2:57:58 PM GENERAL WORK NOTES

REFER TO MECH./ELEC. DRAWINGS FOR SPECIFIC NOTES REGARDING MECH/ELEC. ITEMS NOT SHOWN ON THIS SHEET.

REFER TO ROOF PLAN AND MECH. DRAWINGS FOR ADDITIONAL INFORMATION REGARDING WORK AT ROOF.

3. REFER TO SHEET N0.1 FOR GENERAL NOTES AND PARTITION TYPES.

REFER TO SHEET NO.11 OR GENERAL NOTES AND PARTITION TIPES.
 REFER TO DETAILS ON SHEET A6.1 FOR TYPICAL WALL INTERSECTION DETAILS.

5. REFER TO SHEET A2.5 FOR TOILET ACCESSORY SCHEDULE.

6. REFER TO A2.7 FOR CASEWORK LEGEND AND NOTES.

NOTE: NOT ALL KEYNOTES MAY APPLY TO THIS SHEET.

GYP. BD. BULKHEAD OR SOFFIT ABOVE. REFER TO REFLECTED CLG. PLANS.
 LINE OF BLEACHERS IN RETRACTED POSITION.

LINE OF BLEACHERS IN RETRACTED POSITION.
 FLOOR TRANSITION. REFER TO SHEET A9.1 FOR DETAILS.
 LINE OF PRE-ENG. PRE-FIN. ALUM. CANOPY ABOVE OR BELOW. REFER TO DETAIL

SHELVING / FURNISHINGS / EQUIPMENT PROVIDED BY OWNER, N.I.C.
 FIRE ALARM PANEL. REFER TO ELECTRICAL DWGS.
 LOGO

 LOGO
 BASKETBALL GOAL ABOVE, REFER TO SPECS AND REFLECTED CEILING PLAN FOR MOUNTING CONDITION. ALL EXPOSED BLOCKING REQUIRED FOR GOAL. ATTACHMENT SHALL BE PAINTED TO MATCH ADJACENT WALL COLOR.

WASHER/DRYER, N.I.C.
 FOLDABLE WALL PARTITION. REFER TO DETAIL ON A7.1 FOR CEILING CONDITION.
 UTILITY SINK.
 ELECTRICALLY OPERATED FOLDING BLEACHERS, REFER TO SPECIFICATIONS AND

DETAIL 4/A1.2.

13. SCORERS TABLE (N.I.C.)

14. ADULT CHANGING TABLE.

14. ADULT CHANGING TABLE.15. ATHLETIC WALL PADS FOR LIMITS SHOWN, REFER TO SPECIFICATIONS.16. ROOF ABOVE.

17. WALL MOUNTED COUNTERTOP, REFER TO DETAIL 14/A2.7.18. COMPUTER STATION, N.I.C. REFER TO ELECTRICAL DWGS. FOR DATA AND ELECTRIC.

HIGH/LOW WATER FOUNTAIN UNIT. REFER TO MECH./ELEC. DRAWINGS.
 INDUSTRIAL STAIR PER OSHA STANDARDS. REFER TO REFERENCED DETAIL AND PLAN.

21. SCOREBOARD ABOVE AT 11'-0" A.F.F. (TO B.O. SCOREBOARD). REFER TO SPECIFICATIONS AND ELECTRICAL DRAWINGS.
22. ROOF HATCH ABOVE. SEE DETAIL _____.

23. MECHANICAL LOUVER. REFER TO DETAIL 8/A6.2.
24. RECESSED CONCRETE FLOOR SLAB IN THIS AREA. REFER TO STRUCTURAL DWGS.
25. ELECTRIC PUSH-BUTTON ADA DOOR OPERATOR. REFER TO ELEC. DWGS.

26. DOOR ACCESS CONTROL LOCATION.
27. VOLLEYBALL FLOOR INSERTS, FLUSH WITH WOOD FLOOR.
28. PRE-FIN. ALUM. FIXED WALL LADDER. REFER TO _______.
29. DOUBLE TIER STUDENT LOCKERS.

30. ATHLETIC LOCKERS.31. SINGLE TIER LOCKERS.32. RETRACTABLE GYMNASIUM DIVIDER, REFER TO SPECIFICATIONS.

33. AREA OF NEW FLOOR INFILL. REFER TO STRUCTURE.
34. PAINT EXISTING WALL MATCHING THE EXISITNG WALL COLOR.
35. CANOPY ABOVE. REFER TO SHEET A5.2.
36. ADULT CHANGING TABLE, N.I.C.

SYMBOLS LEGEND

Name
101 # ROOM FINISH GROUPS (REFER TO SHEET N0.1)

DOOR NUMBER (DOOR SCHEDULE SHEET A8.1)

- ROOM NUMBER

WALL TYPE (SCHEDULE SHEET N-1)

ALUMINUM OR HOLLOW METAL FRAME OR STOREFRONT TYPE (REFER TO

NEW WORK KEY NOTES (SHEETS A1.1 THROUGH A2.2)

FLOOR PLANS AND SCHEDULE SHEETS A8.1-A8.2)

TOILET ACCESSORIES (SCHEDULE SHEET A2.2)

ELEVATION KEY NOTE (SHEET A3.1-A3.3)

ROOF KEY NOTE (SHEET A4.1)

CEILING PLAN KEY NOTE (SHEETS A7.1-A7.6)

X) SIGNAGE KEY NOTE (SHEETS A0.1)

DASHED LINE INDICATES WALL TILE AT RESTROOMS
AND BRADLEY SINK WALLS - SHOWN ON RESTROOM PLANS.

(TILE WALL DETAIL 21/A2.4)

ROOM / WALL DESIGNATION
FB1 1 HOUR FIRE BARRIER

FB2 2 HOUR FIRE BARRIER

FW2 2 HOUR FIRE WALL

CONTROL JOINT, REFER TO EXTERIOR ELEVATIONS FOR EXTERIOR
LOCATIONS

BOARD SCHEDULE

TB - TACKBOARD, IN CONTRACT.

MB - MARKERBOARD, IN CONTRACT.

IB - INTERACTIVE BOARD, OFCI. COORDINATE LOCATION & SIZE WITH OWNER.

TV - TELEVISION, OFCI. COORDINATE LOCATION & SIZE WITH OWNER. MOUNT MULTIMEDIA BOX AT HEIGHT INDICATED, 5'-0" A.F.F. U.N.O.

VW - VIDEO WALL, OFCI, COORDINATE LOCATION & SIZE WITH OWNER. REFER TO ELECTRICAL.

GENERAL WORK NOTES

Z

A R A ΣШΙ $\alpha \vdash z$

шсс Idd

S C M <

PKINSVILI ONVILLE,

- REFER TO MECH./ELEC. DRAWINGS FOR SPECIFIC NOTES REGARDING MECH/ELEC.
- ITEMS NOT SHOWN ON THIS SHEET. 2. REFER TO ROOF PLAN AND MECH. DRAWINGS FOR ADDITIONAL INFORMATION
 - REGARDING WORK AT ROOF.
- 3. REFER TO SHEET NO.1 FOR GENERAL NOTES AND PARTITION TYPES.
- 4. REFER TO DETAILS ON SHEET A6.1 FOR TYPICAL WALL INTERSECTION DETAILS.
- 5. REFER TO SHEET A2.5 FOR TOILET ACCESSORY SCHEDULE.
- 6. REFER TO A2.7 FOR CASEWORK LEGEND AND NOTES.

PLAN KEY NOTES

- NOTE: NOT ALL KEYNOTES MAY APPLY TO THIS SHEET.
- 1. GYP. BD. BULKHEAD OR SOFFIT ABOVE. REFER TO REFLECTED CLG. PLANS. 2. LINE OF BLEACHERS IN RETRACTED POSITION.
- 3. FLOOR TRANSITION. REFER TO SHEET A9.1 FOR DETAILS. 4. LINE OF PRE-ENG. PRE-FIN. ALUM. CANOPY ABOVE OR BELOW. REFER TO DETAIL
- 5. SHELVING / FURNISHINGS / EQUIPMENT PROVIDED BY OWNER, N.I.C. 6. FIRE ALARM PANEL. REFER TO ELECTRICAL DWGS.
- 7. LOGO 8. BASKETBALL GOAL ABOVE, REFER TO SPECS AND REFLECTED CEILING PLAN FOR MOUNTING CONDITION. ALL EXPOSED BLOCKING REQUIRED FOR GOAL.
- ATTACHMENT SHALL BE PAINTED TO MATCH ADJACENT WALL COLOR. 9. WASHER/DRYER, N.I.C.
- 10. FOLDABLE WALL PARTITION. REFER TO DETAIL ON A7.1 FOR CEILING CONDITION. 11. UTILITY SINK.
- 12. ELECTRICALLY OPERATED FOLDING BLEACHERS, REFER TO SPECIFICATIONS AND DETAIL 4/A1.2. 13. SCORERS TABLE (N.I.C.)
- 14. ADULT CHANGING TABLE. 15. ATHLETIC WALL PADS FOR LIMITS SHOWN, REFER TO SPECIFICATIONS.
- 16. ROOF ABOVE. 17. WALL MOUNTED COUNTERTOP, REFER TO DETAIL 14/A2.7.
- 19. HIGH/LOW WATER FOUNTAIN UNIT. REFER TO MECH./ELEC. DRAWINGS.

18. COMPUTER STATION, N.I.C. REFER TO ELECTRICAL DWGS. FOR DATA AND

- 20. INDUSTRIAL STAIR PER OSHA STANDARDS. REFER TO REFERENCED DETAIL AND
- 21. SCOREBOARD ABOVE AT 11'-0" A.F.F. (TO B.O. SCOREBOARD). REFER TO SPECIFICATIONS AND ELECTRICAL DRAWINGS.
- 23. MECHANICAL LOUVER. REFER TO DETAIL 8/A6.2. 24. RECESSED CONCRETE FLOOR SLAB IN THIS AREA. REFER TO STRUCTURAL DWGS.

22. ROOF HATCH ABOVE. SEE DETAIL _

- 25. ELECTRIC PUSH-BUTTON ADA DOOR OPERATOR. REFER TO ELEC. DWGS. 26. DOOR ACCESS CONTROL LOCATION.
- 27. VOLLEYBALL FLOOR INSERTS, FLUSH WITH WOOD FLOOR. 28. PRE-FIN. ALUM. FIXED WALL LADDER. REFER TO _____
- 29. DOUBLE TIER STUDENT LOCKERS. 30. ATHLETIC LOCKERS. 31. SINGLE TIER LOCKERS.
- 32. RETRACTABLE GYMNASIUM DIVIDER, REFER TO SPECIFICATIONS. 33. AREA OF NEW FLOOR INFILL. REFER TO STRUCTURE.
- 34. PAINT EXISTING WALL MATCHING THE EXISITNG WALL COLOR. 35. CANOPY ABOVE. REFER TO SHEET A5.2. 36. ADULT CHANGING TABLE, N.I.C.

SYMBOLS LEGEND

- 101 | # ROOM FINISH GROUPS (REFER TO SHEET N0.1) ROOM NUMBER
- DOOR NUMBER (DOOR SCHEDULE SHEET A8.1)
- NEW WORK KEY NOTES (SHEETS A1.1 THROUGH A2.2)
- WALL TYPE (SCHEDULE SHEET N-1)
- ALUMINUM OR HOLLOW METAL FRAME OR STOREFRONT TYPE (REFER TO FLOOR PLANS AND SCHEDULE SHEETS A8.1-A8.2)
- TOILET ACCESSORIES (SCHEDULE SHEET A2.2)

ELEVATION KEY NOTE (SHEET A3.1-A3.3)


- ROOF KEY NOTE (SHEET A4.1)
- CEILING PLAN KEY NOTE (SHEETS A7.1-A7.6)

FW2 2 HOUR FIRE WALL

- SIGNAGE KEY NOTE (SHEETS A0.1) DASHED LINE INDICATES WALL TILE AT RESTROOMS
- — AND BRADLEY SINK WALLS SHOWN ON RESTROOM PLANS. (TILE WALL DETAIL 21/A2.4)
- ROOM / WALL DESIGNATION FB1 1 HOUR FIRE BARRIER FB2 2 HOUR FIRE BARRIER
 - CONTROL JOINT, REFER TO EXTERIOR ELEVATIONS FOR EXTERIOR

BOARD SCHEDULE

- TB TACKBOARD, IN CONTRACT.
- MB MARKERBOARD, IN CONTRACT.
- IB INTERACTIVE BOARD, OFCI. COORDINATE LOCATION & SIZE WITH OWNER.
- TV TELEVISION, OFCI. COORDINATE LOCATION & SIZE WITH OWNER. MOUNT MULTIMEDIA BOX AT HEIGHT INDICATED, 5'-0" A.F.F. U.N.O.
- VW VIDEO WALL, OFCI, COORDINATE LOCATION & SIZE WITH OWNER. REFER TO

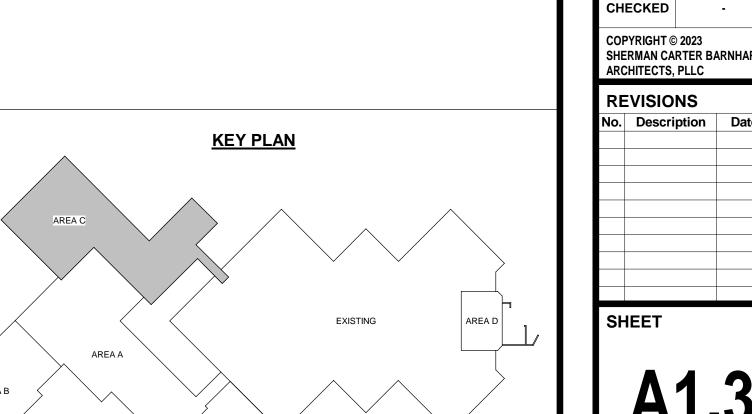

DRAWN

FLOOR

2246 SOUTH HOPKINS SCHOOL 9/11/2023 2:58:11 PM

GENERAL WORK NOTES

REFER TO MECH./ELEC. DRAWINGS FOR SPECIFIC NOTES REGARDING MECH/ELEC. ITEMS NOT SHOWN ON THIS SHEET.

ZC

шкк I 4 4 0

von ∠

AUA 4 Σ \square Γ $\alpha \vdash z$

- 2. REFER TO ROOF PLAN AND MECH. DRAWINGS FOR ADDITIONAL INFORMATION REGARDING WORK AT ROOF.
- 3. REFER TO SHEET N0.1 FOR GENERAL NOTES AND PARTITION TYPES.
- 4. REFER TO DETAILS ON SHEET A6.1 FOR TYPICAL WALL INTERSECTION DETAILS.
- 5. REFER TO SHEET A2.5 FOR TOILET ACCESSORY SCHEDULE.
- 6. REFER TO A2.7 FOR CASEWORK LEGEND AND NOTES.

PLAN KEY NOTES

- NOTE: NOT ALL KEYNOTES MAY APPLY TO THIS SHEET.
- GYP. BD. BULKHEAD OR SOFFIT ABOVE. REFER TO REFLECTED CLG. PLANS.
 LINE OF BLEACHERS IN RETRACTED POSITION.
 FLOOR TRANSITION. REFER TO SHEET A9.1 FOR DETAILS.
 LINE OF PRE-ENG. PRE-FIN. ALUM. CANOPY ABOVE OR BELOW. REFER TO DETAIL
- SHELVING / FURNISHINGS / EQUIPMENT PROVIDED BY OWNER, N.I.C.
 FIRE ALARM PANEL. REFER TO ELECTRICAL DWGS.
- 8. BASKETBALL GOAL ABOVE, REFER TO SPECS AND REFLECTED CEILING PLAN FOR MOUNTING CONDITION. ALL EXPOSED BLOCKING REQUIRED FOR GOAL. ATTACHMENT SHALL BE PAINTED TO MATCH ADJACENT WALL COLOR.
- 9. WASHER/DRYER, N.I.C. 10. FOLDABLE WALL PARTITION. REFER TO DETAIL ON A7.1 FOR CEILING CONDITION.
- 12. ELECTRICALLY OPERATED FOLDING BLEACHERS, REFER TO SPECIFICATIONS AND
- DETAIL 4/A1.2. 13. SCORERS TABLE (N.I.C.)
 14. ADULT CHANGING TABLE.
- 15. ATHLETIC WALL PADS FOR LIMITS SHOWN, REFER TO SPECIFICATIONS.
- ROOF ABOVE.
- 17. WALL MOUNTED COUNTERTOP, REFER TO DETAIL 14/A2.7.
 18. COMPUTER STATION, N.I.C. REFER TO ELECTRICAL DWGS. FOR DATA AND
- 19. HIGH/LOW WATER FOUNTAIN UNIT. REFER TO MECH./ELEC. DRAWINGS.
 20. INDUSTRIAL STAIR PER OSHA STANDARDS. REFER TO REFERENCED DETAIL AND
- 21. SCOREBOARD ABOVE AT 11'-0" A.F.F. (TO B.O. SCOREBOARD). REFER TO SPECIFICATIONS AND ELECTRICAL DRAWINGS.
 22. ROOF HATCH ABOVE. SEE DETAIL ______.
- 23. MECHANICAL LOUVER. REFER TO DETAIL 8/A6.2.
 24. RECESSED CONCRETE FLOOR SLAB IN THIS AREA. REFER TO STRUCTURAL DWGS.
- 25. ELECTRIC PUSH-BUTTON ADA DOOR OPERATOR. REFER TO ELEC. DWGS.
- 26. DOOR ACCESS CONTROL LOCATION. 27. VOLLEYBALL FLOOR INSERTS, FLUSH WITH WOOD FLOOR. 28. PRE-FIN. ALUM. FIXED WALL LADDER. REFER TO ______.
- 29. DOUBLE TIER STUDENT LOCKERS. 30. ATHLETIC LOCKERS.
- 31. SINGLE TIER LOCKERS.
- 32. RETRACTABLE GYMNASIUM DIVIDER, REFER TO SPECIFICATIONS.
 33. AREA OF NEW FLOOR INFILL. REFER TO STRUCTURE. 34. PAINT EXISTING WALL MATCHING THE EXISITNG WALL COLOR.
- 35. CANOPY ABOVE. REFER TO SHEET A5.2. 36. ADULT CHANGING TABLE, N.I.C.

SYMBOLS LEGEND

- ROOM NUMBER DOOR NUMBER (DOOR SCHEDULE SHEET A8.1)
- NEW WORK KEY NOTES (SHEETS A1.1 THROUGH A2.2)

101 | # - ROOM FINISH GROUPS (REFER TO SHEET N0.1)

- WALL TYPE (SCHEDULE SHEET N-1)
- ALUMINUM OR HOLLOW METAL FRAME OR STOREFRONT TYPE (REFER TO FLOOR PLANS AND SCHEDULE SHEETS A8.1-A8.2)
- TOILET ACCESSORIES (SCHEDULE SHEET A2.2) ELEVATION KEY NOTE (SHEET A3.1-A3.3)
- ROOF KEY NOTE (SHEET A4.1)
- CEILING PLAN KEY NOTE (SHEETS A7.1-A7.6)
- SIGNAGE KEY NOTE (SHEETS A0.1) DASHED LINE INDICATES WALL TILE AT RESTROOMS
- — AND BRADLEY SINK WALLS SHOWN ON RESTROOM PLANS. (TILE WALL DETAIL 21/A2.4)
- ROOM / WALL DESIGNATION FB1 1 HOUR FIRE BARRIER FB2 2 HOUR FIRE BARRIER FW2 2 HOUR FIRE WALL

CONTROL JOINT, REFER TO EXTERIOR ELEVATIONS FOR EXTERIOR LOCATIONS.

BOARD SCHEDULE

- TB TACKBOARD, IN CONTRACT.
- MB MARKERBOARD, IN CONTRACT.
- IB INTERACTIVE BOARD, OFCI. COORDINATE LOCATION & SIZE WITH OWNER.
- TV TELEVISION, OFCI. COORDINATE LOCATION & SIZE WITH OWNER. MOUNT MULTIMEDIA BOX AT HEIGHT INDICATED, 5'-0" A.F.F. U.N.O.
- VW VIDEO WALL, OFCI, COORDINATE LOCATION & SIZE WITH OWNER. REFER TO ELECTRICAL.

KEY PLAN

ARE, FLOOR

DRAWN CHECKED COPYRIGHT © 2023 SHERMAN CARTER BARNHART ARCHITECTS, PLLC **REVISIONS**

Z C

A M A $\Sigma \sqcup \mathbf{I}$ $\alpha \vdash z$

шкк Iddo

SCHOOL

MECHANIC

PLAN & | ATFORM

OR P

Ŏ

ECOND

DRAWN

CHECKED

. REFER TO MECH./ELEC. DRAWINGS FOR SPECIFIC NOTES REGARDING MECH/ELEC. ITEMS NOT SHOWN ON THIS SHEET.

. REFER TO ROOF PLAN AND MECH. DRAWINGS FOR ADDITIONAL INFORMATION

REGARDING WORK AT ROOF.

3. REFER TO SHEET NO.1 FOR GENERAL NOTES AND PARTITION TYPES.

4. REFER TO DETAILS ON SHEET A6.1 FOR TYPICAL WALL INTERSECTION DETAILS.

5. REFER TO SHEET A2.5 FOR TOILET ACCESSORY SCHEDULE.

6. REFER TO A2.7 FOR CASEWORK LEGEND AND NOTES.

PLAN KEY NOTES

NOTE: NOT ALL KEYNOTES MAY APPLY TO THIS SHEET.

1. GYP. BD. BULKHEAD OR SOFFIT ABOVE. REFER TO REFLECTED CLG. PLANS. 2. LINE OF BLEACHERS IN RETRACTED POSITION.

3. FLOOR TRANSITION. REFER TO SHEET A9.1 FOR DETAILS. 4. LINE OF PRE-ENG. PRE-FIN. ALUM. CANOPY ABOVE OR BELOW. REFER TO DETAIL

. SHELVING / FURNISHINGS / EQUIPMENT PROVIDED BY OWNER, N.I.C. 6. FIRE ALARM PANEL. REFER TO ELECTRICAL DWGS.

8. BASKETBALL GOAL ABOVE, REFER TO SPECS AND REFLECTED CEILING PLAN FOR MOUNTING CONDITION. ALL EXPOSED BLOCKING REQUIRED FOR GOAL. ATTACHMENT SHALL BE PAINTED TO MATCH ADJACENT WALL COLOR.

10. FOLDABLE WALL PARTITION. REFER TO DETAIL ON A7.1 FOR CEILING CONDITION. 11. UTILITY SINK. 12. ELECTRICALLY OPERATED FOLDING BLEACHERS, REFER TO SPECIFICATIONS AND

DETAIL 4/A1.2. 13. SCORERS TABLE (N.I.C.) 14. ADULT CHANGING TABLE.

15. ATHLETIC WALL PADS FOR LIMITS SHOWN, REFER TO SPECIFICATIONS.

17. WALL MOUNTED COUNTERTOP, REFER TO DETAIL 14/A2.7.
18. COMPUTER STATION, N.I.C. REFER TO ELECTRICAL DWGS. FOR DATA AND

19. HIGH/LOW WATER FOUNTAIN UNIT. REFER TO MECH./ELEC. DRAWINGS. 20. INDUSTRIAL STAIR PER OSHA STANDARDS. REFER TO REFERENCED DETAIL AND

21. SCOREBOARD ABOVE AT 11'-0" A.F.F. (TO B.O. SCOREBOARD). REFER TO SPECIFICATIONS AND ELECTRICAL DRAWINGS. 22. ROOF HATCH ABOVE. SEE DETAIL _

23. MECHANICAL LOUVER. REFER TO DETAIL 8/A6.2.
24. RECESSED CONCRETE FLOOR SLAB IN THIS AREA. REFER TO STRUCTURAL DWGS. 25. ELECTRIC PUSH-BUTTON ADA DOOR OPERATOR. REFER TO ELEC. DWGS.

26. DOOR ACCESS CONTROL LOCATION. 27. VOLLEYBALL FLOOR INSERTS, FLUSH WITH WOOD FLOOR. 28. PRE-FIN. ALUM. FIXED WALL LADDER. REFER TO _____

30. ATHLETIC LOCKERS. 31. SINGLE TIER LOCKERS. 32. RETRACTABLE GYMNASIUM DIVIDER, REFER TO SPECIFICATIONS. 33. AREA OF NEW FLOOR INFILL. REFER TO STRUCTURE.

34. PAINT EXISTING WALL MATCHING THE EXISITNG WALL COLOR. 35. CANOPY ABOVE. REFER TO SHEET A5.2. 36. ADULT CHANGING TABLE, N.I.C.

SYMBOLS LEGEND

(101 | #)— ROOM FINISH GROUPS (REFER TO SHEET NO.1) — ROOM NUMBER

DOOR NUMBER (DOOR SCHEDULE SHEET A8.1)

NEW WORK KEY NOTES (SHEETS A1.1 THROUGH A2.2)

WALL TYPE (SCHEDULE SHEET N-1) ALUMINUM OR HOLLOW METAL FRAME OR STOREFRONT TYPE (REFER TO FLOOR PLANS AND SCHEDULE SHEETS A8.1-A8.2)

TOILET ACCESSORIES (SCHEDULE SHEET A2.2)

ELEVATION KEY NOTE (SHEET A3.1-A3.3)

ROOF KEY NOTE (SHEET A4.1) CEILING PLAN KEY NOTE (SHEETS A7.1-A7.6)

SIGNAGE KEY NOTE (SHEETS A0.1)

DASHED LINE INDICATES WALL TILE AT RESTROOMS — — AND BRADLEY SINK WALLS - SHOWN ON RESTROOM PLANS.

(TILE WALL DETAIL 21/A2.4)

FW2 2 HOUR FIRE WALL CONTROL JOINT, REFER TO EXTERIOR ELEVATIONS FOR EXTERIOR

BOARD SCHEDULE

TB - TACKBOARD, IN CONTRACT.

MB - MARKERBOARD, IN CONTRACT. IB - INTERACTIVE BOARD, OFCI. COORDINATE LOCATION & SIZE WITH OWNER.

TV - TELEVISION, OFCI. COORDINATE LOCATION & SIZE WITH OWNER. MOUNT MULTIMEDIA BOX AT HEIGHT INDICATED, 5'-0" A.F.F. U.N.O.

VW - VIDEO WALL, OFCI, COORDINATE LOCATION & SIZE WITH OWNER. REFER TO ELECTRICAL.

COPYRIGHT © 2023 SHERMAN CARTER BARNHART ARCHITECTS, PLLC **REVISIONS KEY PLAN**

2246 SOUTH HOPKINS SCHOOL 9/11/2023 2:58:18 PM

GENERAL WORK NOTES

REFER TO MECH./ELEC. DRAWINGS FOR SPECIFIC NOTES REGARDING MECH/ELEC.

REFER TO ROOF PLAN AND MECH. DRAWINGS FOR ADDITIONAL INFORMATION

4. REFER TO DETAILS ON SHEET A6.1 FOR TYPICAL WALL INTERSECTION DETAILS.

. GYP. BD. BULKHEAD OR SOFFIT ABOVE. REFER TO REFLECTED CLG. PLANS.

4. LINE OF PRE-ENG. PRE-FIN. ALUM. CANOPY ABOVE OR BELOW. REFER TO DETAIL

8. BASKETBALL GOAL ABOVE, REFER TO SPECS AND REFLECTED CEILING PLAN FOR

10. FOLDABLE WALL PARTITION. REFER TO DETAIL ON A7.1 FOR CEILING CONDITION.

12. ELECTRICALLY OPERATED FOLDING BLEACHERS, REFER TO SPECIFICATIONS AND

MOUNTING CONDITION. ALL EXPOSED BLOCKING REQUIRED FOR GOAL. ATTACHMENT SHALL BE PAINTED TO MATCH ADJACENT WALL COLOR.

15. ATHLETIC WALL PADS FOR LIMITS SHOWN, REFER TO SPECIFICATIONS.

18. COMPUTER STATION, N.I.C. REFER TO ELECTRICAL DWGS. FOR DATA AND

21. SCOREBOARD ABOVE AT 11'-0" A.F.F. (TO B.O. SCOREBOARD). REFER TO

25. ELECTRIC PUSH-BUTTON ADA DOOR OPERATOR. REFER TO ELEC. DWGS.

20. INDUSTRIAL STAIR PER OSHA STANDARDS. REFER TO REFERENCED DETAIL AND

24. RECESSED CONCRETE FLOOR SLAB IN THIS AREA. REFER TO STRUCTURAL DWGS.

SYMBOLS LEGEND

19. HIGH/LOW WATER FOUNTAIN UNIT. REFER TO MECH./ELEC. DRAWINGS.

17. WALL MOUNTED COUNTERTOP, REFER TO DETAIL 14/A2.7.

SPECIFICATIONS AND ELECTRICAL DRAWINGS.

27. VOLLEYBALL FLOOR INSERTS, FLUSH WITH WOOD FLOOR. 28. PRE-FIN. ALUM. FIXED WALL LADDER. REFER TO ______.

33. AREA OF NEW FLOOR INFILL. REFER TO STRUCTURE. 34. PAINT EXISTING WALL MATCHING THE EXISITNG WALL COLOR.

101 # ROOM FINISH GROUPS (REFER TO SHEET N0.1)

WALL TYPE (SCHEDULE SHEET N-1)

ELEVATION KEY NOTE (SHEET A3.1-A3.3)

CEILING PLAN KEY NOTE (SHEETS A7.1-A7.6)

DASHED LINE INDICATES WALL TILE AT RESTROOMS AND BRADLEY SINK WALLS - SHOWN ON RESTROOM PLANS.

CONTROL JOINT, REFER TO EXTERIOR ELEVATIONS FOR EXTERIOR

BOARD SCHEDULE

TV - TELEVISION, OFCI. COORDINATE LOCATION & SIZE WITH OWNER. MOUNT MULTIMEDIA

IB - INTERACTIVE BOARD, OFCI. COORDINATE LOCATION & SIZE WITH OWNER.

VW - VIDEO WALL, OFCI, COORDINATE LOCATION & SIZE WITH OWNER. REFER TO

LIBRARY NOTES

600 STUDENTS x 10 VOLUMES PER STUDENT = 6,000 VOL.

PICTURE BOOKS AT 20% = 1,200 VOLUMES

ALL SHELVES SHALL BE 2/3 FULL. A 3'-0" SHELF AT 2/3 FULL SHALL CONTAIN QUANTITY AS FOLLOWS PER USE:

REGULAR BOOKS: UNIT 5: 100 VOLUMES x 13

600 STUDENTS x 15% = 90 SEATS (REQUIRED)

TOTAL SEATS PROVIDED = 98

PICTURE BOOKS: UNIT 7: 120 VOLUMES x 10 = 1,200

REFERENCE UNIT: UNIT 5: 55 VOLUMES x 4 = 220

= 8

= 56

REGULAR BOOKS = 20 VOLUMES PICTURE BOOKS = 40 VOLUMES

REFERENCE BOOKS = 11 VOLUMES TOTAL LIBRARY SHELVING PER TYPE OF BOOK:

REFERENCE BOOKS AT 10% = 600 VOLUMES

TOTAL = 6,000 VOLUMES

UNIT 8: 120 VOLUMES x 26 = 3,120

UNIT 6: 33 VOLUMES x 12 = 396

SUB TOTAL = 4,420

SUB TOTAL = 616

GRAND TOTAL = 6,236

BASED ON THE FOLLOWING TYPES OF BOOK PERCENTAGES:

SOUTH HOPKINS SCHOOL COLLECTION IS

ROOF KEY NOTE (SHEET A4.1)

SIGNAGE KEY NOTE (SHEETS A0.1)

(TILE WALL DETAIL 21/A2.4)

ROOM / WALL DESIGNATION FB1 1 HOUR FIRE BARRIEF FB2 2 HOUR FIRE BARRIER FW2 2 HOUR FIRE WALL

LOCATIONS.

TB - TACKBOARD, IN CONTRACT.

MB - MARKERBOARD, IN CONTRACT.

BOX AT HEIGHT INDICATED, 5'-0" A.F.F. U.N.O.

LIBRARY BOOK COLLECTION:

LIBRARY SEATING:

COMPUTER STATION

LOUNGE SEATING

TABLE SEATING

STORY AREA

REGULAR BOOKS AT 70%

DOOR NUMBER (DOOR SCHEDULE SHEET A8.1)

NEW WORK KEY NOTES (SHEETS A1.1 THROUGH A2.2)

FLOOR PLANS AND SCHEDULE SHEETS A8.1-A8.2) TOILET ACCESSORIES (SCHEDULE SHEET A2.2)

ALUMINUM OR HOLLOW METAL FRAME OR STOREFRONT TYPE (REFER TO

32. RETRACTABLE GYMNASIUM DIVIDER, REFER TO SPECIFICATIONS.

23. MECHANICAL LOUVER. REFER TO DETAIL 8/A6.2.

22. ROOF HATCH ABOVE. SEE DETAIL _

26. DOOR ACCESS CONTROL LOCATION.

35. CANOPY ABOVE. REFER TO SHEET A5.2. 36. ADULT CHANGING TABLE, N.I.C.

- ROOM NUMBER

29. DOUBLE TIER STUDENT LOCKERS.

30. ATHLETIC LOCKERS. 31. SINGLE TIER LOCKERS.

PLAN KEY NOTES

3. REFER TO SHEET NO.1 FOR GENERAL NOTES AND PARTITION TYPES.

5. REFER TO SHEET A2.5 FOR TOILET ACCESSORY SCHEDULE.

6. REFER TO A2.7 FOR CASEWORK LEGEND AND NOTES.

NOTE: NOT ALL KEYNOTES MAY APPLY TO THIS SHEET.

2. LINE OF BLEACHERS IN RETRACTED POSITION.

). WASHER/DRYER, N.I.C.

13. SCORERS TABLE (N.I.C.) 14. ADULT CHANGING TABLE.

DETAIL 4/A1.2.

ROOF ABOVE.


3. FLOOR TRANSITION. REFER TO SHEET A9.1 FOR DETAILS.

SHELVING / FURNISHINGS / EQUIPMENT PROVIDED BY OWNER, N.I.C.
 FIRE ALARM PANEL. REFER TO ELECTRICAL DWGS.

ITEMS NOT SHOWN ON THIS SHEET.

REGARDING WORK AT ROOF.

SHEET

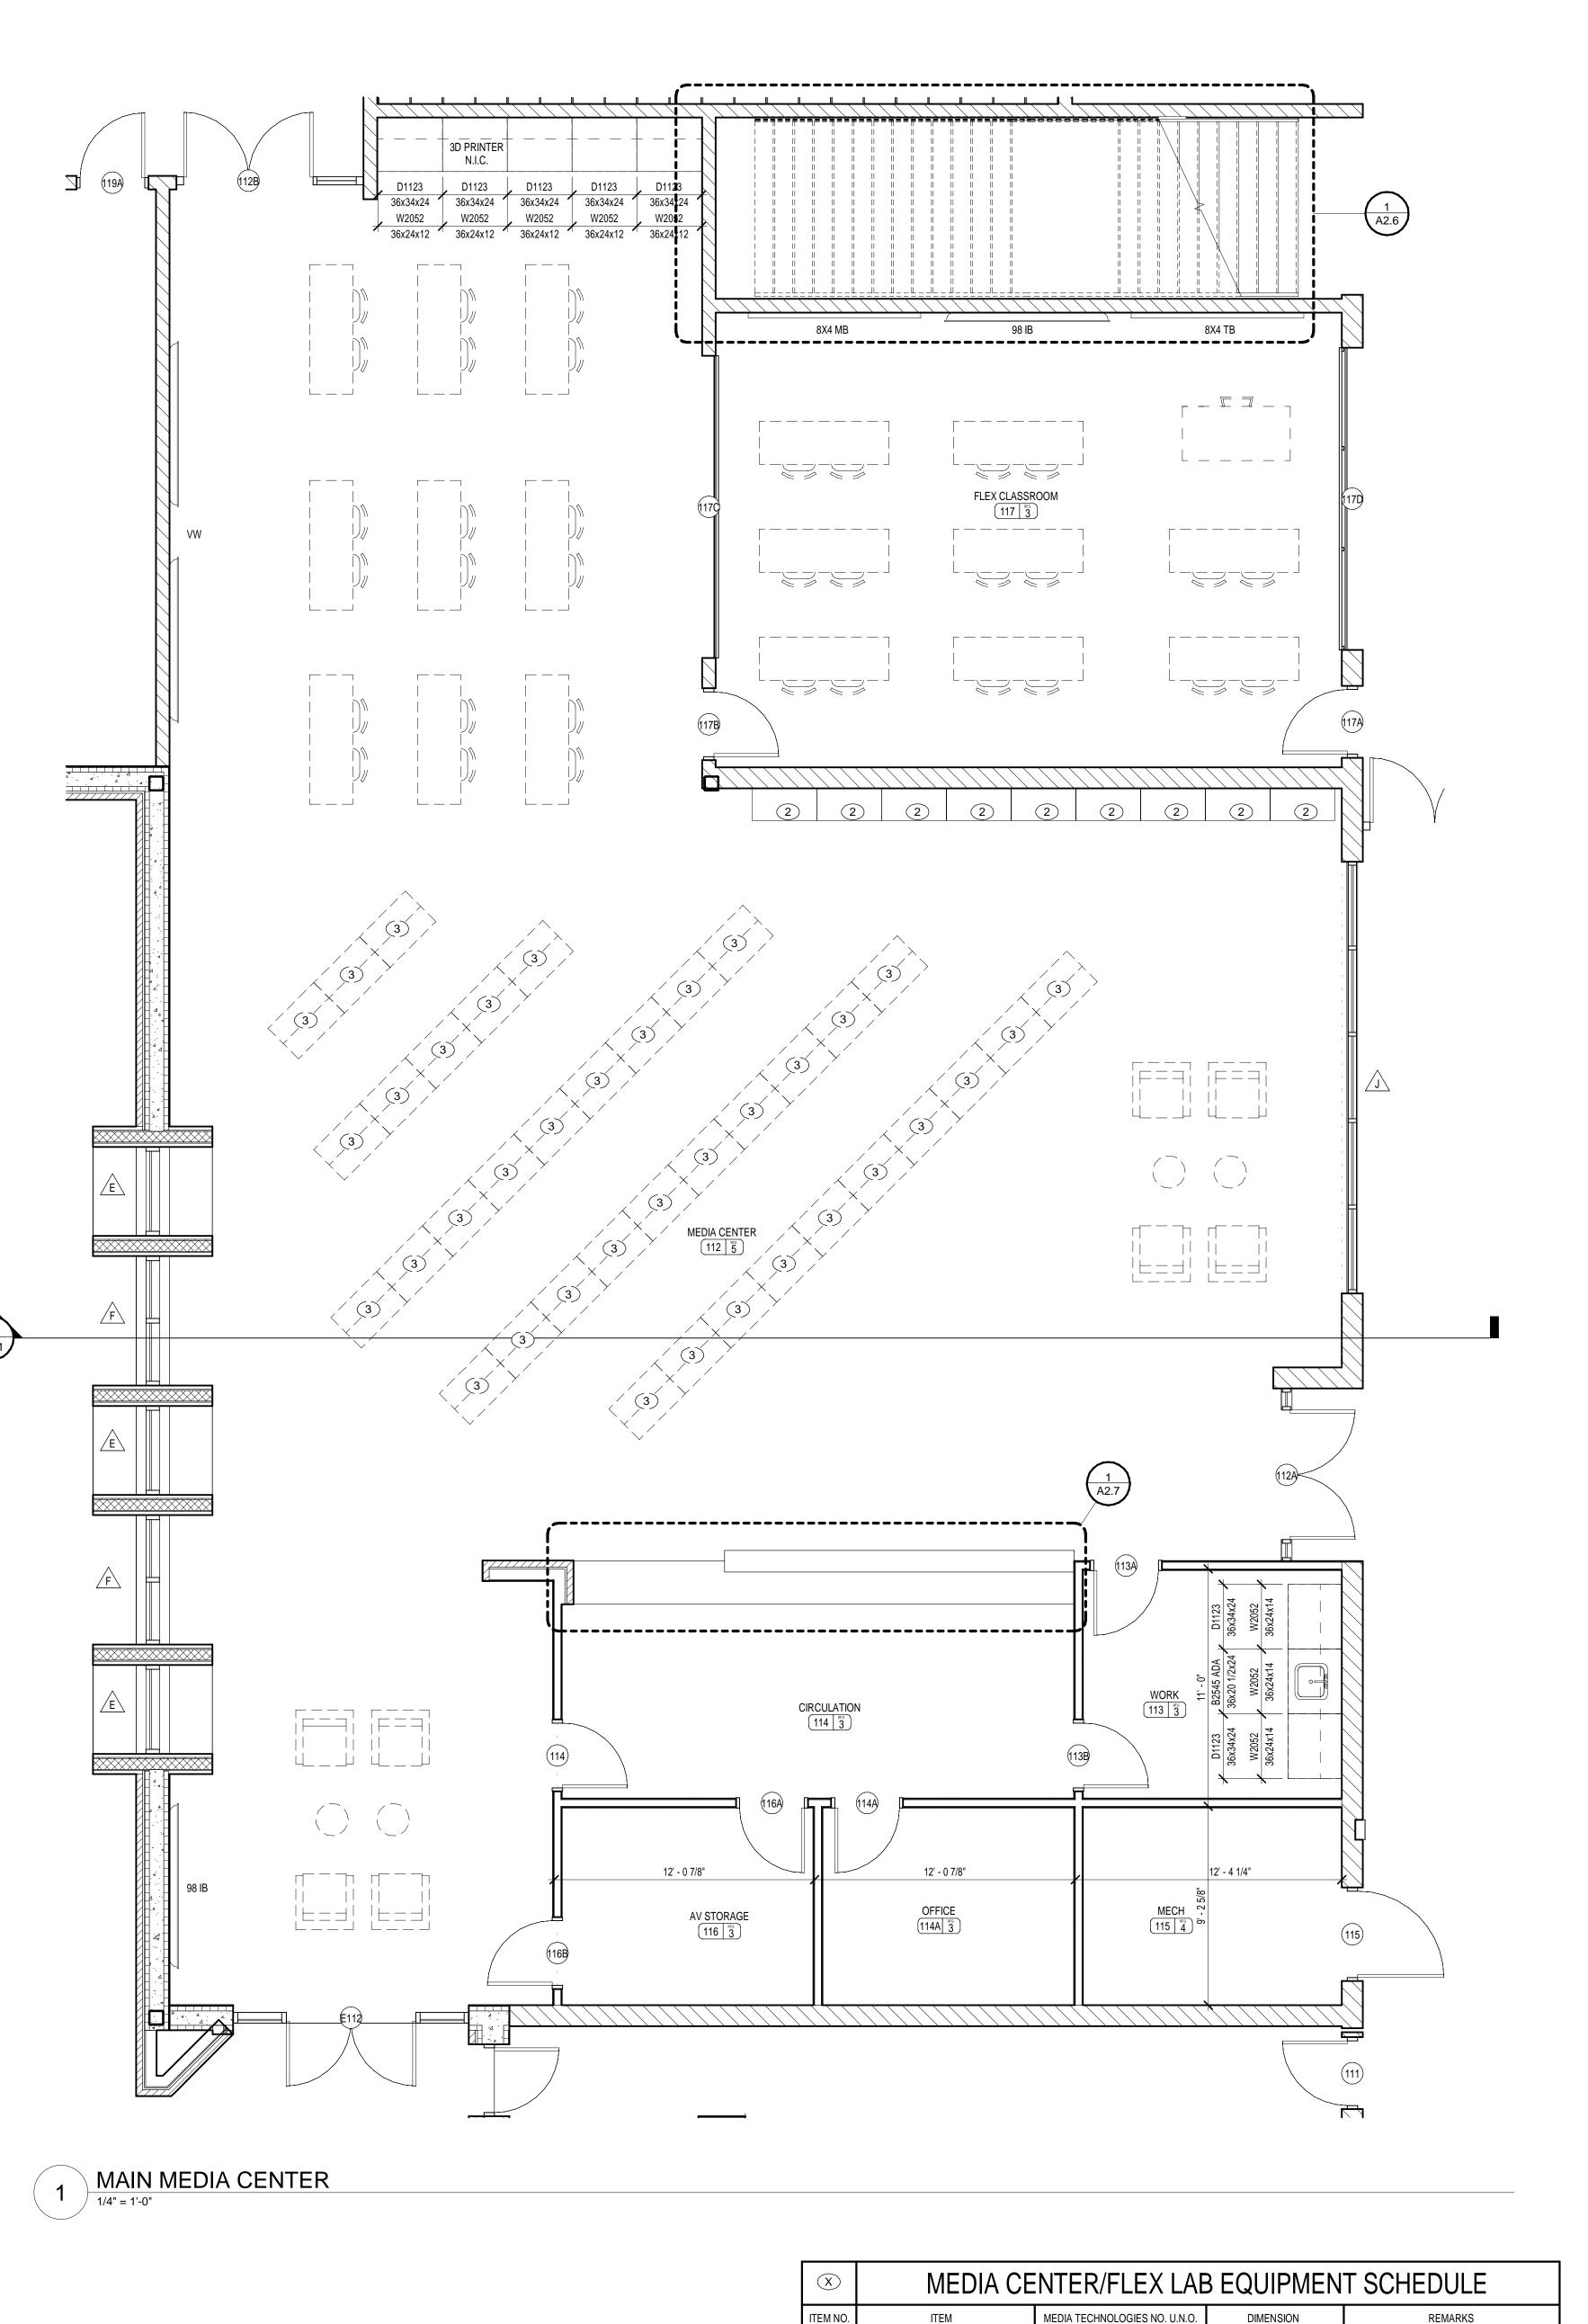

LOW SHELF UNIT

HIGH SHELF UNIT

DOUBLE FACED SHELF UNIT

V11-4810

V11-4810

V11-4820

NOTE: ALL FURNITURE NUMBERED 1-3 ARE FOR MEDIA TECHNOLOGIES, PHONE NUMBER 1(231)861-2194 AND REPRESENT THE LEVEL OF QUALITY REQUIRED, AND SHALL BE USED AS A BASIS FOR EQUAL PRODUCTS.

42"H x 36"W x 18"D

72"H x 36"W x 18"D

42"H x 36"W x 37"D

HARDBOARD BACK

HARDBOARD BACK

HARDBOARD BACK

CASEWORK NOTES

TYPICAL CASEWORK MODEL NUMBERS SHOWN ARE TMI SYSTEMS DESIGN CORP. (PHONE NO. 1-800-456-6716) AND REPRESENT THE LEVEL OF QUALITY REQUIRED AND SHALL BE USED AS THE BASIS FOR EQUAL PRODUCTS. HEIGHT INDICATED IS TO TOP OF COUNTERTOP.

- A MOUNT ALL BASE AND WALL CASEWORK PER ADA GUIDELINES AND ANSI A117.1-2003.
- B MOUNT TOP OF UPPER WALL CABINETS @ 7'-0" A.F.F., U.N.O.

 \vdash

4X8 IB

ENLARGED TYPICAL CLASSROOM

2246 SOUTH HOPKINS SCH 9/11/2023 2:58:24 PM

ENLARGED ART ROOM PLAN

- C COUNTERTOPS SHALL BE PROVIDED AT ALL CASEWORK.
- D PROVIDE FINISHED END PANELS AT ALL EXPOSED LOCATIONS.
- E PROVIDE 4" BACK AND SIDE SPLASH AT ALL WALL LOCATIONS. F PROVIDE INFILL PANELS AS REQUIRED TO CONCEAL VOIDS @ ALL BASE CABINETS.
- G ALL WALL AND BASE CABINETS SHALL HAVE LOCKS ON DOORS AND DRAWERS. PROVIDE ONE KEY SYSTEM PER ROOM AND ONE MASTER KEY.
- PROVIDE WOOD BLOCKING AS REQUIRED TO SUPPORT COUNTERTOP. COORDINATE W/ UNDER COUNTER EQUIPMENT.

PROVIDE CONTINUOUS WOOD BLOCKING @ METAL STUD WALL LOCATIONS FOR

MOUNTING OF CASEWORK. PLUMBING PIPES TO RUN BELOW CASEWORK AS SHOWN ON MECH. DWGS.

ITEMS NOT SHOWN ON THIS SHEET.

REGARDING WORK AT ROOF.

9. WASHER/DRYER, N.I.C.

13. SCORERS TABLE (N.I.C.) 14. ADULT CHANGING TABLE.

22. ROOF HATCH ABOVE. SEE DETAIL _

29. DOUBLE TIER STUDENT LOCKERS.

36. ADULT CHANGING TABLE, N.I.C.

- ROOM NUMBER

(TILE WALL DETAIL 21/A2.4)

FW2 2 HOUR FIRE WALL

IB - INTERACTIVE BOARD, OFCI. COORDINATE LOCATION & SIZE WITH OWNER.

VW - VIDEO WALL, OFCI, COORDINATE LOCATION & SIZE WITH OWNER. REFER TO

TV - TELEVISION, OFCI. COORDINATE LOCATION & SIZE WITH OWNER. MOUNT MULTIMEDIA

TB - TACKBOARD, IN CONTRACT.


MB - MARKERBOARD, IN CONTRACT.

BOX AT HEIGHT INDICATED, 5'-0" A.F.F. U.N.O.


30. ATHLETIC LOCKERS. 31. SINGLE TIER LOCKERS.

DETAIL 4/A1.2.

ROOF ABOVE.

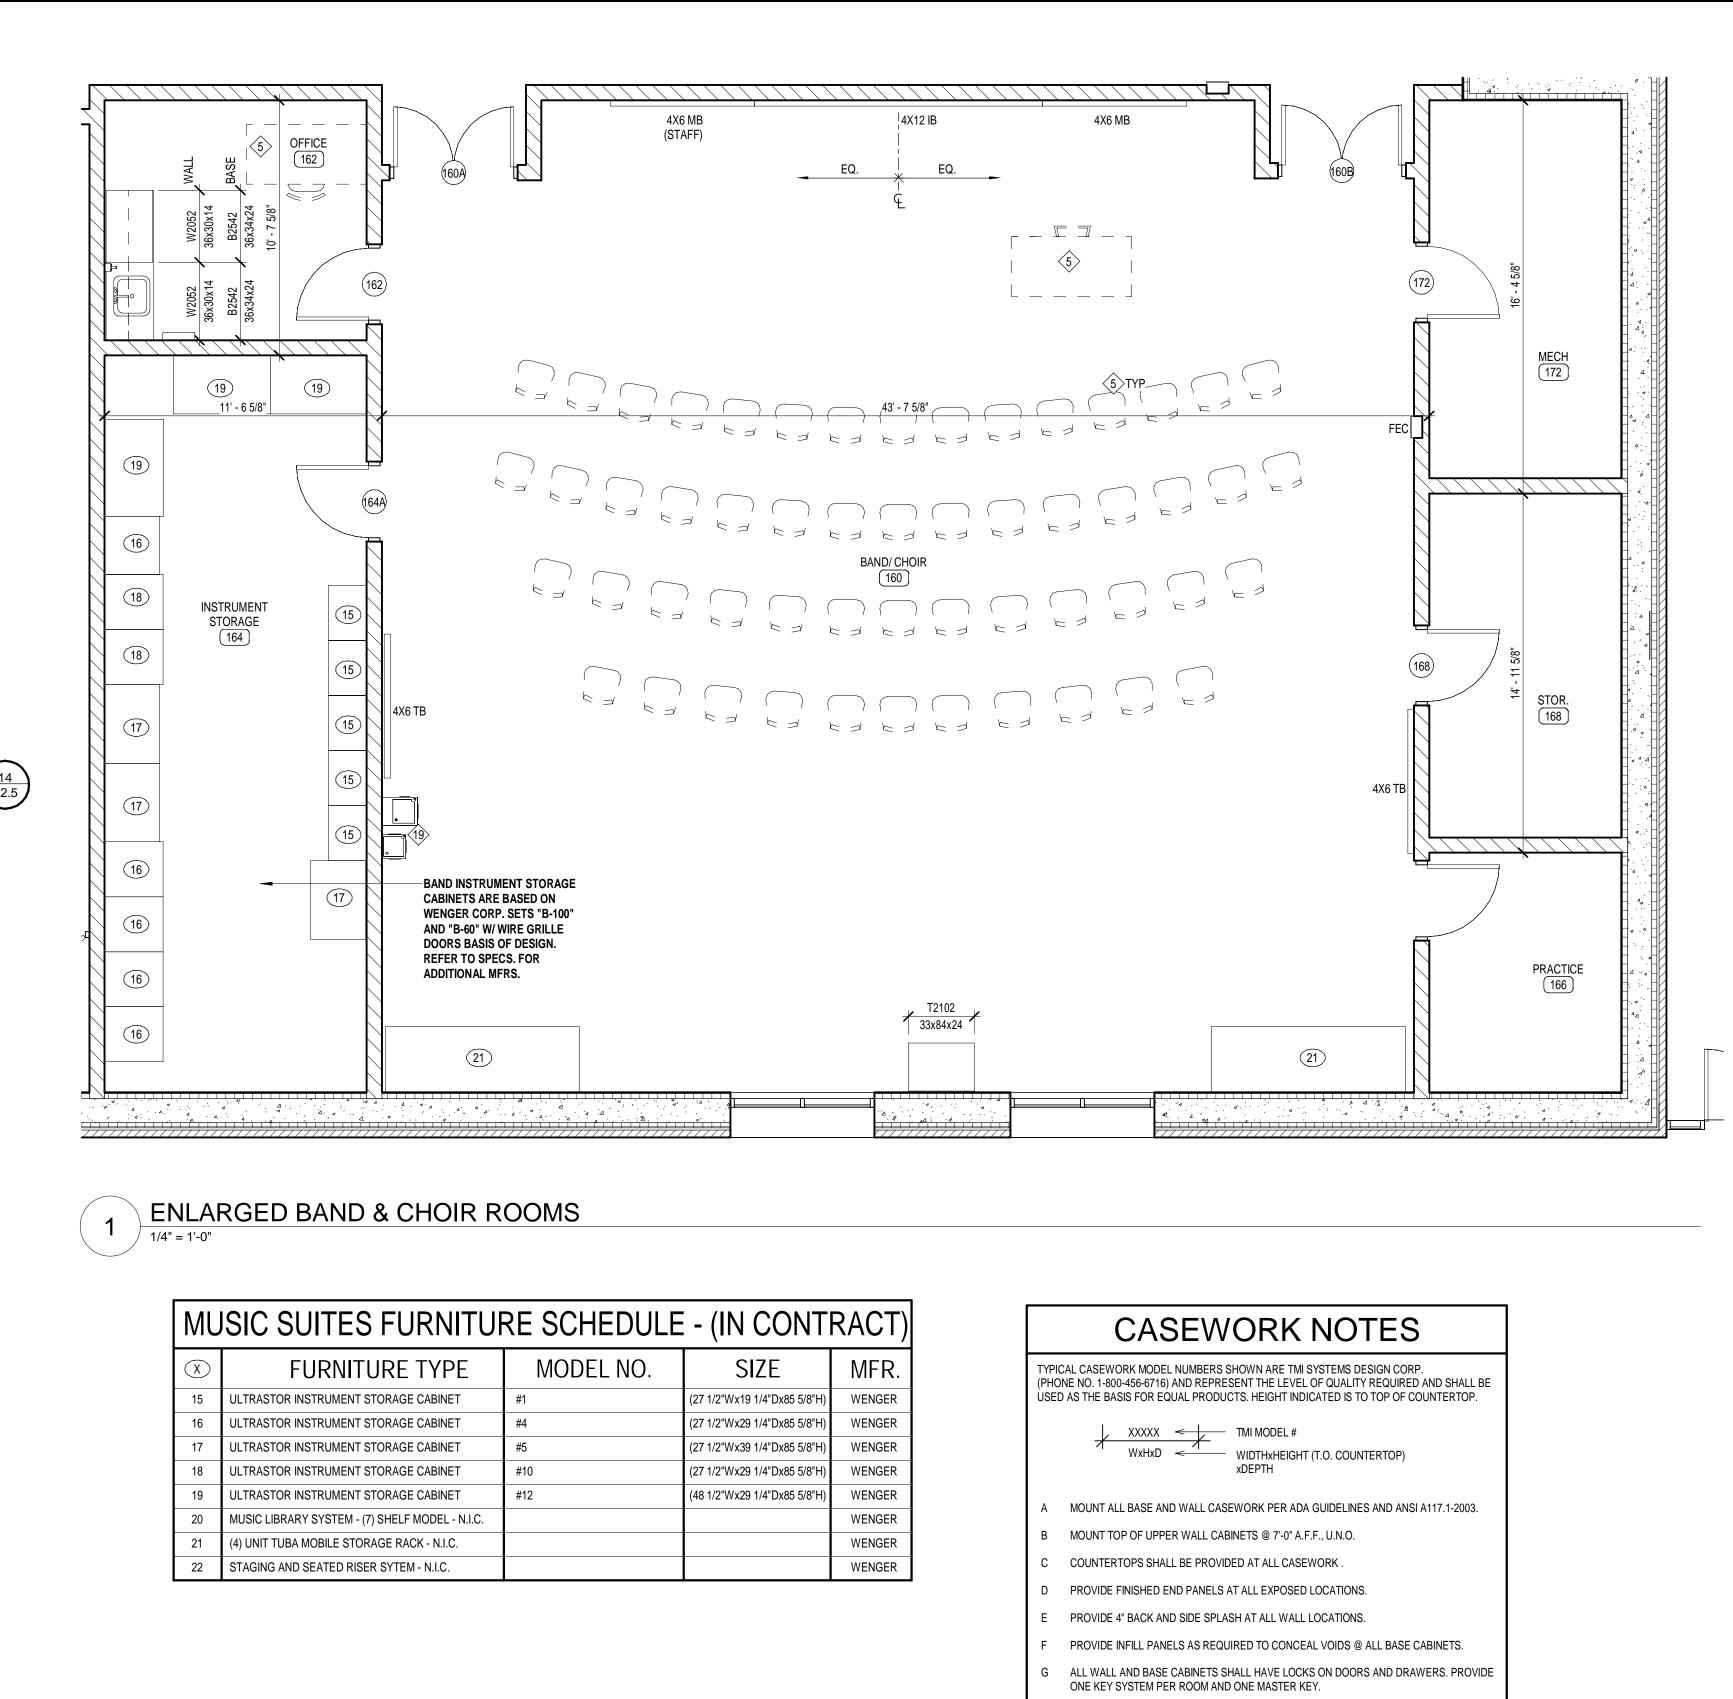

PROVIDE WOOD BLOCKING AS REQUIRED TO SUPPORT COUNTERTOP. COORDINATE W/ UNDER COUNTER EQUIPMENT. PROVIDE CONTINUOUS WOOD BLOCKING @ METAL STUD WALL LOCATIONS FOR MOUNTING OF CASEWORK. PLUMBING PIPES TO RUN BELOW CASEWORK AS SHOWN ON MECH. DWGS.

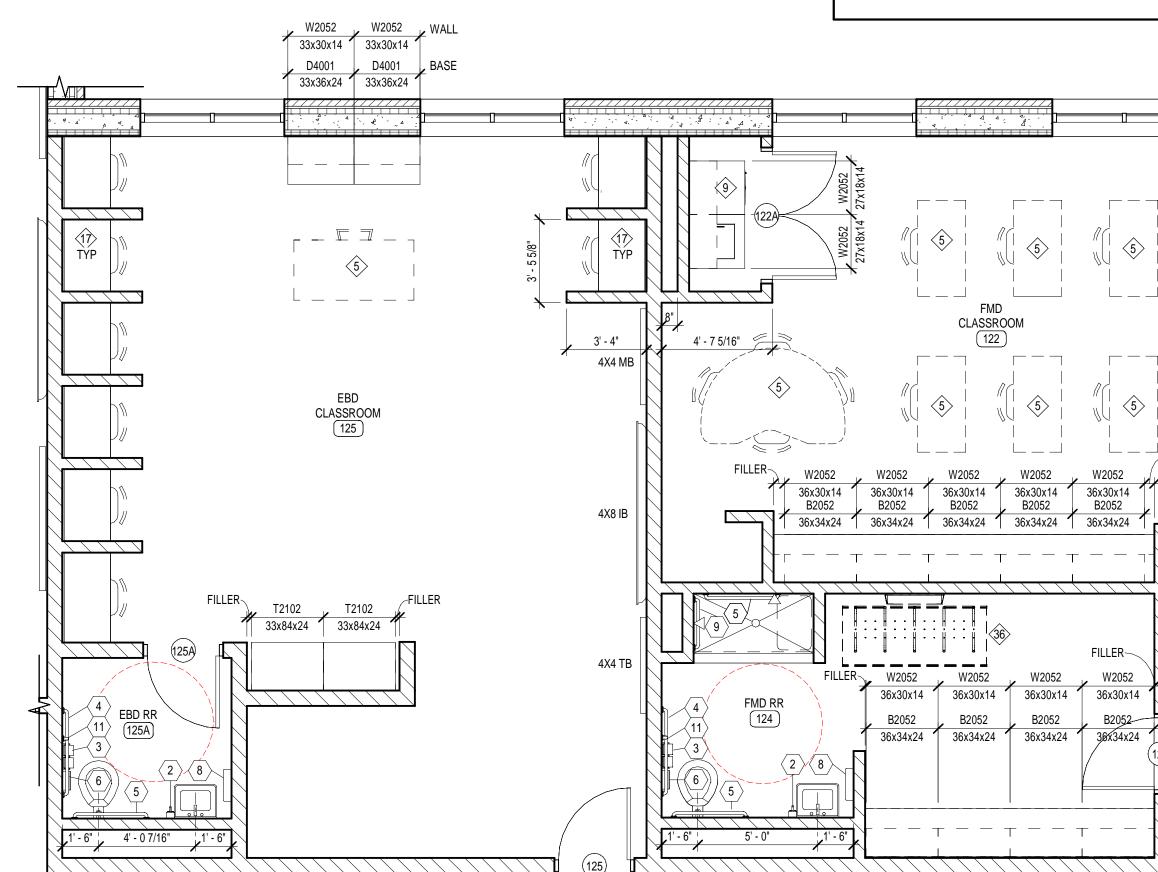

CONCESS. (150A)

(5)

h — — —

STAINLESS STEEL SINK. REFER TO MEP DRAWINGS

PRINCIPAL

PRINCIPAL

SBDM

ENLARGED ADMIN PLAN

2246 SOUTH HOPKINS SCH 9/11/2023 2:58:30 PM

5

BASE B2052 B2052 B2052
WALL 36x34x24 36x34x24 36x34x24
BOTH SIDES W2052 W2052 W2052
36x30x14 36x30x14 36x30x14

BASE B2052 B2052 B2052 B2052 B2052 B2052 B2052 B2052 B2052

WORKROOM

||------------

+----+------------

`~-----

RECEPTION

ENLARGED CONCESSION PLAN


1/4" = 1'-0"


2 ENLARGED EBD AND FMD ROOMS

1/4" = 1'-0"

3 TYPICAL RESOURCE ROOM

1/4" = 1'-0"

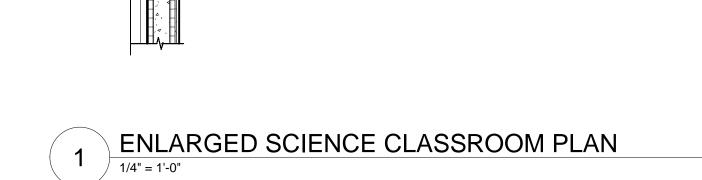

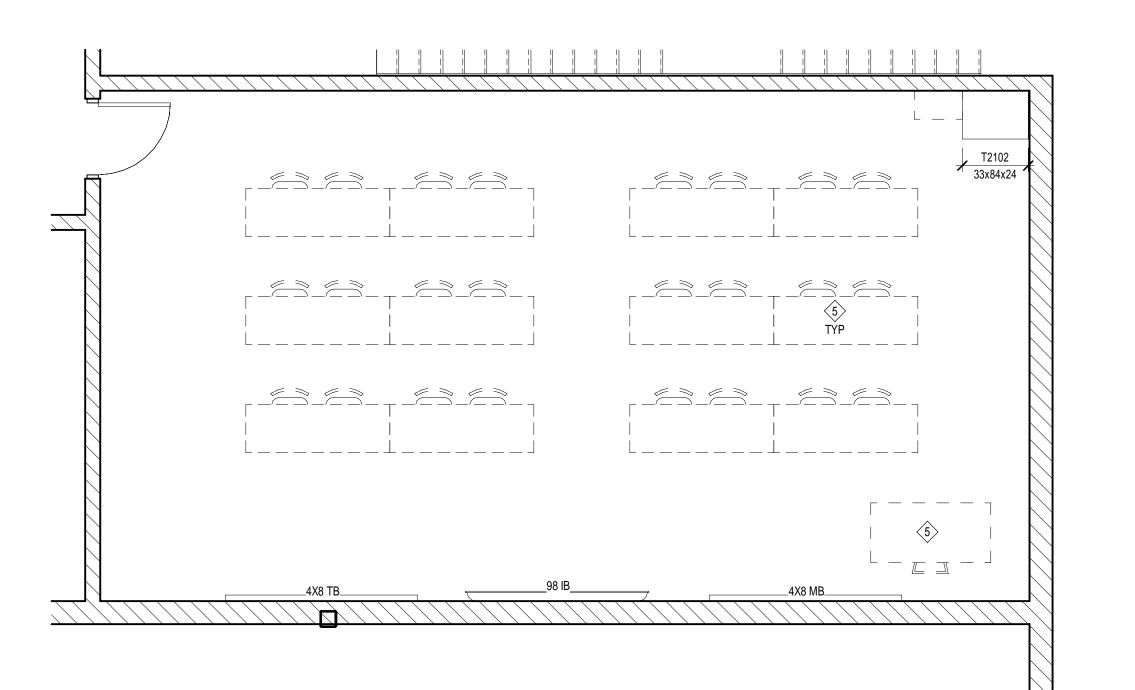

 \vdash - -

GENERAL WORK NOTES

- REFER TO MECH./ELEC. DRAWINGS FOR SPECIFIC NOTES REGARDING MECH/ELEC. ITEMS NOT SHOWN ON THIS SHEET.
- 2. REFER TO ROOF PLAN AND MECH. DRAWINGS FOR ADDITIONAL INFORMATION REGARDING WORK AT ROOF.
- 3. REFER TO SHEET NO.1 FOR GENERAL NOTES AND PARTITION TYPES.
- 4. REFER TO DETAILS ON SHEET A6.1 FOR TYPICAL WALL INTERSECTION DETAILS.
- 5. REFER TO SHEET A2.5 FOR TOILET ACCESSORY SCHEDULE. 6. REFER TO A2.7 FOR CASEWORK LEGEND AND NOTES.

PLAN KEY NOTES

- NOTE: NOT ALL KEYNOTES MAY APPLY TO THIS SHEET.
- GYP. BD. BULKHEAD OR SOFFIT ABOVE. REFER TO REFLECTED CLG. PLANS.
 LINE OF BLEACHERS IN RETRACTED POSITION.
- 3. FLOOR TRANSITION. REFER TO SHEET A9.1 FOR DETAILS. 4. LINE OF PRE-ENG. PRE-FIN. ALUM. CANOPY ABOVE OR BELOW. REFER TO DETAIL
- 5. SHELVING / FURNISHINGS / EQUIPMENT PROVIDED BY OWNER, N.I.C.
- 6. FIRE ALARM PANEL. REFER TO ELECTRICAL DWGS.
- 8. BASKETBALL GOAL ABOVE, REFER TO SPECS AND REFLECTED CEILING PLAN FOR MOUNTING CONDITION. ALL EXPOSED BLOCKING REQUIRED FOR GOAL. ATTACHMENT SHALL BE PAINTED TO MATCH ADJACENT WALL COLOR.
- 9. WASHER/DRYER, N.I.C. 10. FOLDABLE WALL PARTITION. REFER TO DETAIL ON A7.1 FOR CEILING CONDITION.
- 12. ELECTRICALLY OPERATED FOLDING BLEACHERS, REFER TO SPECIFICATIONS AND DETAIL 4/A1.2. 13. SCORERS TABLE (N.I.C.) 14. ADULT CHANGING TABLE.
- 15. ATHLETIC WALL PADS FOR LIMITS SHOWN, REFER TO SPECIFICATIONS. 17. WALL MOUNTED COUNTERTOP, REFER TO DETAIL 14/A2.7.
- 18. COMPUTER STATION, N.I.C. REFER TO ELECTRICAL DWGS. FOR DATA AND
- 19. HIGH/LOW WATER FOUNTAIN UNIT. REFER TO MECH./ELEC. DRAWINGS.
- 20. INDUSTRIAL STAIR PER OSHA STANDARDS. REFER TO REFERENCED DETAIL AND
- 21. SCOREBOARD ABOVE AT 11'-0" A.F.F. (TO B.O. SCOREBOARD). REFER TO SPECIFICATIONS AND ELECTRICAL DRAWINGS.
- 22. ROOF HATCH ABOVE. SEE DETAIL _ 23. MECHANICAL LOUVER. REFER TO DETAIL 8/A6.2.
- 24. RECESSED CONCRETE FLOOR SLAB IN THIS AREA. REFER TO STRUCTURAL DWGS. 25. ELECTRIC PUSH-BUTTON ADA DOOR OPERATOR. REFER TO ELEC. DWGS.
- 26. DOOR ACCESS CONTROL LOCATION.27. VOLLEYBALL FLOOR INSERTS, FLUSH WITH WOOD FLOOR.
- 28. PRE-FIN. ALUM. FIXED WALL LADDER. REFER TO ______.
- 29. DOUBLE TIER STUDENT LOCKERS. 30. ATHLETIC LOCKERS. 31. SINGLE TIER LOCKERS.
- 32. RETRACTABLE GYMNASIUM DIVIDER, REFER TO SPECIFICATIONS. 33. AREA OF NEW FLOOR INFILL. REFER TO STRUCTURE. 34. PAINT EXISTING WALL MATCHING THE EXISITNG WALL COLOR.
- 35. CANOPY ABOVE. REFER TO SHEET A5.2. 36. ADULT CHANGING TABLE, N.I.C.

SYMBOLS LEGEND

101 | # ROOM FINISH GROUPS (REFER TO SHEET N0.1) - ROOM NUMBER

- DOOR NUMBER (DOOR SCHEDULE SHEET A8.1)
- NEW WORK KEY NOTES (SHEETS A1.1 THROUGH A2.2)
- WALL TYPE (SCHEDULE SHEET N-1) ALUMINUM OR HOLLOW METAL FRAME OR STOREFRONT TYPE (REFER TO
- FLOOR PLANS AND SCHEDULE SHEETS A8.1-A8.2)
- TOILET ACCESSORIES (SCHEDULE SHEET A2.2) ELEVATION KEY NOTE (SHEET A3.1-A3.3)
- ROOF KEY NOTE (SHEET A4.1)
- CEILING PLAN KEY NOTE (SHEETS A7.1-A7.6)
- SIGNAGE KEY NOTE (SHEETS A0.1) DASHED LINE INDICATES WALL TILE AT RESTROOMS
 AND BRADLEY SINK WALLS - SHOWN ON RESTROOM PLANS.

(TILE WALL DETAIL 21/A2.4)

FB2 2 HOUR FIRE BARRIER

FW2 2 HOUR FIRE WALL

CONTROL JOINT, REFER TO EXTERIOR ELEVATIONS FOR EXTERIOR LOCATIONS.

BOARD SCHEDULE

- TB TACKBOARD, IN CONTRACT.
- MB MARKERBOARD, IN CONTRACT.
- IB INTERACTIVE BOARD, OFCI. COORDINATE LOCATION & SIZE WITH OWNER.
- TV TELEVISION, OFCI. COORDINATE LOCATION & SIZE WITH OWNER. MOUNT MULTIMEDIA BOX AT HEIGHT INDICATED, 5'-0" A.F.F. U.N.O.
- VW VIDEO WALL, OFCI, COORDINATE LOCATION & SIZE WITH OWNER. REFER TO


ZC **AUA** 4 ΣШΙ $\alpha \vdash z$ шсс Idd S C M ∠

9220 HOF NORT

ENLARGED

JOB NO. DRAWN CHECKED COPYRIGHT © 2023 SHERMAN CARTER BARNHAR ARCHITECTS, PLLC REVISIONS

2246 SOUTH HOPKINS SCHOOL 9/11/2023 2:58:34 PM

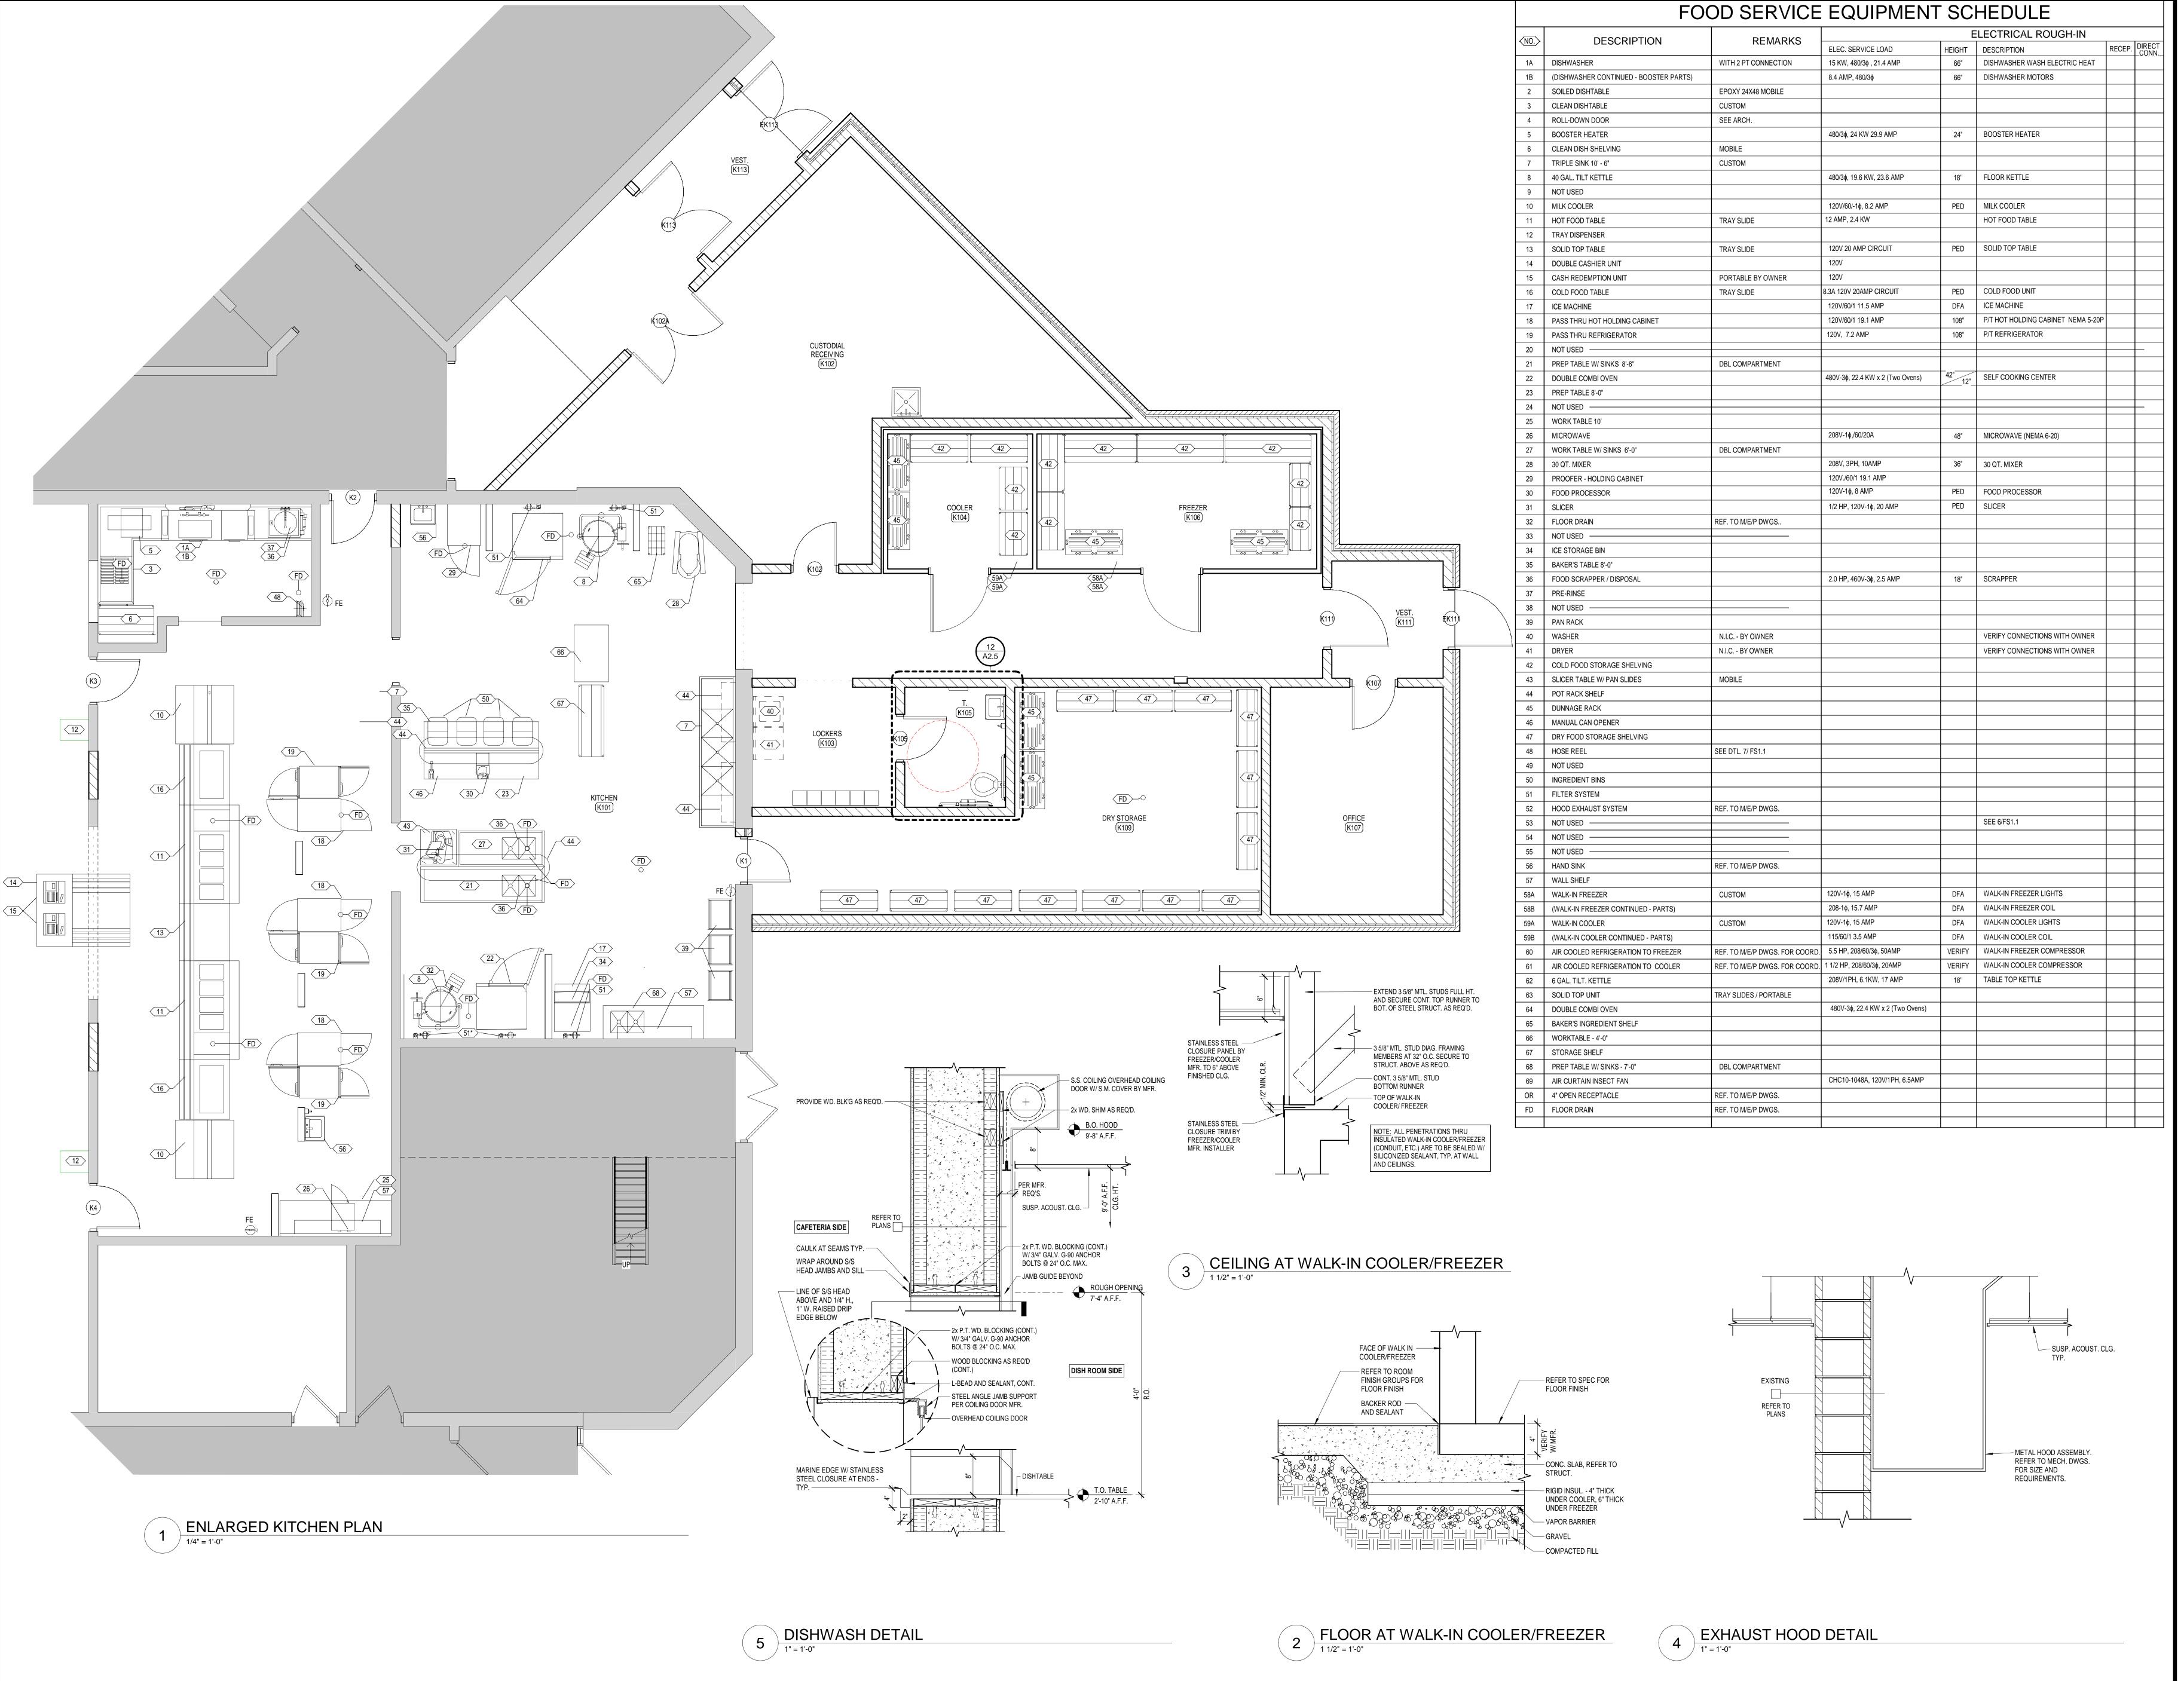

2246 SOUTH HOPKINS SCH 9/11/2023 2:58:40 PM SHERMAN CARTER BARNHART ARCHITECTS

PROGRESS SE

S SCHOOL

9220 HOPKINSVILLE RE NORTONVILLE, KY

ENLARGED KITCHEN PLA

JOB NO. 2246

DATE SEPT 11,2023

DRAWN AN

CHECKED AHO


COPYRIGHT © 2023
SHERMAN CARTER BARNHART
ARCHITECTS, PLLC

REVISIONS

No. Description Date

SHEET

A2.4

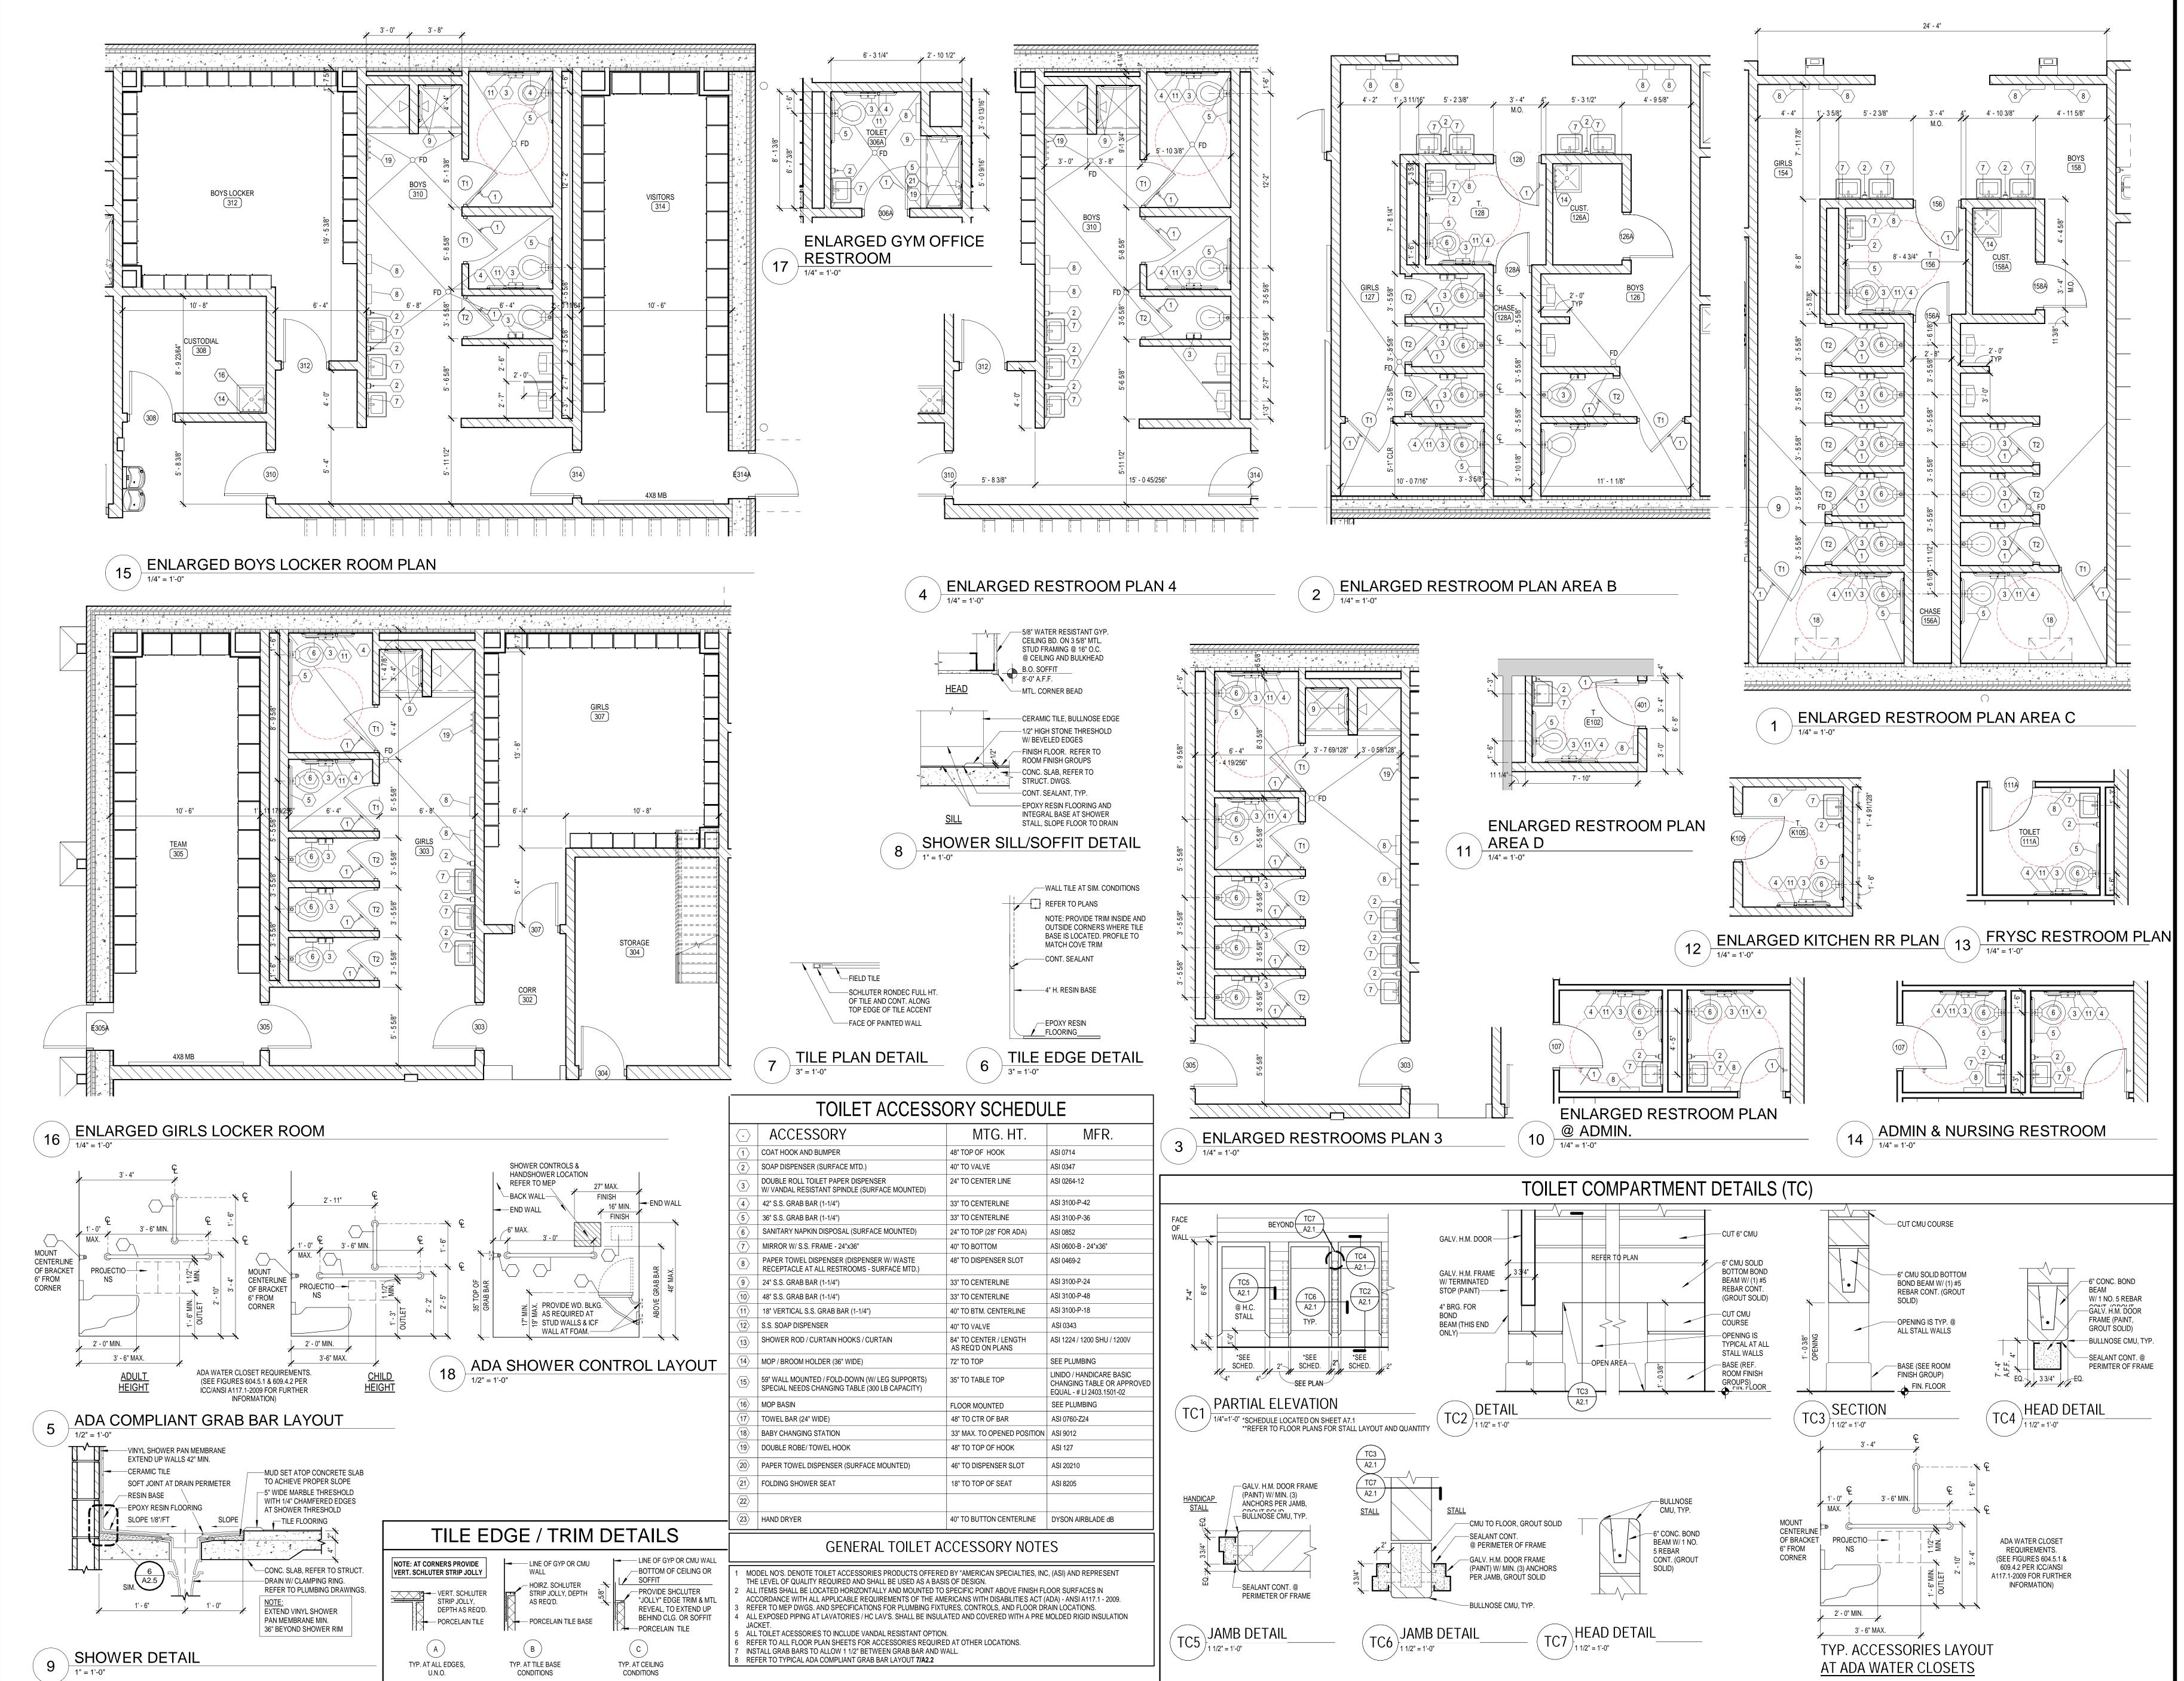

2246 SOUTH HOPKINS SCH 9/11/2023 2:58:54 PM SHERMAN CARTER BARNHART ARCHITECTS

CHOOL

9220 HOF NORT

INLARGED RESTROOM PLANS

JOB NO. 2246

DATE SEPT 11,2023

DRAWN AN

CHECKED AHO

COPYRIGHT © 2023
SHERMAN CARTER BARNHART
ARCHITECTS, PLLC

REVISIONS

No. Description Date

SHEET

A2.5

Z C


AMA $\Sigma \sqcup \mathbf{I}$


 $\alpha \vdash Z$


шсс


IV


S C M ≤

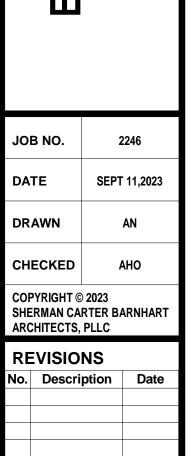

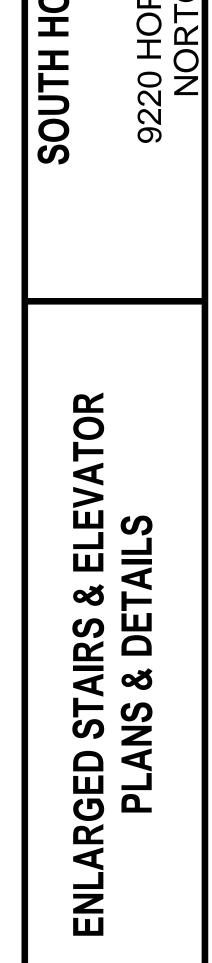

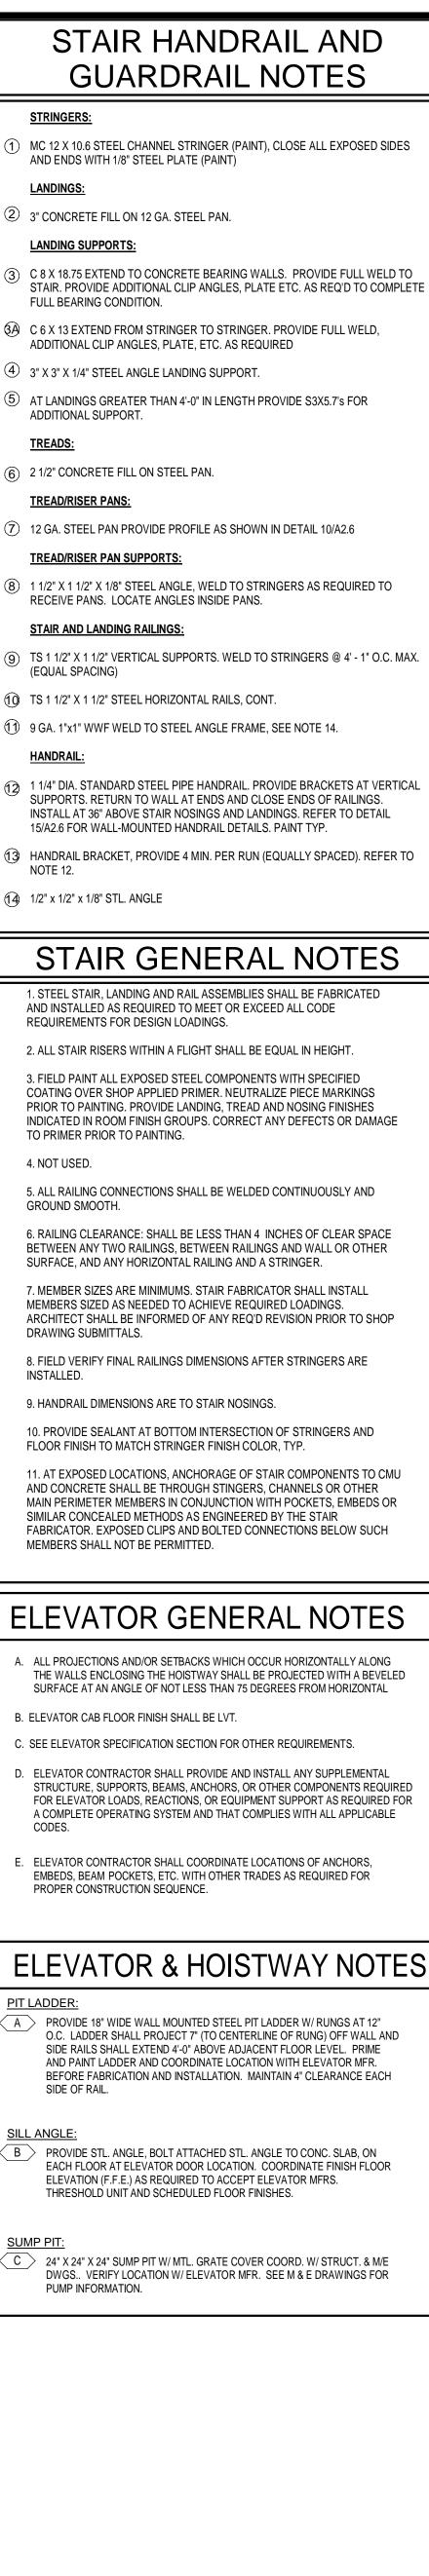

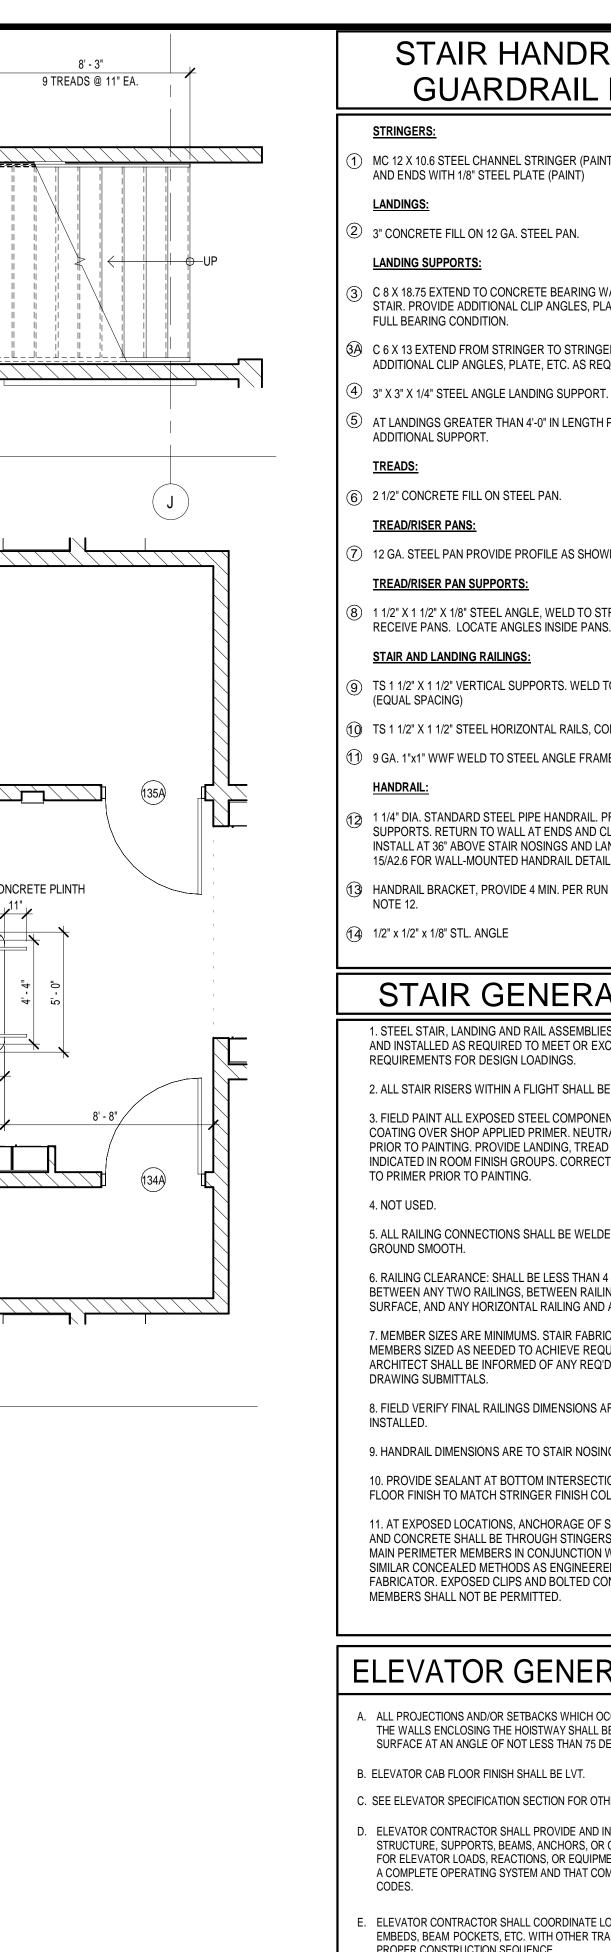

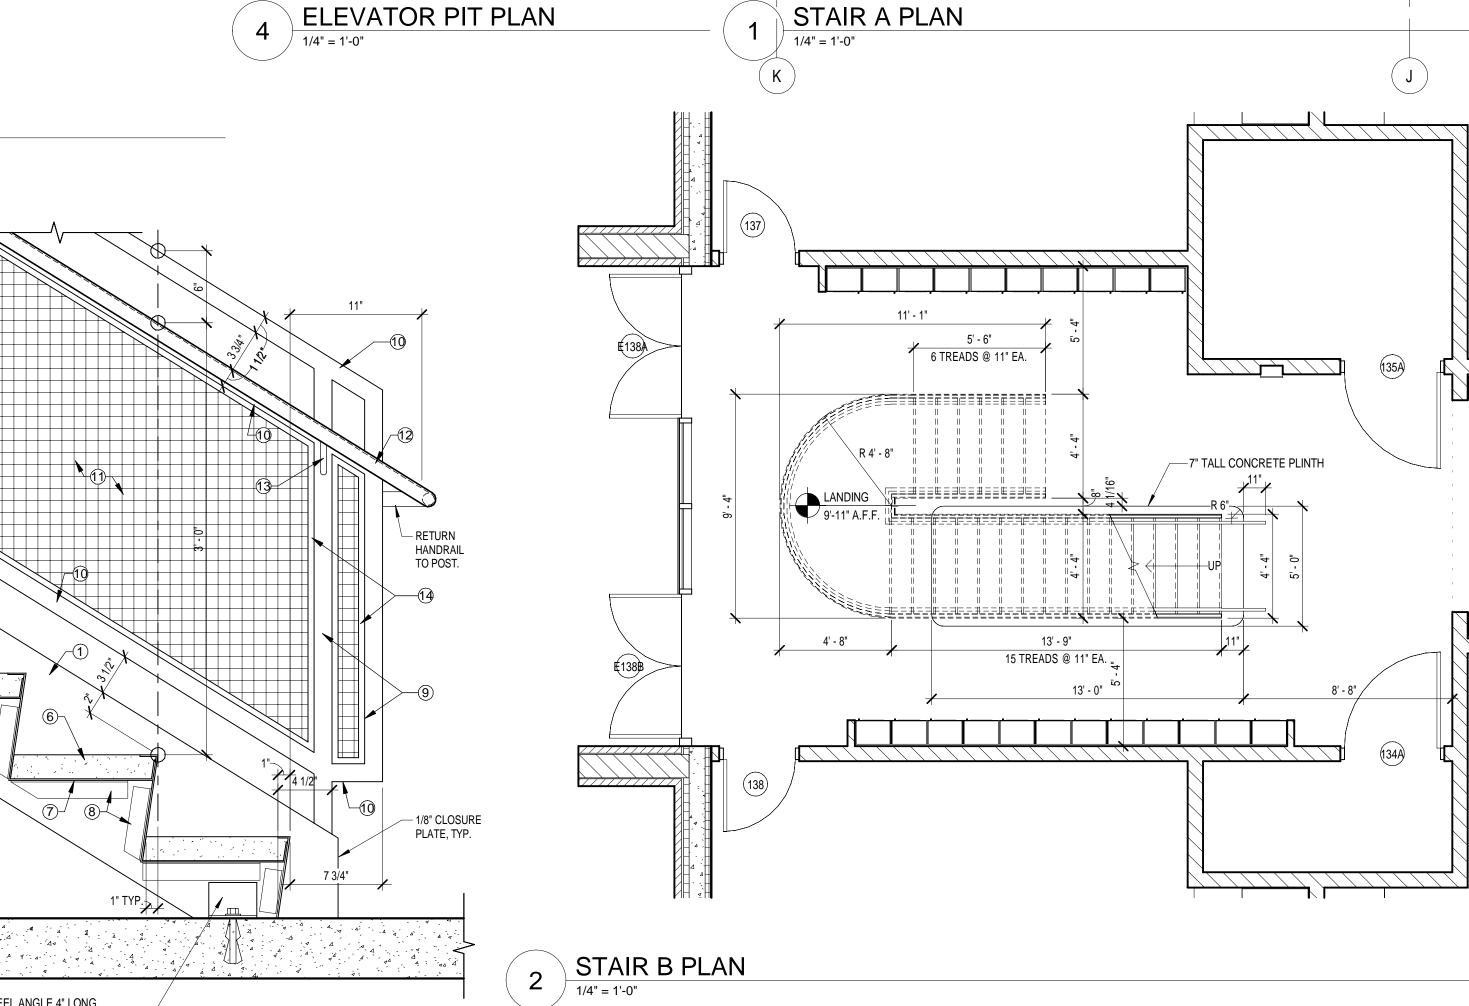

13 TREADS @ 11" EA.

CONC. FOUNDATION WALL, REFER TO STRUCT., TYP.

ELEVATOR PIT F.F.E. 94'-0"

VERIFY W/

ELEVATOR MFR.

1 TREAD DEPTH

HANDRAIL WALL

WD. BLKG. FOR

ANCHORAGE.

BRACKET WITH HIDDEN

AT BOTTOM OF STAIR RUN

FASTENERS. PROVIDE

3" X 3" X 1/4" STEEL ANGLE 4" LONG, WELD TO STRINGER AND ANCOR TO

CONCRETE SLAB WITH 1/2" DIA.

- HANDRAIL WALL BRACKET

ANCHORAGE.

EDGE OF STAIR NOSING

- RETURN ENDS TO WALL

AND CLOSE.

AT TOP OF STAIR/RAMP RUN

WALL —

BEYOND

16 A2.5_10_GUARDRAIL DETAIL

STRINGER DTL. @ WALL TYP. 11/2" = 1'-0" STAIR PAN DETAIL

BEYOND

WITH HIDDEN FASTENERS. PROVIDE WD. BLKG. FOR

15 WALL HANDRAIL DETAIL (TYP.)

REFER TO STAIR

NOTES, THIS SHEET

AND RAILING


NOTE: PROVIDE WALL BRACKET


SPACED) MINIMUM PER RUN OF

EVERY 60" MAX. (4) BRACKETS (EQUAL

— EDGE OF STAIR NOSING

RETURN ENDS TO WALL

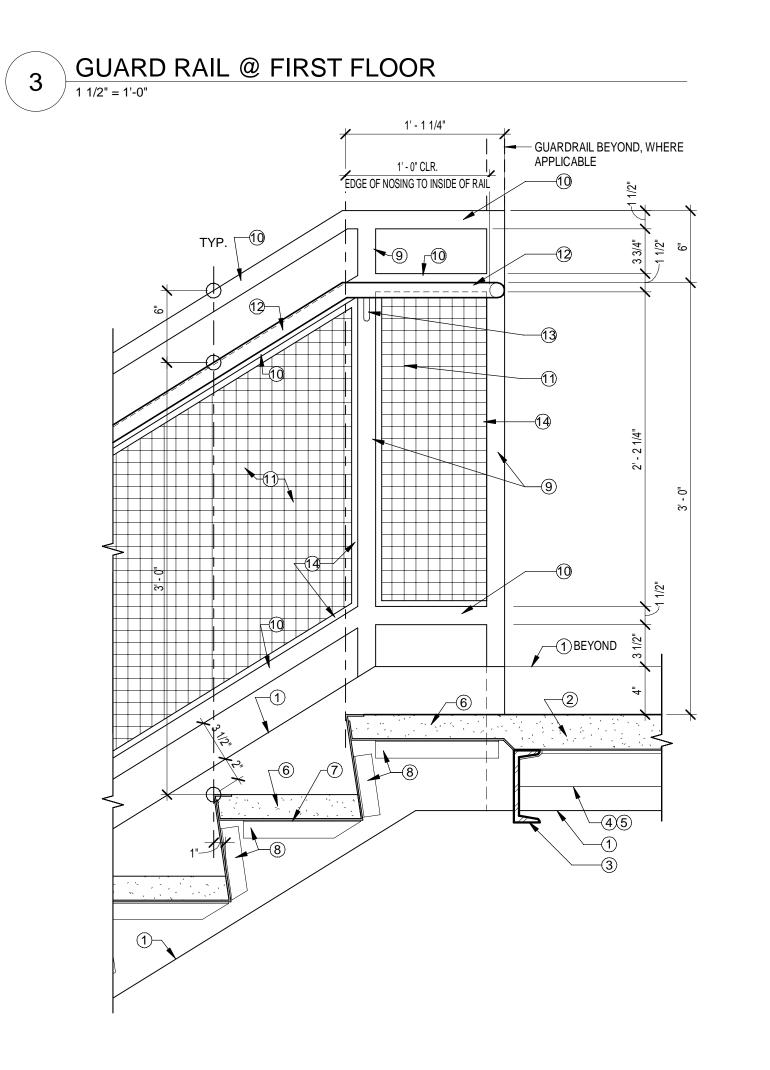

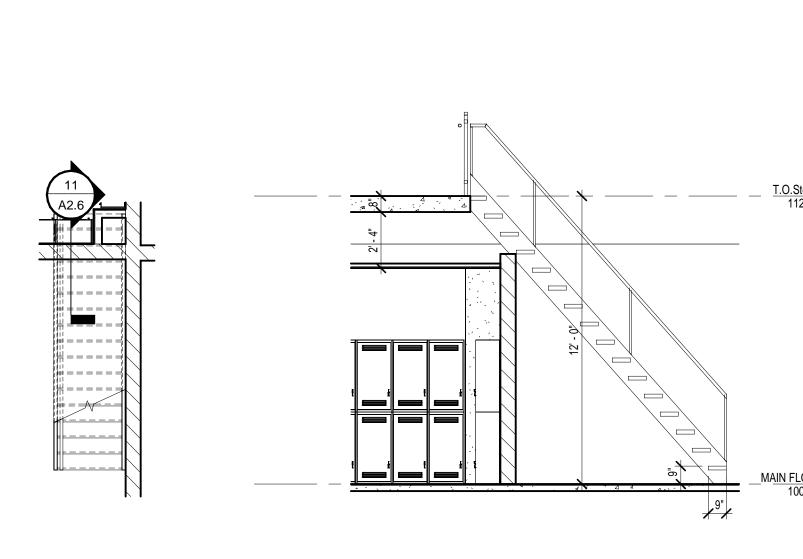



9 INDUSTRIAL STAIRS IN AREA C

11 AREA A - TRANS. SECT. 02

GUARDRAIL DETAIL

1 1/2" = 1'-0"

/-INFILL STAIR PAN

2246 SOUTH HOPKINS SCH^I 9/11/2023 2:59:01 PM

_____ 1 1/4"Ø ALUM. PIPE

- 1/8" PLATE END

10'-4 1/2" +/-

CONCRETE SLAB ——

GAURDRAIL WHERE NOTED

ON PLAN —

FACE OF WALL -

—3" CORE DRILL AND

GROUT SOLID, TYP.

HANDRAIL

NOTE: PROVIDE 3'-0" WIDE TREAD WIDTH PRE-FIN.

INDUSTRIAL STAIR AND

PLATFORM PER OSHA

STANDARDS. REFER TO

FOR COMPLETE

INSTALLATION OF

SPECS. ALL COMPONENTS

INDUSTRIAL STAIR SHALL

DIAMOND BOARD TREADS,

BE PROVIDED BY MFR.

ALUM. STRINGER -

ANGLE @ EA. STRINGER,

W/ 3/4" EXP. BOLTS ---

ANCHOR TO CONC. SLAB

5 INDUSTRIAL STAIR DETAIL

1" = 1'-0"

CANE RAIL DETAIL

RETURN ENDS TO


WALL AND CLOSE -

HANDRAIL WALL BRACKET

WITH HIDDEN FASTENERS —

PROVIDE WD. BLKG. @ — BRACKET LOCATIONS FOR ANCHORAGE WHERE REQ'D OUTSIDE FACE OF

STRINGER BELOW —

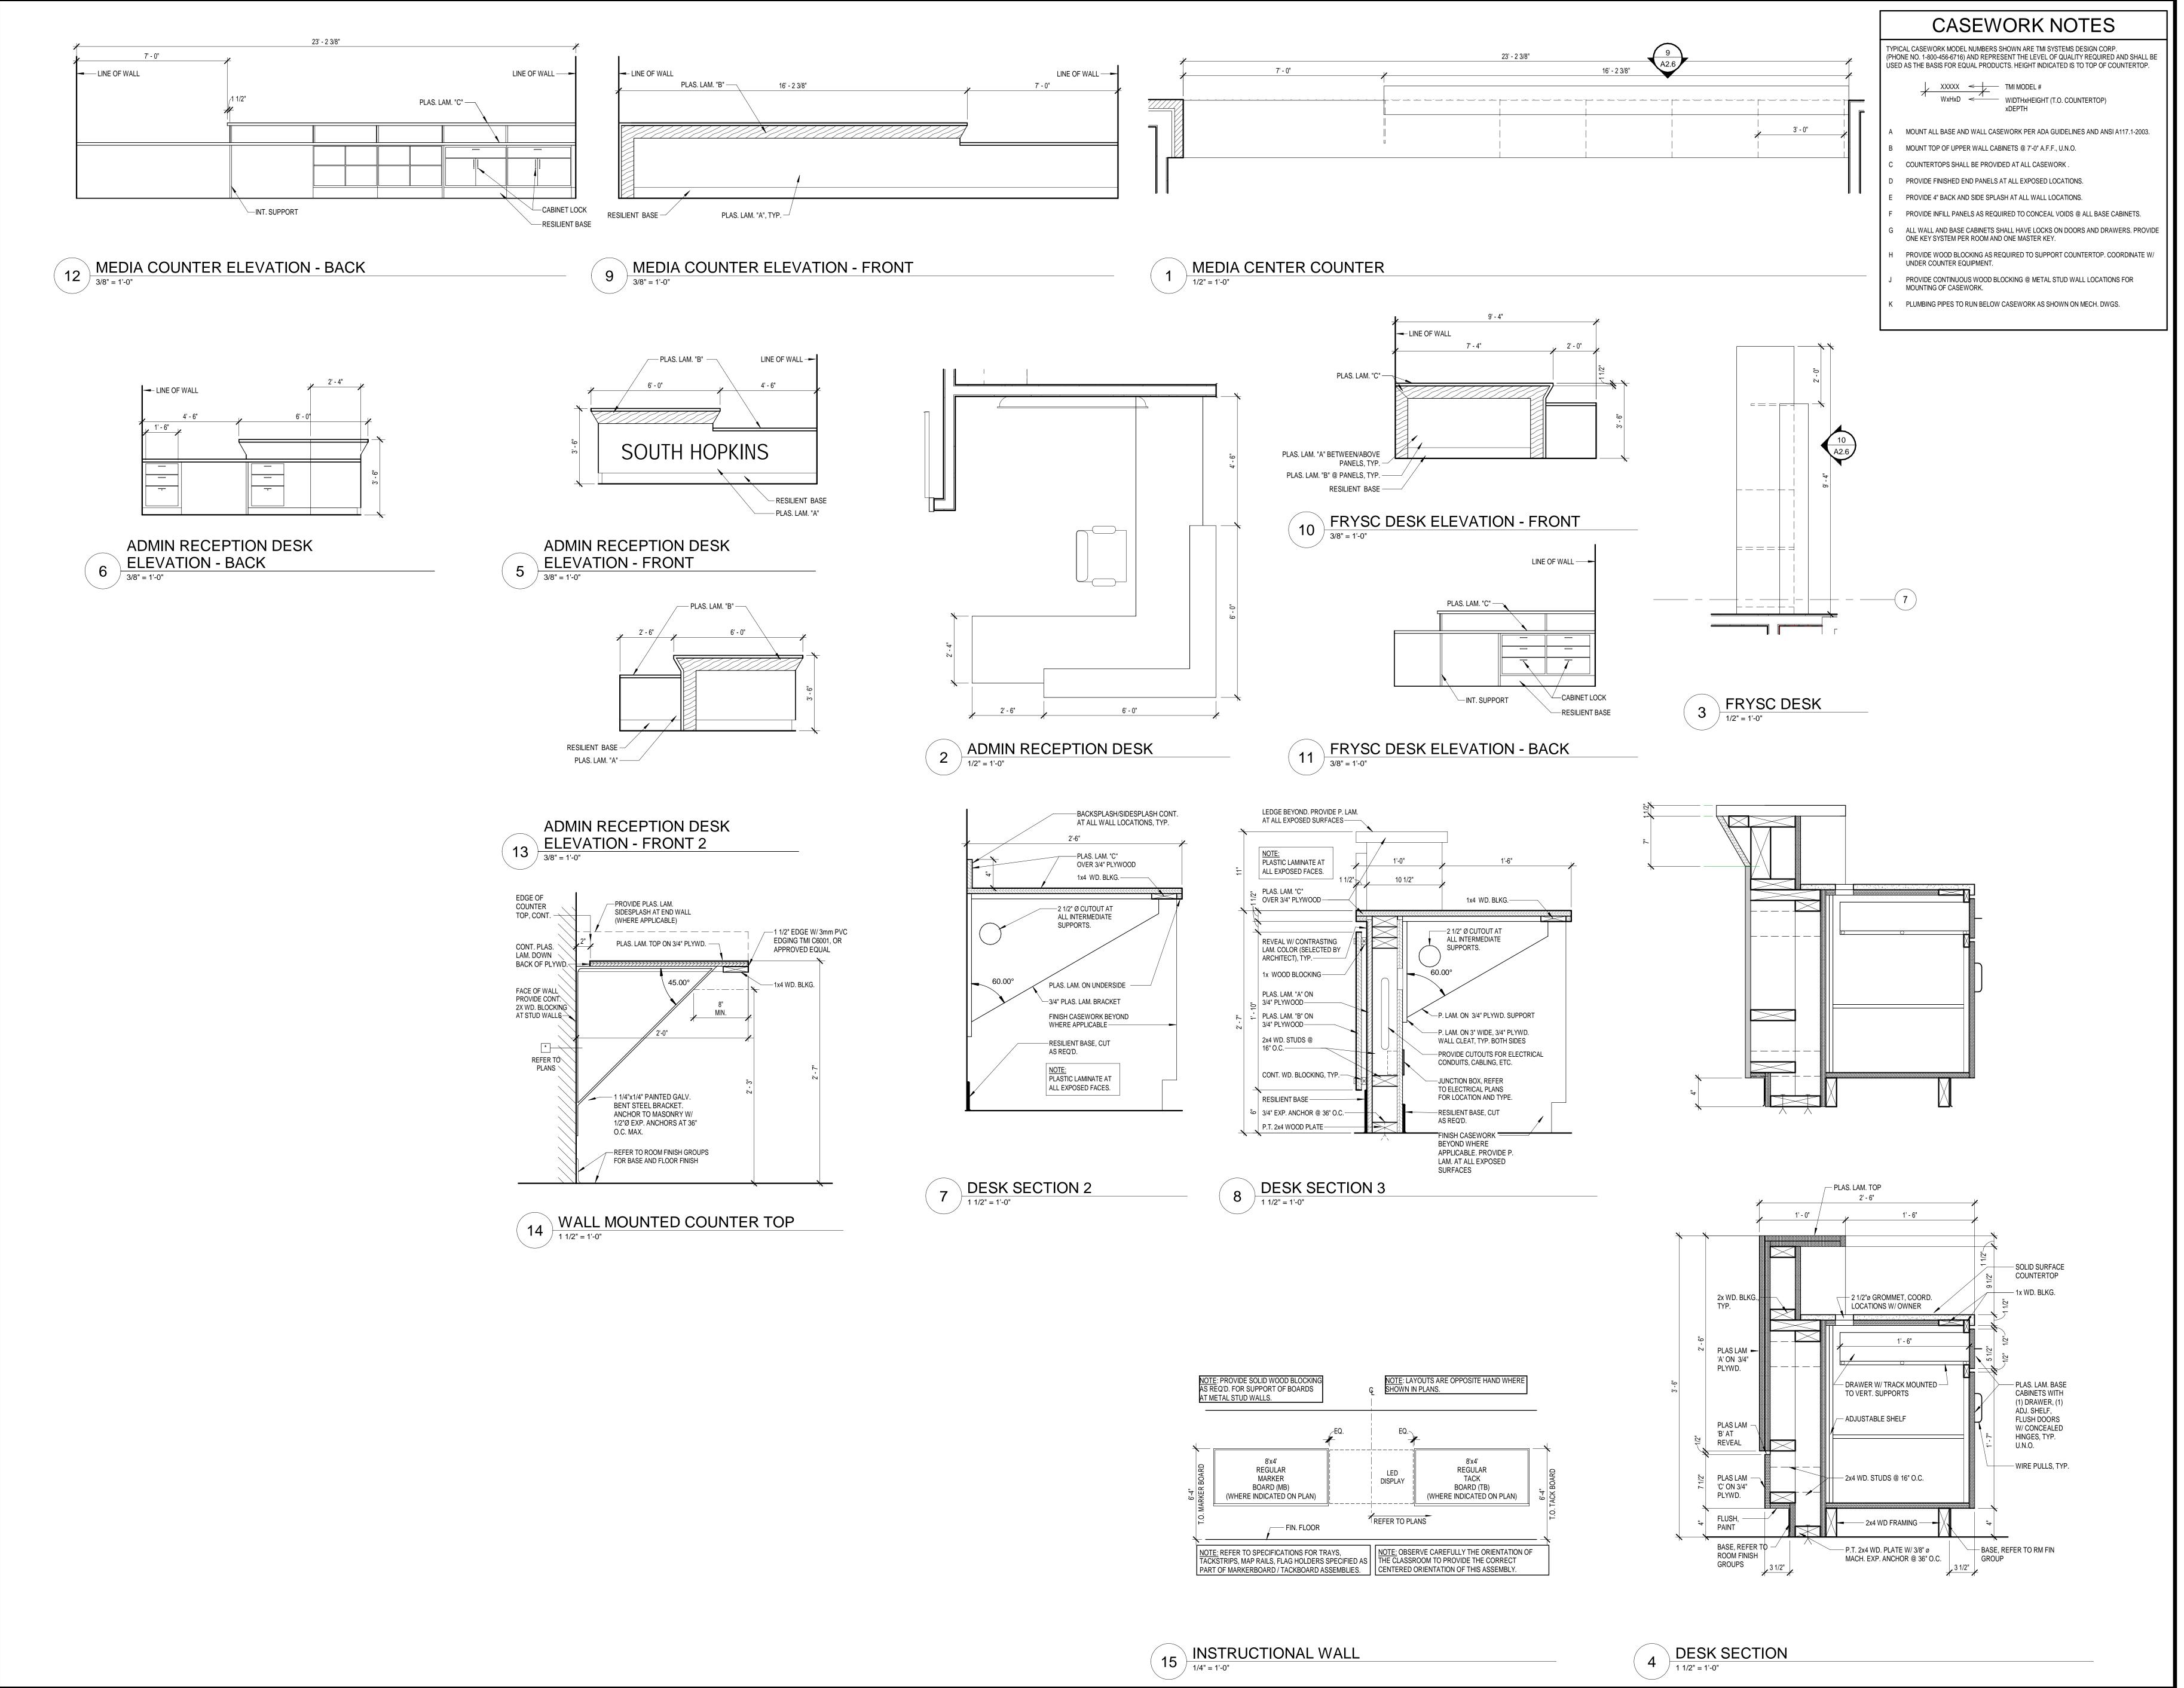


2246 SOUTH HOPKINS SCH 9/11/2023 2:59:06 PM

Z C 444 ∑шІ $\alpha \vdash z$ шкк Idd S C M ∠

SOUTH HOPKINS SCHOOL PKINSVILLE RD, TONVILLE, KY 9220 HOF NORT

> PLANS, CASEWORK S AND DETAILS ENLARGED NOTES

JOB NO. SEPT 11,2023 Author DRAWN Checker CHECKED COPYRIGHT © 2023 SHERMAN CARTER BARNHART ARCHITECTS, PLLC REVISIONS No. Description Date

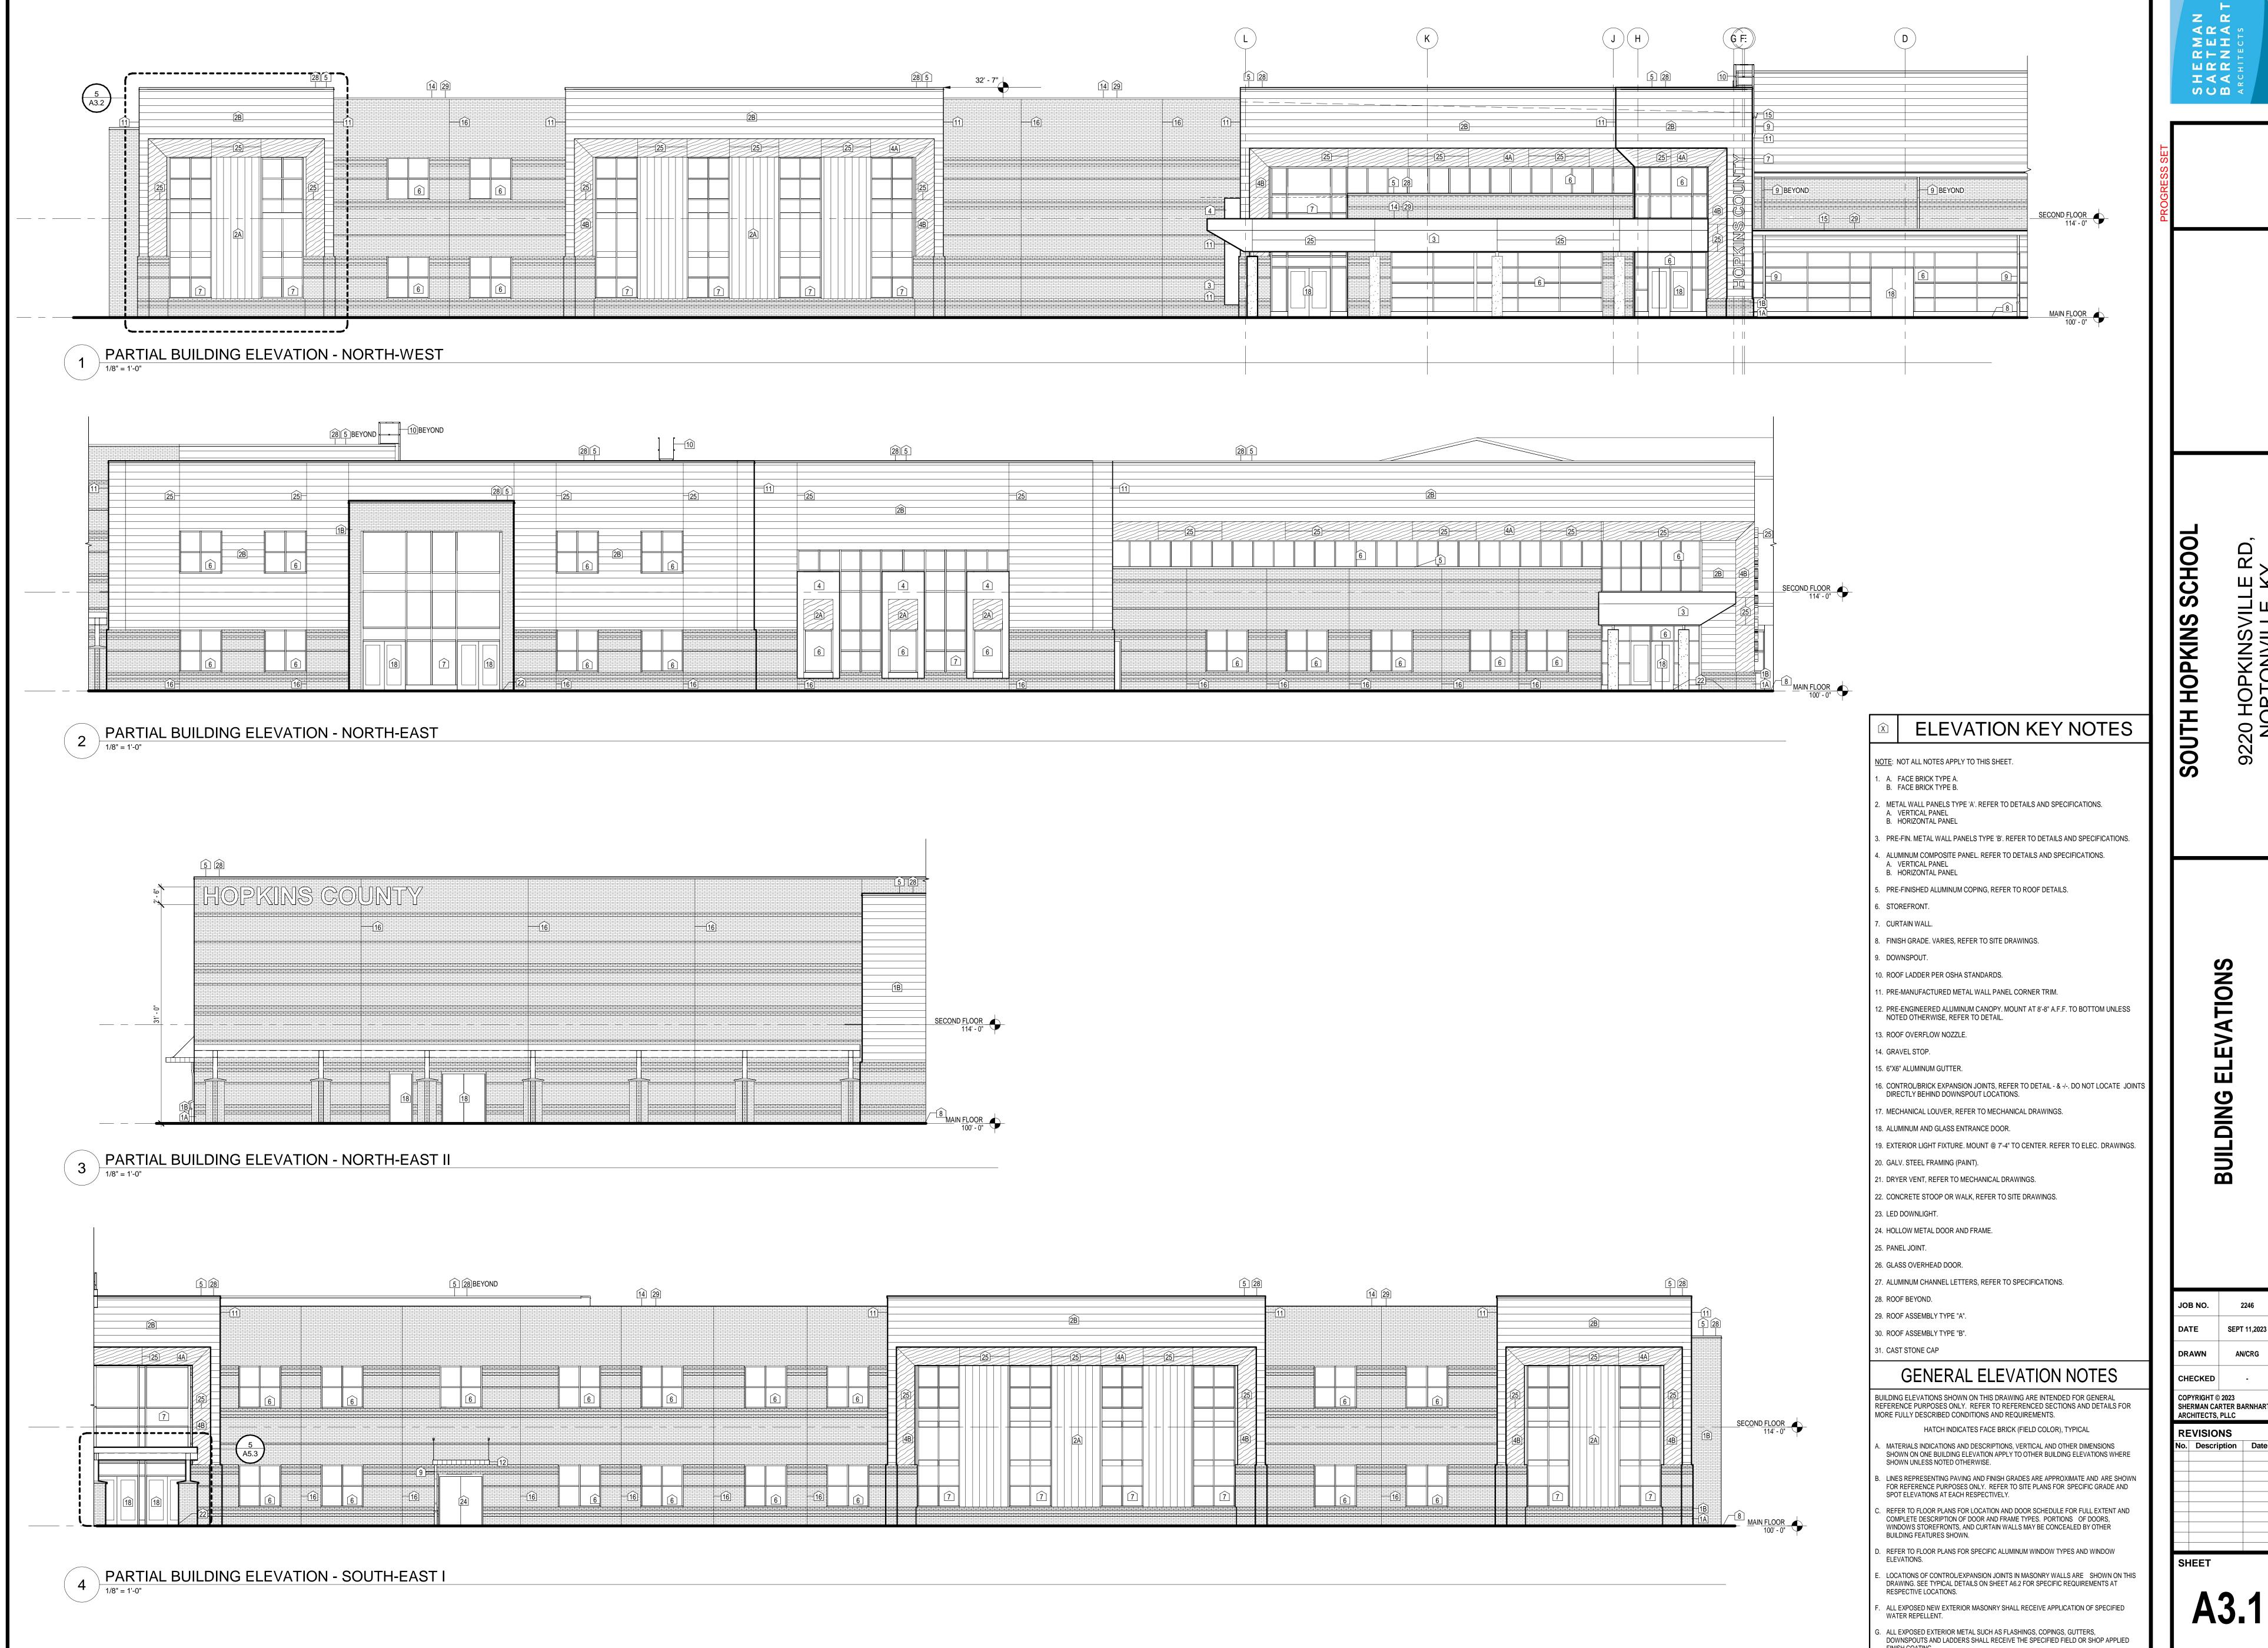


2246 SOUTH HOPKINS SCH 9/11/2023 2:59:22 PM

ZC **444** ZHI ZHI шсс I **4 4** $\stackrel{\circ}{\scriptstyle{\circ}}$ ကပ္ကာ နို

ELEVATIONS BUILDING

9220 HOF NORT

SEPT 11,2023 AN/CRG DRAWN CHECKED COPYRIGHT © 2023 SHERMAN CARTER BARNHART ARCHITECTS, PLLC REVISIONS

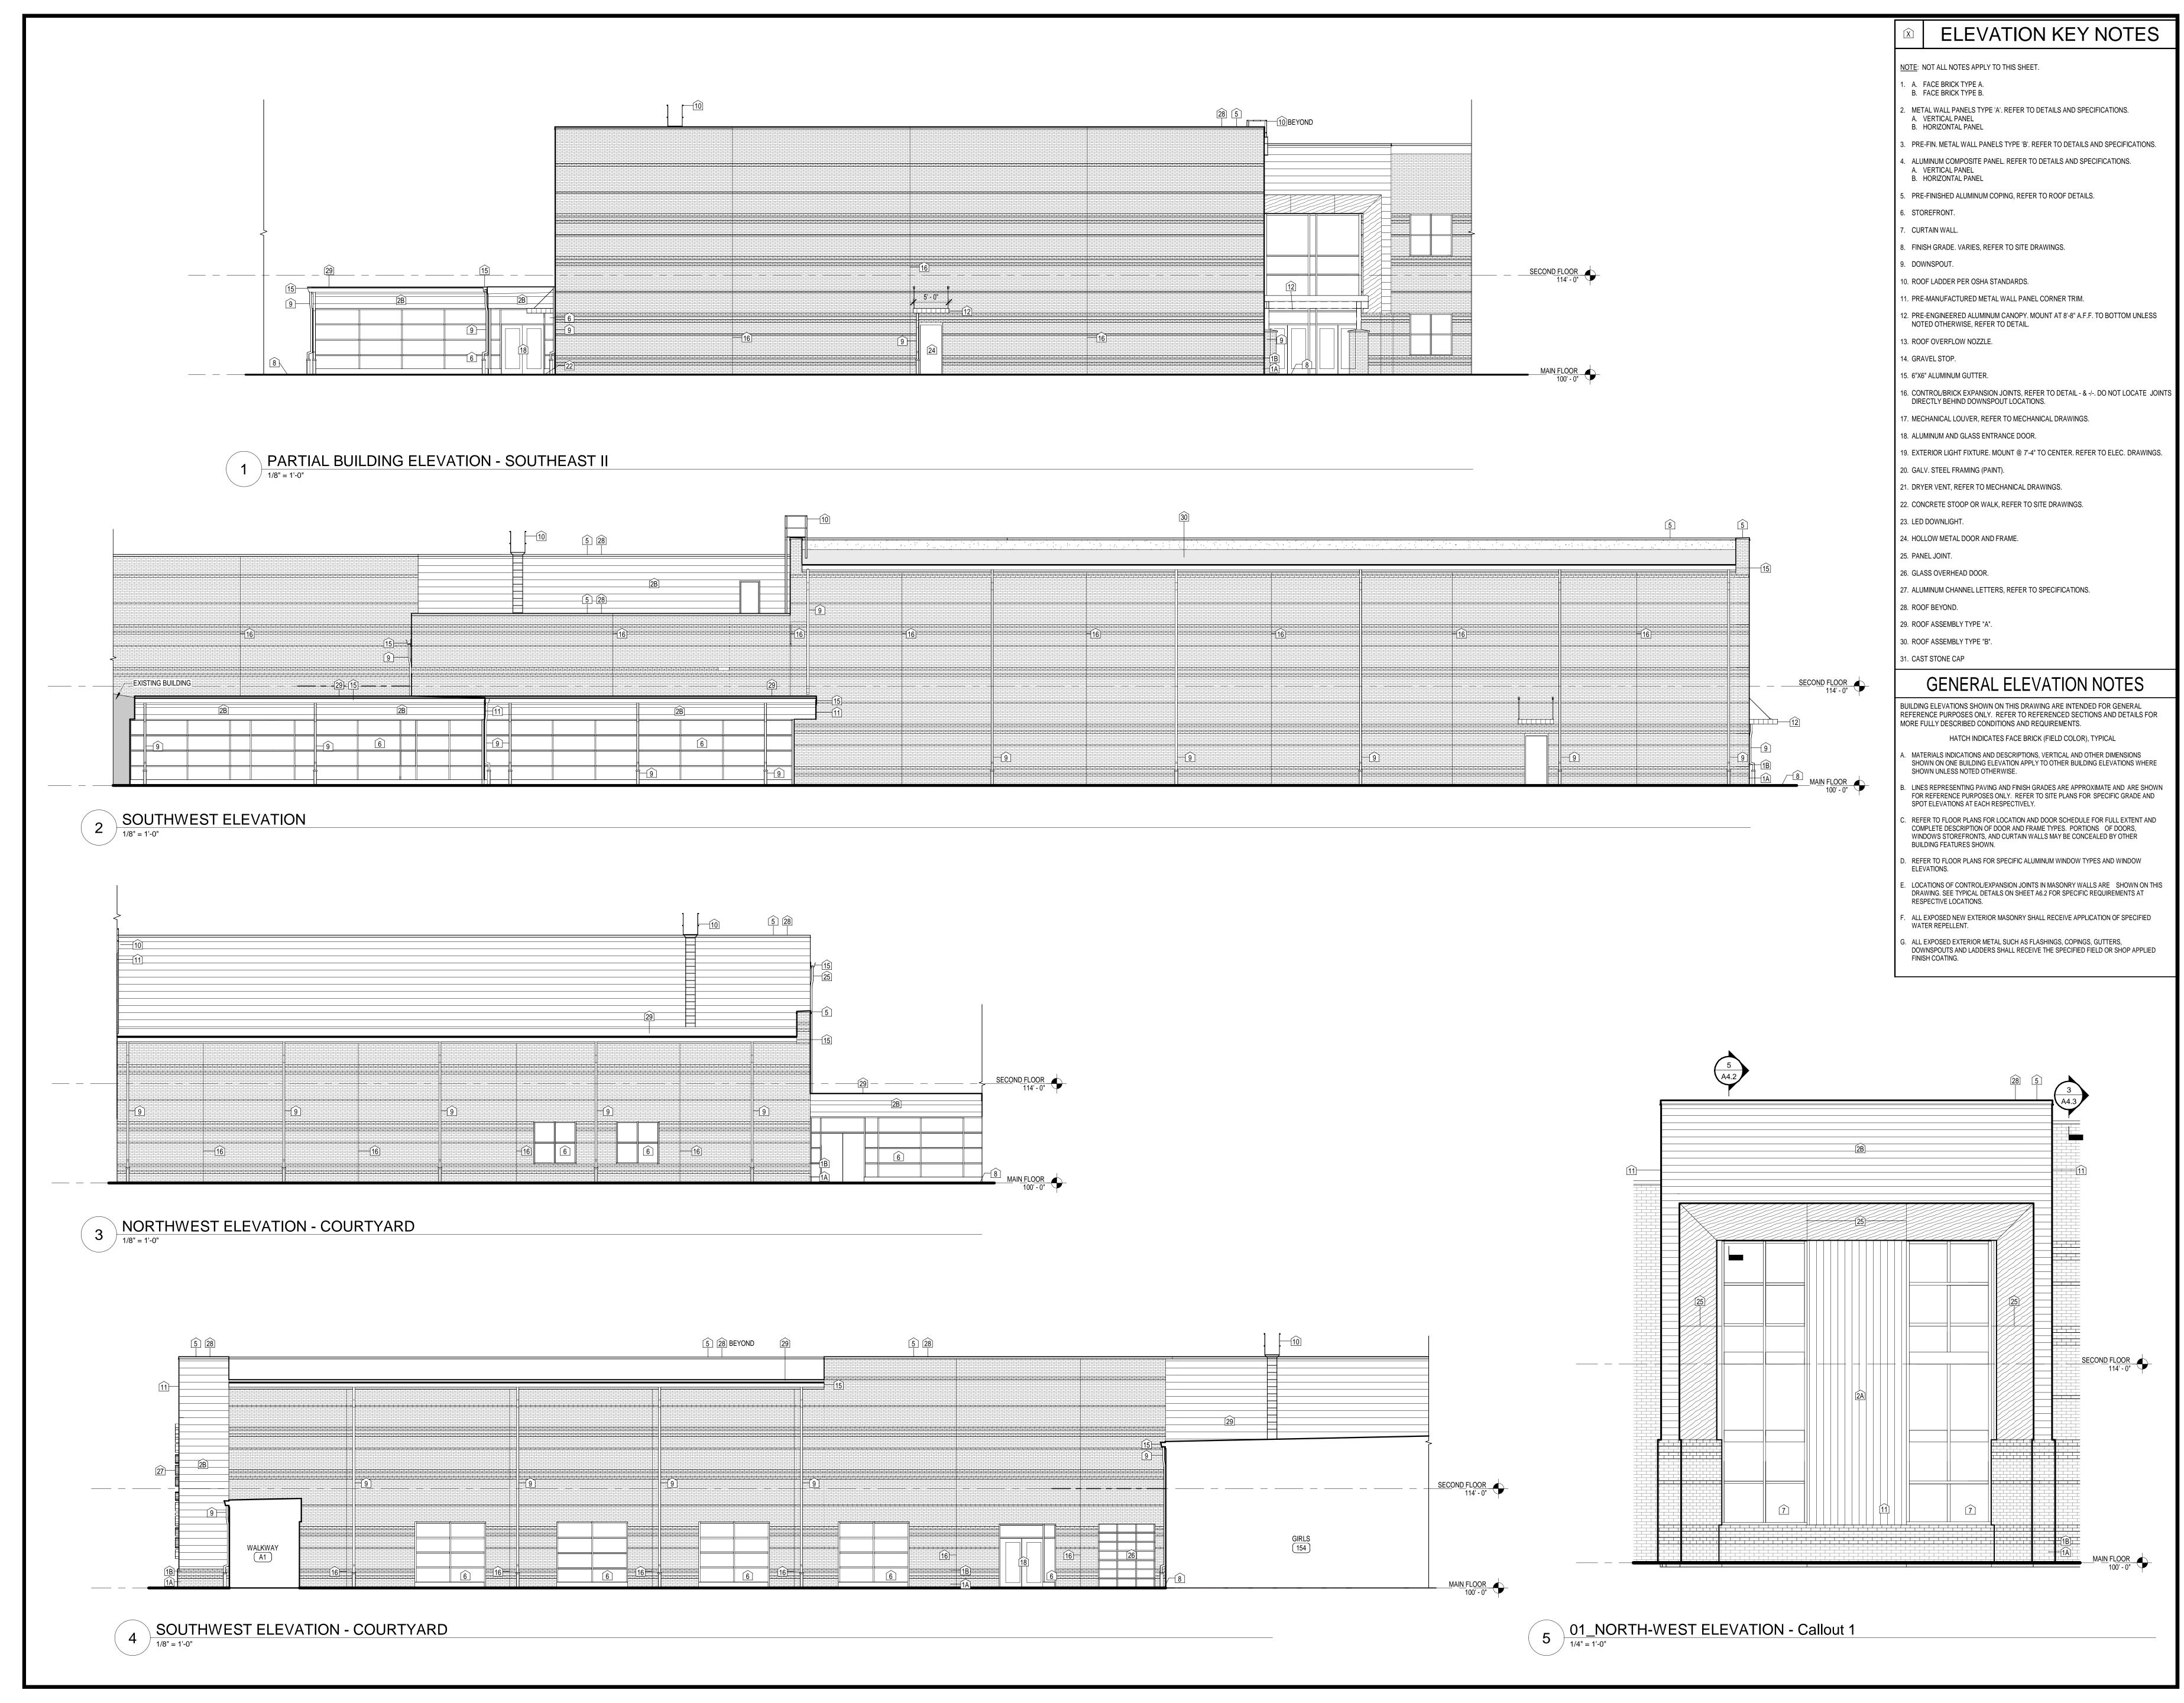

2246 SOUTH HOPKINS SCH 9/11/2023 2:59:36 PM SHERMAN CARTER BARNHART ARCHITECTS

OPKINS SCHOOL

9220 HOPKINSVILLE RD, NORTONVILLE, KY

BUILDING ELEVATIONS

JOB NO. 2246

DATE SEPT 11,2023

DRAWN AN, CRG


CHECKED
COPYRIGHT © 2023
SHERMAN CARTER BARNHART
ARCHITECTS, PLLC

REVISIONS

No. Description Date

SHEET

A3.2

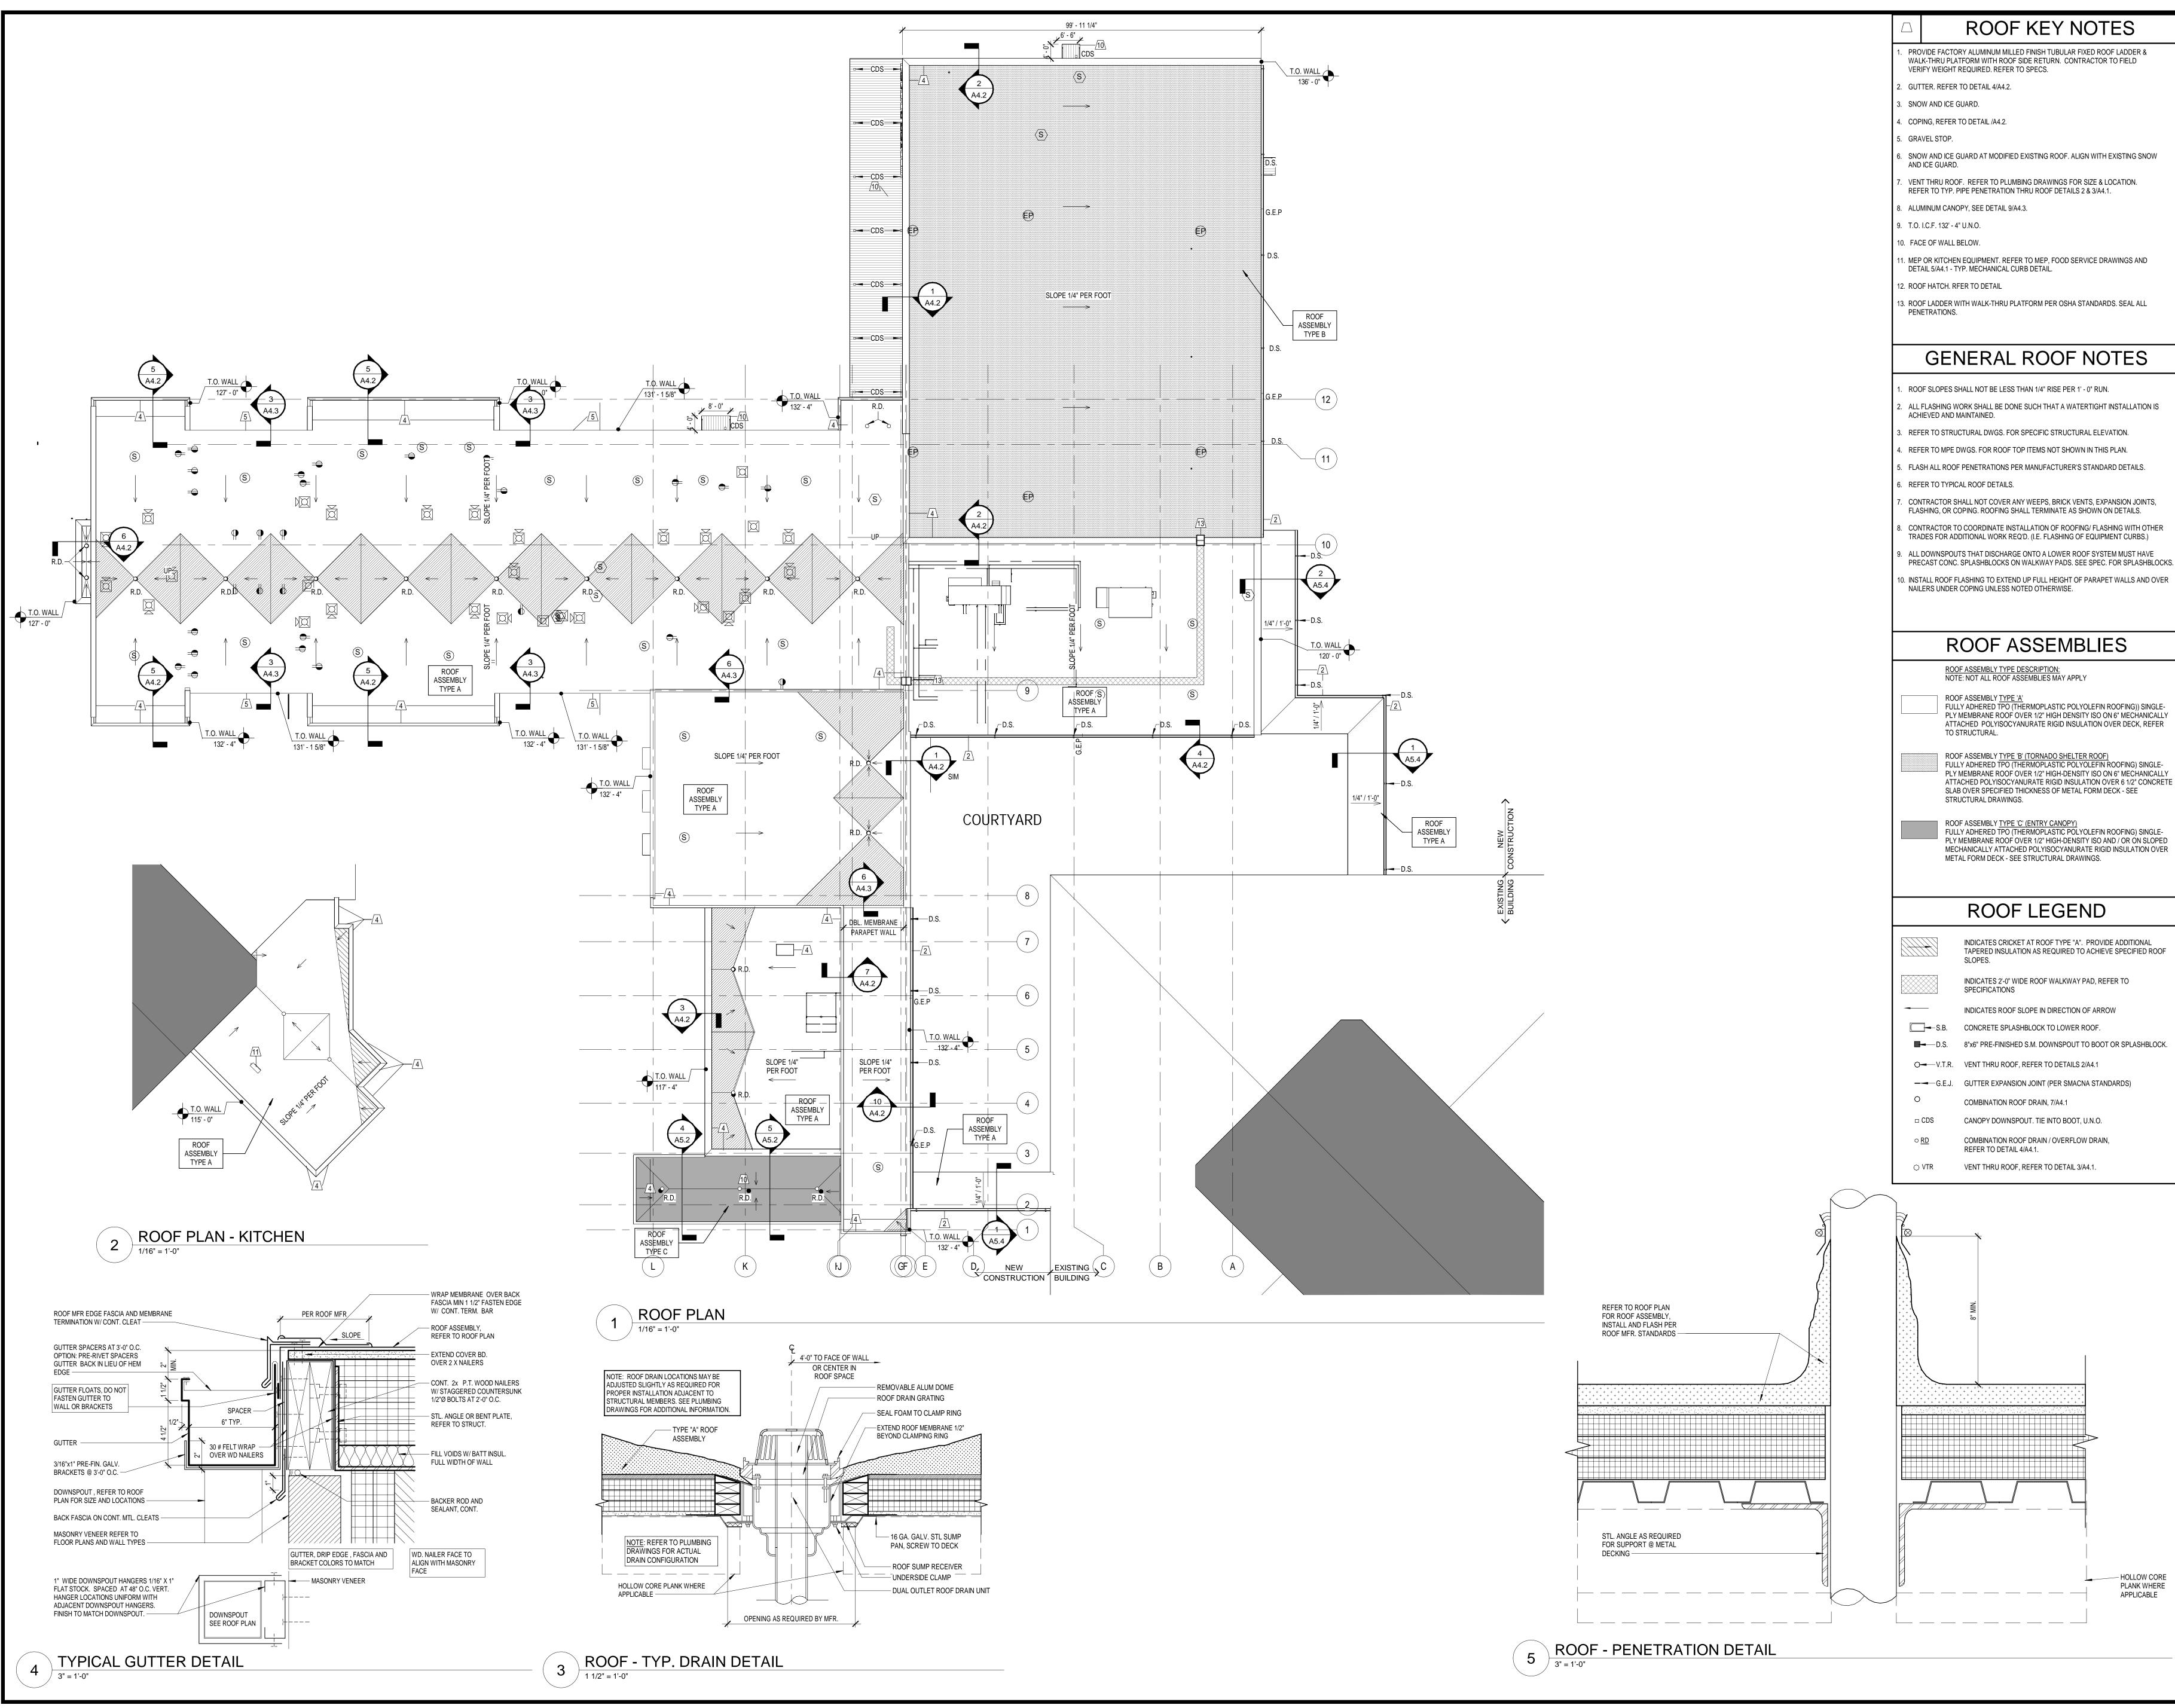

SHERMAN CARTER BARNHART ARCHITECTS

HOPKINS SCHOOL

220 HOF NORT

ROOF PLAN AND DETAILS

JOB NO. 2246

DATE SEPT 11,2023

DRAWN Author

CHECKED Checker

COPYRIGHT © 2023
SHERMAN CARTER BARNHART
ARCHITECTS, PLLC


REVISIONS

No. Description Date

No. Description Date

SHEET

A4.1

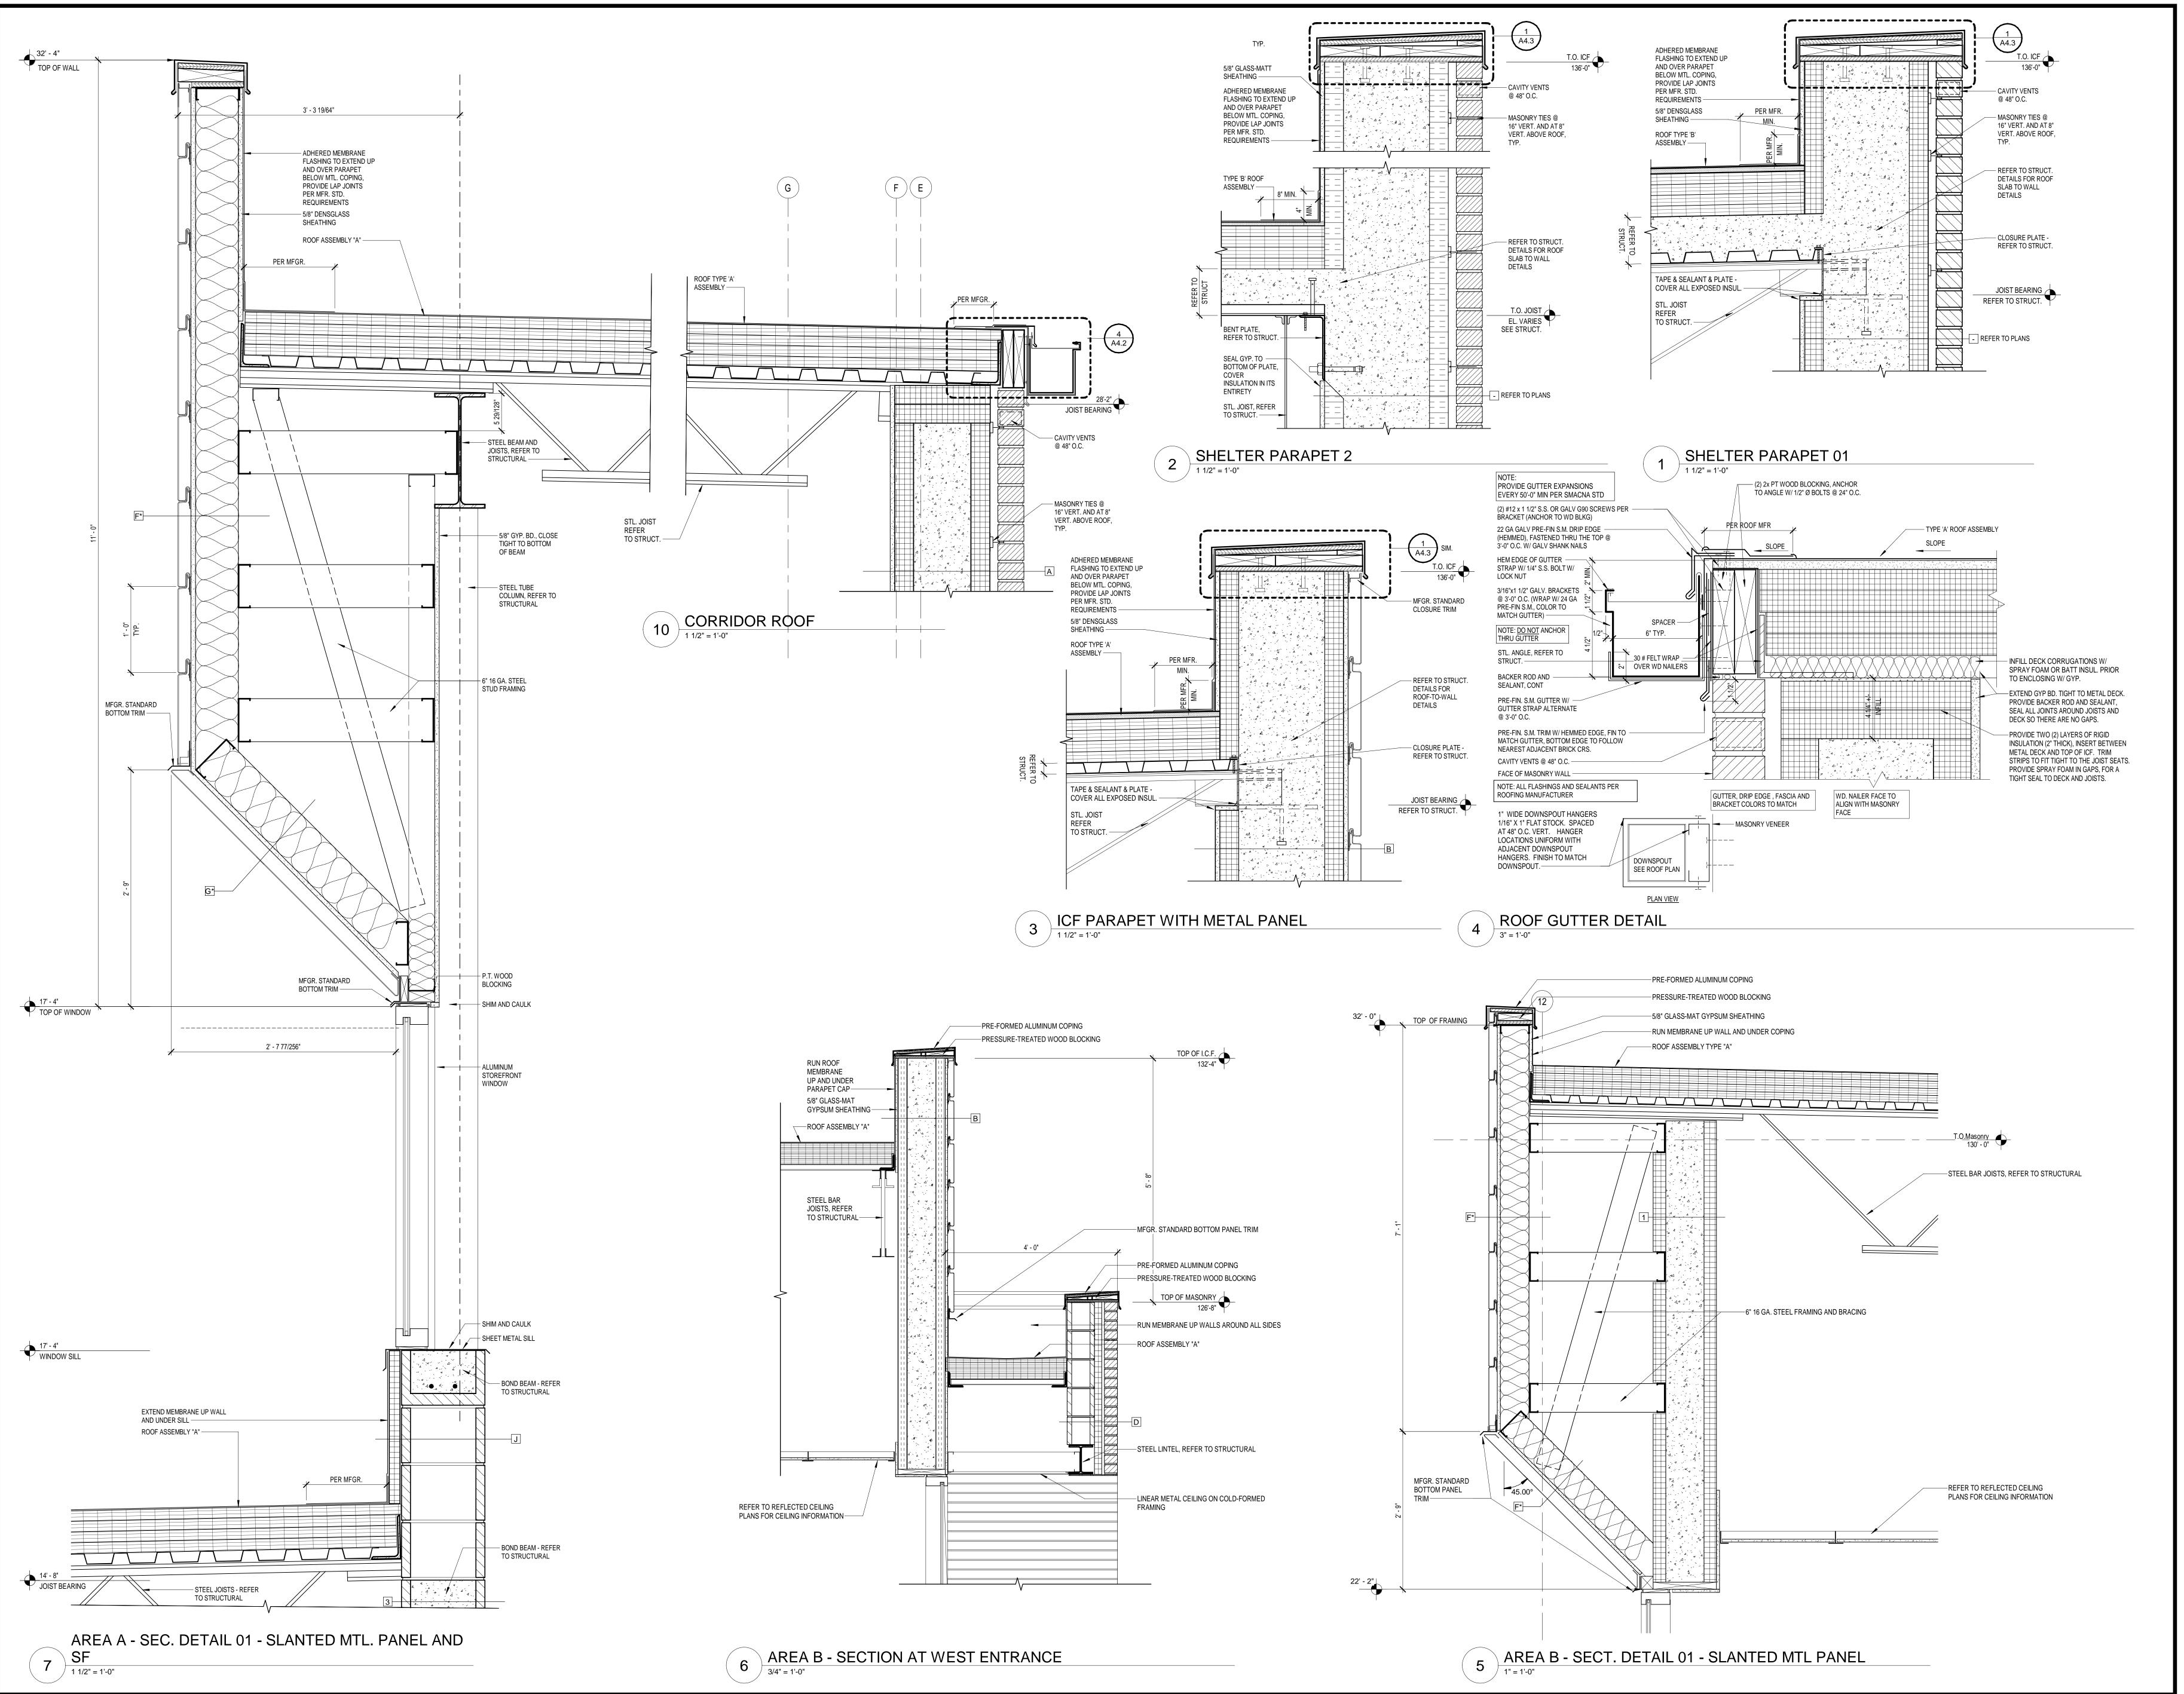

SHERMAN CARTER BARNHART ARCHITECTS

9220 HOPKINSVILLE NORTONVILLE, K

ROOF DETAILS

JOB NO. 2246

DATE SEPT 11,2023

DRAWN AN

CHECKED AHO


COPYRIGHT © 2023
SHERMAN CARTER BARNHART
ARCHITECTS, PLLC

REVISIONS

No. Description Date

SHEET

A4.2

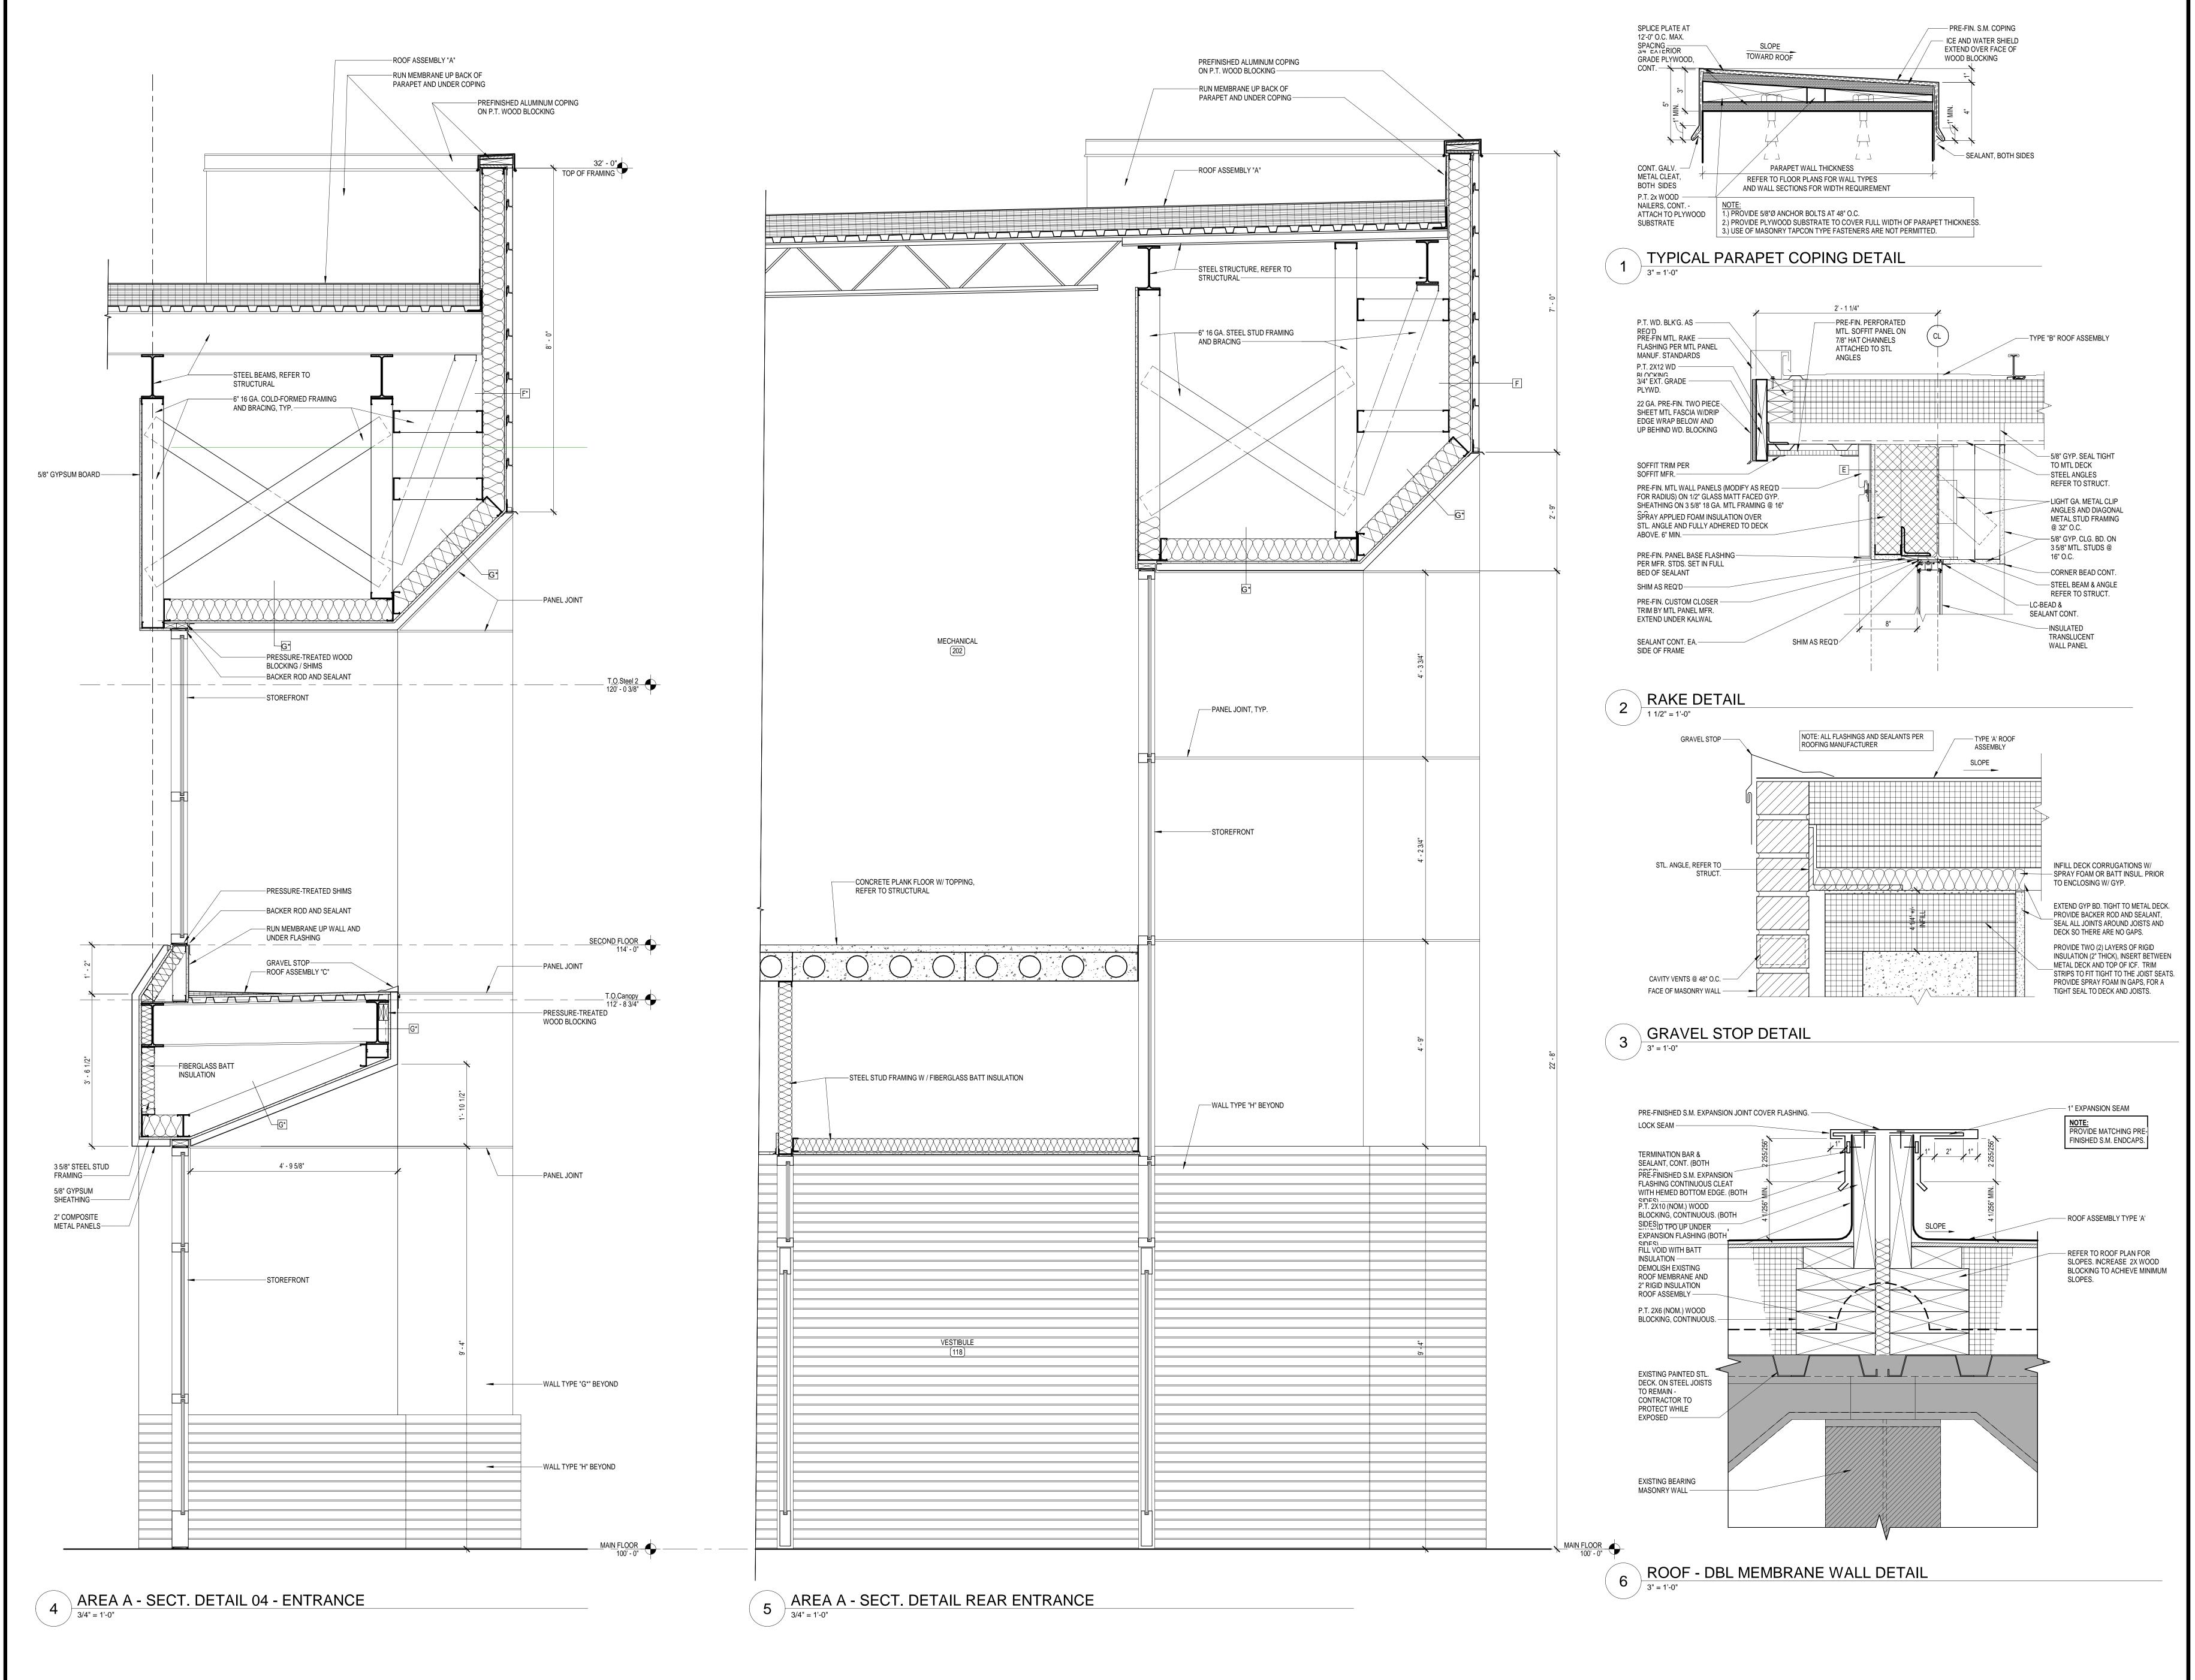

2246 SOUTH HOPKINS SCH 9/11/2023 3:10:30 PM SHERMAN CARTER BARNHART ARCHITECTS

UTH HOPKINS SCHOOL

220 HOPKINSVILLE RD,

ROOF DETAILS

JOB NO. 2246

DATE SEPT 11,2023

DRAWN AN

CHECKED AHO


COPYRIGHT © 2023
SHERMAN CARTER BARNHART
ARCHITECTS, PLLC

REVISIONS

No. Description Date

SHEET

A4.3

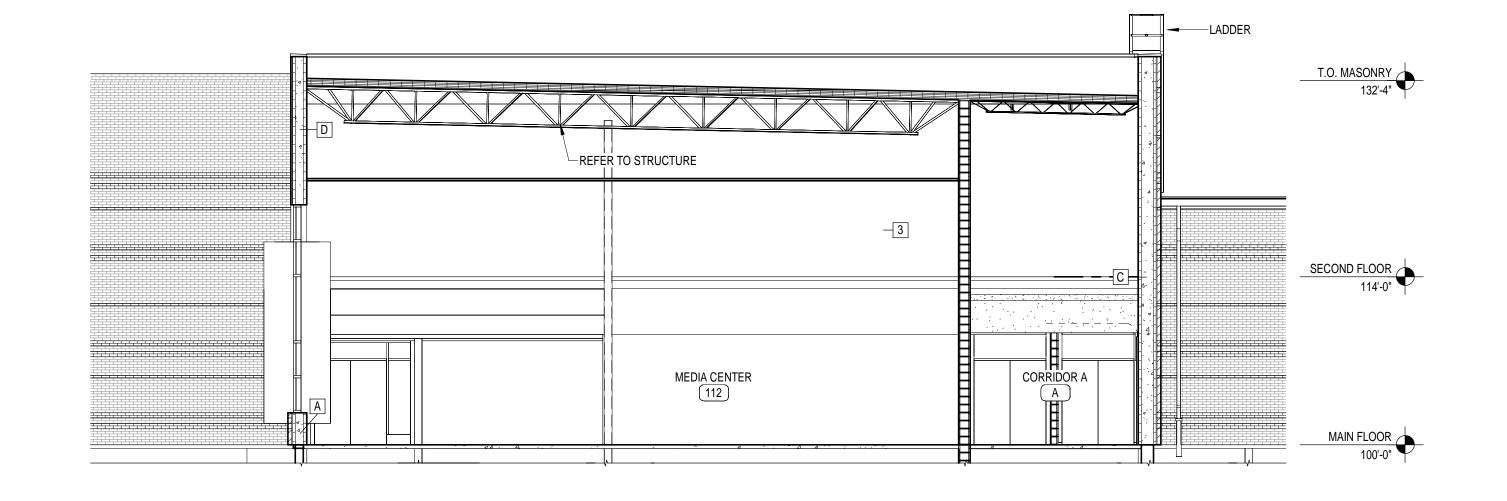


2 AREA B - TRANS. SECT. 04


1/8" = 1'-0"

1 AREA A - TRANS. SECT. 01

MAIN FLOOR 100'-0"

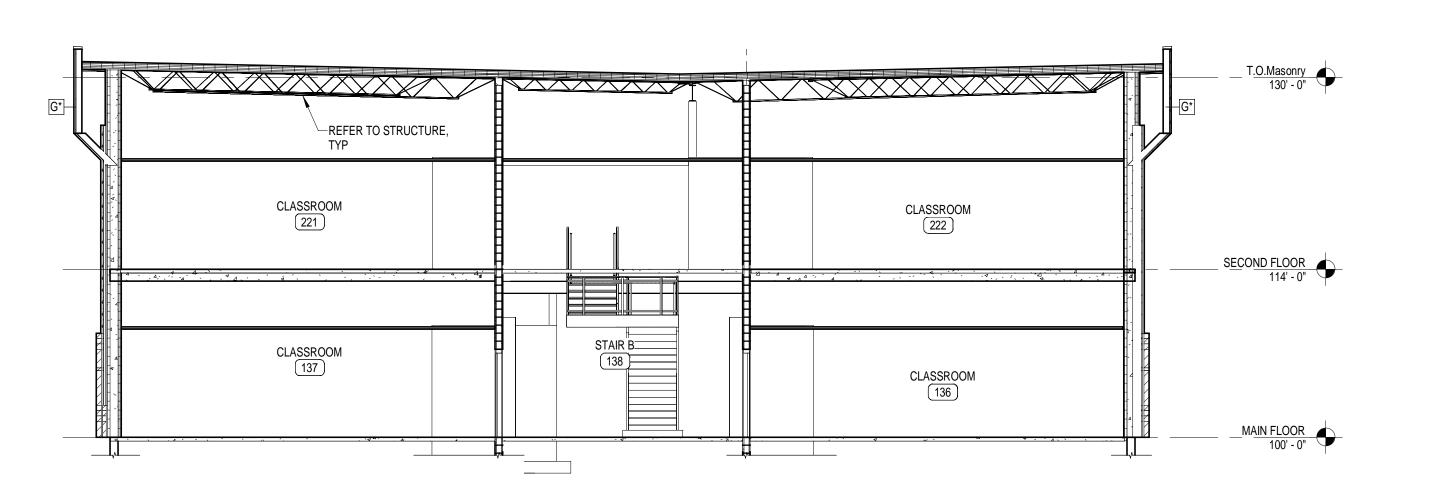

3 AREA B - TRANS. SECT. 03

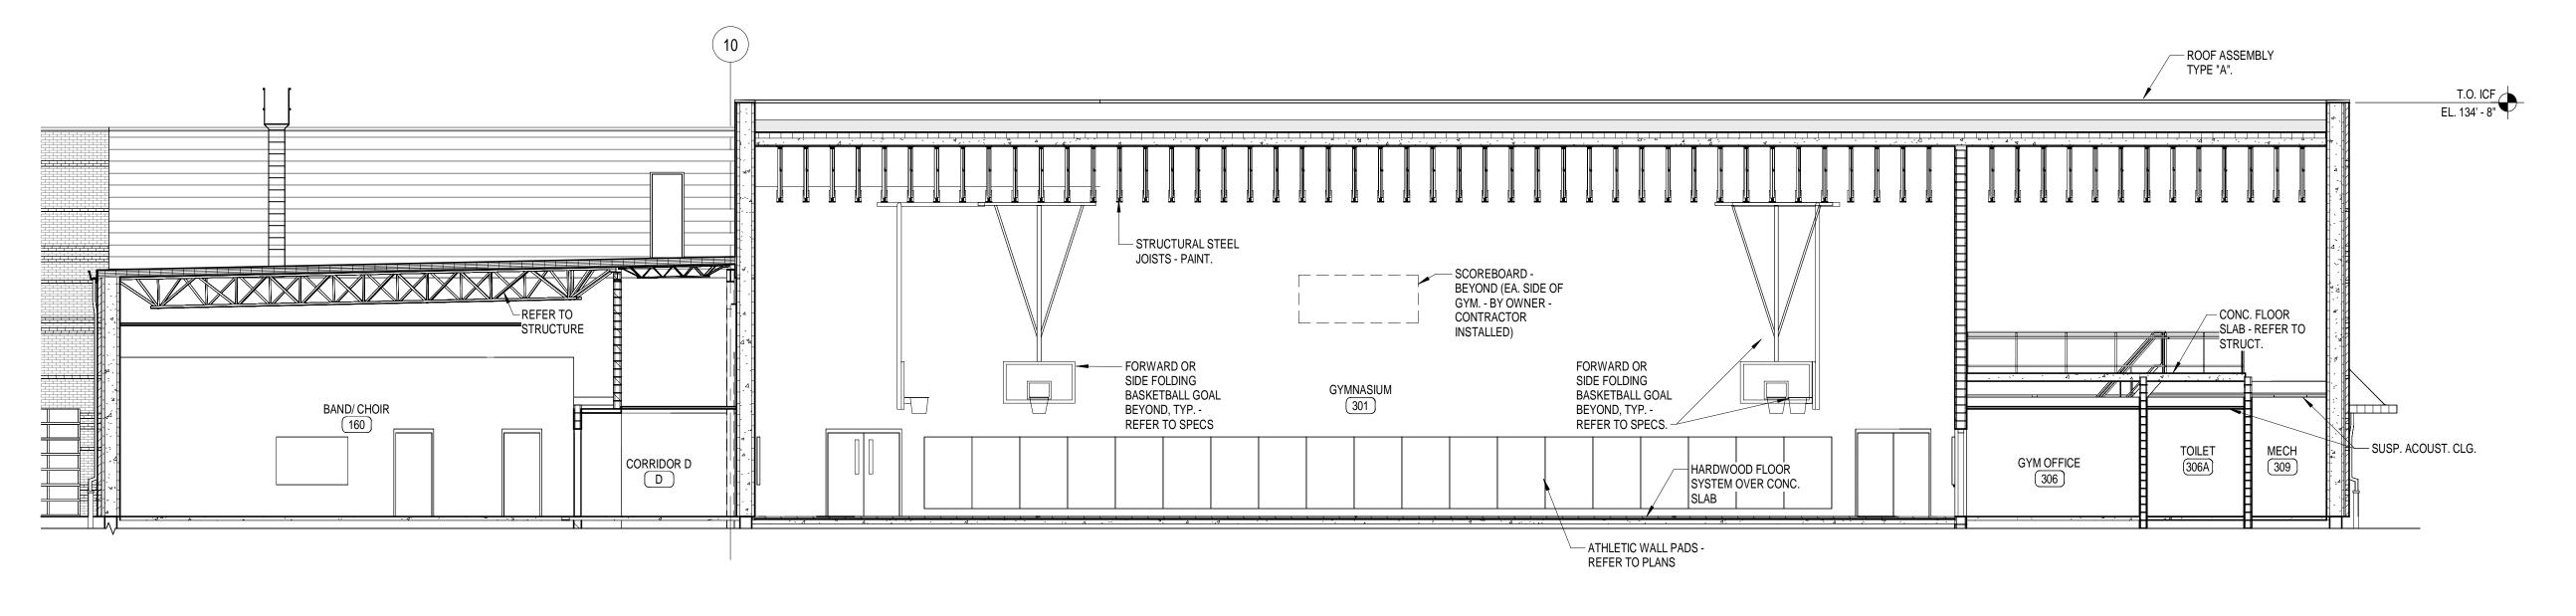

4 AREA C - LONG. SECT. 02 - GYM & BAND

2246 SOUTH HOPKINS SCHOOL 9/11/2023 3:00:11 PM SHERMAN CARTER BARNHART ARCHITECTS

SOUTH HOPKINS SCHOOL
9220 HOPKINSVILLE RD,
NORTONVILLE, KY

BUILDING SECTIONS

JOB NO. 2246

DATE SEPT 11,2023

DRAWN AN

CHECKED AHO


COPYRIGHT © 2023
SHERMAN CARTER BARNHART
ARCHITECTS, PLLC

REVISIONS

No. Description Date

SHEET

A5.1

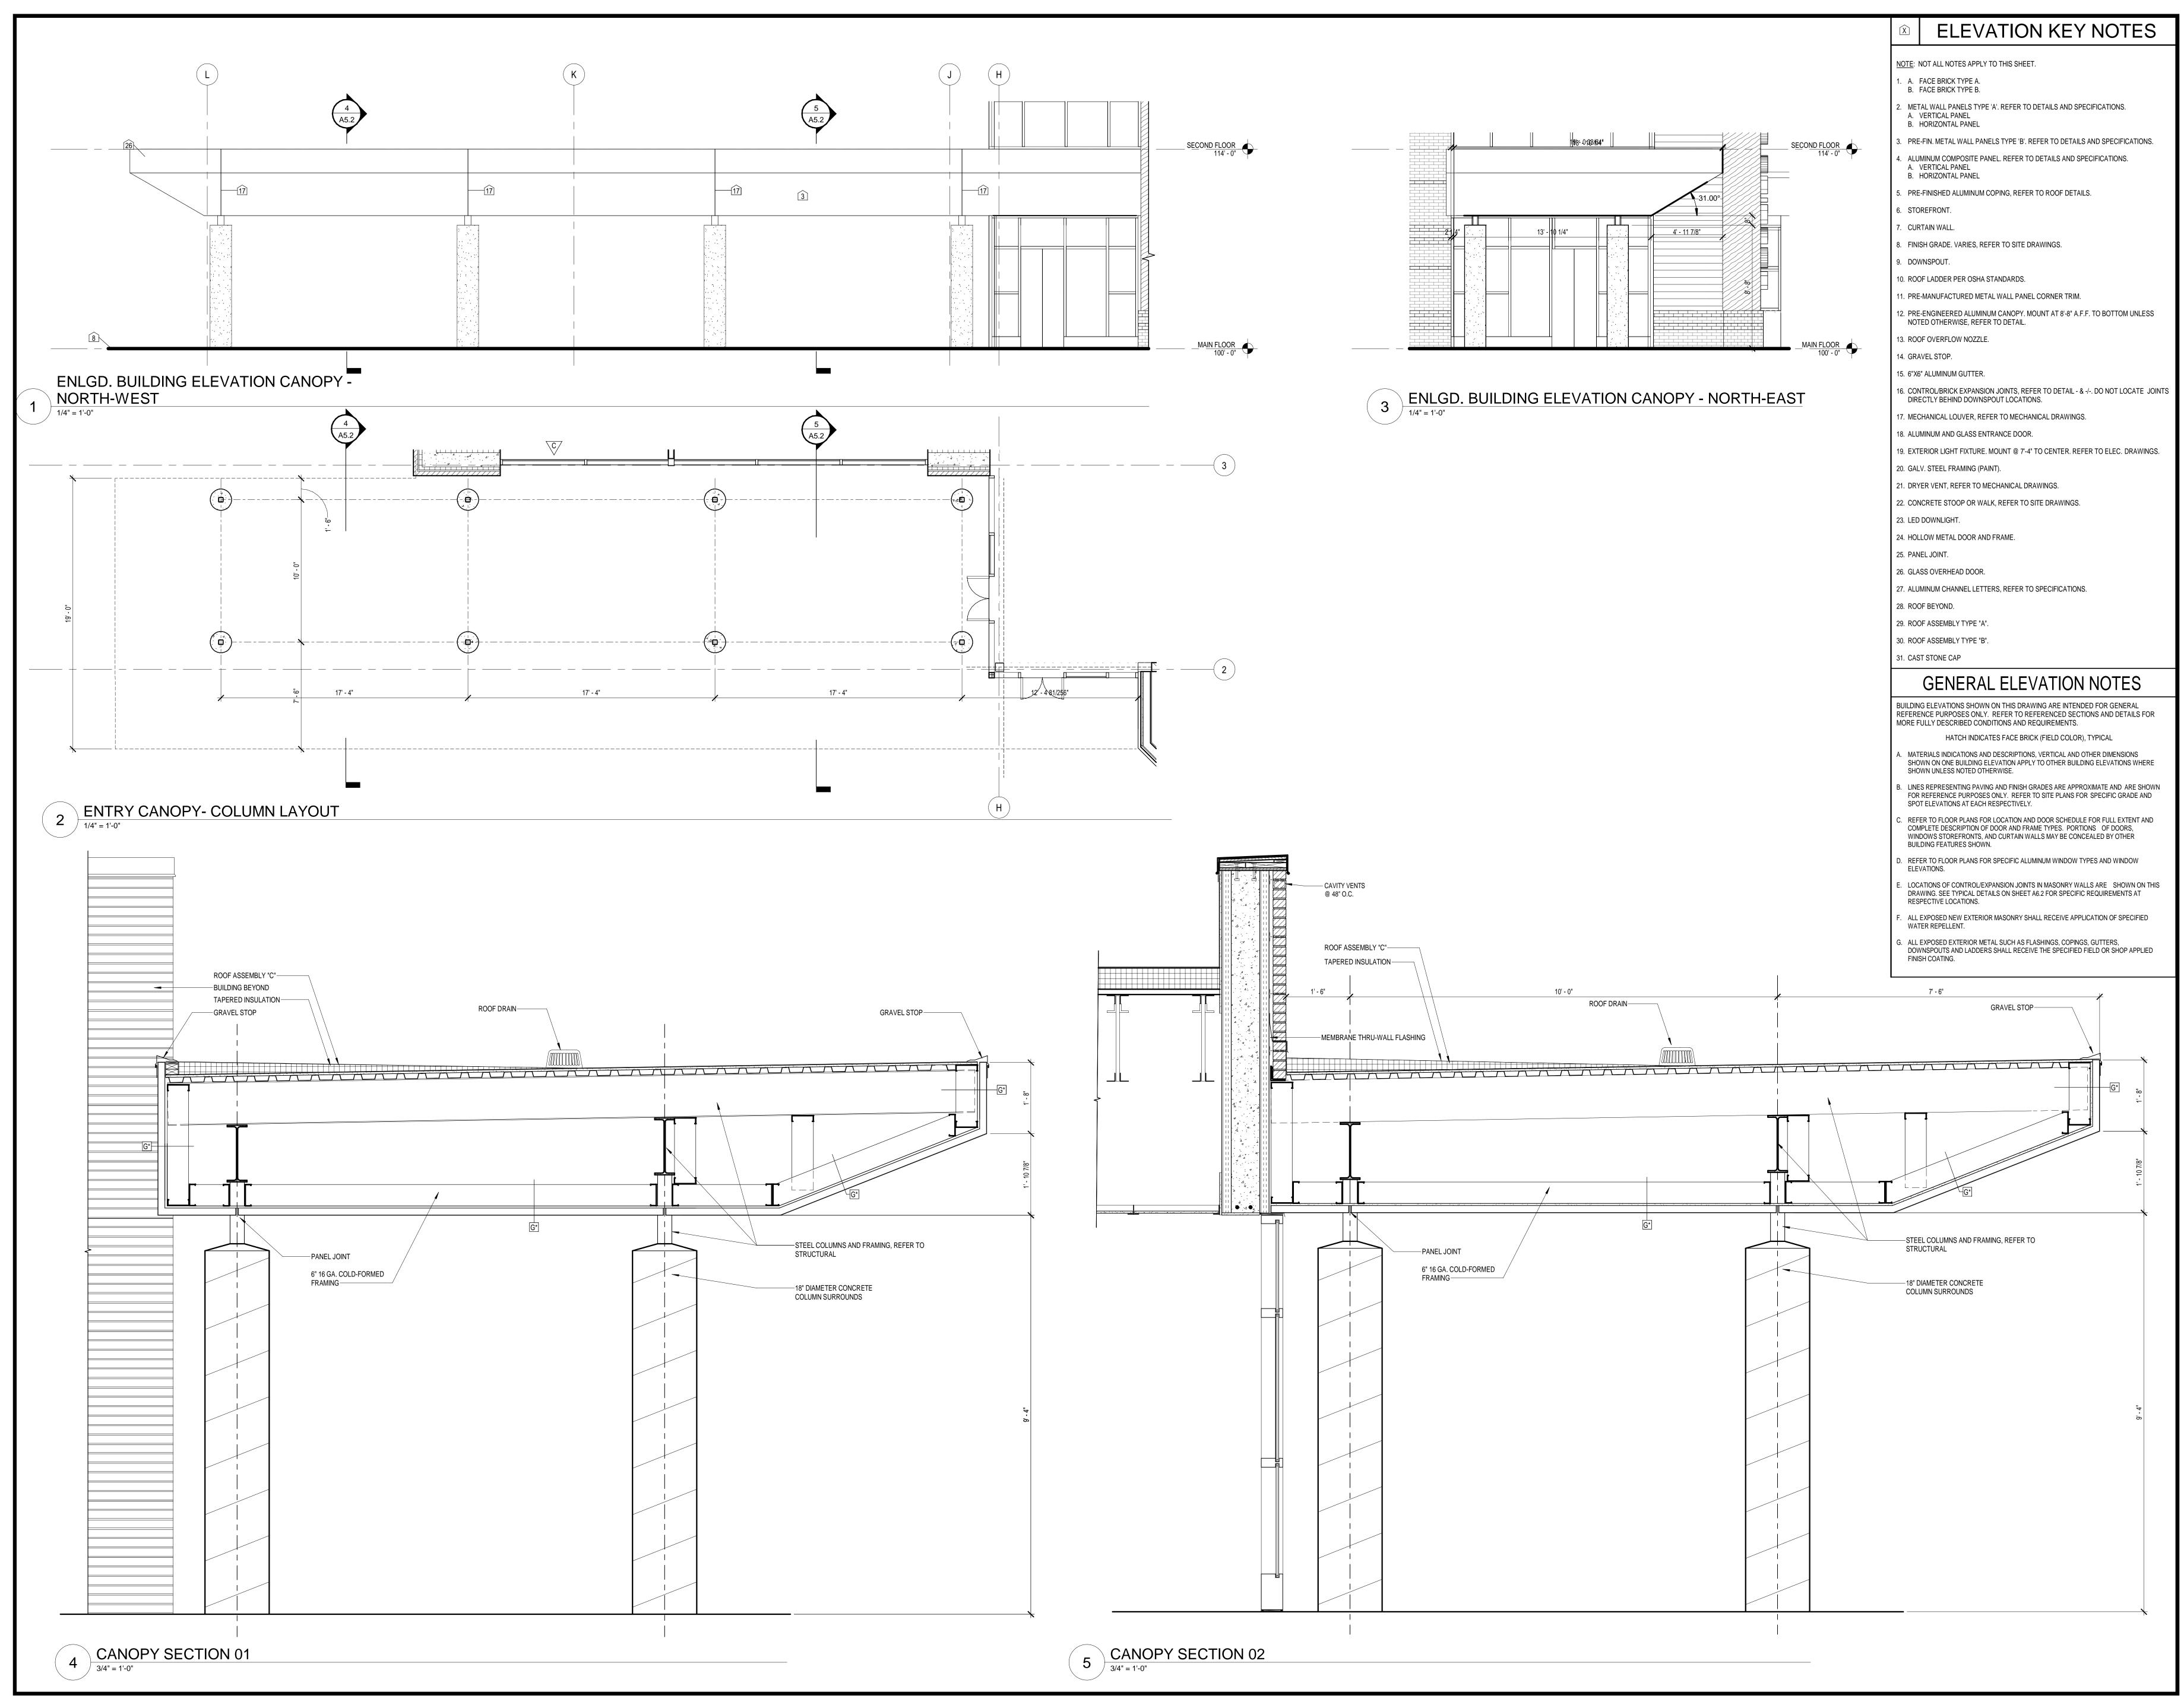

SHERMAN CARTER BARNHART ARCHITECTS

O M <

TH HOPKINS SCHOOL

20 HOPKINSVILLE RD,

ENTRANCE CANOPY DETAILS

JOB NO. 2246

DATE SEPT 11,2023

DRAWN CRG

CHECKED Checker

COPYRIGHT © 2023
SHERMAN CARTER BARNHART
ARCHITECTS, PLLC

REVISIONS

No. Description Date

REVISIONS
No. Description Date

SHEET

A5.2


ZC A R A ΣWΙ $\alpha \vdash z$ шкк I 4 4 0 S C M ∠

ELEVATION KEY NOTES

PKINSVILLE RE TONVILLE, KY

CRG CHECKED COPYRIGHT © 2023 SHERMAN CARTER BARNHAR ARCHITECTS, PLLC REVISIONS

2246 SOUTH HOPKINS SCHOOL 9/11/2023 3:00:20 PM

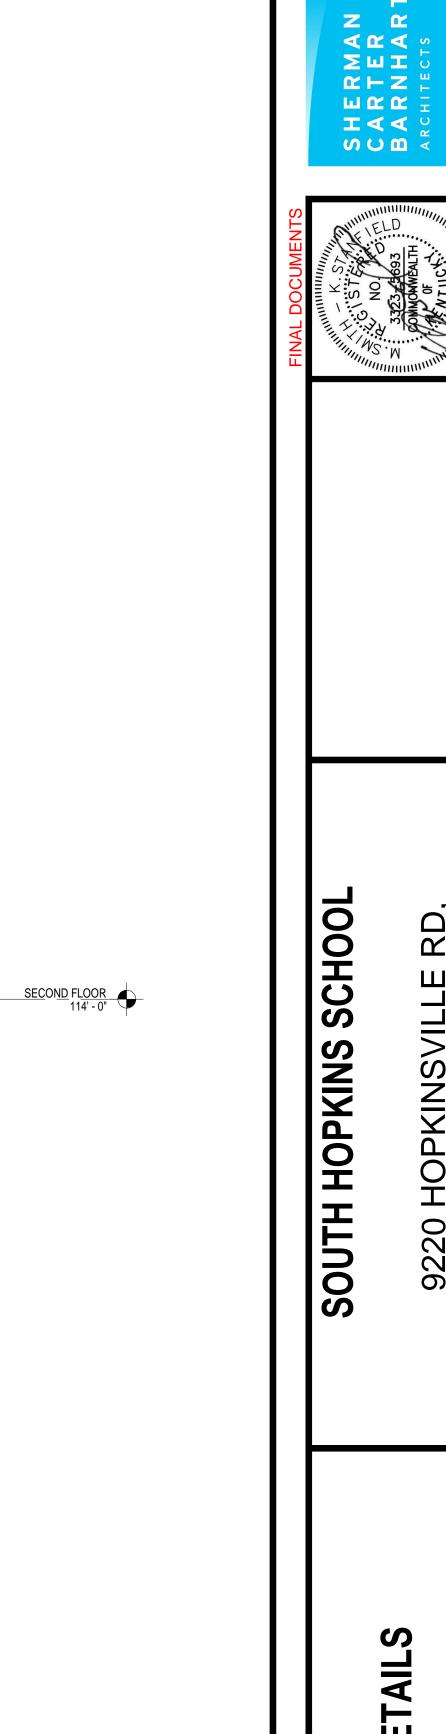

CONNECTOR DETAILS

JOB NO. 2246

DATE SEPT 11,2023

DRAWN Author

CHECKED Checker

COPYRIGHT © 2022
SHERMAN CARTER BARNHART
ARCHITECTS, PLLC


REVISIONS

No. Description Date

SHEET


A5.4

SCOTON AT COMMISSION

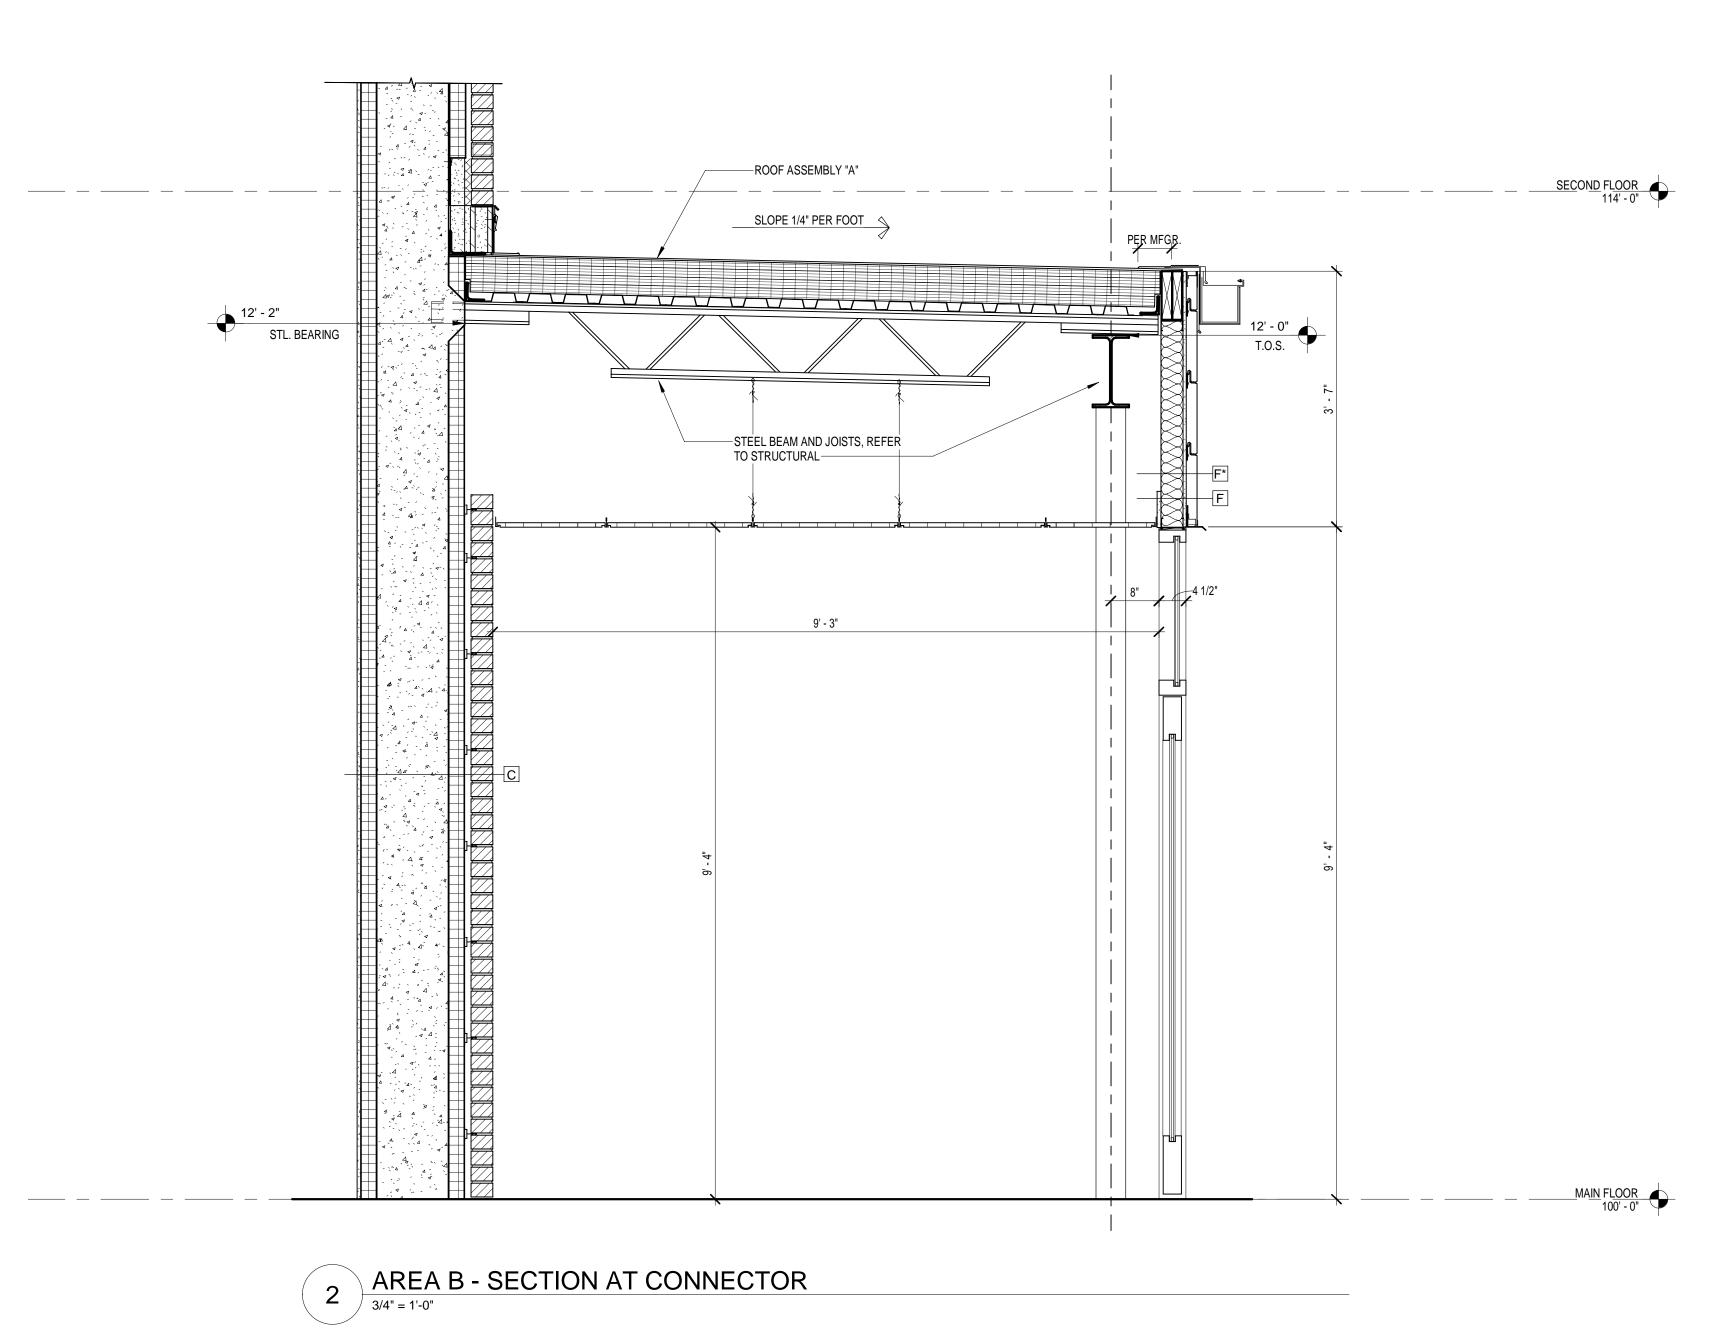

1 AREA A - SECTION AT CONNECTOR

3/4" = 1'-0"

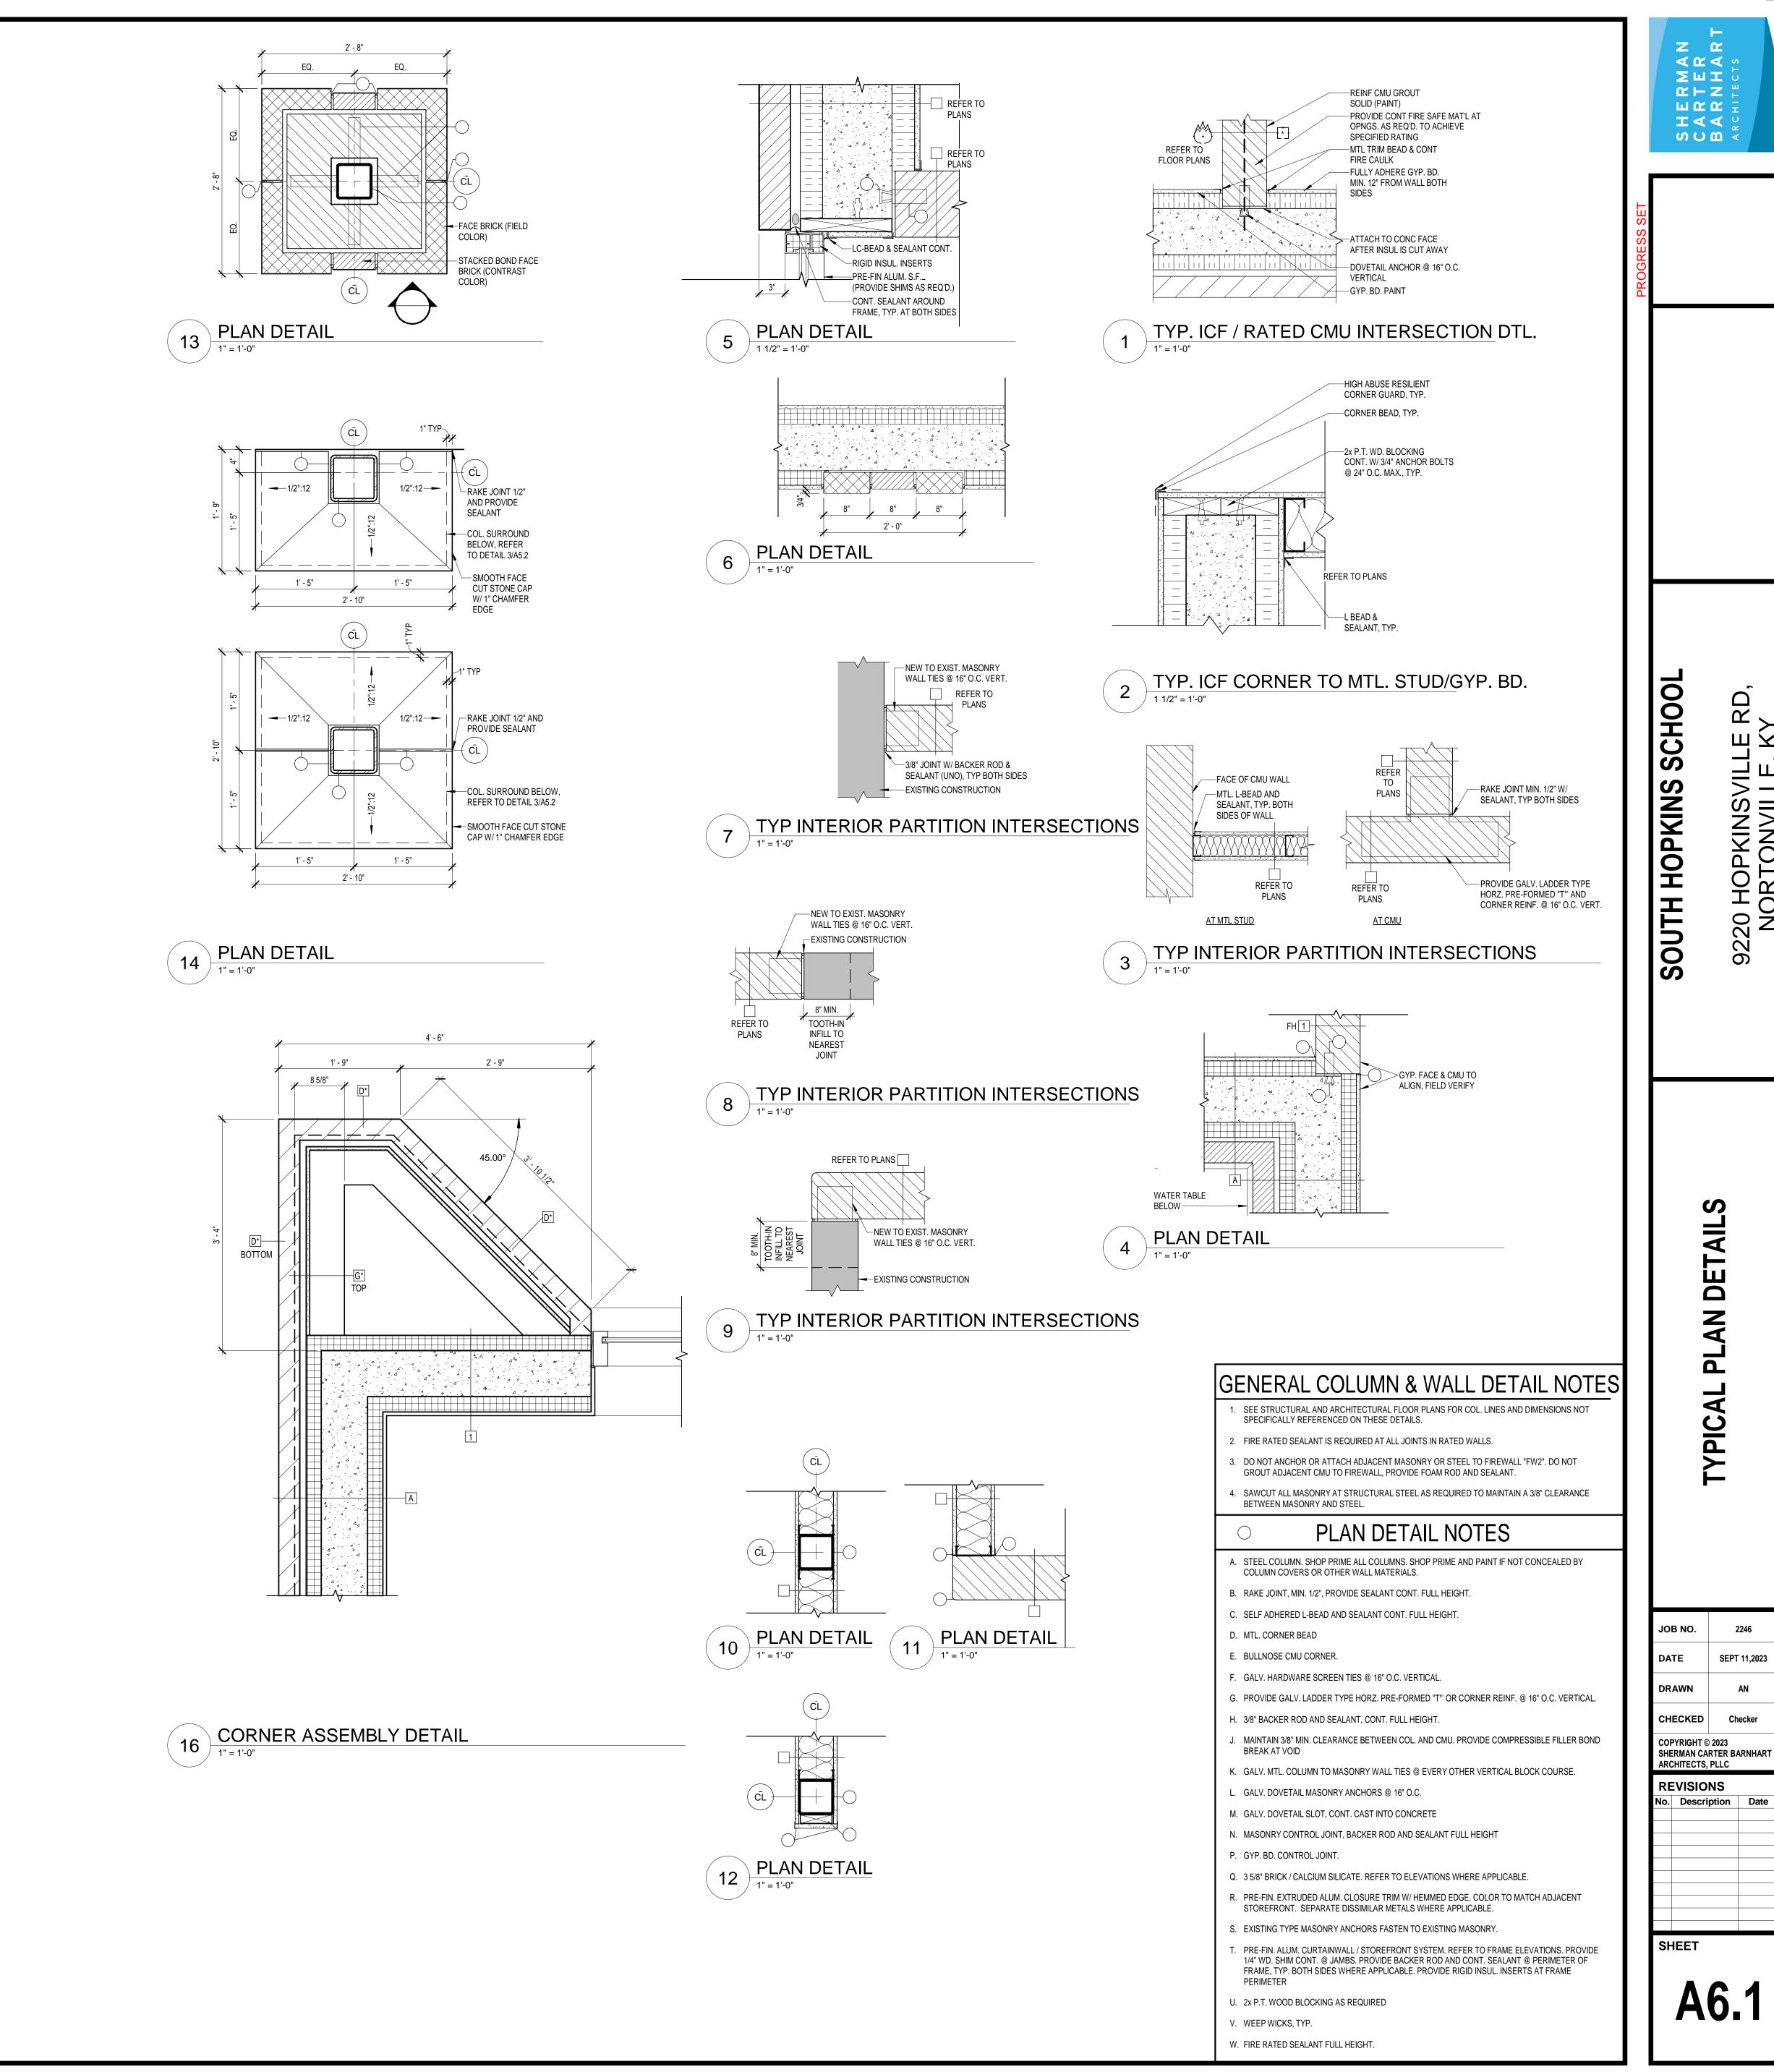

2246 SOUTH HOPKINS SCH 9/11/2023 3:00:27 PM

444

PKINSVILLE RD, TONVILLE, KY


9220 HOF NORT

DETAILS

PLAN

AL

TYPIC/

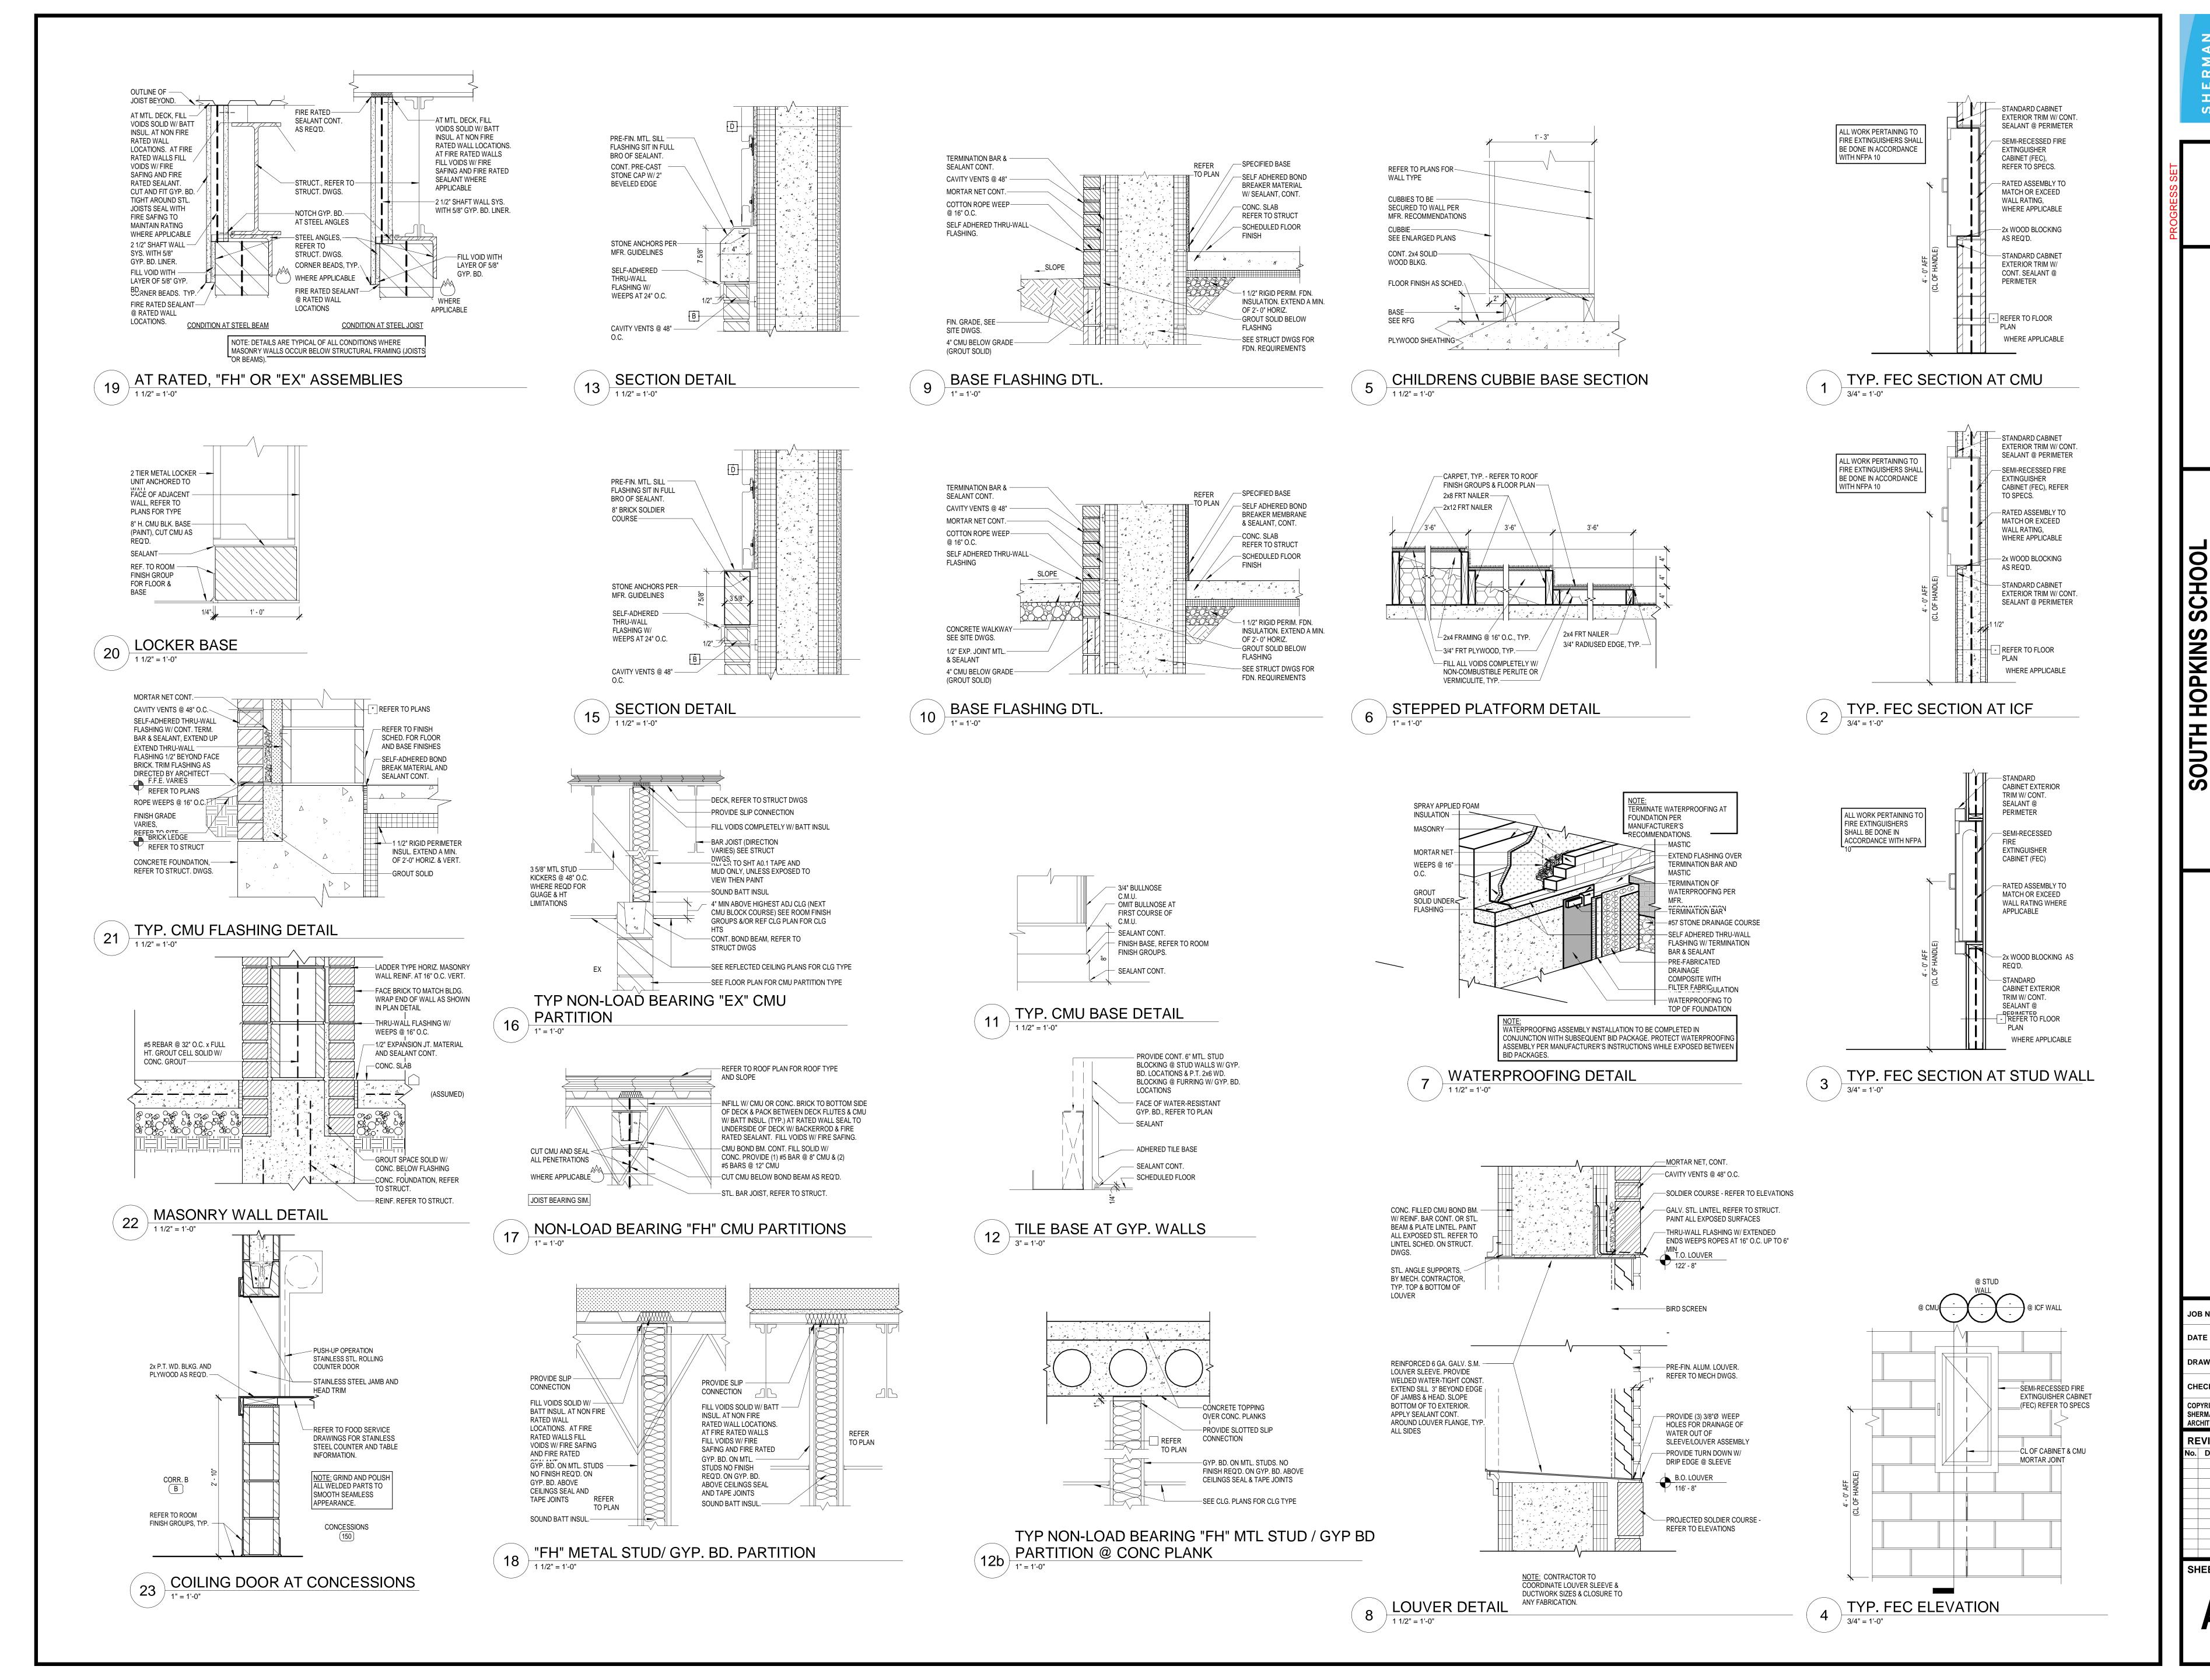

2246 SOUTH HOPKINS SCH 9/11/2023 3:00:34 PM

ZC AMA $\Sigma \sqcup \mathbf{I}$ $\alpha \vdash z$ шсс

IV

PKINSVILI ONVILLE 9220 HOF NORT


ANEOUS MISCELL

JOB NO. SEPT 11,2023 DATE Author DRAWN CHECKED **COPYRIGHT © 2023** SHERMAN CARTER BARNHAF ARCHITECTS, PLLC REVISIONS No. Description Date

TYPIC,

SHEET

A6.2

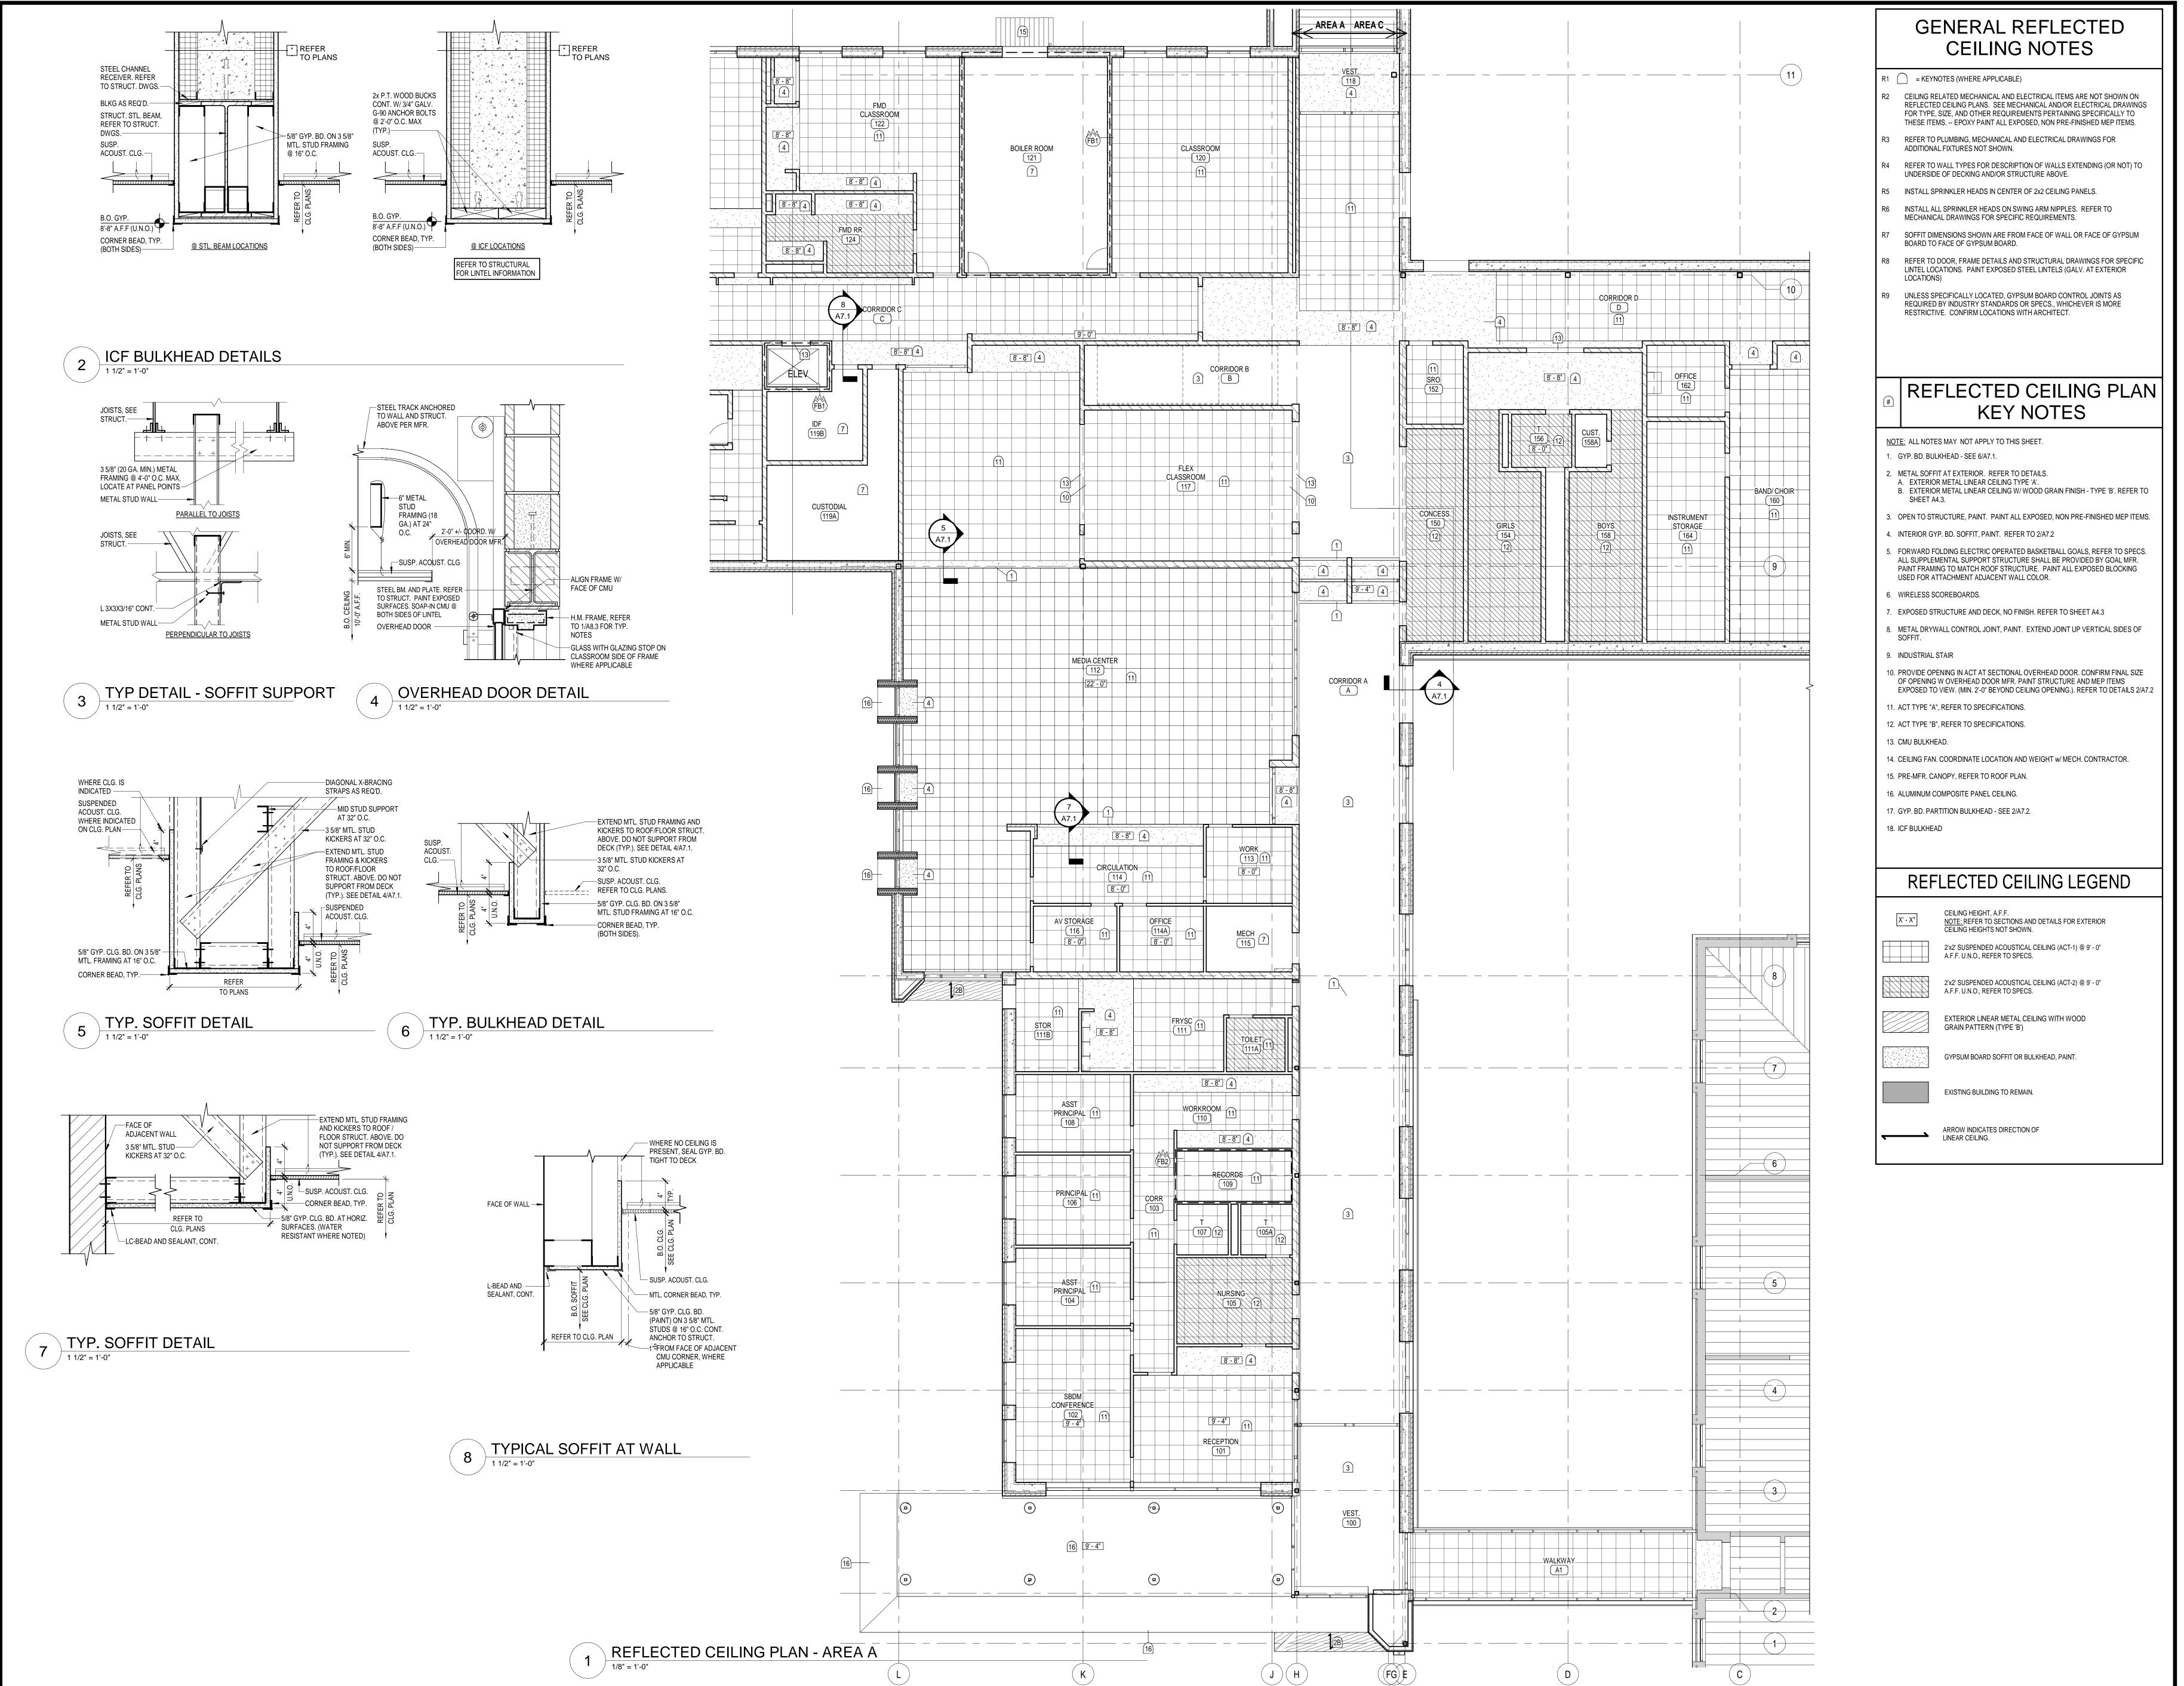

SHERMAN CARTER BARNHART ARCHITECTS

wom ≼

OUTH HOPKINS SCHOOL 3220 HOPKINSVILLE RD, NORTONVILLE, KY

RST FLOOR REFLECTED CEILING
PLAN - AREA A

JOB NO. 2246

DATE SEPT 11,2023

DRAWN ALC, ASC

CHECKED
COPYRIGHT © 2023
SHERMAN CARTER BARNHART
ARCHITECTS, PLLC

REVISIONS


No. Description Date

SHEET

A7.1



2246 SOUTH HOPKINS SCHOOL 9/11/2023 3:00:45 PM

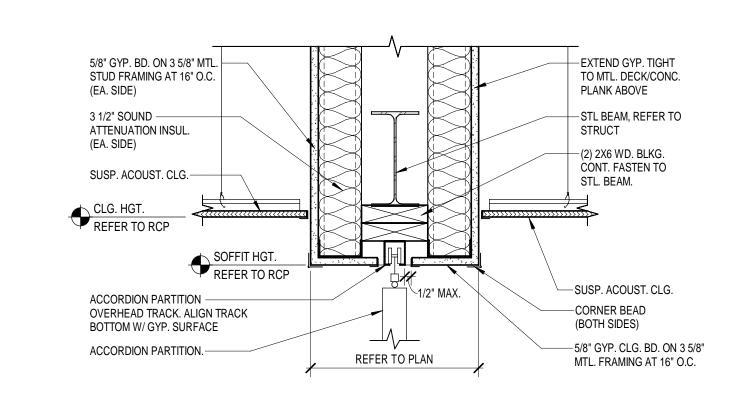

OPERABLE PARTITION SOFFIT DETAIL

1 1/2" = 1'-0"

GENERAL REFLECTED CEILING NOTES

- R1 = KEYNOTES (WHERE APPLICABLE)
- R2 CEILING RELATED MECHANICAL AND ELECTRICAL ITEMS ARE NOT SHOWN ON REFLECTED CEILING PLANS. SEE MECHANICAL AND/OR ELECTRICAL DRAWINGS FOR TYPE, SIZE, AND OTHER REQUIREMENTS PERTAINING SPECIFICALLY TO THESE ITEMS. -- EPOXY PAINT ALL EXPOSED, NON PRE-FINISHED MEP ITEMS.
- R3 REFER TO PLUMBING, MECHANICAL AND ELECTRICAL DRAWINGS FOR ADDITIONAL FIXTURES NOT SHOWN.
- R4 REFER TO WALL TYPES FOR DESCRIPTION OF WALLS EXTENDING (OR NOT) TO UNDERSIDE OF DECKING AND/OR STRUCTURE ABOVE.
- R5 INSTALL SPRINKLER HEADS IN CENTER OF 2x2 CEILING PANELS.
- INSTALL ALL SPRINKLER HEADS ON SWING ARM NIPPLES. REFER TO MECHANICAL DRAWINGS FOR SPECIFIC REQUIREMENTS.
- SOFFIT DIMENSIONS SHOWN ARE FROM FACE OF WALL OR FACE OF GYPSUM BOARD TO FACE OF GYPSUM BOARD.
- R8 REFER TO DOOR, FRAME DETAILS AND STRUCTURAL DRAWINGS FOR SPECIFIC LINTEL LOCATIONS. PAINT EXPOSED STEEL LINTELS (GALV. AT EXTERIOR LOCATIONS)
- R9 UNLESS SPECIFICALLY LOCATED, GYPSUM BOARD CONTROL JOINTS AS REQUIRED BY INDUSTRY STANDARDS OR SPECS., WHICHEVER IS MORE RESTRICTIVE. CONFIRM LOCATIONS WITH ARCHITECT.

REFLECTED CEILING PLAN KEY NOTES

- NOTE: ALL NOTES MAY NOT APPLY TO THIS SHEET.
- 2. METAL SOFFIT AT EXTERIOR. REFER TO DETAILS.

1. GYP. BD. BULKHEAD - SEE 6/A7.1.

- A. EXTERIOR METAL LINEAR CEILING TYPE 'A'.

 B. EXTERIOR METAL LINEAR CEILING W/ WOOD GRAIN FINISH TYPE 'B'. REFER TO
- SHEET A4.3.

 3. OPEN TO STRUCTURE, PAINT. PAINT ALL EXPOSED, NON PRE-FINISHED MEP ITEMS.
- 4. INTERIOR GYP. BD. SOFFIT, PAINT. REFER TO 2/A7.25. FORWARD FOLDING ELECTRIC OPERATED BASKETBALL GOALS, REFER TO SPECS.
- 5. FORWARD FOLDING ELECTRIC OPERATED BASKETBALL GOALS, REFER TO SPECS.
 ALL SUPPLEMENTAL SUPPORT STRUCTURE SHALL BE PROVIDED BY GOAL MFR.
 PAINT FRAMING TO MATCH ROOF STRUCTURE. PAINT ALL EXPOSED BLOCKING
 USED FOR ATTACHMENT ADJACENT WALL COLOR.
- 6. WIRELESS SCOREBOARDS.
- 7. EXPOSED STRUCTURE AND DECK, NO FINISH. REFER TO SHEET A4.3
- 8. METAL DRYWALL CONTROL JOINT, PAINT. EXTEND JOINT UP VERTICAL SIDES OF SOFFIT.
- 9. INDUSTRIAL STAIR
- 10. PROVIDE OPENING IN ACT AT SECTIONAL OVERHEAD DOOR. CONFIRM FINAL SIZE OF OPENING W OVERHEAD DOOR MFR. PAINT STRUCTURE AND MEP ITEMS EXPOSED TO VIEW. (MIN. 2'-0" BEYOND CEILING OPENING.). REFER TO DETAILS 2/A7.2
- 11. ACT TYPE "A", REFER TO SPECIFICATIONS.
- 12. ACT TYPE "B", REFER TO SPECIFICATIONS.
- 13. CMU BULKHEAD.
- 14. CEILING FAN. COORDINATE LOCATION AND WEIGHT w/ MECH. CONTRACTOR.
- 15. PRE-MFR. CANOPY, REFER TO ROOF PLAN.
- 16. ALUMINUM COMPOSITE PANEL CEILING.
- 17. GYP. BD. PARTITION BULKHEAD SEE 2/A7.2.
- 18. ICF BULKHEAD

REFLECTED CEILING LEGEND

CEILING HEIGHT, A.F.F.

NOTE: REFER TO SECTIONS AND DETAILS FOR EXTERIOR
CEILING HEIGHTS NOT SHOWN.

2'x2' SUSPENDED ACOUSTICAL CEILING (ACT-1) @ 9' - 0"
A.F.F. U.N.O., REFER TO SPECS.

2'x2' SUSPENDED ACOUSTICAL CEILING (ACT-2) @ 9' - 0" A.F.F. U.N.O., REFER TO SPECS.

EXTERIOR LINEAR METAL CEILING WITH WOOD GRAIN PATTERN (TYPE 'B')

GYPSUM BOARD SOFFIT OR BULKHEAD, PAINT.

EXISTING BUILDING TO REMAIN.

ARROW INDICATES DIRECTION OF LINEAR CEILING.

ED CEILING
B
9220 HOF
NORT

PKINSVILLE RE TONVILLE, KY

A C A

I 4 4 0

von ∠

FIRST FLOOR REFLECTE PLAN - AREA E

JOB NO. 2246

DATE SEPT 11,2023

DRAWN ALC, ASC

CHECKED
COPYRIGHT © 2023
SHERMAN CARTER BARNHART
ARCHITECTS, PLLC

REVISIONS

No. Description Date

HEET

A7.2

2246 SOUTH HOPKINS SCH(9/11/2023 3:00:50 PM

GENERAL REFLECTED CEILING NOTES

R1 = KEYNOTES (WHERE APPLICABLE)

- R2 CEILING RELATED MECHANICAL AND ELECTRICAL ITEMS ARE NOT SHOWN ON REFLECTED CEILING PLANS. SEE MECHANICAL AND/OR ELECTRICAL DRAWINGS FOR TYPE, SIZE, AND OTHER REQUIREMENTS PERTAINING SPECIFICALLY TO THESE ITEMS. -- EPOXY PAINT ALL EXPOSED, NON PRE-FINISHED MEP ITEMS.
- R3 REFER TO PLUMBING, MECHANICAL AND ELECTRICAL DRAWINGS FOR ADDITIONAL FIXTURES NOT SHOWN.
- R4 REFER TO WALL TYPES FOR DESCRIPTION OF WALLS EXTENDING (OR NOT) TO UNDERSIDE OF DECKING AND/OR STRUCTURE ABOVE.
- 5 INSTALL SPRINKLER HEADS IN CENTER OF 2x2 CEILING PANELS.
- INSTALL ALL SPRINKLER HEADS ON SWING ARM NIPPLES. REFER TO
- MECHANICAL DRAWINGS FOR SPECIFIC REQUIREMENTS.
- SOFFIT DIMENSIONS SHOWN ARE FROM FACE OF WALL OR FACE OF GYPSUM BOARD TO FACE OF GYPSUM BOARD.
- R8 REFER TO DOOR, FRAME DETAILS AND STRUCTURAL DRAWINGS FOR SPECIFIC LINTEL LOCATIONS. PAINT EXPOSED STEEL LINTELS (GALV. AT EXTERIOR LOCATIONS)
- 9 UNLESS SPECIFICALLY LOCATED, GYPSUM BOARD CONTROL JOINTS AS REQUIRED BY INDUSTRY STANDARDS OR SPECS., WHICHEVER IS MORE RESTRICTIVE. CONFIRM LOCATIONS WITH ARCHITECT.

REFLECTED CEILING PLAN KEY NOTES

KEY NOTES

1. GYP. BD. BULKHEAD - SEE 6/A7.1.

NOTE: ALL NOTES MAY NOT APPLY TO THIS SHEET.

- METAL SOFFIT AT EXTERIOR. REFER TO DETAILS.
 A. EXTERIOR METAL LINEAR CEILING TYPE 'A'.
 B. EXTERIOR METAL LINEAR CEILING W/ WOOD GRAIN FINISH TYPE 'B'. REFER TO SHEET A4.3.
- 3. OPEN TO STRUCTURE, PAINT. PAINT ALL EXPOSED, NON PRE-FINISHED MEP ITEMS.
- 4. INTERIOR GYP. BD. SOFFIT, PAINT. REFER TO 2/A7.2
- FORWARD FOLDING ELECTRIC OPERATED BASKETBALL GOALS, REFER TO SPECS.
 ALL SUPPLEMENTAL SUPPORT STRUCTURE SHALL BE PROVIDED BY GOAL MFR.
 PAINT FRAMING TO MATCH ROOF STRUCTURE. PAINT ALL EXPOSED BLOCKING
 USED FOR ATTACHMENT ADJACENT WALL COLOR.
- 6. WIRELESS SCOREBOARDS.
- 7. EXPOSED STRUCTURE AND DECK, NO FINISH. REFER TO SHEET A4.3
- 8. METAL DRYWALL CONTROL JOINT, PAINT. EXTEND JOINT UP VERTICAL SIDES OF SOFFIT.
- 9. INDUSTRIAL STAIR
- 10. PROVIDE OPENING IN ACT AT SECTIONAL OVERHEAD DOOR. CONFIRM FINAL SIZE OF OPENING W OVERHEAD DOOR MFR. PAINT STRUCTURE AND MEP ITEMS EXPOSED TO VIEW. (MIN. 2'-0" BEYOND CEILING OPENING.). REFER TO DETAILS 2/A7.2
- 1. ACT TYPE "A", REFER TO SPECIFICATIONS.
- 12. ACT TYPE "B", REFER TO SPECIFICATIONS.
- 13. CMU BULKHEAD.
- 14. CEILING FAN. COORDINATE LOCATION AND WEIGHT w/ MECH. CONTRACTOR.
- 15. PRE-MFR. CANOPY, REFER TO ROOF PLAN.
- 16. ALUMINUM COMPOSITE PANEL CEILING.
- 17. GYP. BD. PARTITION BULKHEAD SEE 2/A7.2.18. ICF BULKHEAD

REFLECTED CEILING LEGEND

CEILING HEIGHT, A.F.F.

NOTE: REFER TO SECTIONS AND DETAILS FOR EXTERIOR CEILING HEIGHTS NOT SHOWN.

2'x2' SUSPENDED ACOUSTICAL CEILING (ACT-1) @ 9' - 0" A.F.F. U.N.O., REFER TO SPECS.

2'x2' SUSPENDED ACOUSTICAL CEILING (ACT-2) @ 9' - 0"
A.F.F. U.N.O., REFER TO SPECS.

EXTERIOR LINEAR METAL CEILING WITH WOOD
GRAIN PATTERN (TYPE 'B')

GYPSUM BOARD SOFFIT OR BULKHEAD, PAINT.

EXISTING BUILDING TO REMAIN.

ARROW INDICATES DIRECTION OF LINEAR CEILING.

SHERMAN CARTER BARNHART ARCHITECTS

νυ ™ [₹]

O HOPKINSVILLE RD,

SCHOOL

RST FLOOR REFLECTED CEILING PLAN - AREA C

JOB NO. 2246

DATE SEPT 11,2023

DRAWN ALC, ASC

CHECKED
COPYRIGHT © 2023
SHERMAN CARTER BARNHART
ARCHITECTS, PLLC

REVISIONS

No. Description Date

SHEET

A7.3


Z C **AUA** 4

∑шІ $\alpha \vdash z$ шсс

I 4 4 0

S C D E

REVISIONS

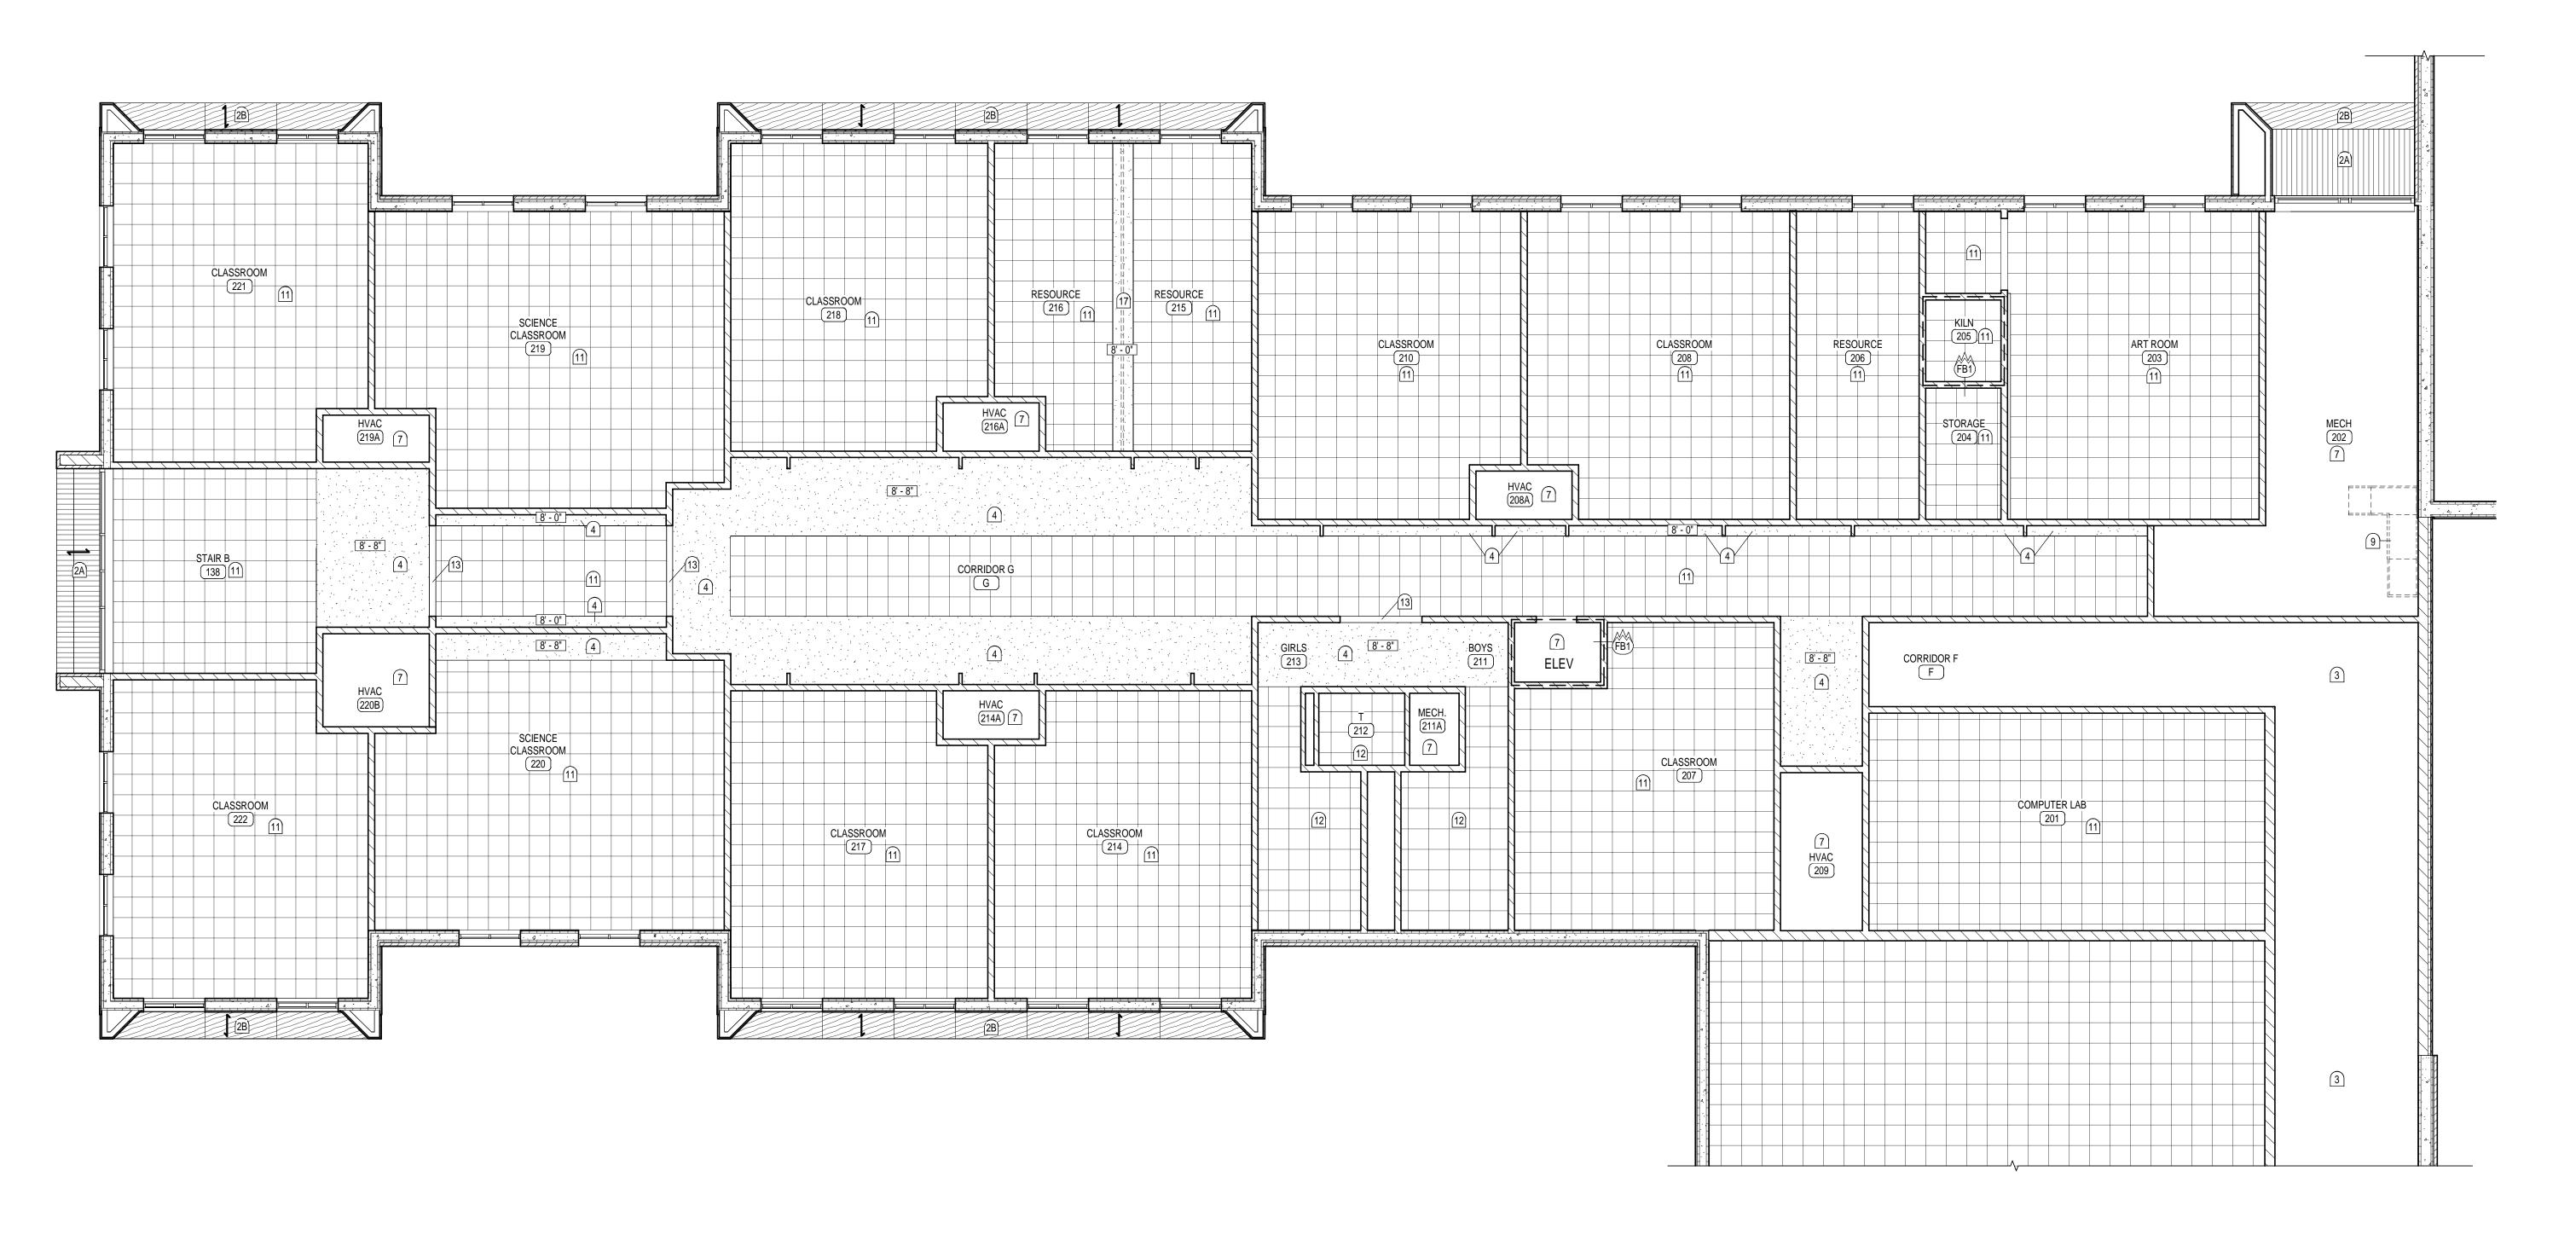

2246 SOUTH HOPKINS SCHOOL 9/11/2023 3:00:54 PM

1 REFLECTED CEILING PLAN - SECOND FLOOR
1/8" = 1'-0"

CEILING NOTES

R1 = KEYNOTES (WHERE APPLICABLE)

R2 CEILING RELATED MECHANICAL AND ELECTRICAL ITEMS ARE NOT SHOWN ON REFLECTED CEILING PLANS. SEE MECHANICAL AND/OR ELECTRICAL DRAWINGS FOR TYPE, SIZE, AND OTHER REQUIREMENTS PERTAINING SPECIFICALLY TO THESE ITEMS. -- EPOXY PAINT ALL EXPOSED, NON PRE-FINISHED MEP ITEMS.

GENERAL REFLECTED

R3 REFER TO PLUMBING, MECHANICAL AND ELECTRICAL DRAWINGS FOR ADDITIONAL FIXTURES NOT SHOWN.

R4 REFER TO WALL TYPES FOR DESCRIPTION OF WALLS EXTENDING (OR NOT) TO UNDERSIDE OF DECKING AND/OR STRUCTURE ABOVE.

R5 INSTALL SPRINKLER HEADS IN CENTER OF 2x2 CEILING PANELS.

R6 INSTALL ALL SPRINKLER HEADS ON SWING ARM NIPPLES. REFER TO MECHANICAL DRAWINGS FOR SPECIFIC REQUIREMENTS.

SOFFIT DIMENSIONS SHOWN ARE FROM FACE OF WALL OR FACE OF GYPSUM BOARD TO FACE OF GYPSUM BOARD.

R8 REFER TO DOOR, FRAME DETAILS AND STRUCTURAL DRAWINGS FOR SPECIFIC LINTEL LOCATIONS. PAINT EXPOSED STEEL LINTELS (GALV. AT EXTERIOR

R9 UNLESS SPECIFICALLY LOCATED, GYPSUM BOARD CONTROL JOINTS AS REQUIRED BY INDUSTRY STANDARDS OR SPECS., WHICHEVER IS MORE RESTRICTIVE. CONFIRM LOCATIONS WITH ARCHITECT.

REFLECTED CEILING PLAN **KEY NOTES**

NOTE: ALL NOTES MAY NOT APPLY TO THIS SHEET. 1. GYP. BD. BULKHEAD - SEE 6/A7.1.

METAL SOFFIT AT EXTERIOR. REFER TO DETAILS. A. EXTERIOR METAL LINEAR CEILING TYPE 'A'.

B. EXTERIOR METAL LINEAR CEILING W/ WOOD GRAIN FINISH - TYPE 'B'. REFER TO SHEET A4.3.

3. OPEN TO STRUCTURE, PAINT. PAINT ALL EXPOSED, NON PRE-FINISHED MEP ITEMS. 4. INTERIOR GYP. BD. SOFFIT, PAINT. REFER TO 2/A7.2

5. FORWARD FOLDING ELECTRIC OPERATED BASKETBALL GOALS, REFER TO SPECS. ALL SUPPLEMENTAL SUPPORT STRUCTURE SHALL BE PROVIDED BY GOAL MFR.
PAINT FRAMING TO MATCH ROOF STRUCTURE. PAINT ALL EXPOSED BLOCKING USED FOR ATTACHMENT ADJACENT WALL COLOR.

6. WIRELESS SCOREBOARDS.

7. EXPOSED STRUCTURE AND DECK, NO FINISH. REFER TO SHEET A4.3

8. METAL DRYWALL CONTROL JOINT, PAINT. EXTEND JOINT UP VERTICAL SIDES OF

9. INDUSTRIAL STAIR

10. PROVIDE OPENING IN ACT AT SECTIONAL OVERHEAD DOOR. CONFIRM FINAL SIZE OF OPENING W OVERHEAD DOOR MFR. PAINT STRUCTURE AND MEP ITEMS EXPOSED TO VIEW. (MIN. 2'-0" BEYOND CEILING OPENING.). REFER TO DETAILS 2/A7.2

11. ACT TYPE "A", REFER TO SPECIFICATIONS. 12. ACT TYPE "B", REFER TO SPECIFICATIONS.

13. CMU BULKHEAD.

14. CEILING FAN. COORDINATE LOCATION AND WEIGHT w/ MECH. CONTRACTOR. 15. PRE-MFR. CANOPY, REFER TO ROOF PLAN.

16. ALUMINUM COMPOSITE PANEL CEILING.

17. GYP. BD. PARTITION BULKHEAD - SEE 2/A7.2.

18. ICF BULKHEAD

REFLECTED CEILING LEGEND

CEILING HEIGHT, A.F.F.

NOTE: REFER TO SECTIONS AND DETAILS FOR EXTERIOR CEILING HEIGHTS NOT SHOWN.


 $2\mbox{'}x2\mbox{'}$ SUSPENDED ACOUSTICAL CEILING (ACT-1) @ 9' - 0" A.F.F. U.N.O., REFER TO SPECS.

2'x2' SUSPENDED ACOUSTICAL CEILING (ACT-2) @ 9' - 0" A.F.F. U.N.O., REFER TO SPECS. EXTERIOR LINEAR METAL CEILING WITH WOOD

GRAIN PATTERN (TYPE 'B') GYPSUM BOARD SOFFIT OR BULKHEAD, PAINT.

EXISTING BUILDING TO REMAIN.

ARROW INDICATES DIRECTION OF LINEAR CEILING.

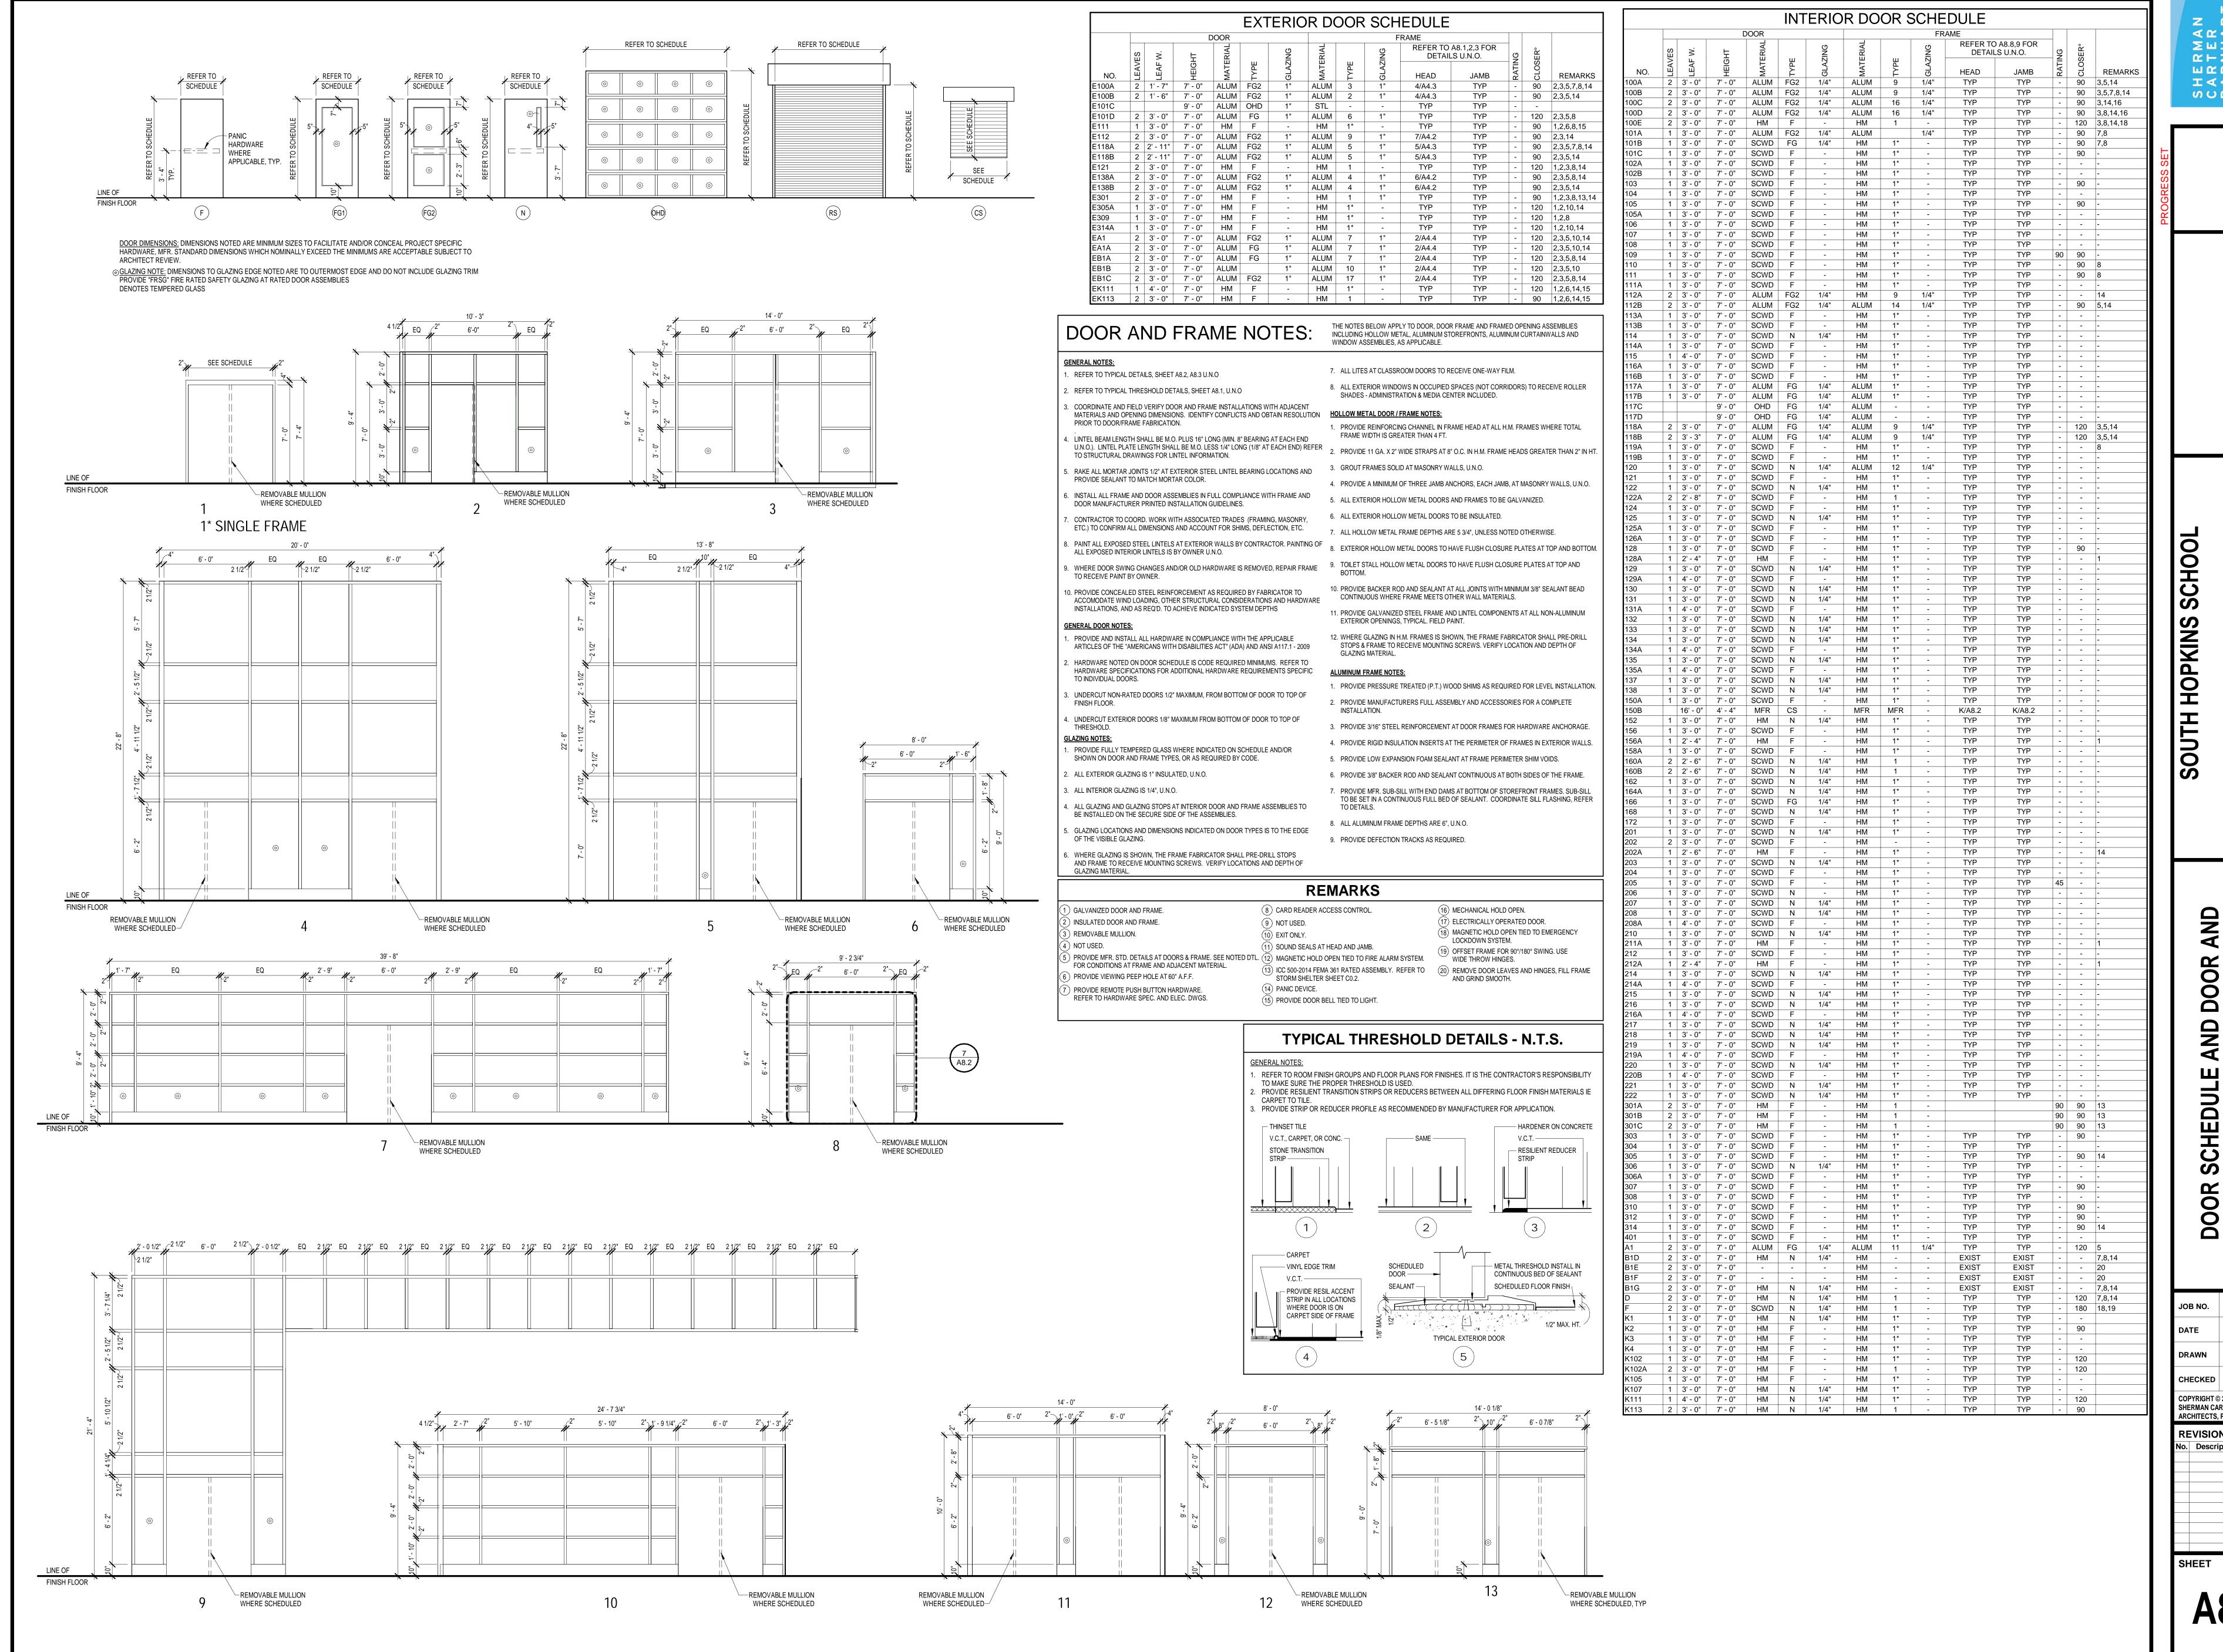


2246 SOUTH HOPKINS SCH 9/11/2023 3:01:03 PM

Z AMA $\Sigma \sqcup I$ $\alpha \vdash z$ шкк IVV S C M <

OOR NS AND DO EDUI ME E I S I

SEPT 11,2023 **COPYRIGHT © 2023 SHERMAN CARTER BARNHA** ARCHITECTS, PLLC REVISIONS No. Description Date

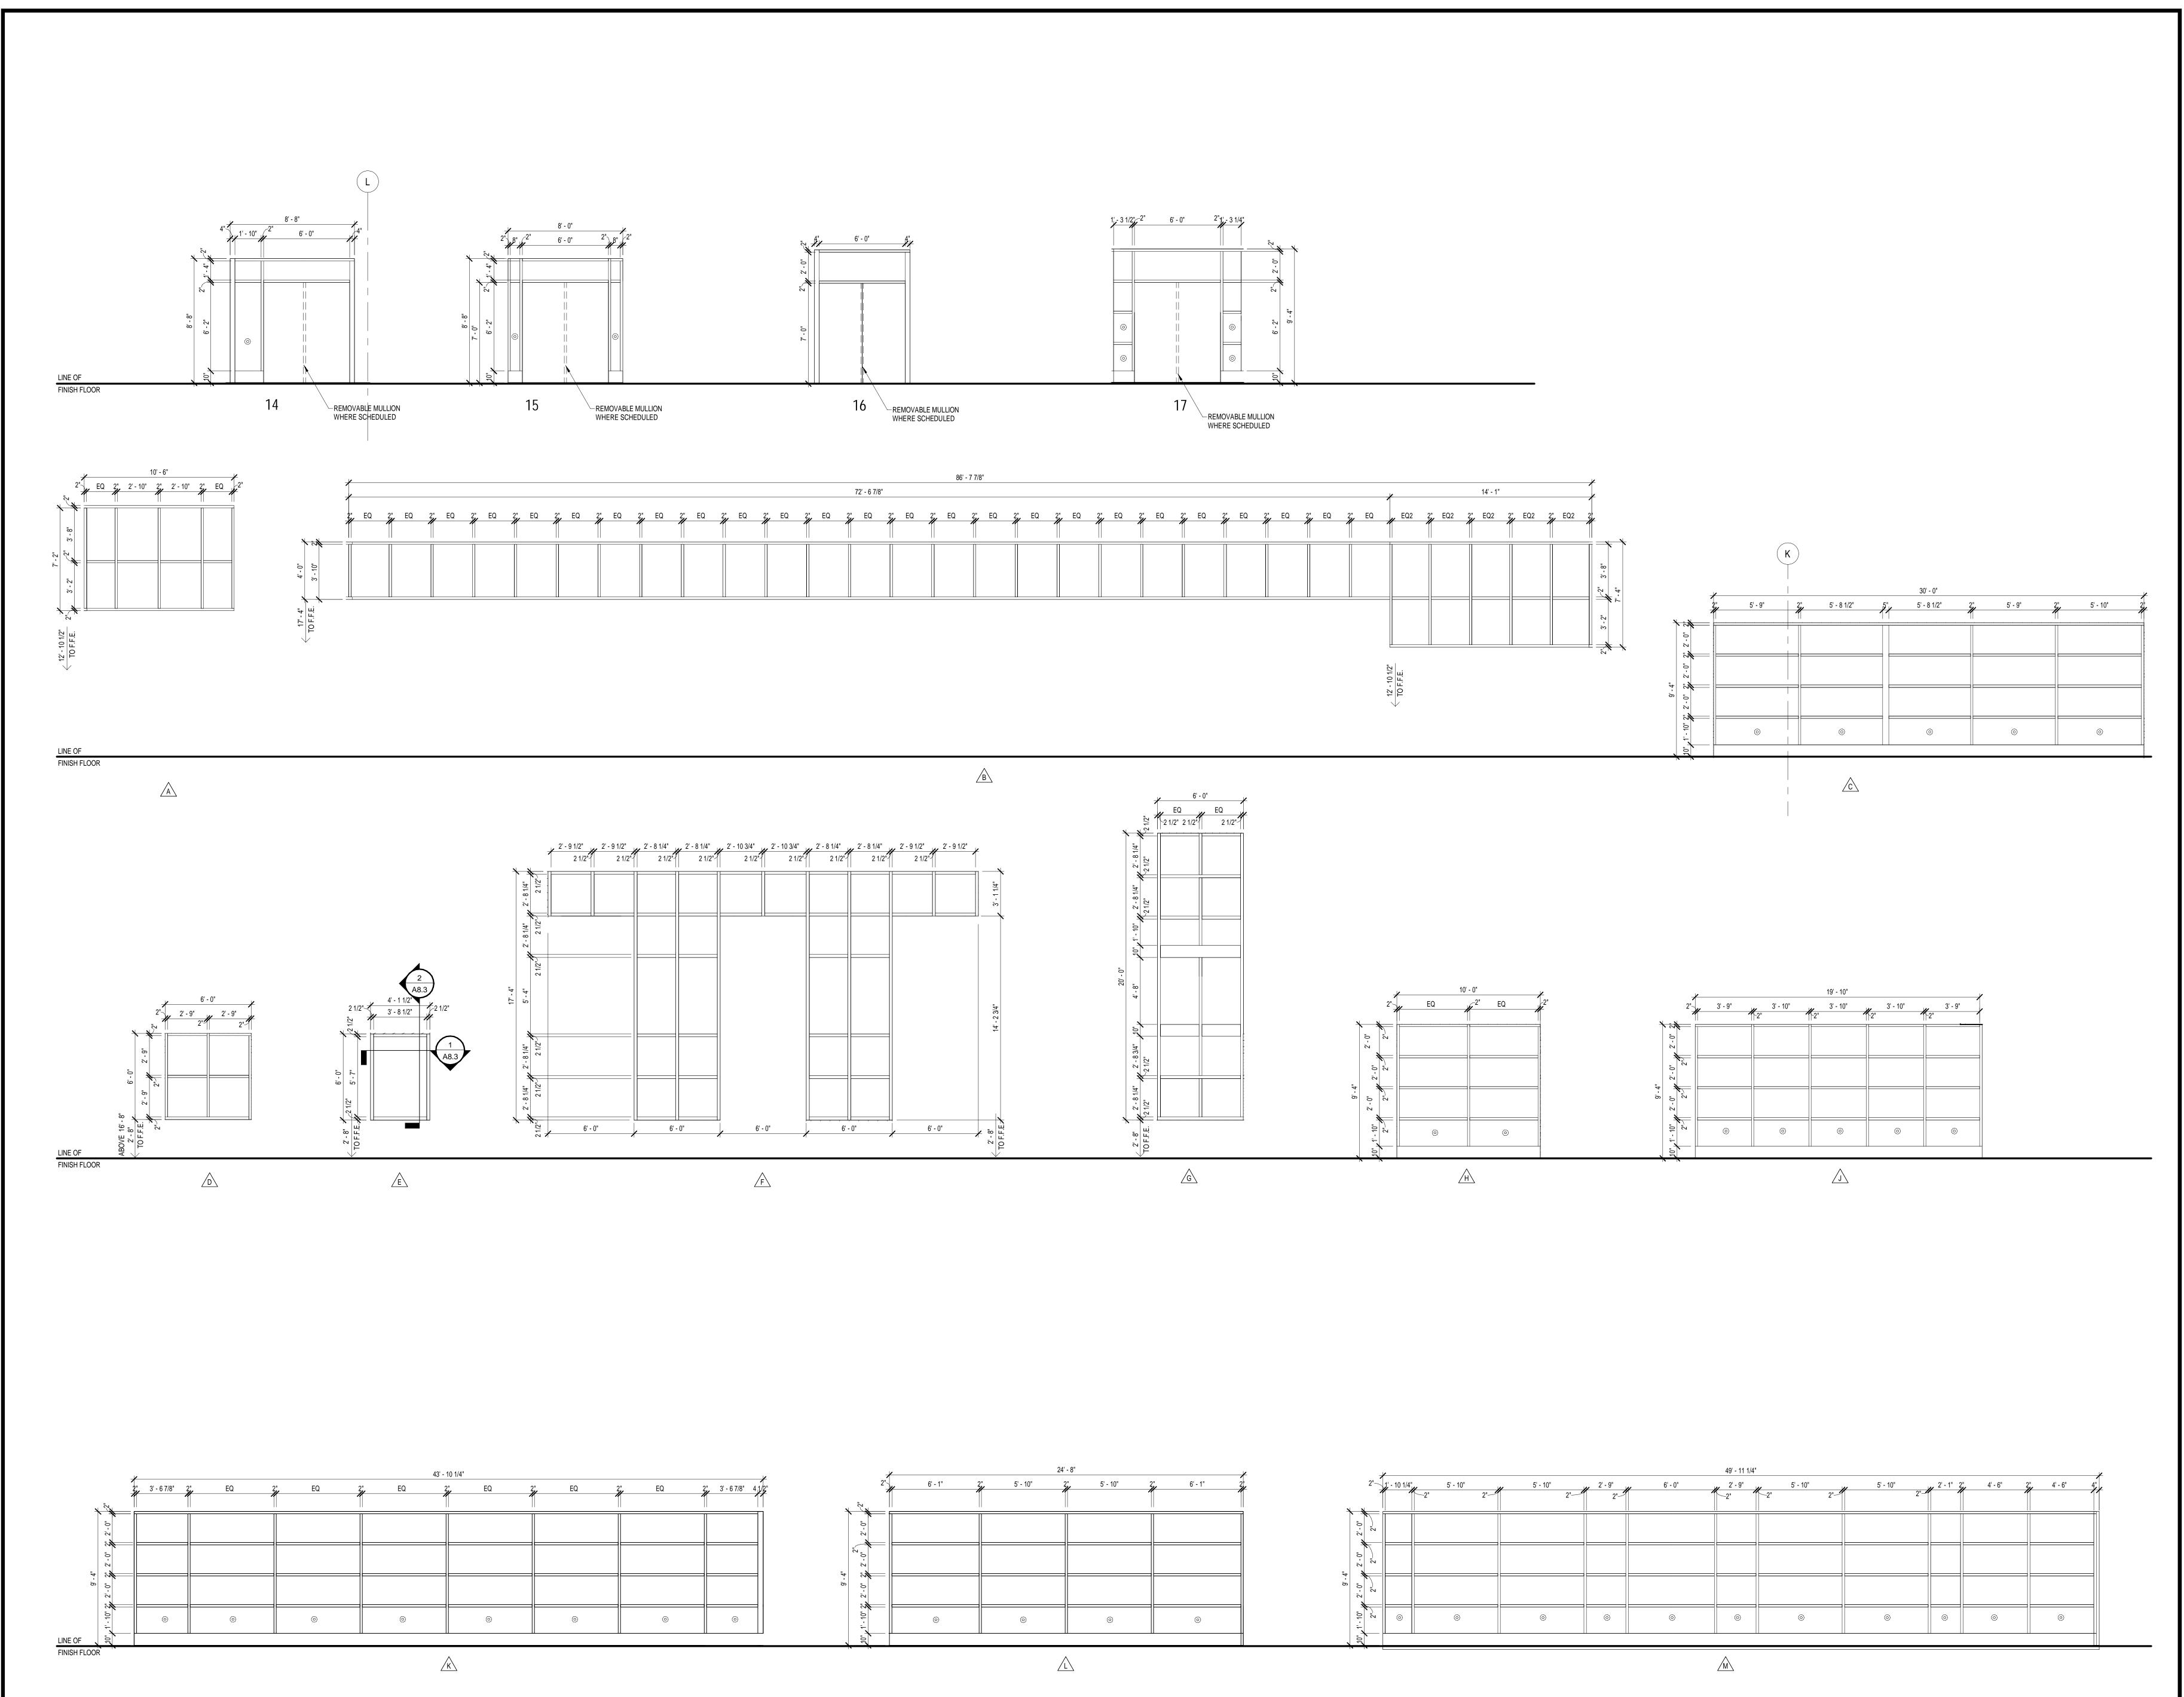

2246 SOUTH HOPKINS SCHOOL 9/11/2023 3:01:10 PM



SOUTH HOPKINS SCHOOL
9220 HOPKINSVILLE RD,
NORTONVILLE, KY

FRAME ELEVATIONS AND DETAILS

JOB NO. 2246

DATE SEPT 11,2023

DRAWN Author

CHECKED Checker


COPYRIGHT © 2023
SHERMAN CARTER BARNHART
ARCHITECTS, PLLC

REVISIONS

No. Description Date

SHEET

A8.2

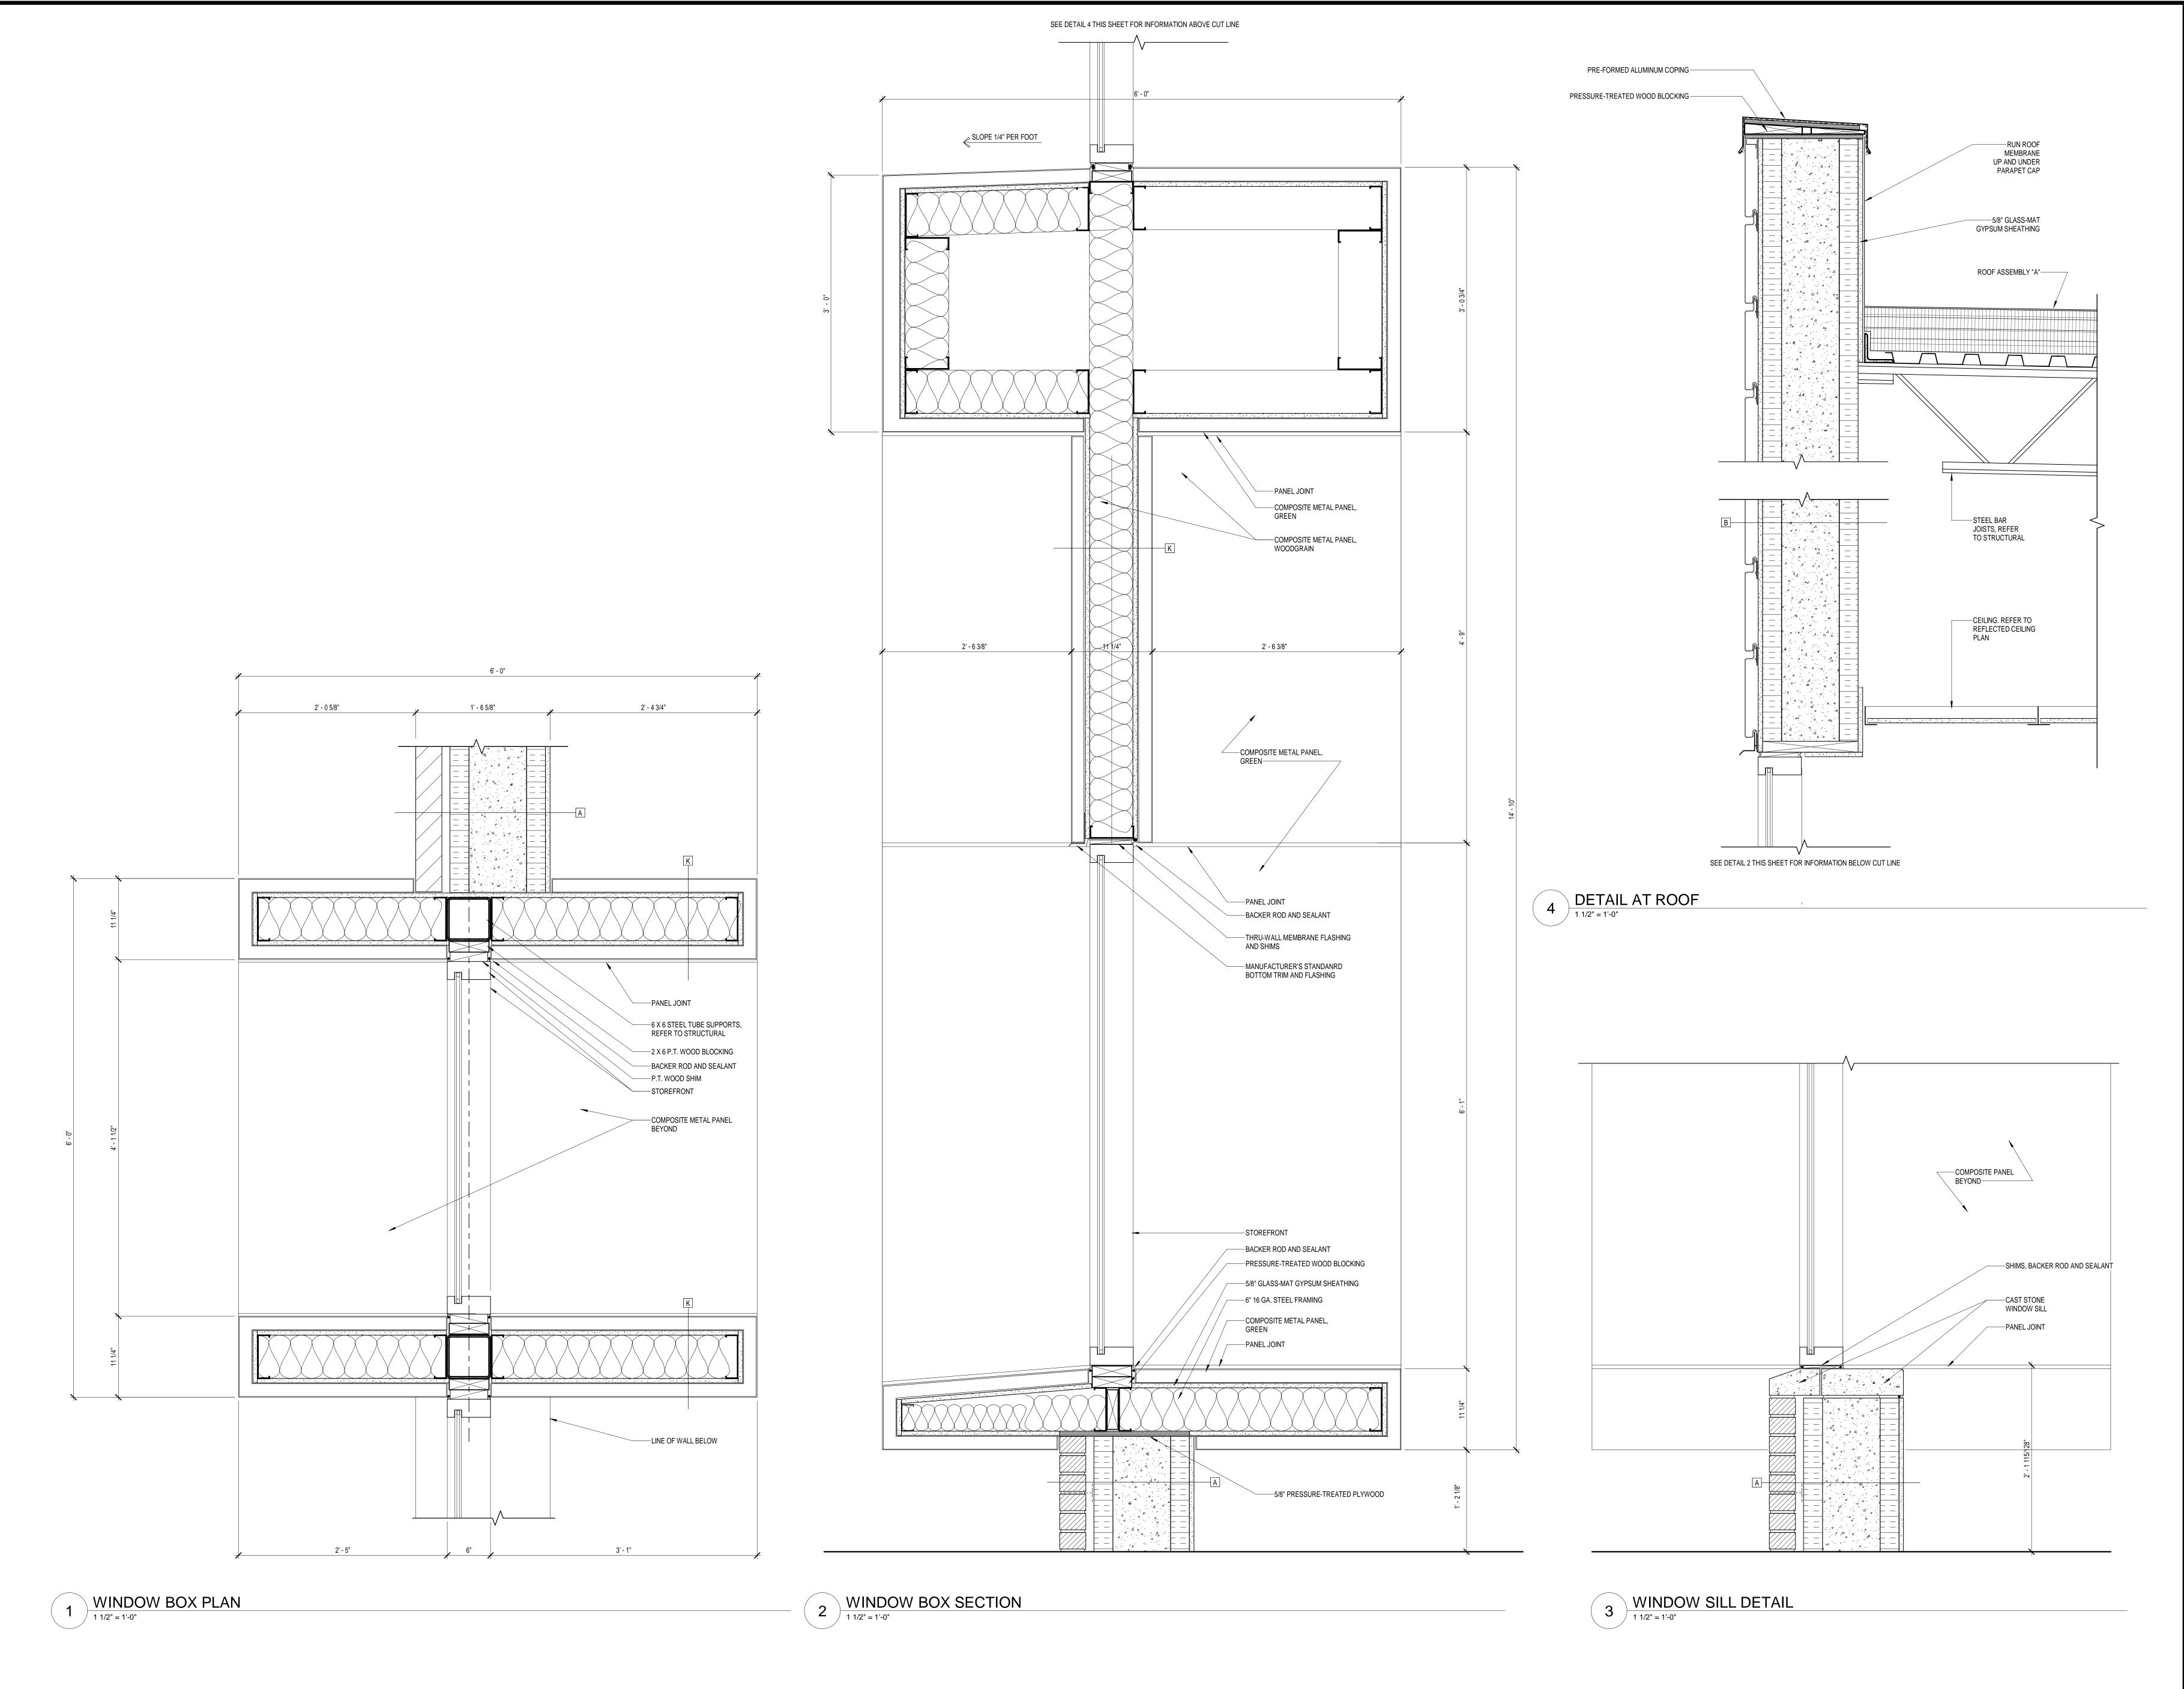

2246 SOUTH HOPKINS SCHOOL 9/11/2023 3:01:13 PM



SCHOOL DPKINSVILLE RD, TONVILLE, KY

> **DETAILS** WINDOW CENTER

DRAWN CHECKED COPYRIGHT © 2023 SHERMAN CARTER BARNHART ARCHITECTS, PLLC REVISIONS

No. Description Date

A8.3




20 HOF NORT


A AM

00H

SEPT 11,202 AN DRAWN CHECKED **COPYRIGHT © 2023** SHERMAN CARTER BARNHAF ARCHITECTS, PLLC REVISIONS No. Description Date

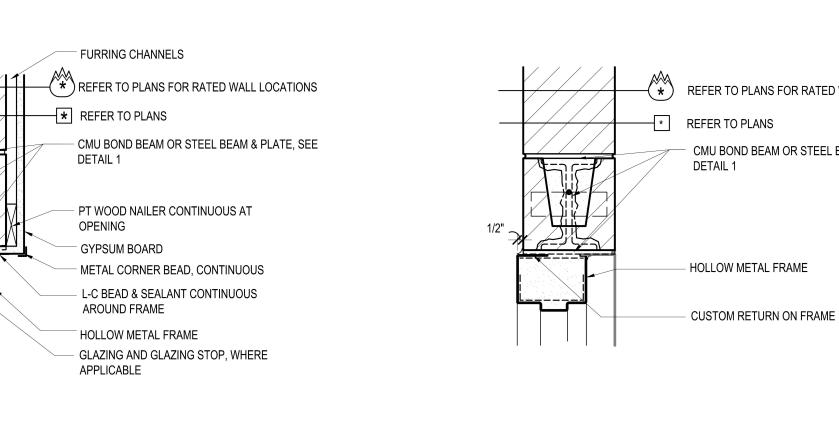




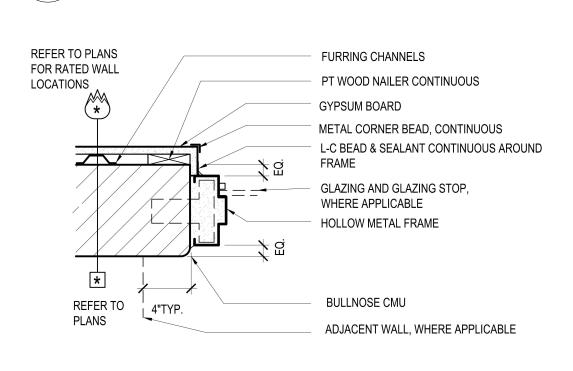


SILL CONDITION SIMILAR, ROTATED 90 DEGREES, OMIT WALL TIES, OMIT ADJACENT WALL REFERENCE.

TYPICAL HOLLOW METAL JAMB DETAIL AT CMU WITH FURRING

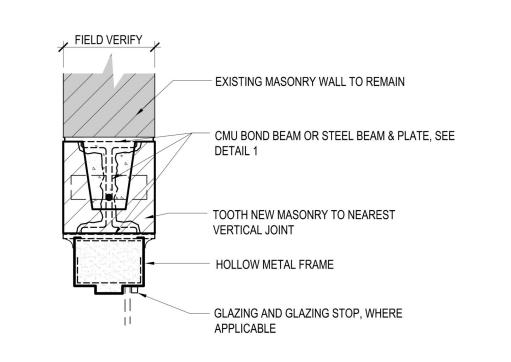


ALIGN WITH EXISTING CMU TYPICAL HOLLOW METAL HEAD DETAIL AT EXISTING CMU INFILL 1 1/2" = 1'-0"

CMU INFILL TO MATCH SIZE AND

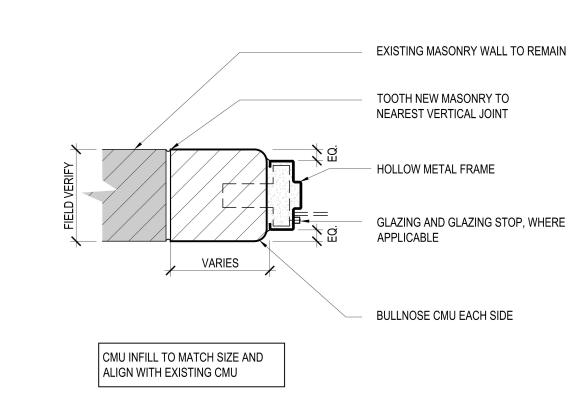


TYPICAL HOLLOW METAL JAMB INFILL DETAIL AT EXISTING CMU

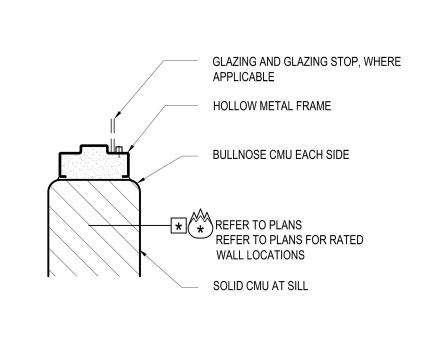


TYPICAL HOLLOW METAL SILL DETAIL / 1 1/2" = 1'-0"


2246 SOUTH HOPKINS SCH 9/11/2023 3:01:25 PM

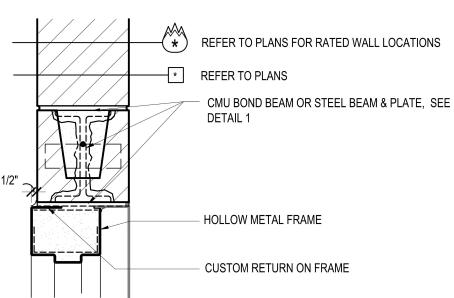


TYPICAL H.M. HEAD DETAIL AT 135°, 145° & 180° SWING1

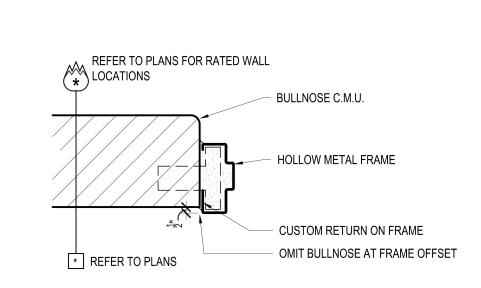


TYPICAL H.M. JAMB DETAIL AT 135°,

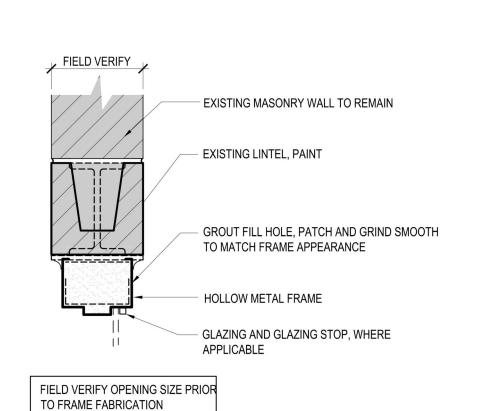


TYPICAL HOLLOW METAL HEAD DETAIL AT EXISTING CMU OPENING 1 1/2" = 1'-0"

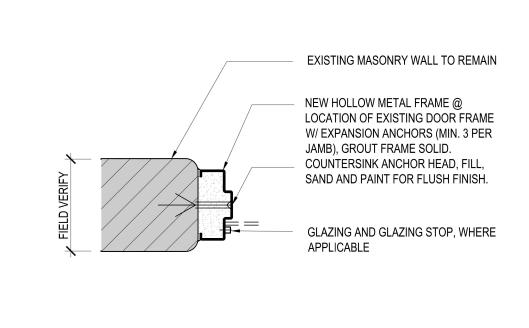


TYPICAL HOLLOW METAL JAMB DETAIL AT EXISTING CMU OPENING

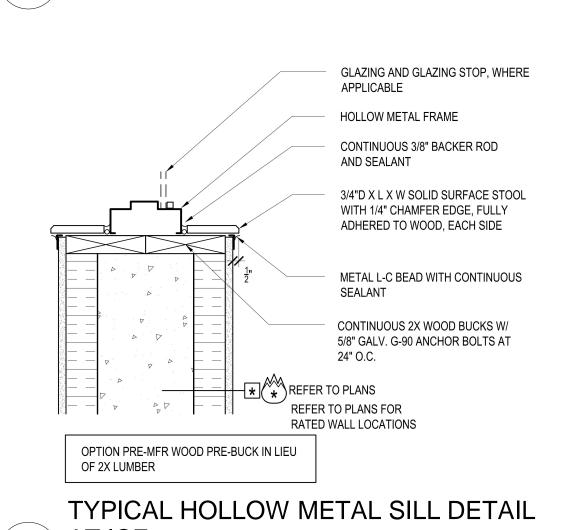

1 1/2" = 1'-0"

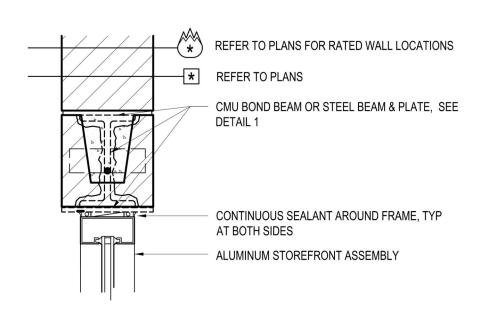


TYPICAL ALUMINUM FRAME HEAD F DETAIL AT INTERIOR CMU [/] 1 1/2" = 1'-0"

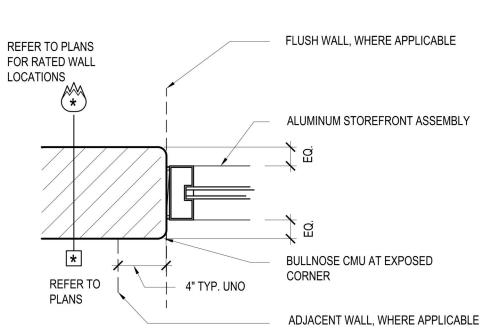


SILL CONDITION SIMILAR, ROTATED 90 DEGREES, OMIT WALL REFERENCES.


TYPICAL ALUMINUM FRAME JAMB DETAIL AT INTERIOR CMU 1 1/2" = 1'-0"

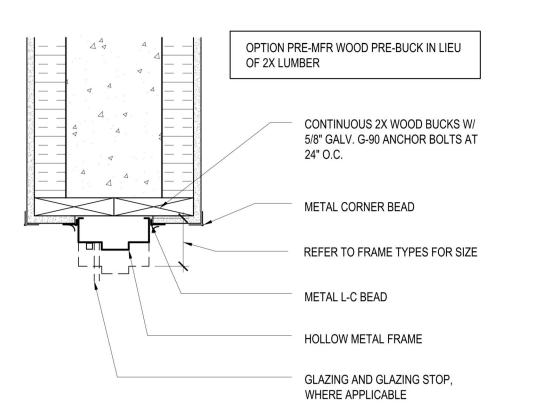

TYPICAL HOLLOW METAL HEAD H DETAIL AT ICF 1 1/2" = 1'-0"

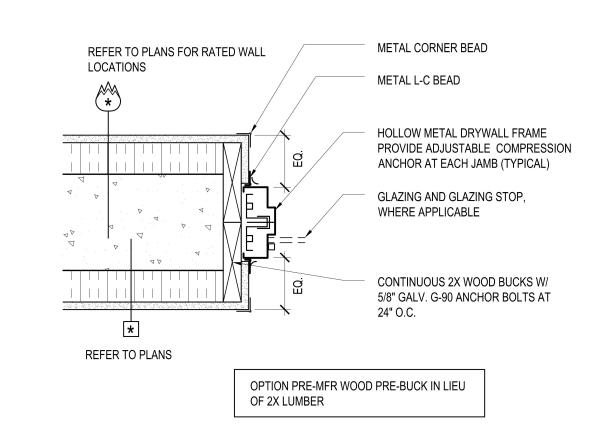

TYPICAL HOLLOW METAL JAMB DETAIL AT ICF

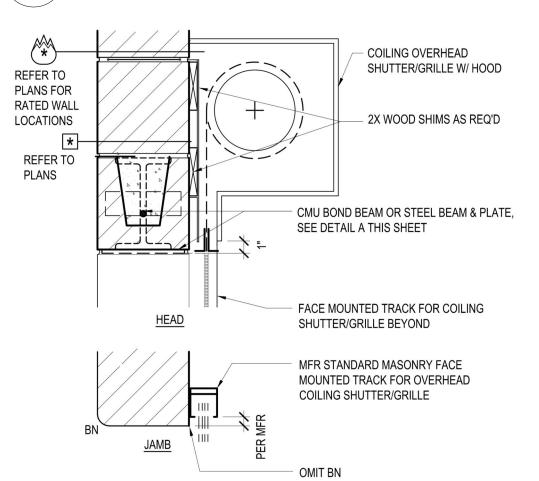


TYPICAL COILING OVERHEAD SHUTTER-GRILLE HEAD AND JAMB DETAIL E 1 1/2" = 1'-0"


 GLAZING AND GLAZING STOP - HOLLOW METAL FRAME - GROUT SOLID WHERE LOCATED AT MASONRY WALLS CONTINUOUS SEALANT, EACH SIDE AT NON-CARPET FINISHES FLOOR FINISH ABUTT FRAME CONCRETE FLOOR SLAB

TYPICAL HOLLOW METAL FRAME BASE DETAIL


FOR ALL DETAILS THIS SHEET, TYP. TYPICAL HOLLOW METAL HEAD DETAIL AT INTERIOR CMU1

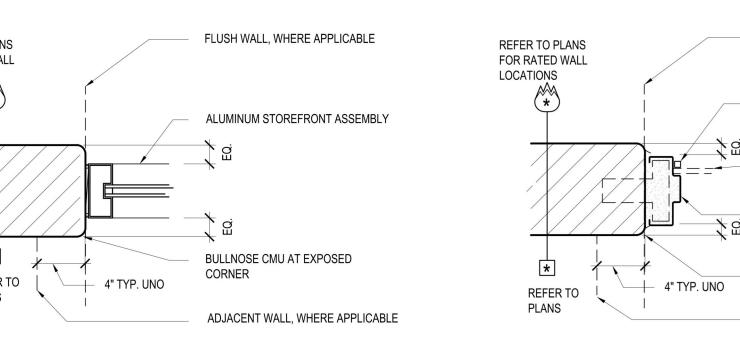


TYPICAL HOLLOW METAL JAMB DETAIL AT INTERIOR CMU

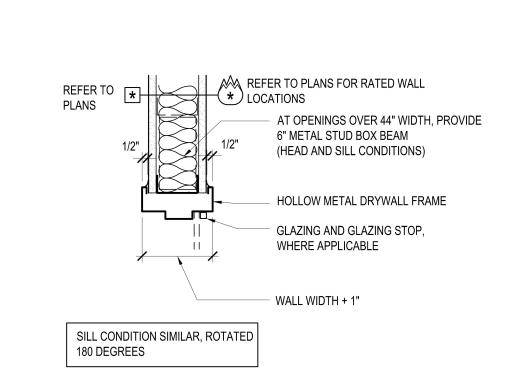

TYPICAL HOLLOW METAL HEAD DETAIL AT METAL STUD

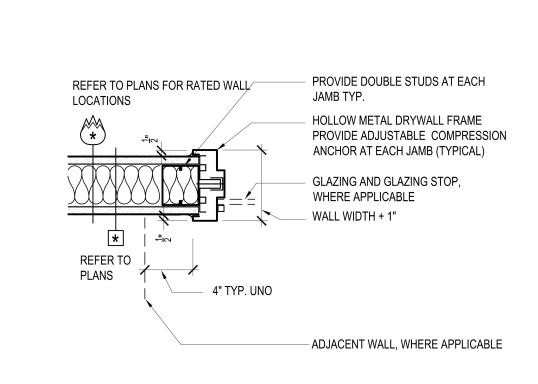

TYPICAL HOLLOW METAL JAMB DETAIL AT METAL STUD

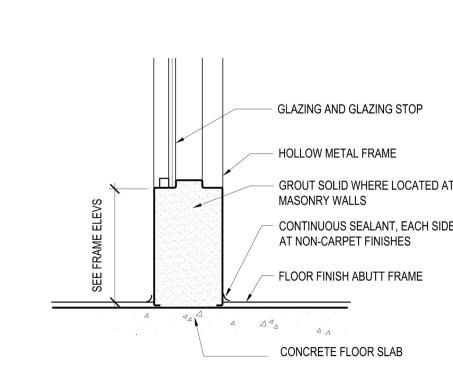

GENERAL NOTES: - CMU BOND BEAM OR STEEL BEAM & PLATE, SEE STRUCTURAL 1. REFER TO TYPICAL FRAME DETAILS, UNLESS NOTED OTHERWISE. 2. REFER TO TYPICAL THRESHOLD DETAILS, UNLESS NOTED OTHERWISE.

CMU SOAPS AT STEEL BEAM WITH MASONRY TIES AT 16" O.C., EACH SIDE 3. REFER TO FRAME ELEVATIONS FOR FACE DIMENSION, UNLESS NOTED OTHERWISE.

* REFER TO PLANS FOR RATED WALL LOCATIONS

CONT. SEALANT AROUND FRAME, TYP. AT

FLUSH WALL, WHERE APPLICABLE

GLAZING STOP, WHERE APPLICABLE

GLAZING, WHERE APPLICABLE

HOLLOW METAL FRAME

BULLNOSE CMU (TYP)

ADJACENT WALL, WHERE APPLICABLE

BOTH SIDES

HOLLOW METAL FRAME

WHERE APPLICABLE

REFER TO FRAME TYPES, ELEVATIONS AND DOOR AND FRAME NOTES FOR ADDITIONAL INFORMATION

1 1/2" = 1'-0"

GLAZING AND GLAZING STOP,

4. COORDINATE AND FIELD VERIFY DOOR AND FRAME INSTALLATIONS WITH ADJACENT MATERIALS AND OPENING DIMENSIONS. IDENTIFY CONFLICTS AND OBTAIN RESOLUTION PRIOR TO DOOR/FRAME FABRICATION.

5. LINTEL BEAM LENGTH SHALL BE M.O. PLUS 16" LONG (MIN. 8" BEARING AT EACH END UNLESS NOTED OTHERWISE). LINTEL PLATE LENGTH SHALL BE M.O. LESS 1/4" LONG (1/8" AT EACH END) REFER TO STRUCTURAL DRAWINGS FOR LINTEL INFORMATION. PAINT EXPOSED STEEL, U.N.O.

THE DETAILS ON THIS SHEET ARE TYPICAL OFFICE STANDARDS, TO BE UTILIZED WHERE APPLICABLE FOR

REFER TO PROJECT PLANS, WALL TYPES AND FRAME ASSEMBLIES FOR SPECIFIC REQUIREMENTS FOR THIS

THE NOTES BELOW APPLY TO DOOR, DOOR FRAME AND FRAMED OPENING ASSEMBLIES, AS APPLICABLE.

6. RAKE ALL MORTAR JOINTS 1/2" AT EXTERIOR STEEL LINTEL BEARING LOCATIONS AND PROVIDE SEALANT TO MATCH MORTAR COLOR.

7. INSTALL ALL FRAME AND DOOR ASSEMBLIES IN FULL COMPLIANCE WITH FRAME AND DOOR MANUFACTURER PRINTED INSTALLATION GUIDELINES.

8. PROVIDE AND INSTALL ALL HARDWARE IN COMPLIANCE WITH THE APPLICABLE ARTICLES OF THE "AMERICANS WITH DISABILITIES ACT" (ADA) AND ANSI A117.1 - 2009

HARDWARE NOTED ON THE DOOR SCHEDULE ARE CODE REQUIRED MINIMUMS. REFER TO HARDWARE SPECIFICATIONS FOR ADDITIONAL HARDWARE REQUIREMENTS SPECIFIC TO INDIVIDUAL DOORS. CONTACT THE ARCHITECT IN WRITING IF CONFLICTS ARE FOUND, AND OBTAIN CLARIFICATION PRIOR TO

10. UNDERCUT NON-RATED DOORS 1/2" MAXIMUM, FROM BOTTOM OF DOOR TO TOP OF FINISH FLOOR.

11. UNDERCUT EXTERIOR DOORS 1/8" MAXIMUM FROM BOTTOM OF DOOR TO TOP OF THRESHOLD.

HOLLOW METAL DOOR / FRAME NOTES:

DOOR AND FRAME NOTES

1. ALL HOLLOW METAL FRAME DEPTHS ARE 5 3/4", UNLESS NOTED OTHERWISE.

2. ALL HOLLOW METAL DOORS AND FRAMES ARE TO BE PAINTED, UNLESS NOTED OTHERWISE.

3. PROVIDE A MINIMUM OF THREE STRAP JAMB ANCHORS, EACH JAMB, AT MASONRY WALLS, UNLESS NOTED OTHERWISE.

4. GROUT FRAMES SOLID AT MASONRY WALLS, UNLESS NOTED OTHERWISE.

5. PROVIDE CONTINUOUS SEALANT AT EACH FRAME FACE.

6. ALL EXTERIOR HOLLOW METAL DOORS AND FRAMES TO BE GALVANIZED. 7. ALL EXTERIOR HOLLOW METAL DOORS TO BE INSULATED.

8. PROVIDE REINFORCING CHANNEL IN FRAME HEAD AT ALL H.M. FRAMES WHERE TOTAL FRAME WIDTH IS GREATER THAN 4 FT.

9. PROVIDE 11GA. X 2" WIDE STRAPS AT 8" O.C. IN H.M. FRAME HEADS GREATER THAN 2" IN HT.

10. EXTERIOR HOLLOW METAL DOORS TO HAVE FLUSH CLOSURE PLATES AT TOP AND BOTTOM.

11. TOILET STALL HOLLOW METAL DOORS TO HAVE FLUSH CLOSURE PLATES AT TOP AND BOTTOM.

1. ALL STOREFRONT FRAME DEPTHS ARE 4 1/2", UNLESS NOTED OTHERWISE.

2. PROVIDE MANUFACTURERS STANDARD DETAILS FOR A FULL ASSEMBLY WITH ACCESSORIES FOR A COMPLETE INSTALLATION.

3. PROVIDE 3/16" STEEL REINFORCEMENT AT DOOR FRAMES FOR HARDWARE ANCHORAGE

4. PROVIDE PRESSURE TREATED (P.T.) WOOD SHIMS AS REQUIRED FOR LEVEL INSTALLATION.

5. PROVIDE 3/8" BACKER ROD AND SEALANT CONTINUOUS AT BOTH SIDES OF THE FRAME. 6. AT EXTERIOR FRAMES, PROVIDE RIGID INSULATION INSERTS AT FRAME PERIMETER.

7. AT EXTERIOR FRAMES, PROVIDE LOW EXPANSION FOAM SEALANT AT FRAME PERIMETER SHIM VOIDS.

8. AT EXTERIOR FRAMES, PROVIDE MANUFACTURER SUB-SILL WITH END DAMS AT FRAME BASE. SUB-SILL TO BE SET IN A CONTINUOUS FULL BED OF SEALANT. COORDINATE SILL FLASHING, REFER TO DETAILS.

GLAZING NOTES:

ALUMINUM FRAME NOTES:

1. ALL EXTERIOR GLAZING IS 1" INSULATED, UNLESS NOTED OTHERWISE.

2. ALL INTERIOR GLAZING IS 1/4", UNLESS NOTED OTHERWISE

DENOTES TEMPERED GLAZING.

4. PROVIDE FIRE RATED GLAZING AT ALL GLAZING APPLICATIONS IN FIRE RATED WALLS. GLAZING AS REQUIRED BY CODE FOR APPLICATION.

5. "FRRG" INDICATES FIRE RESISTANT RATED GLAZING (D-H-W-"RATING") (ASTM E-119). "FPRG" INDICATES FIRE PROTECTION RATED GLAZING (D-H-"RATING"). THICKNESS AS REQUIRED FOR FIRE RATING

6. ALL GLAZING AND GLAZING STOPS AT INTERIOR DOOR AND FRAME ASSEMBLIES TO BE INSTALLED ON

THE SECURE SIDE OF THE ASSEMBLIES.


8. WHERE GLAZING IS SHOWN, THE FRAME FABRICATOR SHALL PRE-DRILL STOPS AND FRAME TO RECEIVE

7. GLAZING LOCATIONS AND DIMENSIONS INDICATED ON DOOR TYPES IS TO THE EDGE OF THE VISIBLE

MOUNTING SCREWS. VERIFY LOCATIONS AND DEPTH OF GLAZING MATERIAL. SPECIALTY FRAME NOTES IE SECTIONAL DOORS, COILING DOORS AND COILING SHUTTERS:

1. PROVIDE MANUFACTURERS STANDARD DETAILS FOR A FULL ASSEMBLY WITH ACCESSORIES FOR A COMPLETE INSTALLATION. 2. COORDINATE MANUFACTURER FRAME ANCHOR REQUIREMENTS WITH ADJACENT CONSTRUCTION.

3. INSTALL ASSEMBLIES PER MANUFACTURERS WRITTEN INSTALLATION GUIDELINES.

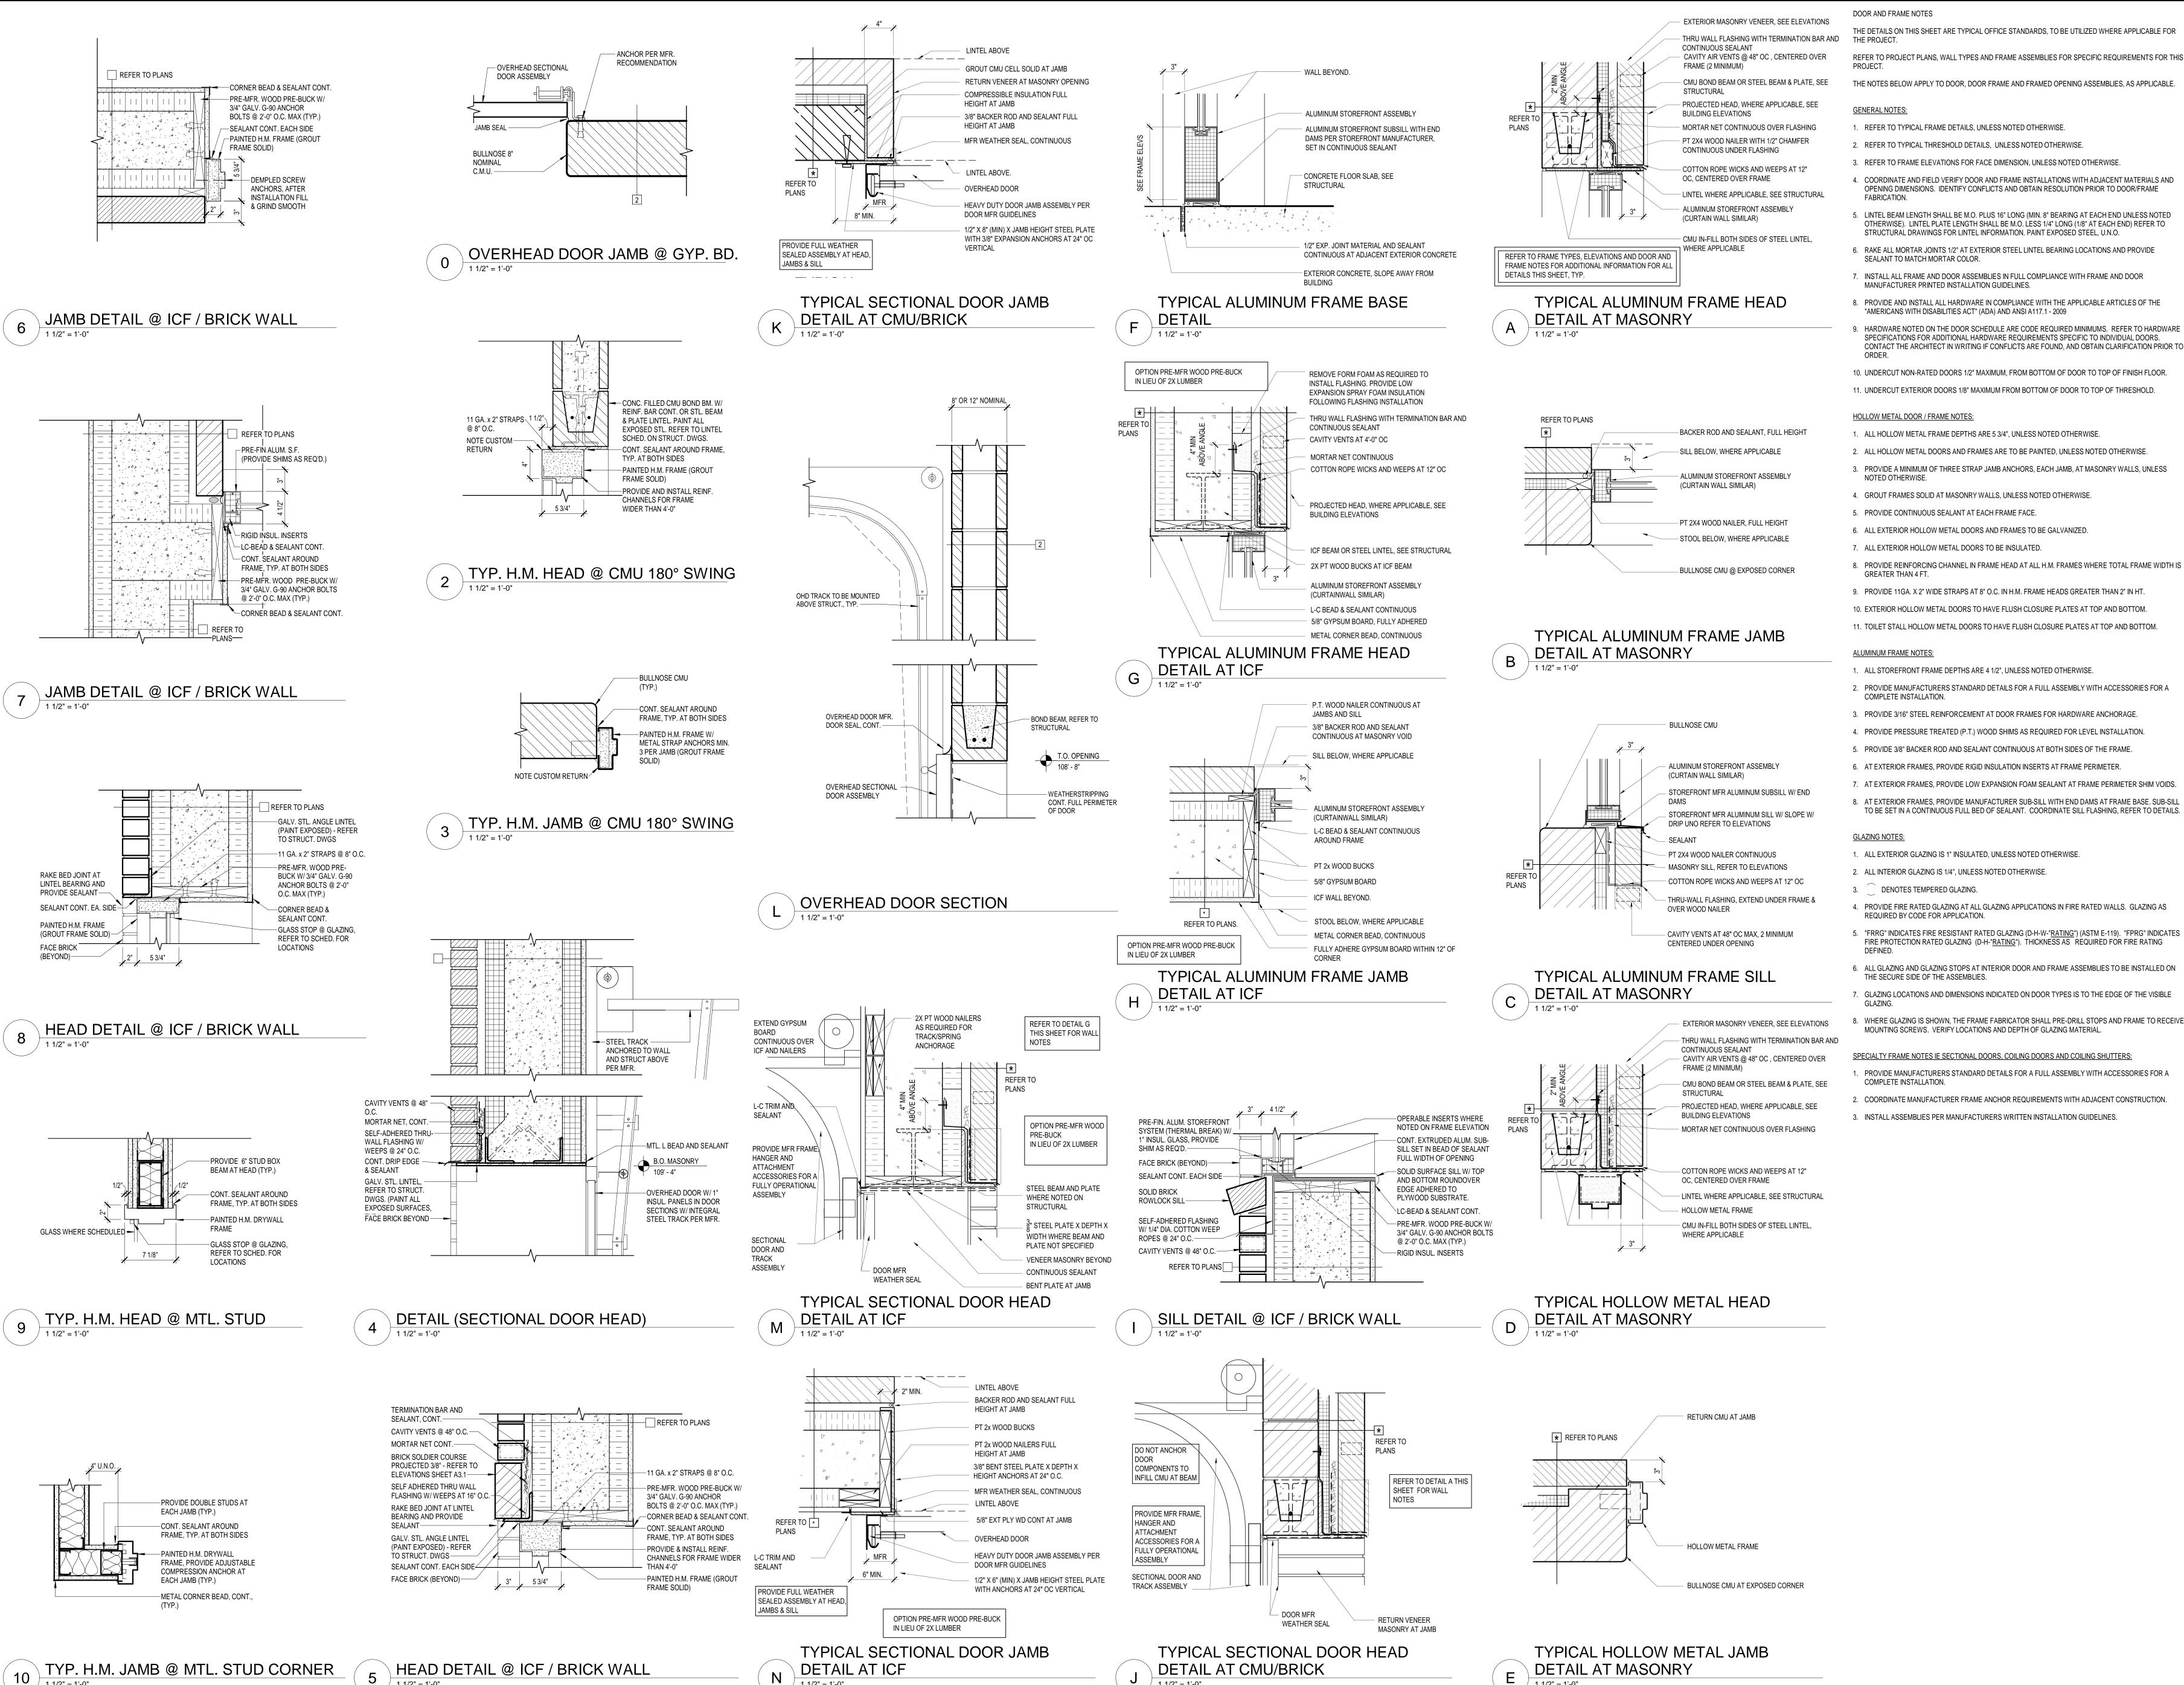

Z AMA $\Sigma \sqcup \mathbf{I}$ $\alpha \vdash z$ шсс I 4 4 S D M <

ОН

2. PROVIDE MANUFACTURERS STANDARD DETAILS FOR A FULL ASSEMBLY WITH ACCESSORIES FOR A

PROVIDE 3/16" STEEL REINFORCEMENT AT DOOR FRAMES FOR HARDWARE ANCHORAGE.

4. PROVIDE PRESSURE TREATED (P.T.) WOOD SHIMS AS REQUIRED FOR LEVEL INSTALLATION.

5. PROVIDE 3/8" BACKER ROD AND SEALANT CONTINUOUS AT BOTH SIDES OF THE FRAME 6. AT EXTERIOR FRAMES, PROVIDE RIGID INSULATION INSERTS AT FRAME PERIMETER.

7. AT EXTERIOR FRAMES, PROVIDE LOW EXPANSION FOAM SEALANT AT FRAME PERIMETER SHIM VOIDS.

8. AT EXTERIOR FRAMES, PROVIDE MANUFACTURER SUB-SILL WITH END DAMS AT FRAME BASE. SUB-SILL TO BE SET IN A CONTINUOUS FULL BED OF SEALANT. COORDINATE SILL FLASHING, REFER TO DETAILS.

1. ALL EXTERIOR GLAZING IS 1" INSULATED, UNLESS NOTED OTHERWISE.

4. PROVIDE FIRE RATED GLAZING AT ALL GLAZING APPLICATIONS IN FIRE RATED WALLS. GLAZING AS REQUIRED BY CODE FOR APPLICATION.

FIRE PROTECTION RATED GLAZING (D-H-"RATING"). THICKNESS AS REQUIRED FOR FIRE RATING 6. ALL GLAZING AND GLAZING STOPS AT INTERIOR DOOR AND FRAME ASSEMBLIES TO BE INSTALLED ON

THE SECURE SIDE OF THE ASSEMBLIES. 7. GLAZING LOCATIONS AND DIMENSIONS INDICATED ON DOOR TYPES IS TO THE EDGE OF THE VISIBLE

8. WHERE GLAZING IS SHOWN, THE FRAME FABRICATOR SHALL PRE-DRILL STOPS AND FRAME TO RECEIVE MOUNTING SCREWS. VERIFY LOCATIONS AND DEPTH OF GLAZING MATERIAL.

<u>SPECIALTY FRAME NOTES IE SECTIONAL DOORS, COILING DOORS AND COILING SHUTTERS</u>

PROVIDE MANUFACTURERS STANDARD DETAILS FOR A FULL ASSEMBLY WITH ACCESSORIES FOR A

COORDINATE MANUFACTURER FRAME ANCHOR REQUIREMENTS WITH ADJACENT CONSTRUCTION.


AM

20 HOF NORT

SEPT 11,202 DRAWN CHECKED COPYRIGHT © 2023 SHERMAN CARTER BARNHAF ARCHITECTS, PLLC REVISIONS No. Description Date

2246 SOUTH HOPKINS SCH 9/11/2023 3:01:36 PM

2246 SOUTH HOPKINS SCHOOL 9/11/2023 3:02:11 PM

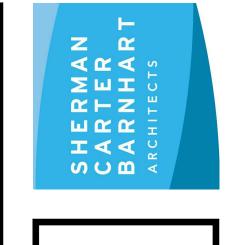

у

SOUTH HOPKINS SCHOOL
9220 HOPKINSVILLE RD,

T FLOOR PATTERN AND SIGNAGE
PLAN

JOB NO. 2246

DATE SEPT 11,2023

DRAWN ALC, ASC


CHECKED
COPYRIGHT © 2023
SHERMAN CARTER BARNHART
ARCHITECTS, PLLC

REVISIONS

No. Description Date

SHEET

A9.1

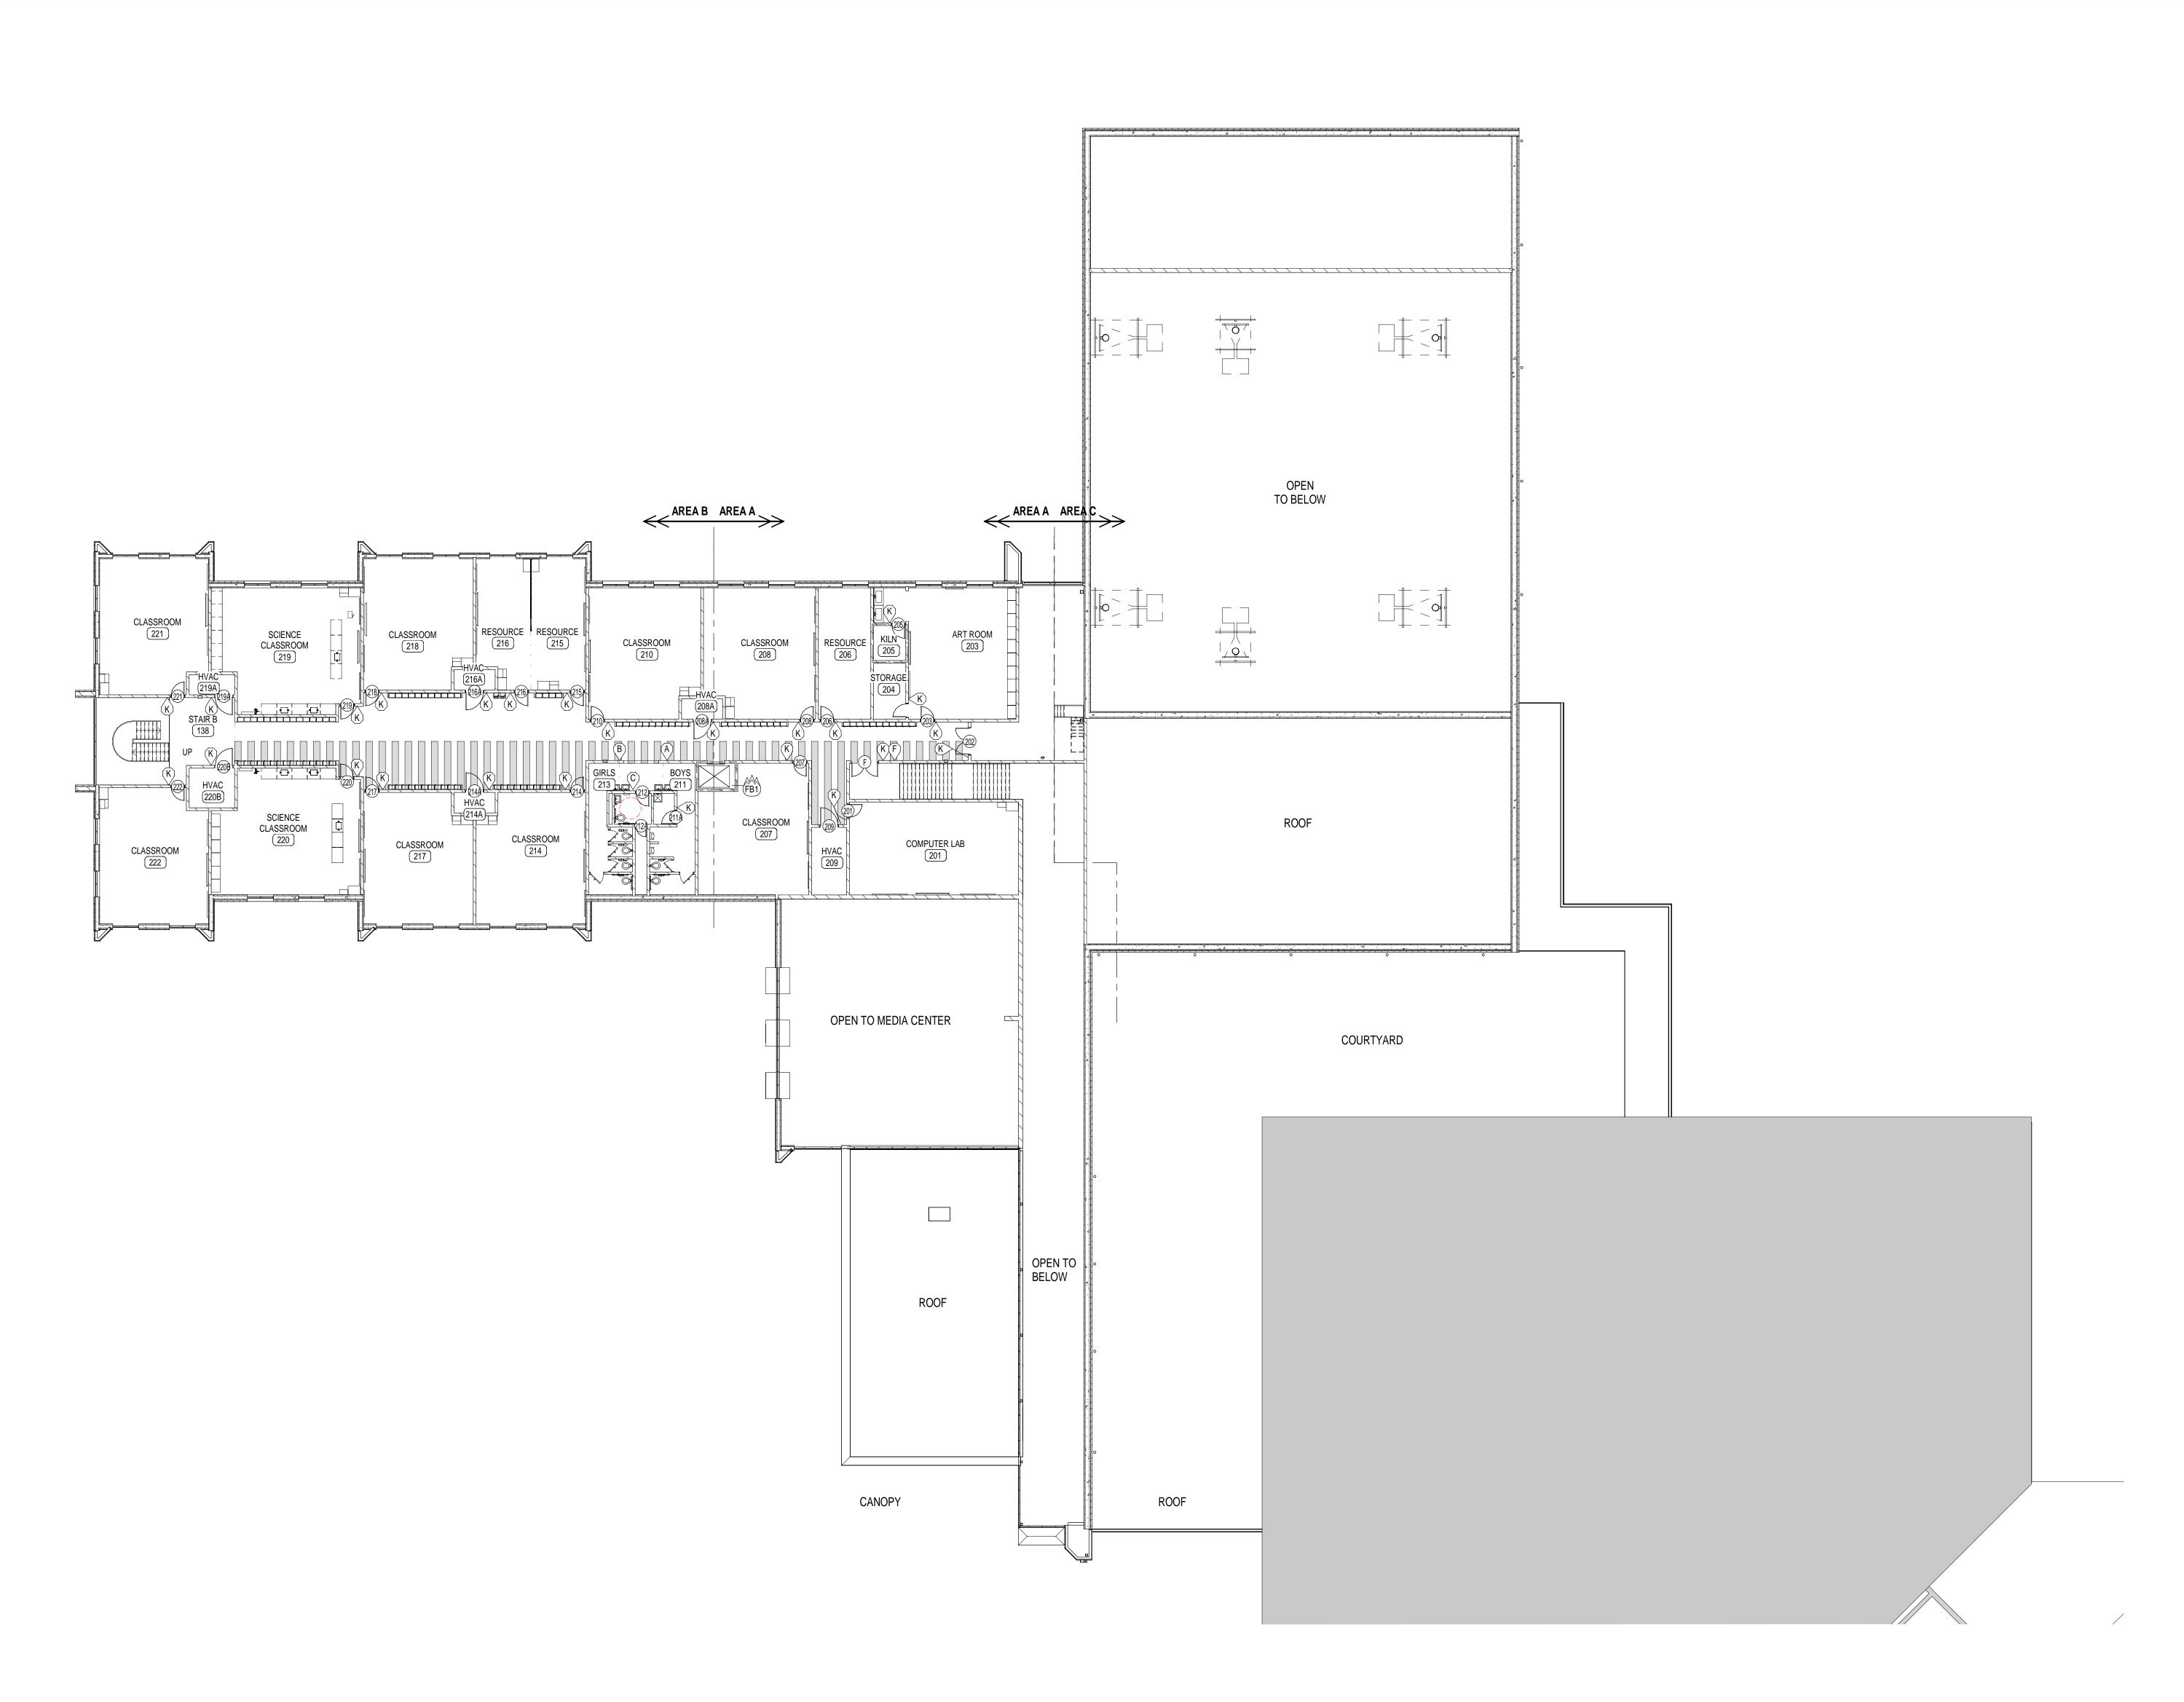

1 SECOND FLOOR SIGNAGE PLAN
1/16" = 1'-0"

2246 SOUTH HOPKINS SCHOOL 9/11/2023 3:02:13 PM SHERMAN CARTER BARNHART ARCHITECTS

SOUTH HOPKINS SCHOOL
9220 HOPKINSVILLE RD,
NORTONVILLE, KY

SECOND FLOOR PATTERN AND SIGNAGE PLAN

JOB NO. 2246

DATE SEPT 11,2023

DRAWN Author

CHECKED Checker

COPYRIGHT © 2023
SHERMAN CARTER BARNHART
ARCHITECTS, PLLC

REVISIONS

No. Description Date

SHEET

A9.2