




Softball **FIELD HOUSE**

integrity
ARCHITECTURE



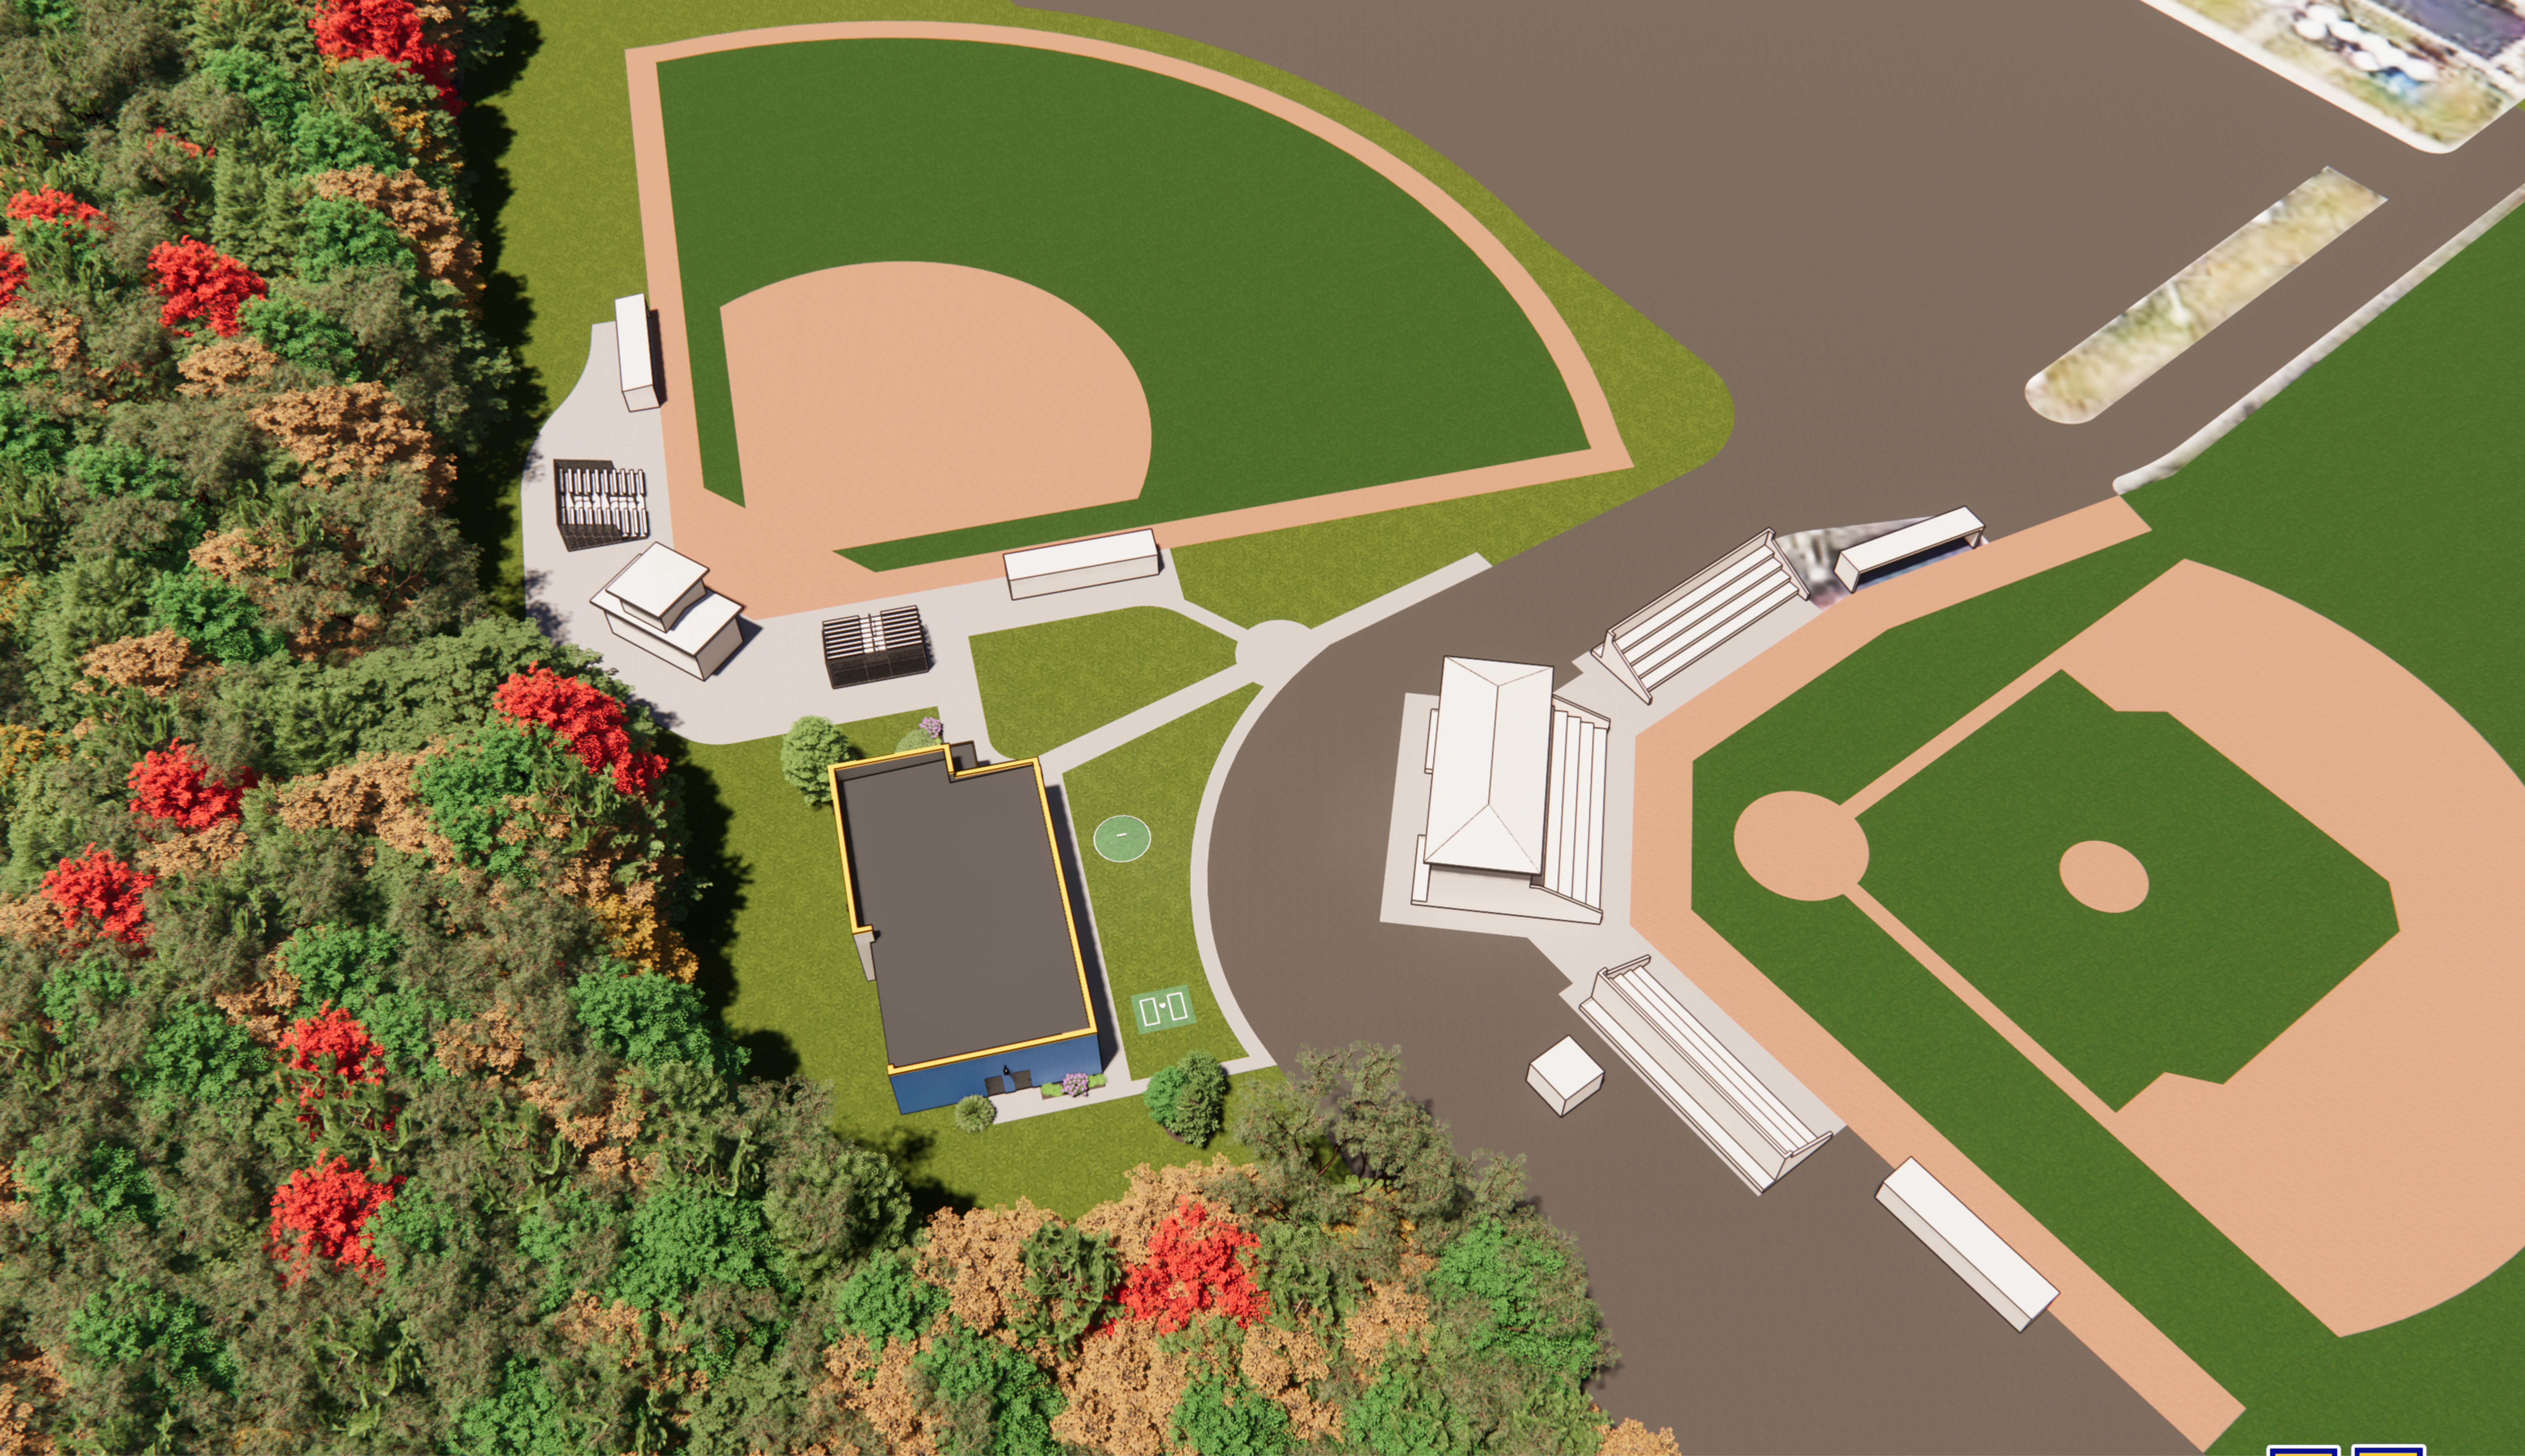


HENRY CLAY HS SOFTBALL FIELD HOUSE

2100 Fontaine Rd, Lexington, KY 40502



*IMAGE SHOWN FOR ILLUSTRATIVE PURPOSES ONLY. REFER TO DRAWINGS.

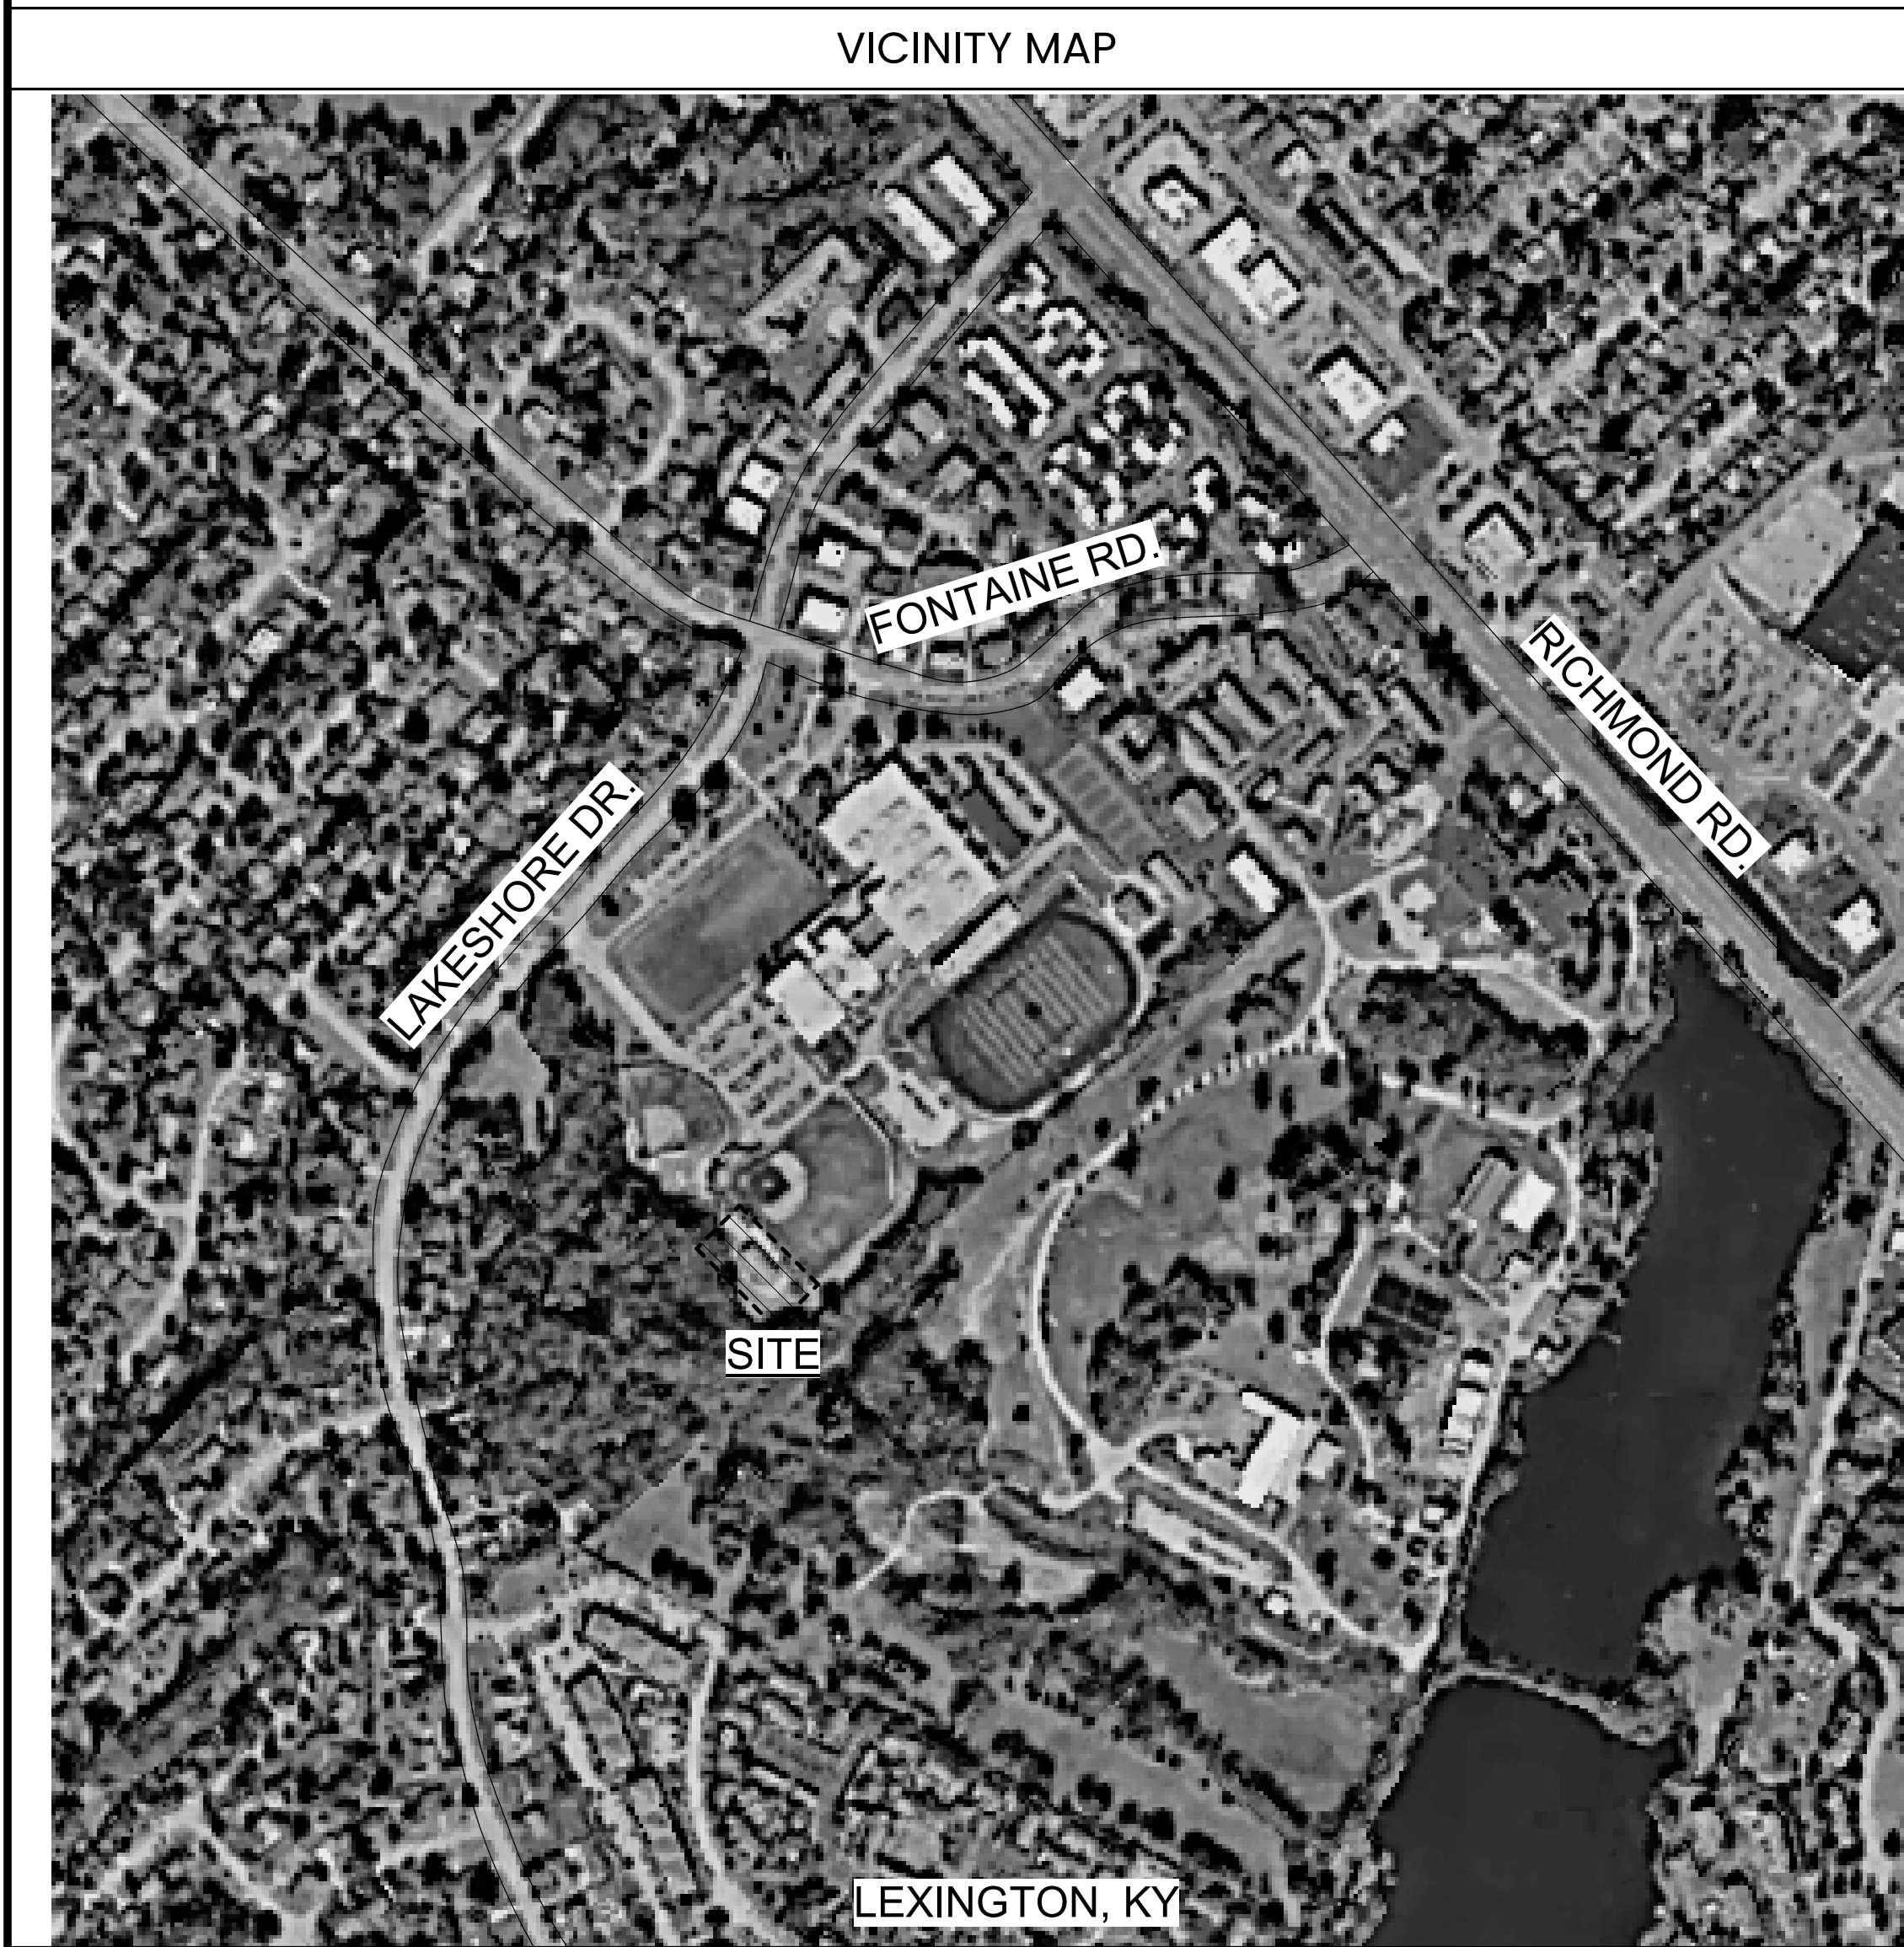

PROJECT TEAM

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MEP


E Tech Group
378 Park Ave.
Lexington, KY 40502
(859)254-4200

SITE


Element Design
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Lexington, KY 40508
(859)389-6533

STRUCTURAL

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Lexington, KY 40504
(859)255-9034

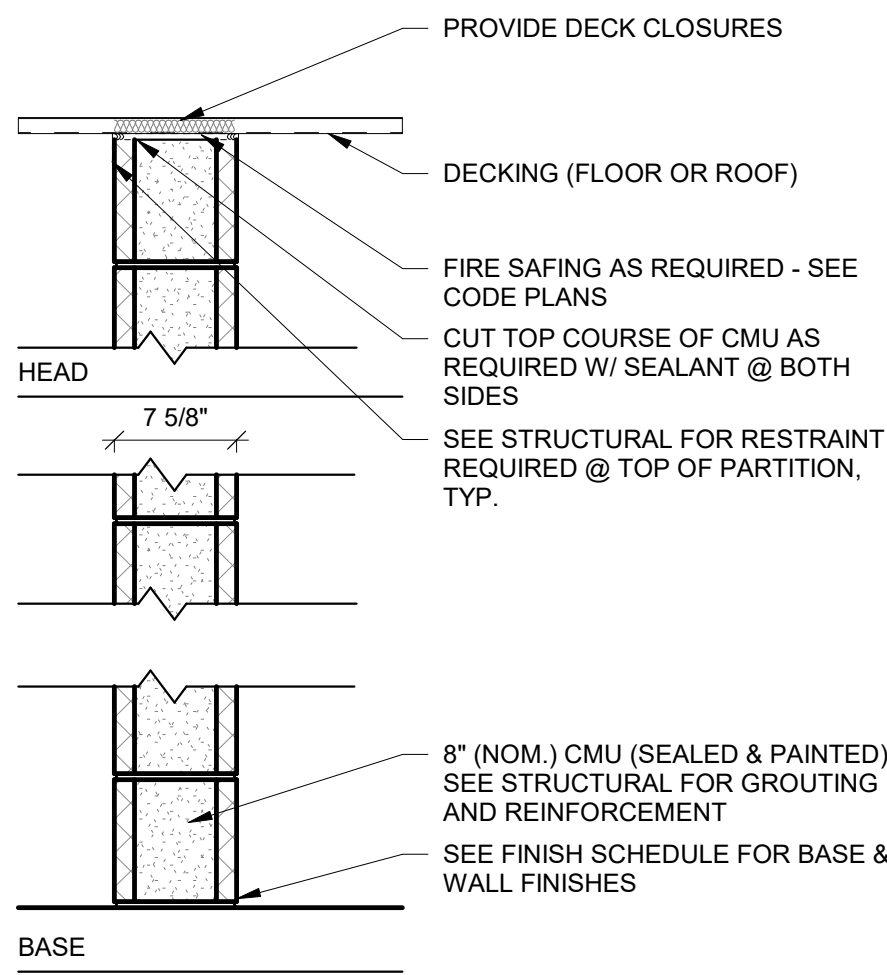

C8 - TYP. INT. CMU WALL

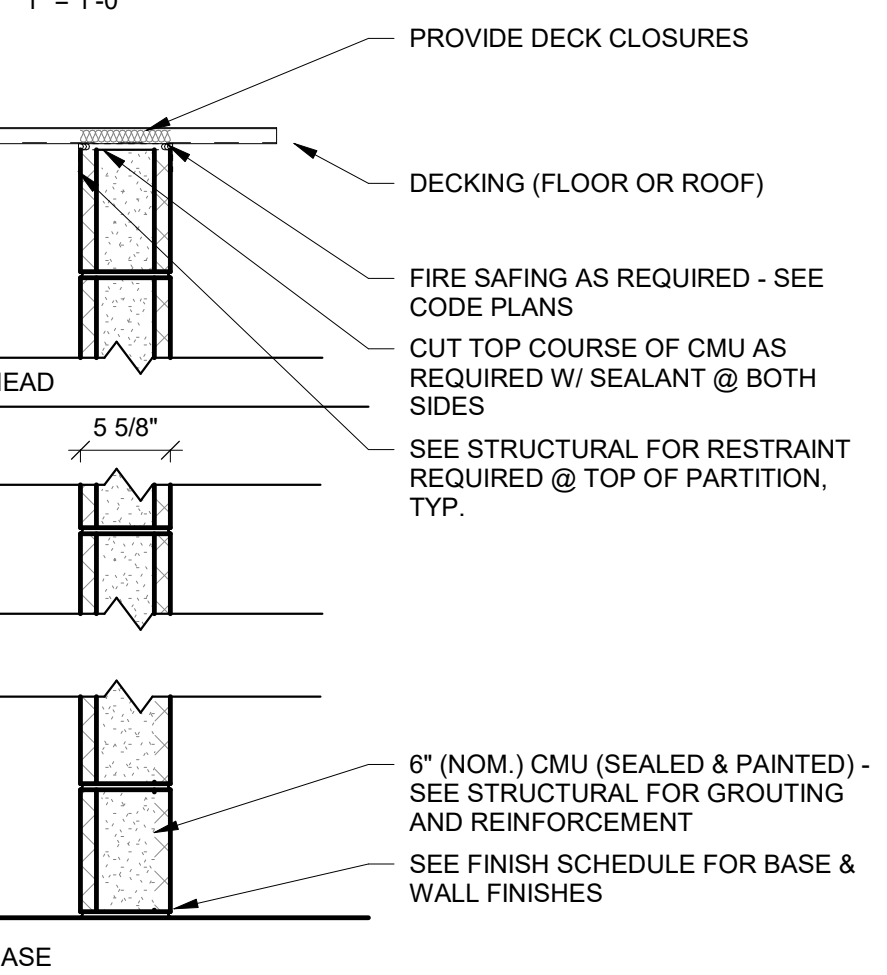

C6 - TYP. INT. CMU WALL

DRAWING INDEX


A2.1	RCP, ROOF PLAN AND DETAILS
A3.1	BUILDING ELEVATIONS
A4.1	BUILDING AND WALL SECTIONS
CIVIL	
C1.0	SITE PLAN, NOTE - THIS COLUMN IS SIZED FOR A 2-PART SPLIT SCHEDULE SO BOTH ADD UP TO 10\"/>
SITE UTILITY	
SU1.1	SITE UTILITY PLAN
STRUCTURAL	
S0.1	STRUCTURAL TITLE SHEET
ARCHITECTURAL	
A0.0	COVER SHEET & PROJECT NOTES
A1.1	FLOOR PLAN
A7.1	DOOR & WINDOW ELEVATIONS, DOOR SCHEDULE & DETAILS
INTERIOR	
I1.1	INTERIORS TITLE SHEET
FIRE PROTECTION	
FP0.1	FIRE PROTECTION LEAD SHEET
PLUMBING	
P0.1	PLUMBING LEAD SHEET
MECHANICAL	
M0.1	MECHANICAL LEAD SHEET
ELECTRICAL	
E0.1	ELECTRICAL LEAD SHEET

ABBREVIATIONS

A	And	N	New
@	At	NA	Not Applicable
A/C	Air Conditioning	NET	Means Exact Dimension Req'd.
AB	Anchor Bolt	NIC or	Not in Contract
ADH	Adhesive	N.I.C.	Number
ADJ	Adjustable / Adjacent	NO or #	Nominal
AFF	Above Finished Floor	NOM	Not to Scale
AGG	Aggregate	NTS	Not to Scale
AHU	Air Handling Unit	O	On Center
ALUM	Aluminum	OC	Outside Diameter
ANCH	Anchor	OD	Outside Diameter
APPROX	Approximate	OF	Owner Furnished, Contractor Installed
ASSY	Assembly	OFCI	Owner Furnished & Installed(NIC)
AUTO	Automatic	OFI	Owner Furnished & Installed(NIC)
B.O.	Bottom Of	OH	Overhead
BD	Board	OPG	Opening
BIT	Bituminous	OPP	Opposite
BLK	Block	OR	Outer Radius
BLKG	Blocking	P	Plus or Minus
BM	Beam, Bench Mark	+/-	Plus or Minus
BOT or BTM	Bottom	P/C	Poured Concrete
C	Center to Center	PART	Partition
C/C or OC	Center to Center	PART BD	Partic Board
CAB	Cabinet	PASS	Passage
CER	Ceramic	PEMB	Pre-Engineered Metal Building
CF	Cubit Feet	PERF	Perforated
CFI	Contractor Furnished & Installed	PERIM	Perimeter
CHAN	Channel	PERP	Perpendicular
CIP	Cast in Place	PF CMU	Prefaced Conc. Mas. Unit
CJ	Control Joint	PH	Phase
CLG	Ceiling	PLAM	Plastic Laminate
CLO	Closet	PLAS	Plaster
CLR	Clear	PLUMB	Plumbing
CMU	Concrete Masonry Unit	PLYWD	Plywood
COL	Column	POL	Polished
CONC	Concrete	POLY	Polycarbonate Sheet
COND	Condition, Condenser, Condensate	CARB	Carbon
CONST	Construction	PR	Pair
CONT	Continuous	PREFAB	Prefabricated
CONTR	Contractor	PROJ	Project, Projected
CSG	CASING	PT	Point, Pressure Treated
CTSK	Countersink	PVC	Polyvinyl Chloride
CW	Cold Water, Clockwise	PVMT	Pavement
D	Double	R	Riser, Radius
DBL	Double	R or RAD	Radius
DEP	Depressed	REBAR	Reinforcing Bar
DET	Detail	REF	Reference, Refer
DIA	Diameter	REFR	Refrigerator
DM	Dimension	REINF	Reinforce, Reinforced, Reinforcing
DN	Down	REQD or	Required
DS	Downspout	REQD	Required
DWG(S)	Drawing(s)	RESIL	Resilient
E	Existing	RET	Retaining, Return
EA	Each	RH	Right-Hand
EJ	Expansion Joint	RO	Rough Opening
EL or ELEV	Elevation	S	Solid Core
ELEC	Electric, Electrical	SCHD	Schedule
EMERG	Emergency	SECT	Section
ENCL	Enclosure	SEP	Separate, Separation
EQ	Equal	SF	Square Feet, Split Face
EQUIP	Equipment	SHEATH	Sheathing
EQUIV	Equivalent	SHT	Sheet
ESMT	Easement	SIM	Similar
EXIST	Existing	SPEC	Specifications
EXP	Expansion	SQ	Square
EXT	Exterior	SS	Stainless Steel
F	Fabricate	STD	Standard
FAB	Fabricate	STL	Steel
FC	Fire Code	STOR	Storage
FDN	Foundation	STRUCT	Structural
FFE	Finished Floor Elevation	T	Tread, Thick
FH	Flat Head	T&G	Tongue & Groove
FIN	Finish, Finished	T.O.	Top of
FLASH	Flashing	T.O.M.	Top of Masonry
FLEX	Flexible	TDS	Turned Down Slab
FRT	Fire Retardant Treated	TEL	Telephone
FTG	Footing	TF	Top of Footing
FURR	Furring	TFE	Top of Footing Elevation
FV	Field Verify	THK	Thick, Thickness
G	Gauge	THRESH	Threshold
GA	Galvanized	TOC	Top of Concrete
GALV	Galvanized	TOIL	Toilet
GEN	Generator	TOS	Top of Steel
GFI	Ground Fault Interrupt	TOW	Top of Wall
GL	Glass, Glazing	TPO	Thermoplastic Polyolefin
GLUE LAM	Glue-Laminated	TS	Structural Steel Tubing, Tack Strip
GND	Ground	TYP	Typical
GR	Grate	U	Underground
GST	Glazed Structural Tile	UG	Underwriters Laboratory
GYP	Gypsum	UNFIN	Unfinished
H	Hose Bib	UNO	Unless Noted Otherwise
HC	Hollow Core	V	Vapor Barrier
HD WD	Hardwood	VB	Vapor Barrier
HDR	Header	VCT	Vinyl-Composition Tile
HDWE	Hardware	VERT	Vertical
HM	Hollow Metal	VIF	Verify in Field
HORIZ	Horizontal	VTR	Vent Through Roof
HP	Horse Power	W	Wide
HT	Height	WND	Window
HTG	Heating	WWF	Welded Wire Fabric
HTR	Heater	X	X
HW	Hot Water, Hard White	Y	By
I	Insulated Concrete Form	YD	Yard
ICF	Insulated Concrete Form		
ID	Inside Diameter / Inside Dim		
IF	Inside Face		
IFA	Integrated Framing Assembly		
INSUL	Insulation		
INT	Interior		
INV	Invert		
J	Inner Radius		
JB	Junction Box		
JT	Joint		
JS	Joint		
K	Kentucky Building Code		
KBC	Kentucky Building Code		
L	Angle, Long		
LAM	Laminated		
LF	Light Fixture, Linear Feet		
LH	Left Hand		
LLV	Long Leg Vertical		
LOC	Location		
LOL	Laugh Out Loud		
LT	Light		
LTWT	Lightweight		
M	Metal Building Manufacturer		
M.B.M.	Metal Building Manufacturer		
MAS	Masonry		
MATL	Material		
MAX	Maximum		
MC	Miscellaneous Channel		
MECH	Mechanical		
MED	Medium, Medicine		
MFR	Manufacturer		
MIN	Minimum, minute		
MISC	Miscellaneous		
MPE	Mechanical, Plumbing, & Electrical		
MT	Mount		
MTD	Mounted		
MTG	Mounting		
MTL	Meta		
MULL	Mullion		

PROJECT GENERAL NOTES

- DO NOT SCALE DRAWINGS. WRITTEN DIMENSIONS TAKE PRECEDENCE OVER SCALED DIMENSIONS. ANY DISCREPANCIES SHALL BE BROUGHT TO THE ATTENTION OF THE ARCHITECT.
- THE TERM "FURNISH" MEANS TO SUPPLY AND DELIVER TO THE PROJECT SITE. "INSTALL" MEANS TO PLACE IN POSITION FOR SERVICE OR USE. "PROVIDE" MEANS TO FURNISH AND INSTALL.
- NOTES INDICATED AS N.I.C. (NOT IN CONTRACT) ARE SHOWN FOR COORDINATION PURPOSES ONLY.
- SEE STRUCTURAL DRAWINGS FOR TYPES, SIZE, LOCATION, CONNECTIONS, REINFORCEMENT AND STRUCTURAL COMPONENTS INDICATED.
- SEE STRUCTURAL DRAWINGS FOR LINTEL SCHEDULE, WHERE STEEL PLATES ARE A PART OF LINTEL'S. FACE OF LINTEL SHALL BE INSET 1/2" FROM FACE OF CMU. ALL RELIEF ANGLES AND EXPOSED COMPONENTS OF STEEL LINTELS AND SUPPORTS IN EXTERIOR WALLS SHALL BE GALVANIZED. ALL EXPOSED PORTIONS OF LINTELS AND SUPPORTS SHALL BE PAINTED. TYP.
- COLUMN LINES INDICATED ARE REFERENCE LINES ONLY AND MAY NOT INDICATE CENTER OF COLUMN. SEE ENLARGED PLANS / DETAILS AND STRUCTURAL DRAWINGS WHERE APPLICABLE.
- PROVIDE ADDITIONAL HEADERS AS REQUIRED TO ACCOMMODATE ELECTRICAL, HVAC AND PLUMBING PENETRATIONS.
- CONTACT BETWEEN DISSIMILAR METALS SHALL BE SEPARATED WITH BUTYL TAPE.
- FIRESTOPPING SHALL BE INSTALLED AT PENETRATIONS THROUGH SLABS AS REQUIRED TO MAINTAIN INDICATED FIRE RATING. FIRESTOPPING IS NOT REQUIRED AT SLAB PENETRATIONS WHICH ARE ENCLOSED WITHIN RATED SHAFT CONSTRUCTION.
- ALL PENETRATIONS IN FIRE RATED ASSEMBLIES SHALL BE FIRESTOPPED - USE THE MANUFACTURER'S UL TESTED ASSEMBLY FOR THE RATING OF THAT ASSEMBLY. RATED WALLS FILL VOIDS W/ FIRE SAFING AND PROVIDE BACKER ROD AND FIRE RATED SEALANT ON BOTH SIDES OF WALL.
- ALL GYPSUM BOARD SHALL BE TYPE "X" AT FIRE RATED CONSTRUCTION OR AS NOTED.
- MASONRY VENEER SHALL RETURN TO SHEATHING OR FRAMING AT WALL OPENINGS U.N.O.
- REFER TO FOUNDATION PLAN AND ELEVATIONS FOR CONTROL JOINTS IN CONCRETE AND MASONRY.
- BACKER ROD SHALL BE USED BEHIND ALL EXTERIOR SEALANT CONDITIONS (TYP.) WHERE SPECIFIC CONDITIONS DO NOT ALLOW BACKER ROD TO BE USED. A BOND BREAKER SHALL BE USED AT THE BACK OF THE JOINT.
- PAINTED ACCESS PANELS SHALL BE PROVIDED AND INSTALLED WHERE REQUIRED TO MAINTAIN CONCEALED ELEC. MECH. SYSTEMS AND ACCESS POINTS WHETHER OR NOT INDICATED ON THESE DRAWINGS. LOCATIONS SHALL BE APPROVED BY ARCHITECT.
- CORNER BEADS SHALL BE USED AT ALL GYPSUM BOARD OUTSIDE CORNERS. TYP. CASING BEADS SHALL BE USED AT ALL GYPSUM BOARD TERMINATIONS. TYP.
- BATT INSULATION SHALL BE MECHANICALLY FASTENED TO WALLS.
- PAINT ALL EXPOSED GAS PIPING TO PREVENT RUST - IF PIPING IS VISIBLE, ARCHITECT TO SELECT FINISH / COLOR.
- FLOOR FINISHING TRANSITIONS HAPPEN AT DOOR THRESHOLDS U.N.O.
- CONCEALED FRT WOOD BLOCKING SHALL BE PROVIDED AS REQUIRED BY MANUFACTURER OR INSTALLER OF WALL-MOUNTED EQUIPMENT OR FURNISHINGS.
- ALL WOOD BLOCKING, NAILERS AND PLYWOOD SHALL BE FIRE RETARDANT TREATED (FRT), EXCEPT AT COPINGS WHERE BLOCKING SHALL BE PRESSURE TREATED (PT).
- ALL FRT WOOD FRAMING AND/OR BLOCKING IN CONTACT W/ CONCRETE AND/OR MASONRY SHALL ALSO BE PT.
- SEPARATE PT WOOD FROM METALS W/ BUILDING FELT TAPE OR APPROVED METHOD. ANCHORS IN PT WOOD SHALL BE STAINLESS STEEL OR HOT-DIPPED GALVANIZED G-90.
- THE LOCATION OF ALL HVAC, ELEC. & PLUMBING COMPONENTS (I.E. DUCTWORK, ELEC. SERVICE TUBS, TOILETS) SHALL BE COORDINATED PRIOR TO THE PLACEMENT OF CONC. SLABS, PLANKS & FLOOR JOISTS.
- LABELLED ITEMS ARE NEW, (N), UNLESS LABELED AS EXISTING, (E), OR U.N.O. (E) PORTIONS OF THE BUILDING MAY NOT BE LABELED OR DETAILED, (E) AREAS SHOWN FOR REFERENCE ONLY.
- IF (E) CONDITIONS VARY FROM THOSE SHOWN ON DRAWINGS, BRING TO THE ATTENTION OF ARCHITECT BEFORE PROCEEDING. INFORMATION COMPILED FROM FIELD MEASUREMENTS AND ORIGINAL CONSTRUCTION DOCUMENTS SUPPLIED BY THE OWNER.
- THE CONTRACTOR SHALL FIELD VERIFY (E) DIMENSIONS, ELEVATIONS AND ALL CONDITIONS RELATED TO (N) WORK.
- (E) PAINTED SURFACES IN AREAS OF (N) WORK SHALL BE CLEANED AND PAINTED U.N.O. COLORS TO BE SELECTED BY ARCHITECT.
- CONTRACTOR SHALL BE RESPONSIBLE FOR ALL PATCHING AND REPAIRING DUE TO DEMOLITION AND/OR REMOVAL OF ITEMS TO CREATE A FLUSH, SMOOTH SURFACE PROPERLY PREPARED TO RECEIVE (N) FINISHES AS SCHEDULED. CONTRACTOR SHALL SOAP IN (N) CMU OR BRICK TO MATCH (E) ADJACENT AREAS WHERE REQUIRED.
- IN AREAS OF DEMOLISHING OR REMOVAL, CAUSE AND/OR RE-ROUTE EXISTING UTILITIES AS REQUIRED FOR COMPLETE, FUNCTIONING AND FINISHED PROJECT. CONTRACTOR TO COORDINATE UTILITY DEACTIVATION, SWITCH OVER AND ACTIVATION WITH OWNER / ARCHITECT PRIOR TO DEMOLITION.
- THE CONTRACTOR SHALL BE RESPONSIBLE FOR ANY DAMAGE TO (E) ITEMS TO REMAIN CAUSED BY THE DEMOLITION, WORK OR WEATHER EXPOSURE. FIRE RATED ASSEMBLIES AND STRUCTURAL SYSTEMS TO REMAIN COMPLETE AND INTACT. PATCH/REPAIR/REPLACE IN AREAS OF WORK TO PROVIDE COMPLETE FINISHED SURFACES.
- CONTRACTOR IS RESPONSIBLE FOR PHASING / SCHEDULING OF WORK WITH EXISTING BUILDING AND SERVICES - COORDINATE W/ OWNER & ARCHITECT PRIOR TO CONSTRUCTION.
- THE BUILDING OWNER IS RESPONSIBLE FOR IDENTIFYING WORK PLACE HAZARDS AND HAZARDOUS MATERIALS PRIOR TO CONSTRUCTION, RENOVATION, OR DEMOLITION. INTEGRITY / ARCHITECTURE ASSUMES NO LIABILITY, EXPRESSES OR IMPLIES NO OR ANY WARRANTY OR GUARANTEE, AS TO THE COMPLETENESS OF THE OWNERS OR ITS CONSULTANTS DUE DILIGENCE TO IDENTIFY WORK PLACE HAZARDS OR HAZARDOUS MATERIALS THAT MAY BE ENCOUNTERED DURING THE CONTRACTORS SCOPE OF WORK.
- DETAILS SHOWN ARE TYPICAL. SIMILAR DETAILS APPLY IN SIMILAR CONDITIONS. IF CONDITIONS ARISE THAT ARE NOT COVERED BY A TYPICAL DETAIL, THE CONTRACTOR SHALL CONTACT THE ARCHITECT FOR CLARIFICATION BEFORE PROCEEDING.
- PROVIDE MECHANICAL, PLUMBING, ELECTRICAL (INCLUDING EXIT SIGNS AND EMERGENCY LIGHTING) AND FIRE PROTECTION ITEMS FOR EACH ROOM/SPACE AS REQUIRED PER CODE AND OWNER REQUIREMENTS.

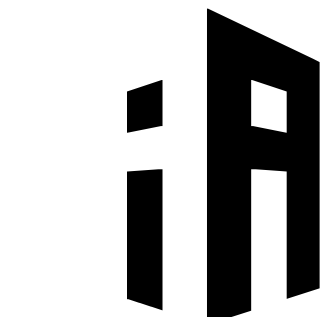

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PROJECT NAME

HENRY CLAY HS
SOFTBALL FIELD
HOUSE

PROJECT ADDRESS

2100 Fontaine Rd, Lexington,
KY 40502

SHEET NAME

COVER SHEET &
PROJECT NOTES

PROJECT NO.

2220

DATE


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REVISIONS


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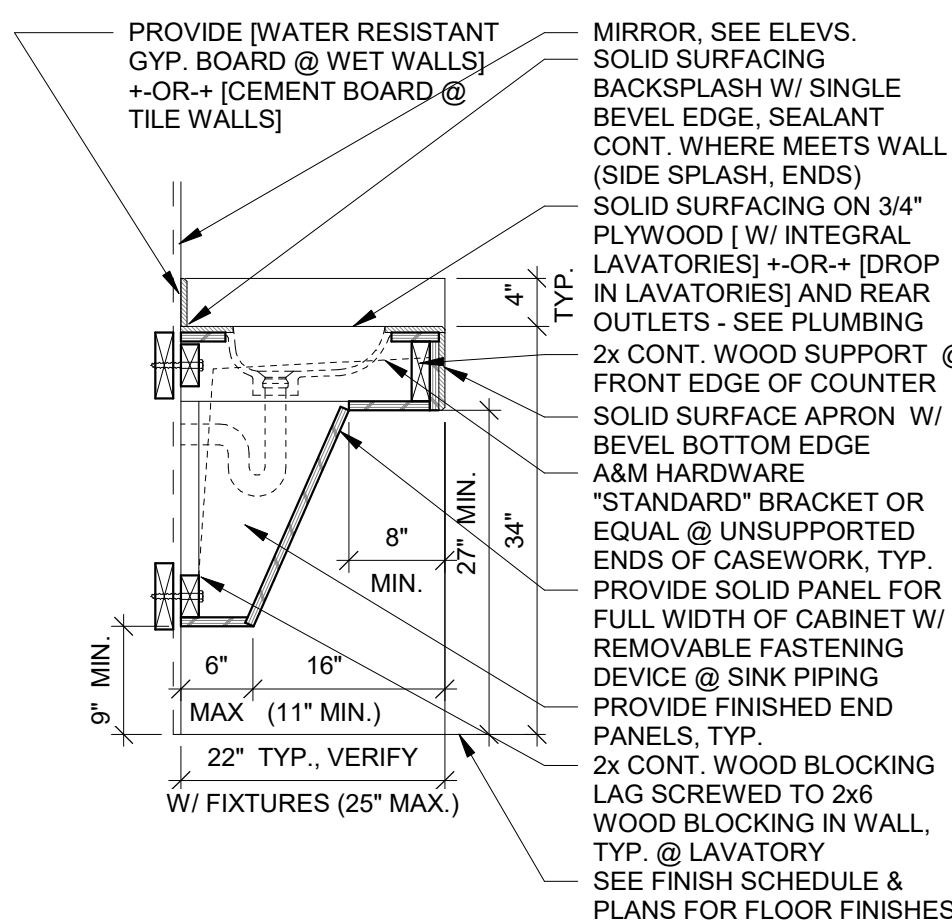
A0.0



1 FIRST FLOOR LEVEL
1/4" = 1'-0"

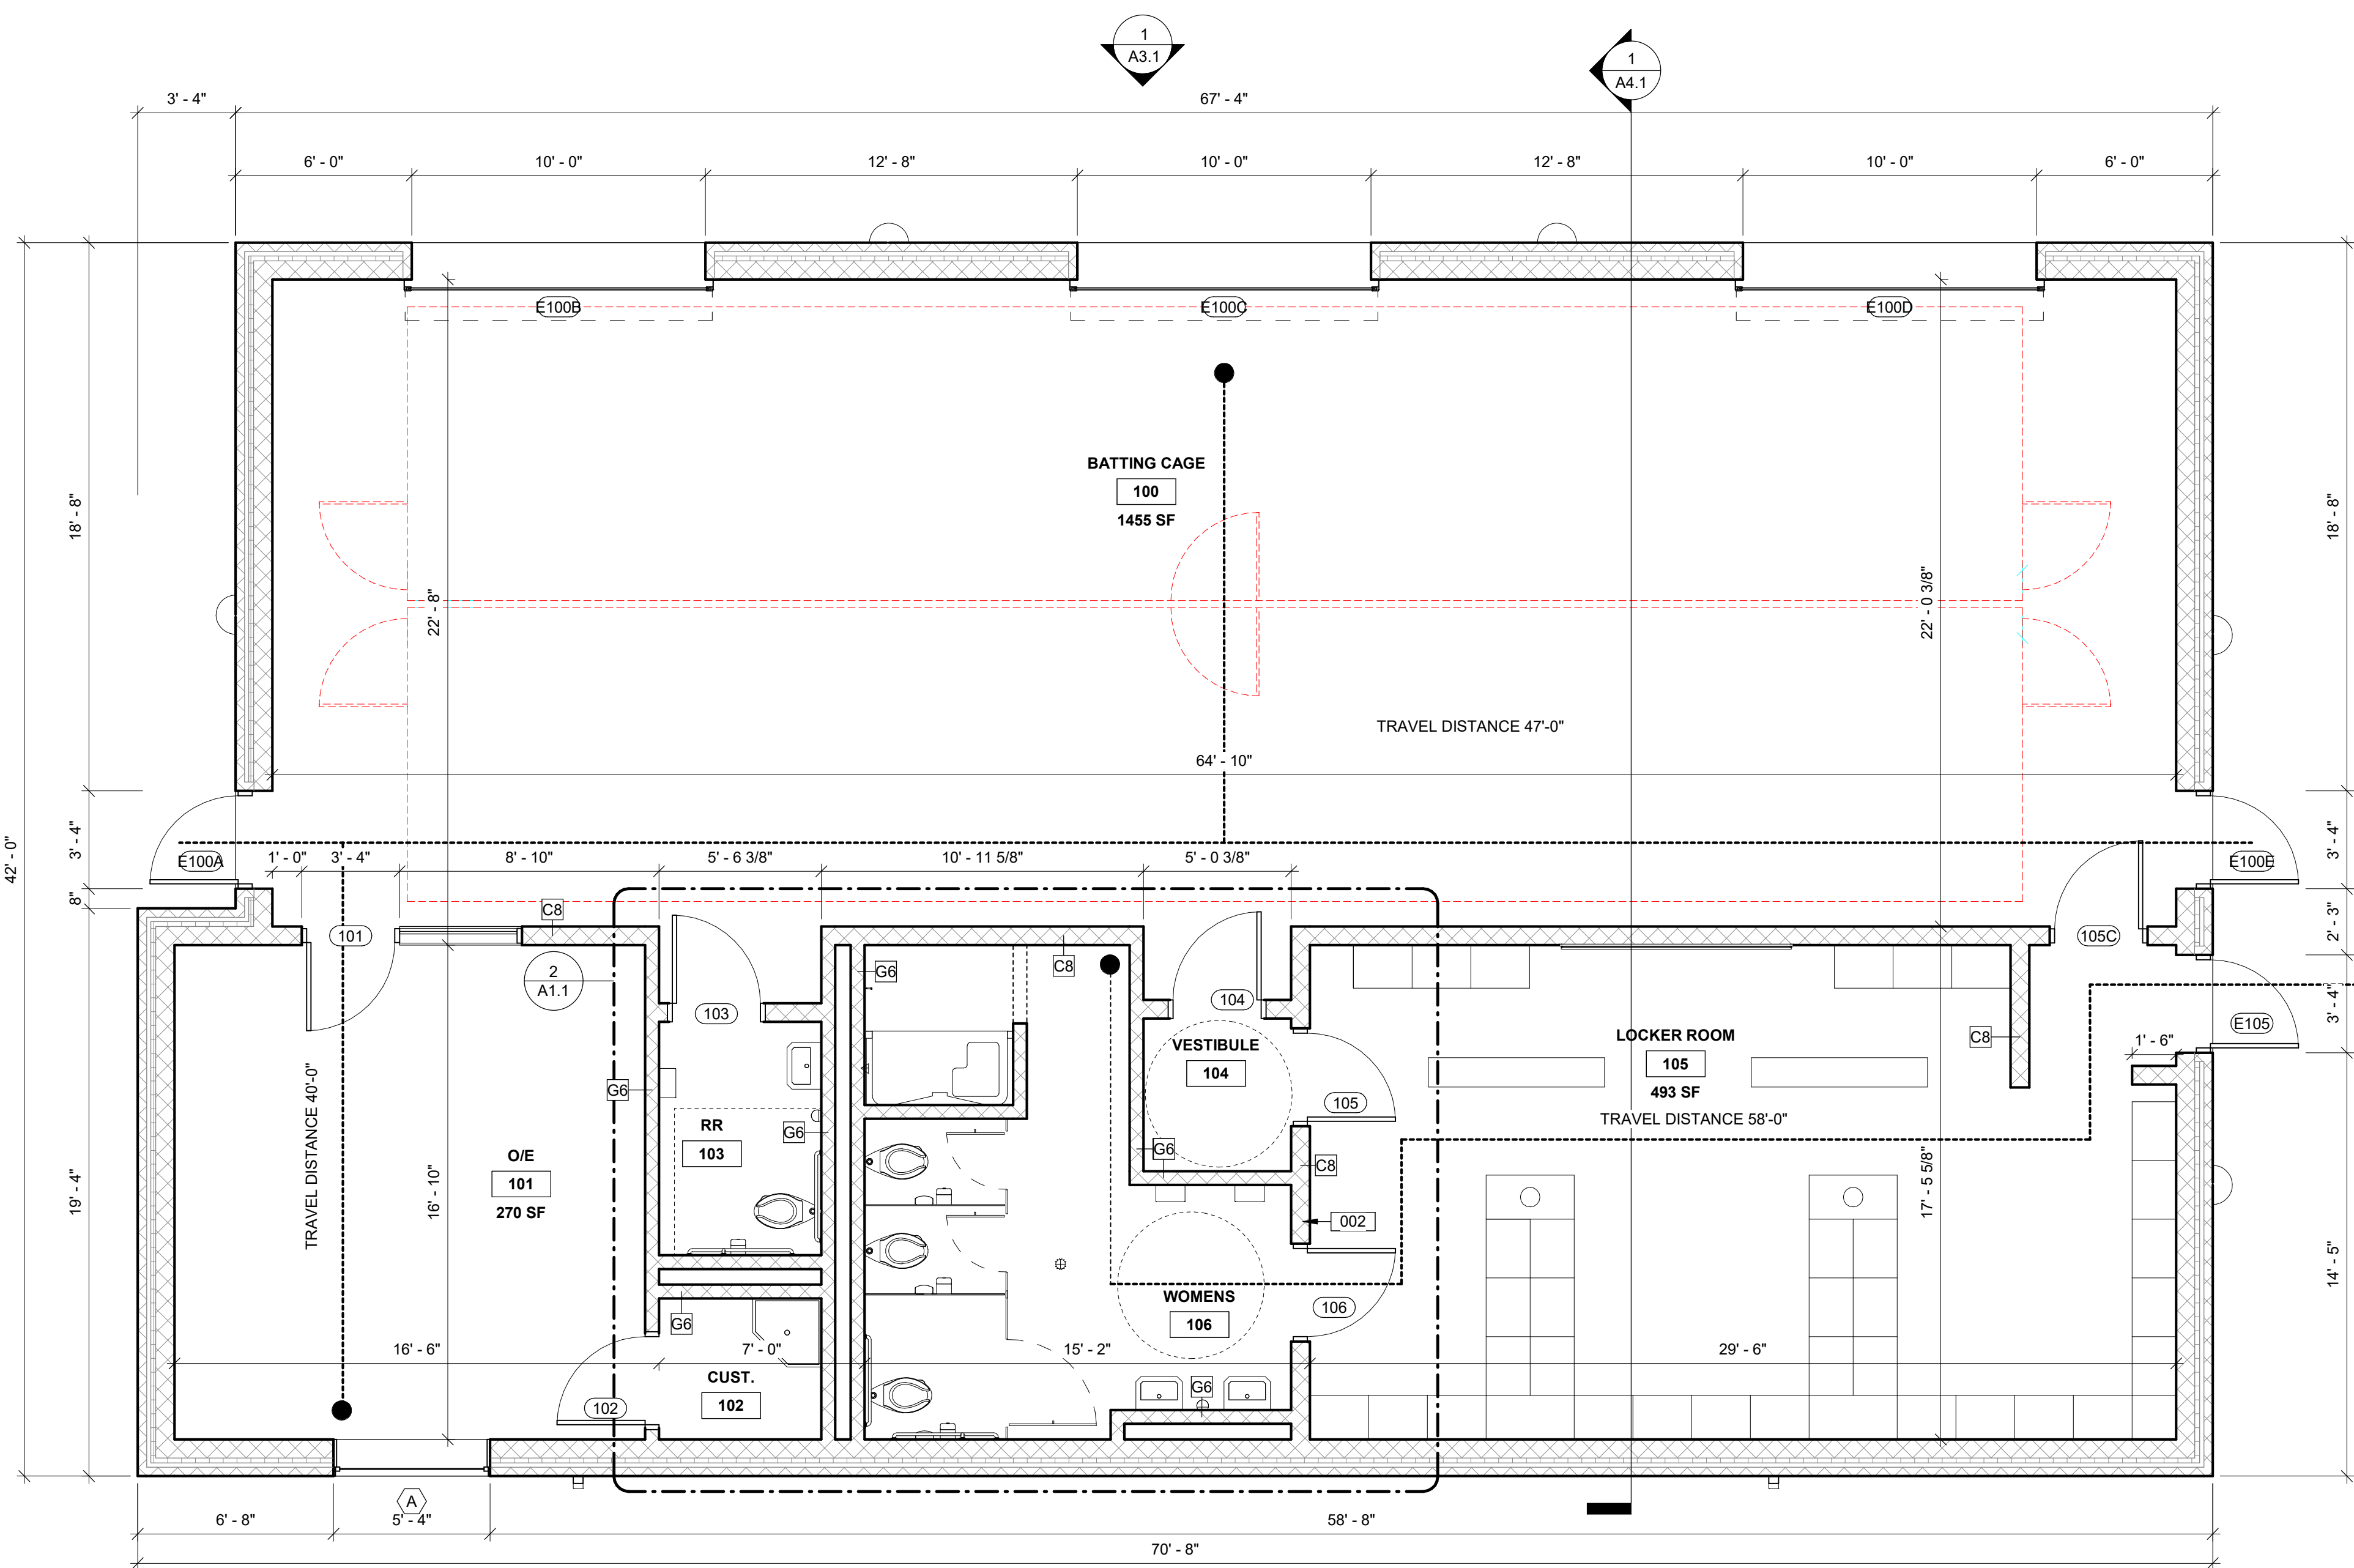

2 RR 106 ENLARGED PLAN
3/8" = 1'-0"

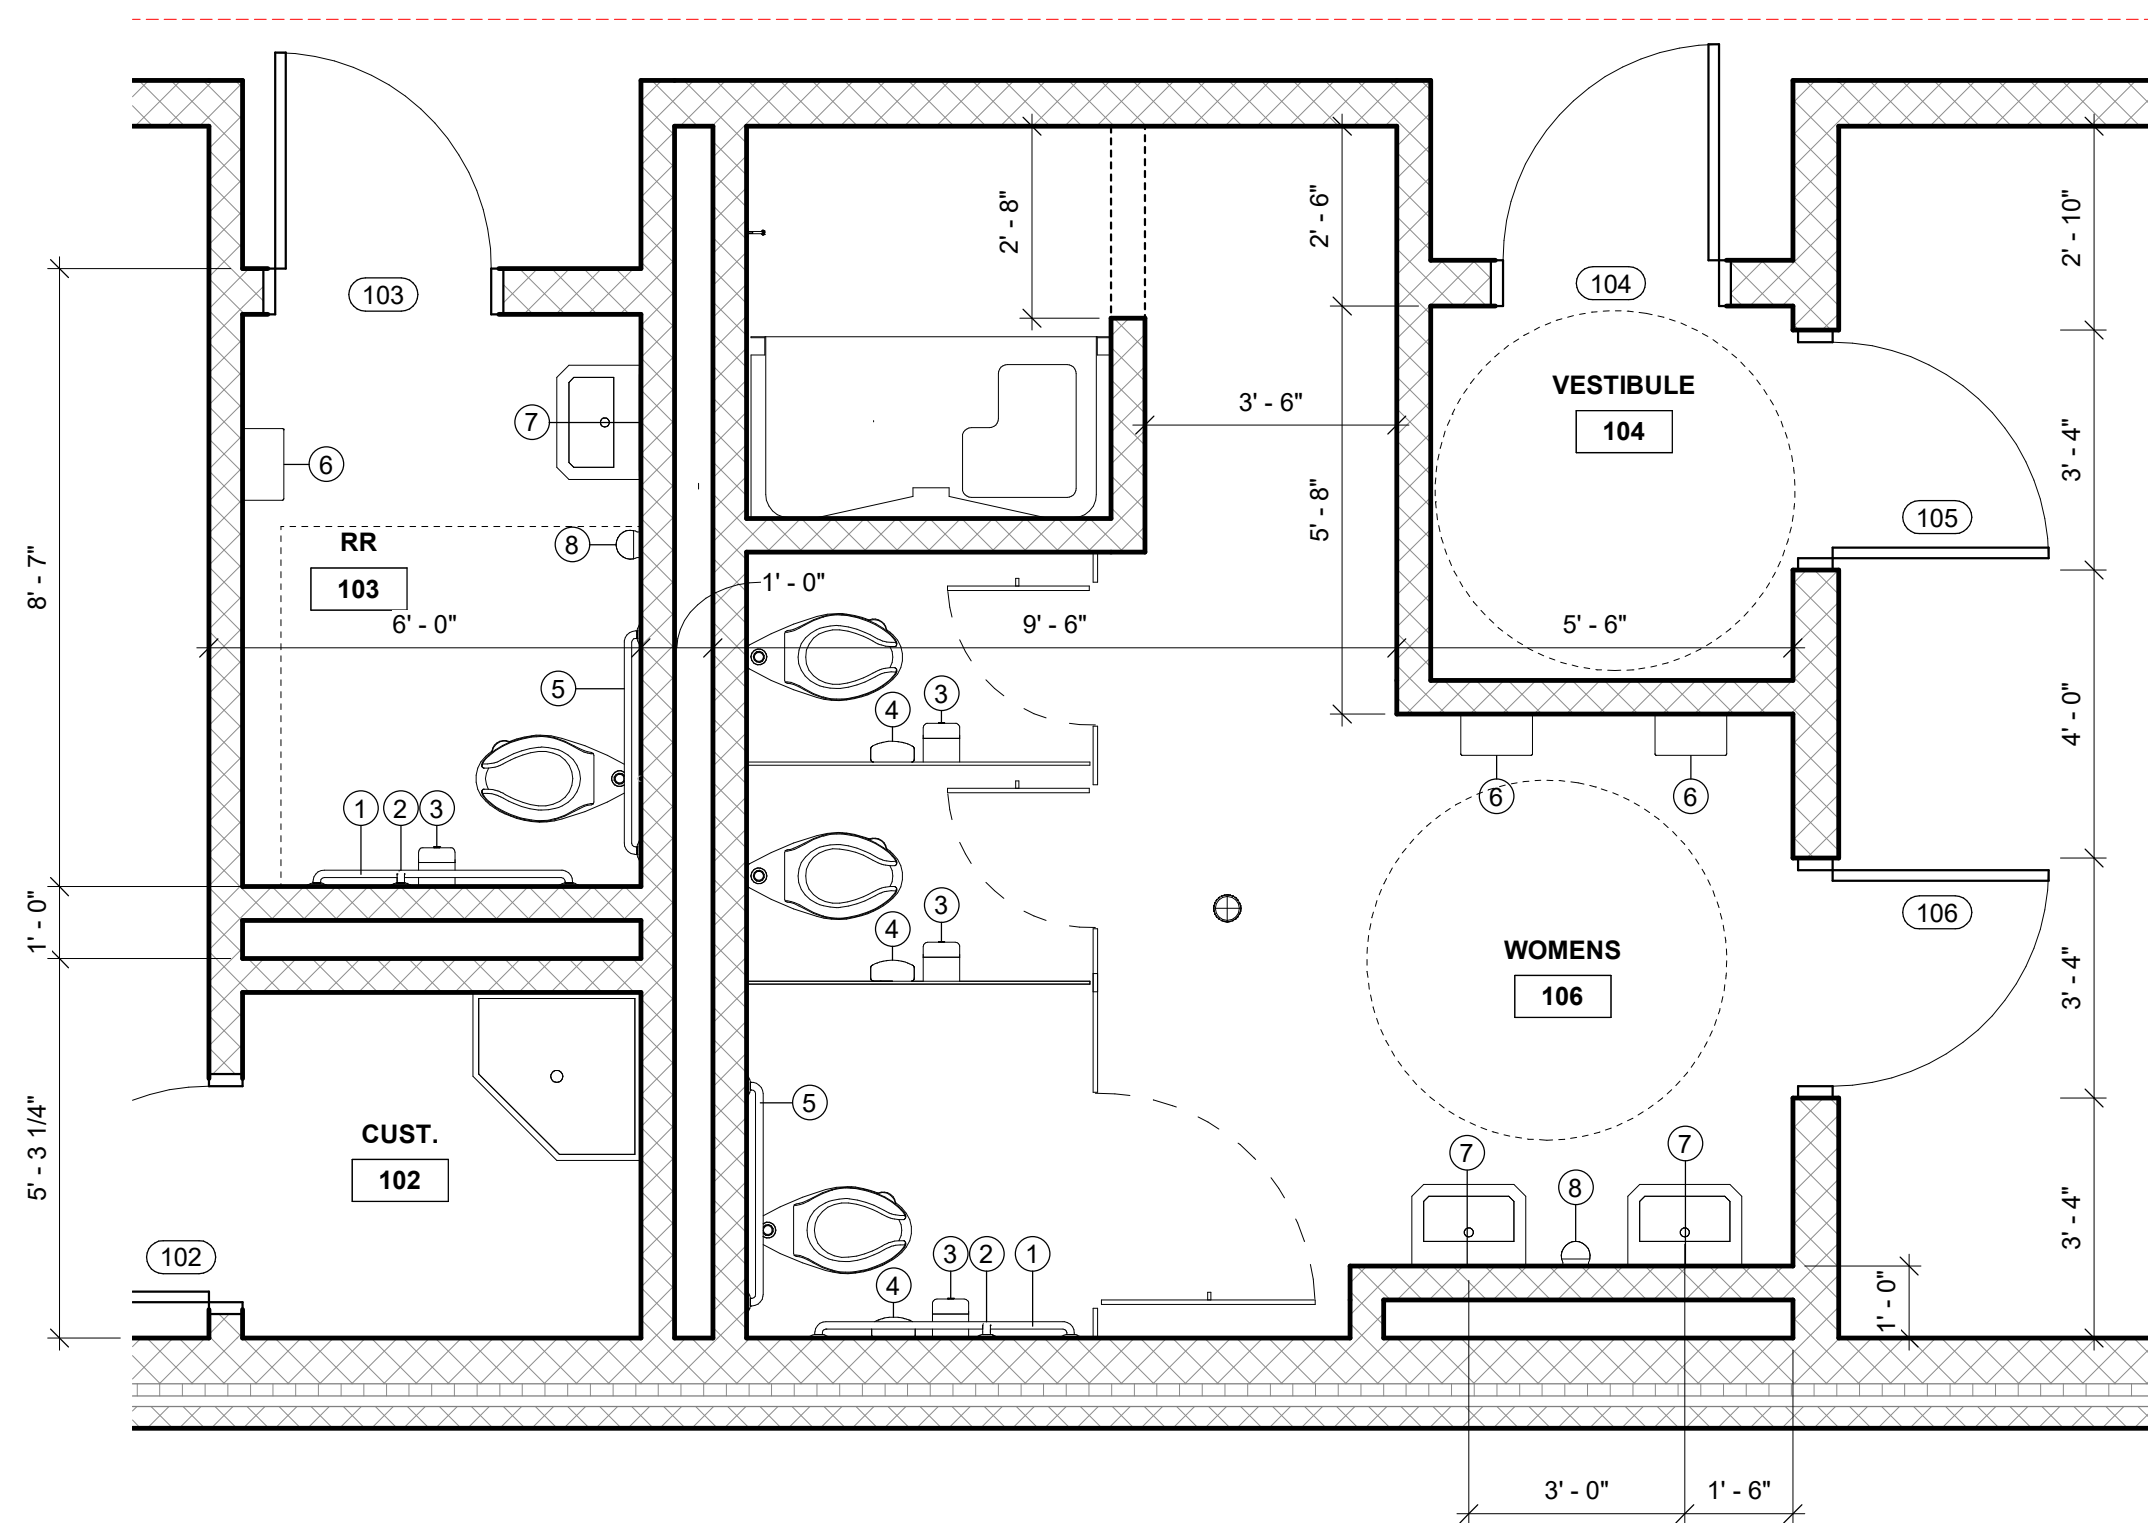

3 CASEWORK SECTION - LAVATORY
3/4" = 1'-0"

CODE COMPLIANCE DATA

APPLICABLE BUILDING CODE: IBC 2015 (WITH 2018 KY AMENDMENTS)

OCCUPANCY CLASSIFICATION (CHS KBC): E (EDUCATIONAL)

ACTUAL FLOOR BUILDING AREA: FIRST FLOOR = 2,604 SF

ACTUAL BUILDING HEIGHT: 1 STORY, 18'-0"

ALLOWABLE HEIGHT: 1 STORY, 40'-0"

MAX ALLOWABLE AREA PER FL: 9,500 SF

CONSTRUCTION TYPE: 5B

FIRE PROTECTION: NONE

MAX ALLOWABLE TRAVEL DISTANCE (PER KBC TABLE 1017.2): 200 FT

MAX COMMON PATH OF EGRESS TRAVEL (PER KBC TABLE 1006.2.1): 75 FT

ACTUAL MAXIMUM TRAVEL DISTANCE: 58 FT

MINIMUM FIRE RESISTANCE RATINGS (PER KBC TABLE 601.1.6/602):

PRIMARY STRUCTURAL FRAME	0HR
EXTERIOR BEARING WALLS	0HR
EXTERIOR WALLS W/ FIRE SEPARATION DISTANCE >10'	0HR
INTERIOR BEARING WALLS	0HR
INTERIOR NONBEARING WALLS & PARTITIONS	0HR
FLOOR CONSTRUCTION & SECONDARY MEMBERS	0HR
ROOF/CEILING CONSTRUCTION & SECONDARY MEMBERS	0HR

DESIGN OCCUPANT LOAD FACTORS (PER KBC TABLE 1004.1.2):

A ASSEMBLY (UNCONCENTRATED)	15 NET SF / PERSON
B MERCANTILE	60 GROSS SF / PERSON
C PARKING GARAGE	200 GROSS SF / PERSON
D RESIDENTIAL	200 GROSS SF / PERSON
E MECH. EQUIPMENT/STORAGE AREA	300 GROSS SF / PERSON

GENERAL NOTES:

OWNER IS RESPONSIBLE FOR CONFIRMING ALL SPECIAL INSPECTIONS. OWNER SHALL PROVIDE ALL DOCUMENTATION REQUIRED PER CODE.

THESE FACILITIES MUST BE DESIGNED TO COMPLY WITH ALL APPLICABLE REQUIREMENTS OF THE AMERICANS WITH DISABILITIES ACT. ALL SIGNAGE SHALL MEET REQUIREMENTS OF ADAAG OF THE AMERICANS WITH DISABILITIES ACT (ADA).

ITEMS INSTALLED IN FIRE SEPARATION PARTITIONS AND OTHER FIRE RESISTANT CONSTRUCTION SHALL BE INSTALLED WITH PROPER LABELING FOR THE RATED ASSEMBLY. ALL PENETRATIONS SHALL BE FIRE STOPPED / FIRE BLOCKED AS REQUIRED BY CODE WITH AN APPROVED UL METHOD AND MATERIALS.

FLOOR PLAN GENERAL NOTES

- SEE PROJECT GENERAL NOTES ON A0.1 FOR MORE INFO.
- THE FOLLOWING NOTES ARE TYPICAL FOR ALL FLOOR PLANS IN THIS SET. NOT ALL NOTES MAY APPLY TO THIS SHEET. SEE ENLARGED PLANS FOR NOTES OF ENLARGED AREAS.
- DIMENSIONS ARE TO FACE OF STUD OR MASONRY U.N.O. EXTERIOR WALLS ON FLOORS ABOVE ALIGN WITH WALLS BELOW U.N.O. STAIR DIMENSIONS ARE TO NOSE OF TREAD/RISER U.N.O. SEE STRUCTURAL FOR FOUNDATION WALL DIMS. - EXTERIOR WALL ASSEMBLIES VARY.
- DOOR / WINDOW OPENINGS IN STUD WALLS SHALL BEGIN 6" FROM NEAREST WALL OR CENTERED ON WALL U.N.O. FIELD VERIFY LOCATIONS TO RECEIVE MILLWORK. SEE DOOR SCHEDULE FOR MORE INFO.
- EXTERIOR WINDOWS & DOORS DIMENSIONED TO OUTSIDE EDGE OF FRAME OR MASONRY OPENING (WHERE OCCURS), CONTRACTOR TO COORDINATE R.O. WITH WINDOW MANUFACTURER.
- WINDOWS & DOORS SHOWN AS GENERIC UNITS, SEE SHEET A7.1 FOR MORE INFORMATION.
- SEE CIVIL DRAWINGS FOR EXTERIOR HARDSCAPE AND SITE INFORMATION.
- SEE PLUMBING FOR PLUMBING FIXTURE INFORMATION.
- SEE FINISH PLANS FOR FINISH TRANSITIONS & PAINT - COLORS TO BE SELECTED BY ARCHITECT U.N.O.
- SEE INTERIOR ELEVATIONS & DETAILS FOR CASEWORK.
- FURNITURE AND APPLIANCES SHOWN FOR COORDINATION PURPOSES ONLY U.N.O.

FLOOR PLAN KEYNOTES

- ROOM SIGNAGE [SEE SHEET A8.1 FOR DETAILS]. PROVIDE RESTROOM SIGNAGE PER CODE REQUIREMENTS.

SIGNAGE GENERAL NOTES

- CHARACTERS SHOWN ARE COMPUTER GENERATED. SPACING OF CHARACTERS MAY NOT BE ACCURATE. CORRECT "VISUAL" SPACING IS THE RESPONSIBILITY OF THE MANUFACTURER.
- PICTOGRAMS ARE SHOWN HEREIN FOR INFORMATION AND INTENT ONLY. MECHANICAL, CAMERA-READY ARTWORK SHALL BE SUPPLIED BY THE SIGNAGE CONTRACTOR.
- COLORS TO BE SELECTED BY ARCHITECT
- SIGNS TO BE MOUNTED BESIDE DOORS AT 4'-6" A.F.F. TO CENTER OF SIGN AND 2" FROM EDGE OF DOOR FRAME ON THE STRIKE SIDE U.N.O. THE ARCHITECT SHALL BE CONSULTED BEFORE PLACEMENT OF SIGNAGE FOR LEFTHAND AND RIGHTHAND ORIENTATION OF SIGNS.
- * = THREE CHARACTER NUMBER TO BE COORDINATED BY SIGN MFR WITH OWNER.
- ALL SIGNAGE SHALL MEET REQUIREMENTS OF ADAAG OF THE AMERICANS WITH DISABILITIES ACT (ADA).
- SIGNS MOUNTED ON GLAZING TO HAVE A MATCHING BLANK ON THE OPPOSITE SIDE OF GLAZING.
- MESSAGE (COPY) TO BE DETERMINED BY OWNER.
- SEE SPECIFICATIONS FOR MORE INFO.

FIXTURE/ACCESS. GEN.NOTES

- PROVIDE SOLID FIRE RETARDANT TREATED WOOD BLOCKING AS REQUIRED FOR SUPPORT OF FIXTURES AND ACCESSORIES IN STUD PARTITIONS. MAINTAIN PROPER FIRE RATING WHERE MOUNTED IN / ON RATED WALLS.
- EXPOSED WATER SUPPLY AND DRAINPIPS UNDER SINKS AND LAVATORIES SHALL BE INSULATED AND COVERED WITH A RIGID JACKET TO PROTECT AGAINST CONTACT. THERE SHALL BE NO SHARP OR ABRASIVE SURFACES UNDER LAVATORIES AND SINKS.
- ALL ITEMS SHALL BE MOUNTED TO SPECIFIC POINTS ABOVE FINISH FLOOR SURFACES, LOCATED HORIZONTALLY, AND MAINTAIN CLEARANCES IN ACCORDANCE WITH ALL APPLICABLE REQUIREMENTS OF THE AMERICANS WITH DISABILITIES ACT (ADA) AND KBC CHAPTER 11 (ACCESSIBILITY).
- ALL TOILET PARTITIONS AND DOORS SHALL BE SOLID PHENOLIC U.N.O. MINIMUM 3/4" THICK PANELS ON ALL WALLS, DOORS AND DIVIDER PANELS. FLOOR MOUNTED WITH OVERHEAD BRACED TOP RAILS U.N.O. COLOR TO BE SELECTED BY ARCHITECT. 36" WIDE ACCESSIBLE STALL DOORS, 34" WIDE AMBULATORY STALL DOORS, 24" WIDE STANDARD STALL DOORS TYP. 12" A.F.F. TO BOTTOM U.N.O. CONTRACTOR TO PROVIDE BLOCKING AS REQUIRED FOR PARTITION INSTALLATION.
- TOILET ROOM ACCESSORIES SHALL BE ASI OR AS NOTED AND REPRESENT THE LEVEL OF QUALITY REQUIRED.
- SEE MECHANICAL, PLUMBING AND ELECTRICAL DRAWINGS AND SPECIFICATIONS FOR ALL REQUIREMENTS PERTAINING TO PLUMBING FIXTURES AND CONTROLS.
- SEE FIXTURE/ACCESSORY MOUNTING & ACCESSIBLE FLOOR SPACES DIAGRAM FOR ADDITIONAL MOUNTING AND LAYOUT DIMENSION INFORMATION.
- SEE FLOOR PLANS FOR INFORMATION NOT SHOWN. SEE FINISH SCHEDULE FOR FLOOR, BASE & WALL FINISHES.
- ALL ITEMS ARE (N) U.N.O.

GENERAL SYMBOLS

- WALL TYPE, SEE A0.1
- SHEET KEYNOTES
- ROOM NUMBER, SEE FLOOR PLANS
- WINDOW TYPE, SEE A7.1
- DOOR TYPE, SEE A7.1
- PLUMBING/ACCESSORY TYPE, SEE A2.1
- BID ALTERNATE, SEE A0.0
- BUILDING ELEVATION, SEE A3.1-A3.2
- BUILDING OR WALL SECTION, SEE A4.1-A4.3
- DETAIL OR ENLARGED PLAN
- INTERIOR ELEVATION, SEE A10.1
- ELEVATION MARK


WALL FIRE RATING DESIGNATION: SEE A0.2 & SECTIONS FOR RATED CONST. LOCATIONS & UL ASSEMBLIES

- SP - SMOKE PARTITION
- FP1 - 1 HOUR FIRE RATING (FP = FIRE PARTITION)
- FB2 - 2 HOUR FIRE RATING (FB = FIRE BARRIER)
- FW3 - 3 HOUR FIRE RATING (FW = FIRE WALL)


FIXTURE / ACCESSORY SCHEDULE

NO.	ACCESSORY	MOUNTING HEIGHTS (U.N.O.)	MANUF. / MODEL NO.
1	42" GRAB BAR (SURFACE MOUNTED)	SEE MOUNTING DIAGRAM(S)	BOBRICK B-6806 90X42
2	18" VERTICAL GRAB BAR (SURFACE MOUNTED)	SEE MOUNTING DIAGRAM(S)	BOBRICK B-6806 90X18
3	TISSUE DISPENSER (SURFACE MOUNTED)	26" A.F.F. TO BOTTOM	ASI 20030
4	SANITARY WASTE RECEPTACLE (SURFACE MOUNTED)	24" A.F.F. TO TOP	ASI 20852
5	36" GRAB BAR (SURFACE MOUNTED)	SEE MOUNTING DIAGRAM(S)	BOBRICK B-6806 90X36
6	ELECTRIC HAND DRYER	PER ADA & MANUF. INSTRUCTIONS	XLERATOR XL-SB-ECO
7	PLATE GLASS MIRROR W/ STAINLESS STEEL FRAME	SEE MOUNTING DIAGRAM(S)	ASI 20650-1830
8	SOAP DISPENSER (WALL MOUNTED)	48" A.F.F. TO BOTTOM	ASI 0362

FIXTURE / ACCESSORY MOUNTING (ALL CLEAR DIMS U.N.O.)

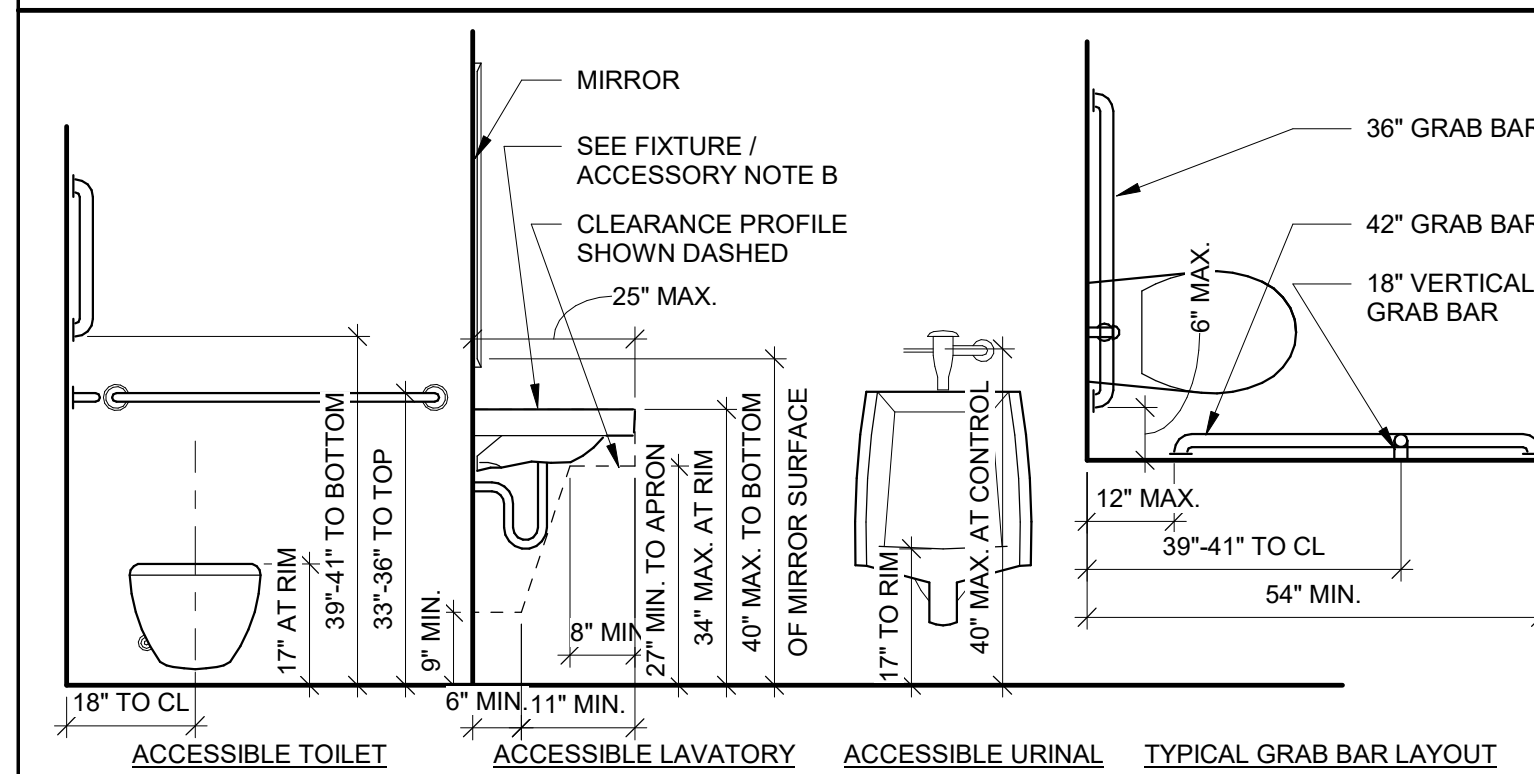


ACCESSIBLE FLOOR SPACES (ALL CLEAR DIMS U.N.O.)

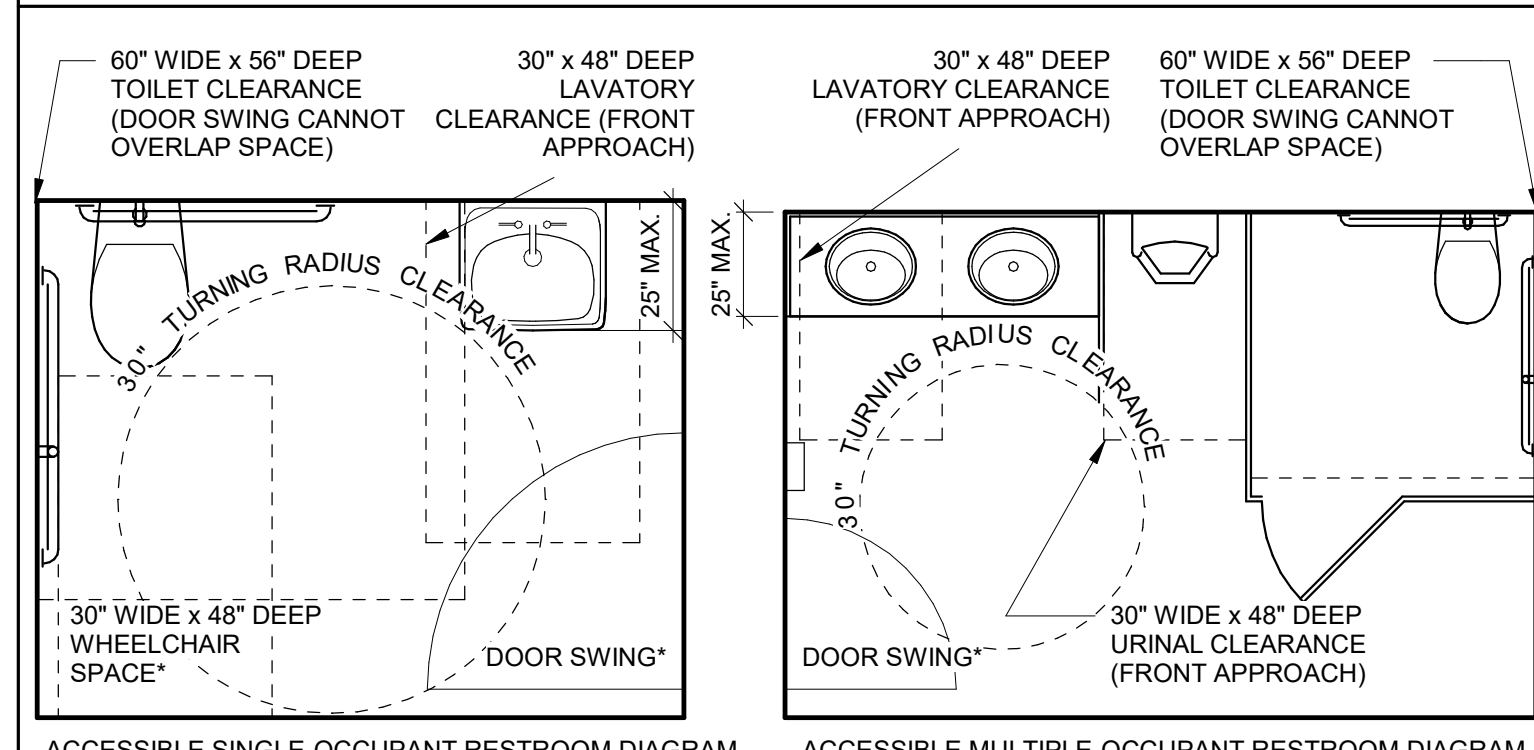


NOTES: TURNING & FIXTURE FLOOR CLEARANCES MAY OVERLAP EACH OTHER, BUT FIXTURES CANNOT OVERLAP ADJACENT FIXTURE FLOOR CLEARANCES PER ICC A117.1 §604.3.3.


*DOOR SWING CANNOT OVERLAP FIXTURE FLOOR CLEARANCES EXCEPT IN A SINGLE-OCCUPANT RESTROOM WHERE A 30"x48" CLEAR WHEELCHAIR SPACE IS PROVIDED OUTSIDE OF SWING AREA PER ICC A117.1 §603.2.2. DOOR SWING MAY OVERLAP TURNING CLEARANCES UNLESS NOTED OTHERWISE PER ICC A117.1 §304.4.

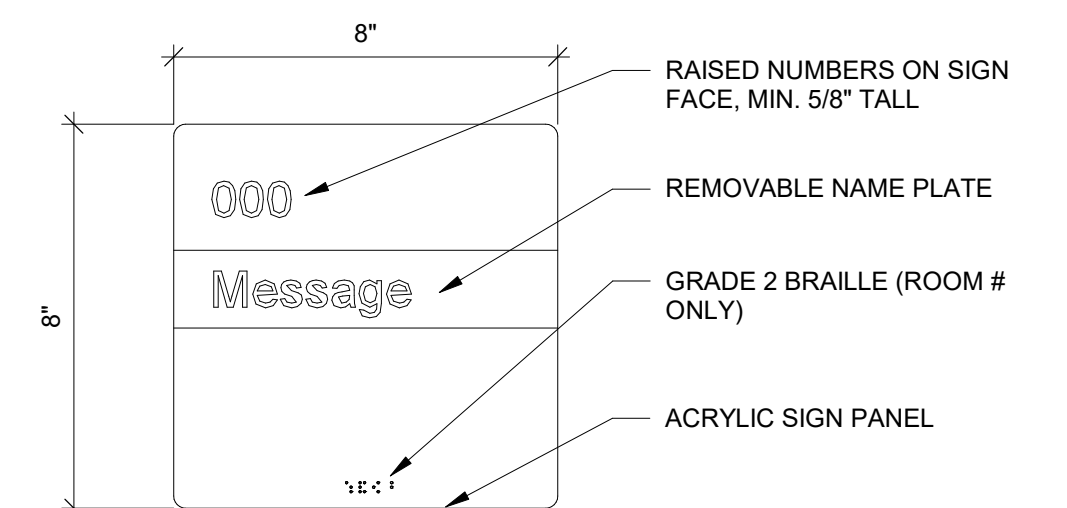


TYPICAL ROOM SIGN

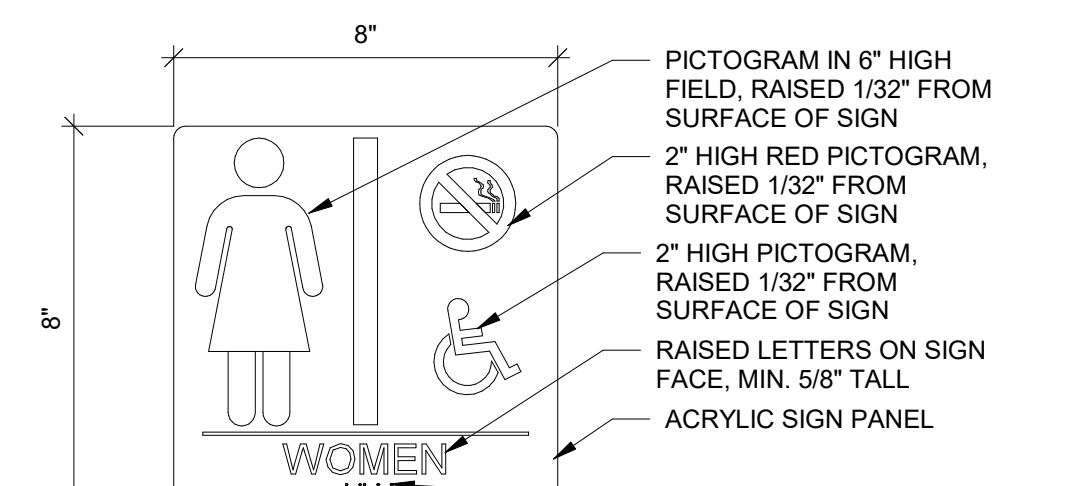


WOMEN'S RESTROOM SIGN

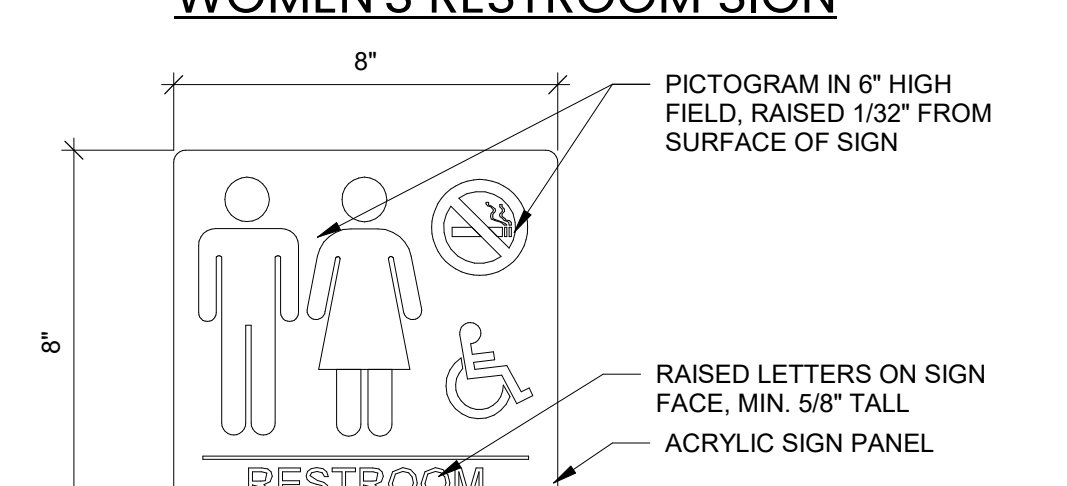

RESTROOM SIGN (UNISEX & FAMILY)

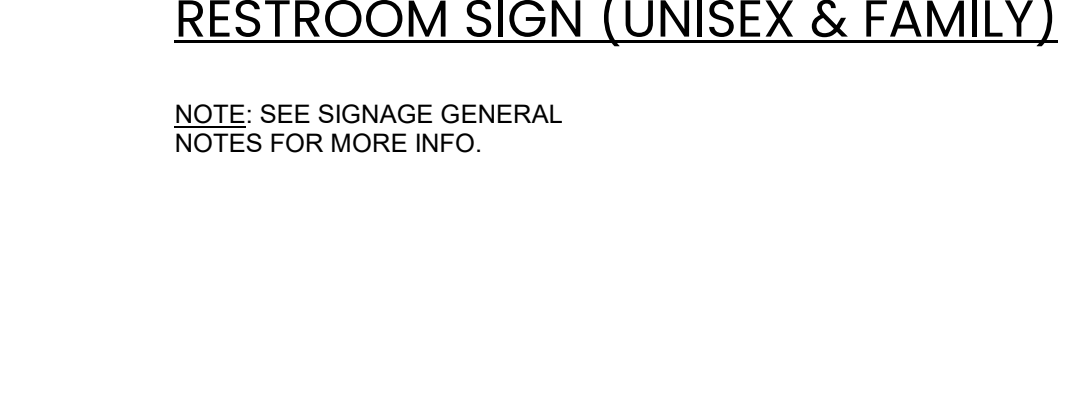

NOTE: SEE SIGNAGE GENERAL NOTES FOR MORE INFO.

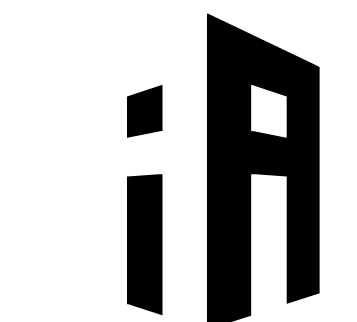

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SOFTBALL FIELD
HOUSE

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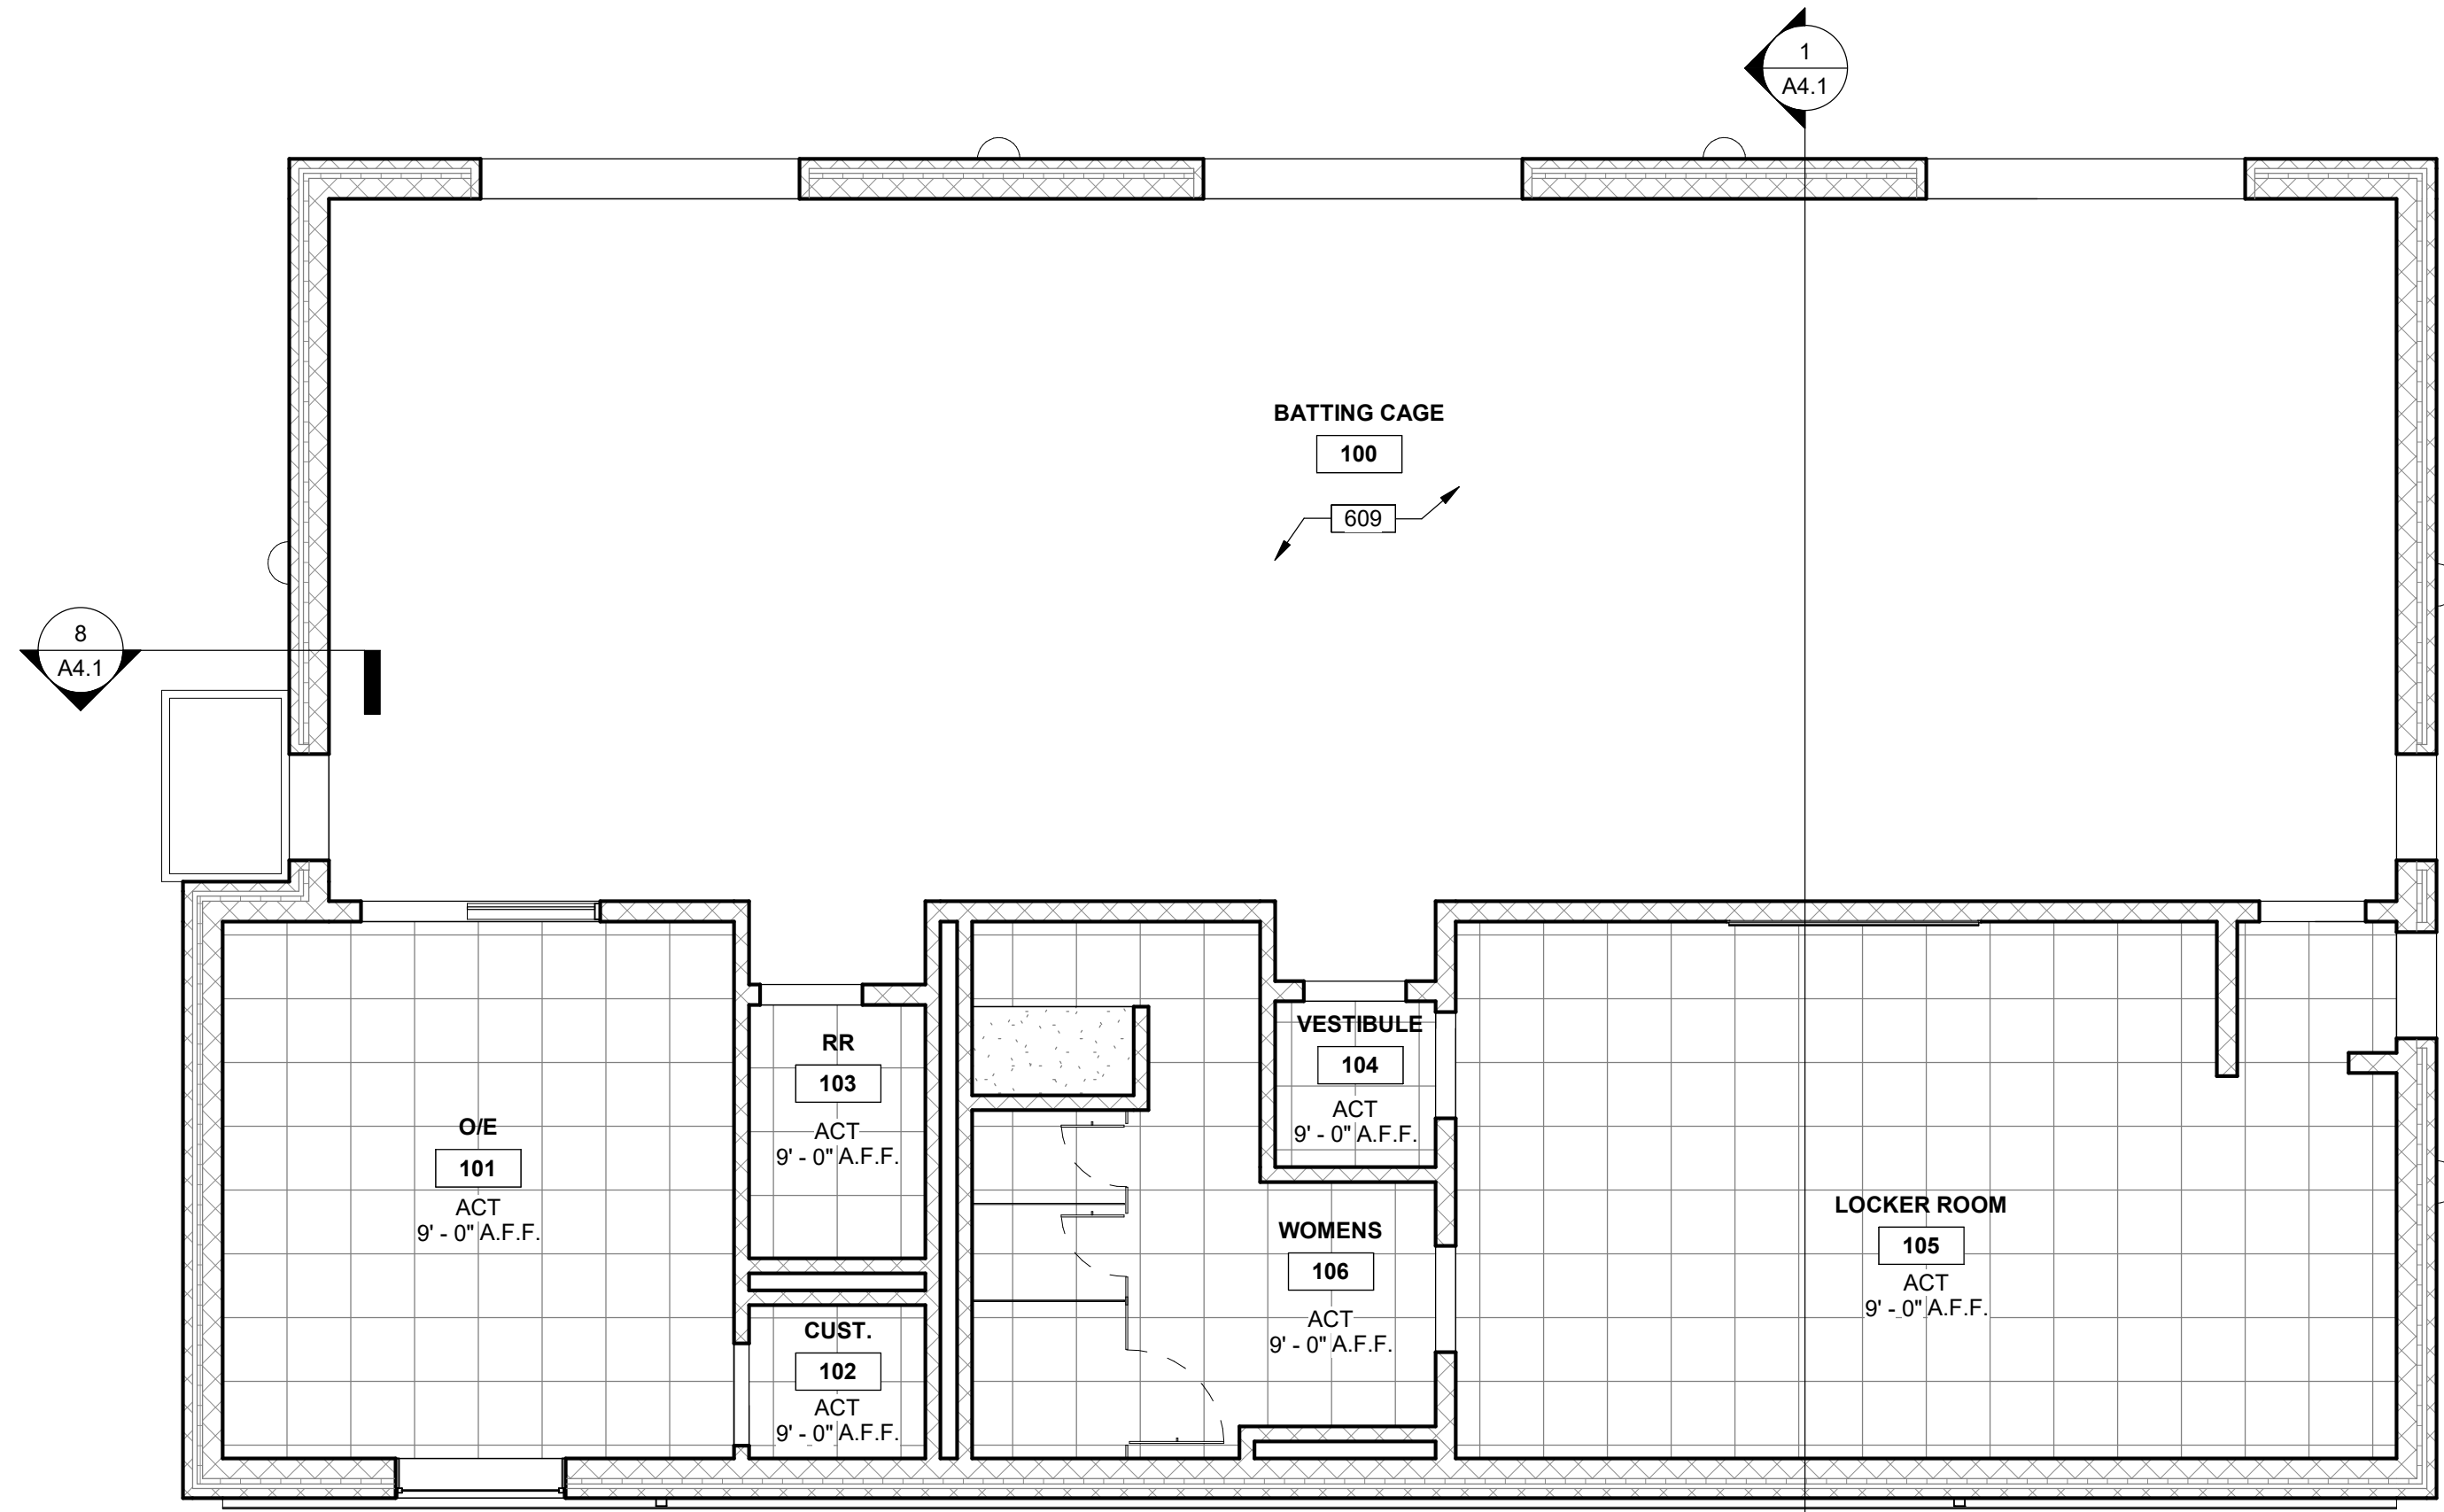
SHEET NAME
FLOOR PLAN

PROJECT NO. 2220
DATE Mon DD, YYYY
REVISIONS


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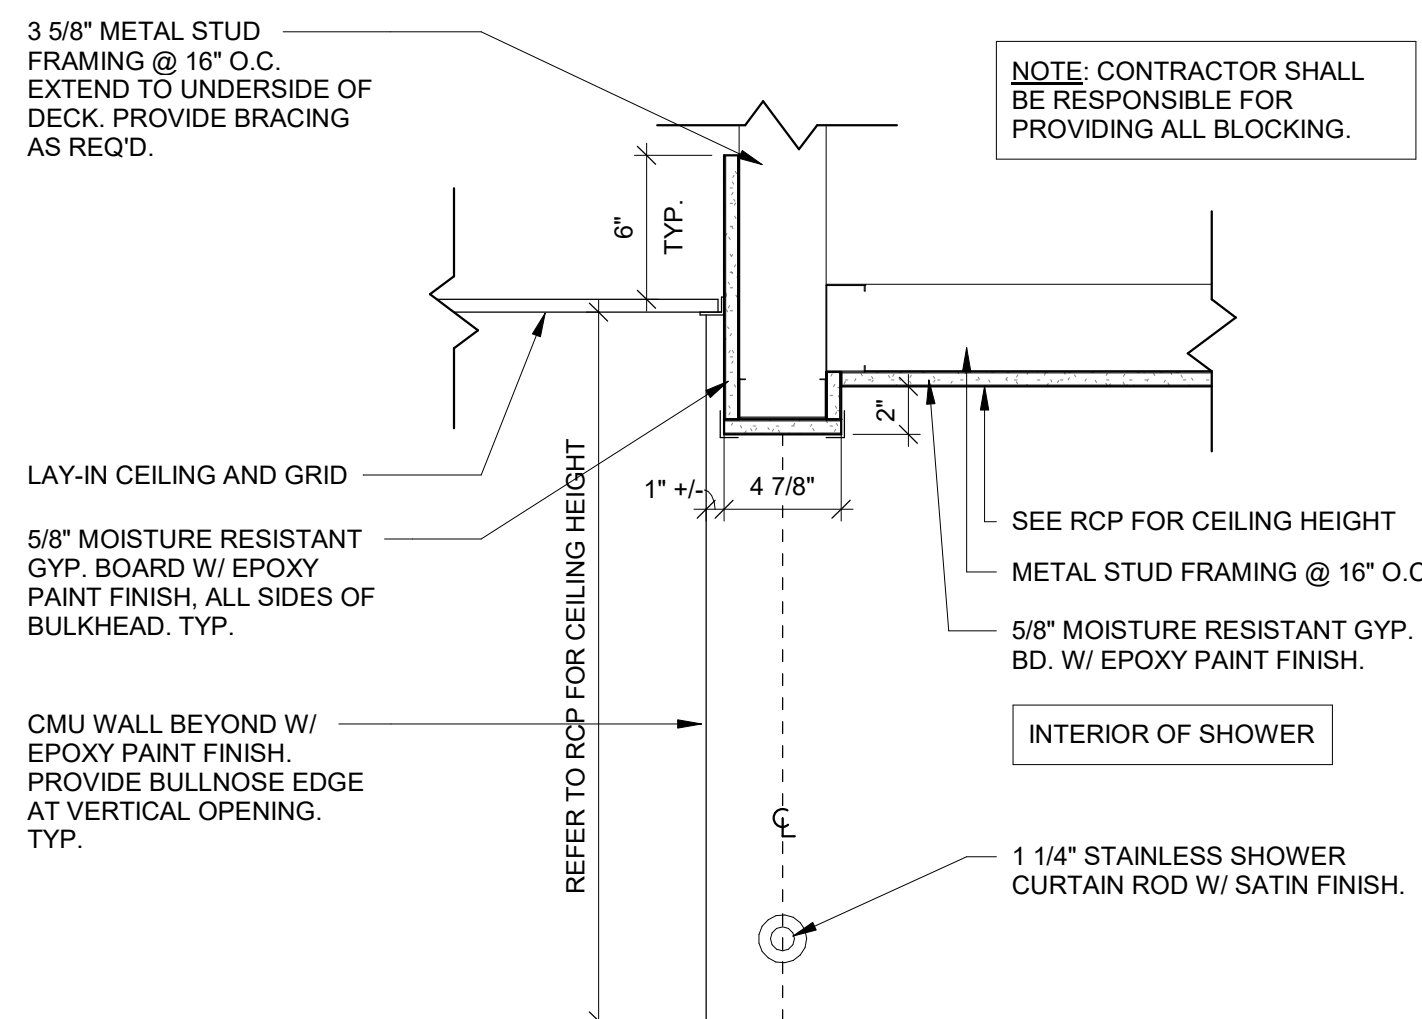
A1.1




1 FIRST FLOOR LEVEL REFLECTED CEILING PLAN
3/16" = 1'-0"




2 ROOF PLAN
3/16" = 1'-0"

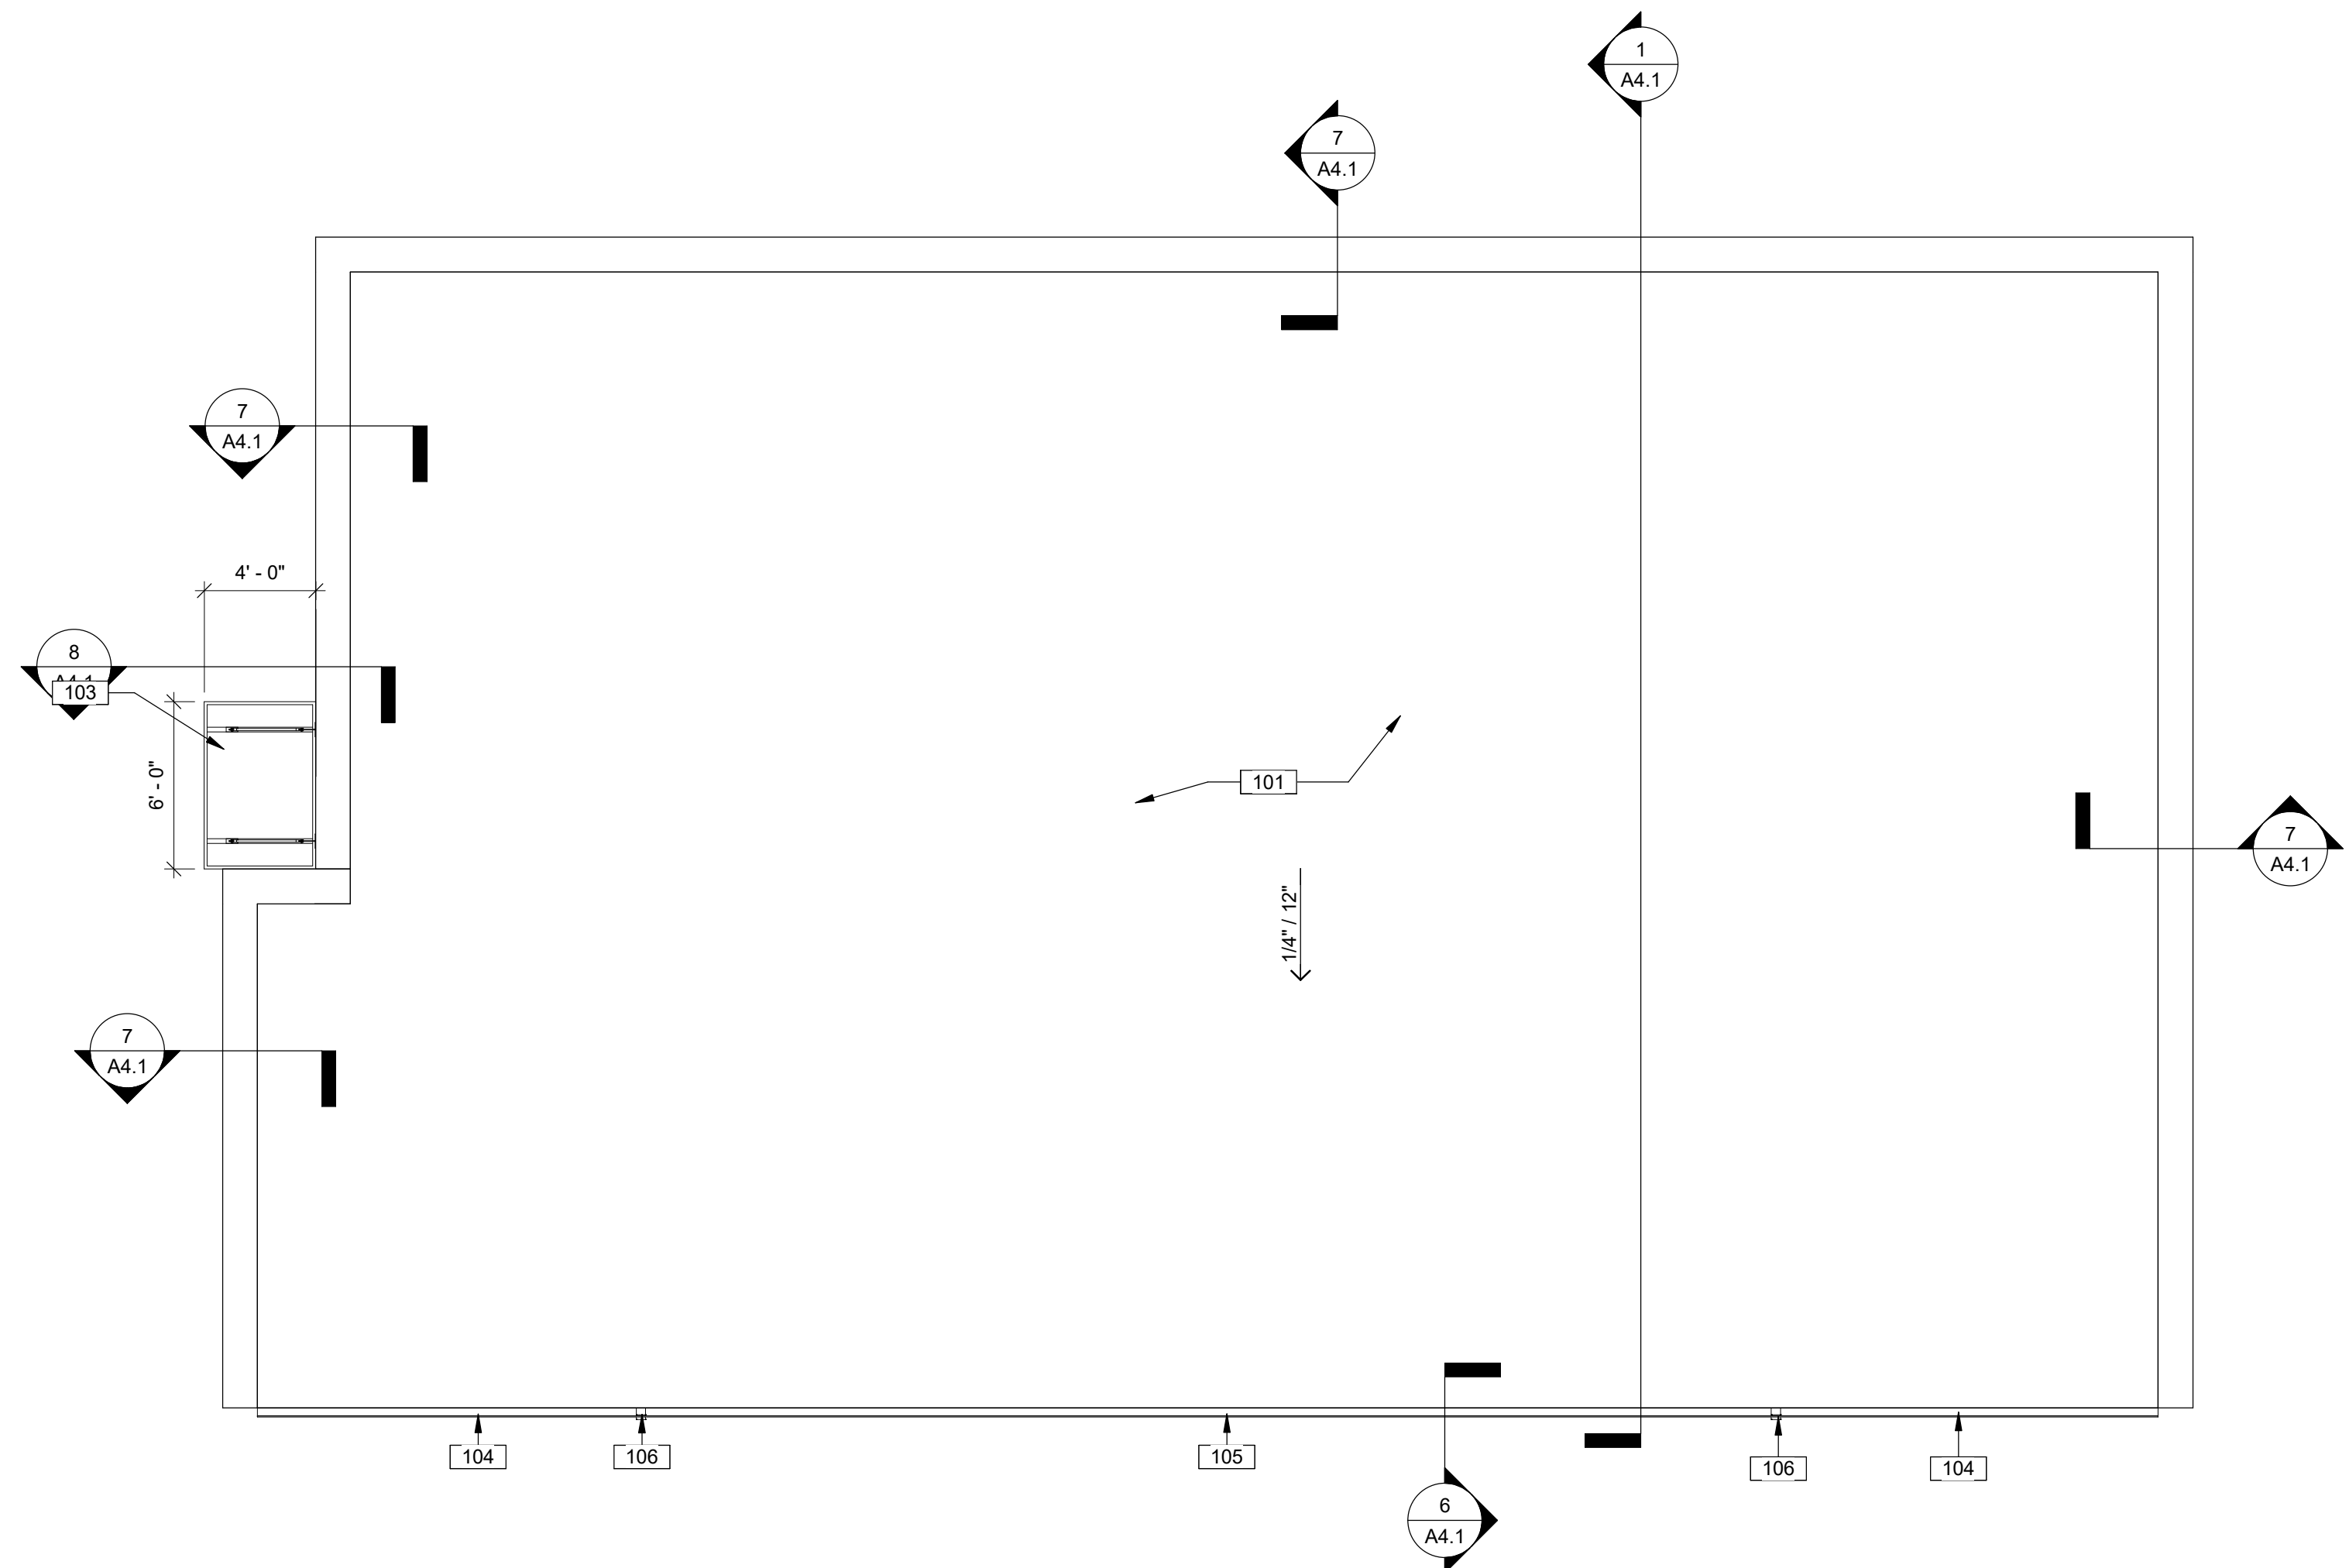


3 TYP. GYPSUM BULKHEAD
1 1/2" = 1'-0"

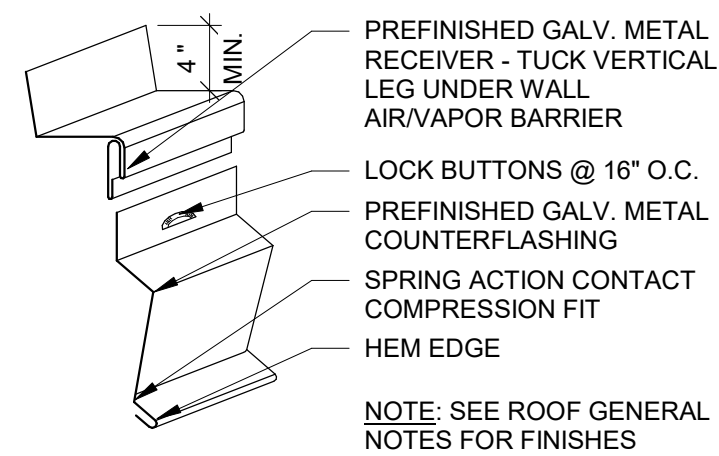


4 TYP. COUNTERFLASHING
1 1/2" = 1'-0"

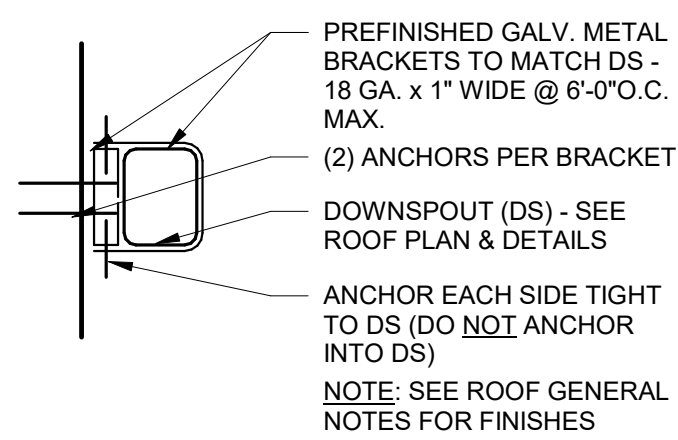

6 TYP. DS BRACKET
1 1/2" = 1'-0"

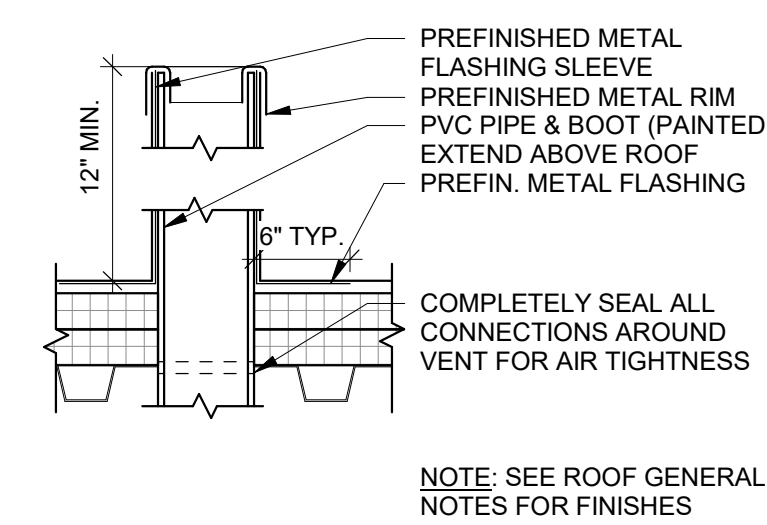

5 TYP. VENT THRU FLAT ROOF
1 1/2" = 1'-0"

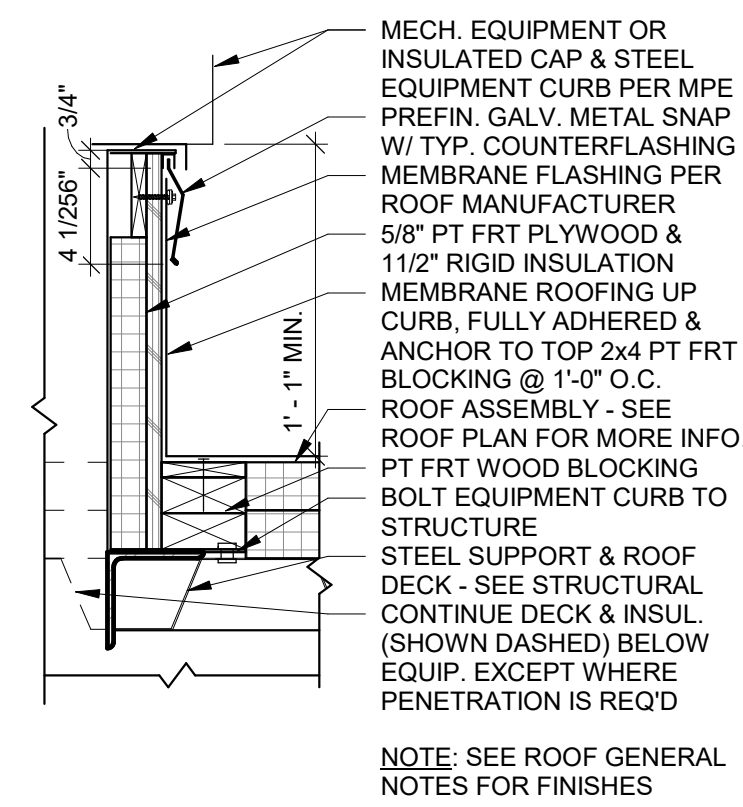

7 TYP. MECH EQUIPMENT CURB
1 1/2" = 1'-0"

RCP GENERAL NOTES

- SEE FLOOR PLANS AND PARTITION TYPES FOR EXTENT OF GYPSUM BOARD ABOVE FINISHED CEILING.
- FINISHED VERTICAL FACES OF SOFFITS AND BULKHEADS SHALL ALIGN W/ FINISHED VERTICAL FACES OF ADJACENT PARTITIONS WHERE APPLICABLE U.N.O.
- CEILING GRIDS OR PANELS ARE CENTERED ON THE PRIMARY SPACE, ROOM OR CORRIDOR AS INDICATED U.N.O. BY DIMENSION OR ALIGNMENT W/ WALL OR SOFFIT.
- PROVIDE HOLD-DOWN CLIPS FOR CEILING PANELS AT COMMERCIAL KITCHEN AREAS AND WITHIN 10'-0" OF AN EXTERIOR DOOR.
- SEE WALL SECTIONS AND OTHER DETAILS FOR CEILING CONDITIONS AND ADDITIONAL REQUIREMENTS AT EXTERIOR WALLS OF BUILDING OR SPECIFIC LOCATION NOT INDICATED ON REFERENCED TYPICAL DETAILS.
- GYPSUM BOARD CONTROL JOINTS SHALL BE PROVIDED AS INDICATED ON DRAWINGS AND AT 30'-0" MAX. INTERVALS, AT EACH CHANGE OF DIRECTION, AND AS OTHERWISE REQUIRED BY SPECIFICATIONS OR INDUSTRY STANDARDS. COORDINATE LOCATIONS WITH ARCHITECT PRIOR TO INSTALLATION.
- VERTICAL STUD SOFFIT FRAMING SHALL EXTEND AND BE ANCHORED TO THE UNDERSIDE OF STRUCTURE OR FRAMING ATTACHED TO STRUCTURE, TYP. U.N.O.
- SEE MPEF PLANS FOR ITEMS NOT SHOWN ON ARCHITECTURAL REFLECTED CEILING PLANS (E.G.: SPEAKERS, EMERGENCY LIGHTING, EXT. LIGHTING, ETC.).
- WHERE LIGHTING, ELECTRICAL WIRING OR HVAC EQUIPMENT IS PRESENT IN AREAS OF ACCESS PANELS, CONTRACTOR TO COORDINATE SLACK IN WIRING AND DUCT WORK.
- CEILING HEIGHTS LISTED ABOVE FINISH FLOOR ASSUMED ELEVATION OF 0'-0" WHERE A SPACE HAS VARIED FINISHED FLOOR LEVELS. THE HEIGHT OF CEILING IS ABOVE THE HIGHEST FINISHED FLOOR ELEVATION IN THE SPACE. SEE SECTIONS AND FLOOR PLANS FOR VARIED FINISHED FLOOR LEVELS.

RCP KEYNOTES

- 609 PAINT EXPOSED CEILING - (SEE ROOM FINISH SCHEDULE FOR MORE INFO) --or-- (INCLUDES STRUCTURE, DECK, INSULATION, EQUIPMENT, DUCTWORK, PIPING, CONDUIT, ETC. U.N.O. PROTECT / DO NOT PAINT DATA LINES & SPRINKLER HEADS. COLOR SELECTED BY ARCHITECT).

ROOF PLAN GENERAL NOTES

- ROOFING SYSTEM SHALL INCLUDE ALL MATERIALS AND ASSEMBLIES AS REQUIRED TO ACHIEVE THE MANUFACTURER'S SPECIFIED WARRANTY FOR A WEATHERPROOF AND WATERTIGHT SYSTEM. MATERIALS AND ASSEMBLIES REQUIRED BY THE MANUFACTURER MAY INCLUDE, BUT ARE NOT LIMITED TO, MISC. FLASHING, VAPOR RETARDER, ROOF VENTING SYSTEMS, AND EXPANSION JOINT SYSTEMS.
- ROOF SLOPES SHALL CONFORM TO THE SPECIFIC SLOPES INDICATED. WHERE NO SPECIFIC SLOPES ARE INDICATED, SUCH SLOPES SHALL BE CONFIGURED TO PRODUCE THE GEOMETRY SHOWN, WITHOUT PONDING.
- GUTTERS AND DOWNSPOUTS SHALL BE CALCULATED BASED ON LOCAL RAINFALL AND AS REQUIRED BY LOCAL CODES AND JURISDICTION.
- CONTRACTOR TO COORDINATE INSTALLATION OF ROOFING / FLASHING W/ OTHER TRADES FOR ADDITIONAL WORK REQUIRED (E.G. FLASHING OF EQUIPMENT CURBS).
- SEE FLOOR PLANS, ELEVATIONS & SECTIONS FOR ADDITIONAL NOTES. SEE WALL SECTIONS & DETAILS FOR BEARING HEIGHTS.
- EXTERIOR SHEET METAL COPINGS, FLASHING AND TRIM SHALL BE PREFINISHED GALV. SHEET METAL U.N.O.
- ARCHITECT TO SELECT EXTERIOR FINISHES AND COLORS. PHYSICAL SAMPLES OF EXTERIOR FINISHES SHALL BE SUBMITTED SIMULTANEOUSLY TO COMPARE AND REVIEW ALL FINISHES TOGETHER U.N.O.
- NOT ALL PENETRATIONS, UTILITY LINES, VENTS AND EQUIPMENT MAY BE SHOWN ON ROOF PLAN. MAINTAIN MIN. 36" BETWEEN ALL ROOF PENETRATIONS AND ADJACENT EAVES, HIPs, VALLEYS AND RIDGES.

ROOF PLAN KEYNOTES

- FULLY-ADHERED SINGLE PLY REFLECTIVE WHITE TPO MEMBRANE ROOFING SYSTEM (60 mil THICKNESS, 20 YEAR WARRANTY, FIRESTONE ULTRAPLY BASIS OF DESIGN) ON (2) STAGGERED LAYERS OF 2" CONTINUOUS RIGID INSULATION (MIN. R-25) W/ SOLID FRT BLOCKING WHERE REQUIRED. SLOPE TO DRAIN. SEE WALL SECTIONS & STRUCTURAL FOR ROOF FRAMING & DECKING.
- PRE-ENGINEERED ALUMINUM CANOPY W/ INTEGRAL GUTTERS, SOFFIT PANELS, CONNECTIONS & HANGER RODS BY MANUF. (MAPES CANOPY SUPER LUMIDECK FLAT SOFFIT BASIS OF DESIGN) - SEE WALL SECTIONS & DETAILS. ALIGN HANGER RODS AS NOTED OR AS REQUIRED BY MANUF. U.N.O. DESIGN BY MANUFACTURER - SHOWN FOR COORDINATION PURPOSES ONLY. USE HOLLOW BOLT OR EQUIVALENT @ BLIND CONNECTIONS, TYP.
- PREFINISHED GALV. METAL GUTTER, 24 GA. U.N.O., CLOSE ENDS OF GUTTER SOLID - SEE DETAIL [777]. 1" GUTTER EXPANSION JOINT AT 45' MAX. SPACING OR REQUIRED BY MANUFACTURER, TYP. FOR REFERENCE ONLY - CONTRACTOR TO FIELD VERIFY ACTUAL LOCATIONS.
- PREFINISHED GALV. METAL DOWNSPOUT (DS) - CONTRACTOR TO FIELD VERIFY ACTUAL LOCATIONS. SEE CIVIL FOR CONTINUATION, SEE DETAIL [777] FOR ATTACHMENT.

GENERAL SYMBOLS

- WALL TYPE, SEE A0.1
- SHEET KEYNOTES
- ROOM NUMBER, SEE FLOOR PLANS
- WINDOW TYPE, SEE A7.1
- DOOR TYPE, SEE A7.1
- PLUMBING/ACCESSORY TYPE, SEE A2.1
- BID ALTERNATE, SEE A0.0
- BUILDING ELEVATION, SEE A3.1-A3.2
- BUILDING OR WALL SECTION, SEE A4.1-A4.3
- DETAIL OR ENLARGED PLAN
- INTERIOR ELEVATION, SEE A10.1
- ELEVATION MARK
- WALL FIRE RATING DESIGNATION: SEE A0.2 & SECTIONS FOR RATED CONST. LOCATIONS & UL ASSEMBLIES
- SP - SMOKE PARTITION
- FP1 - 1 HOUR FIRE RATING (FP = FIRE PARTITION)
- FB2 - 2 HOUR FIRE RATING (FB = FIRE BARRIER)
- FW3 - 3 HOUR FIRE RATING (FW = FIRE WALL)



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PROJECT NAME

HENRY CLAY HS
SOFTBALL FIELD
HOUSE

PROJECT ADDRESS

2100 Fontaine Rd, Lexington,
KY 40502

SHEET NAME

RCP, ROOF PLAN
AND DETAILS

PROJECT NO.

2220

DATE

Mon DD, YYYY

REVISIONS


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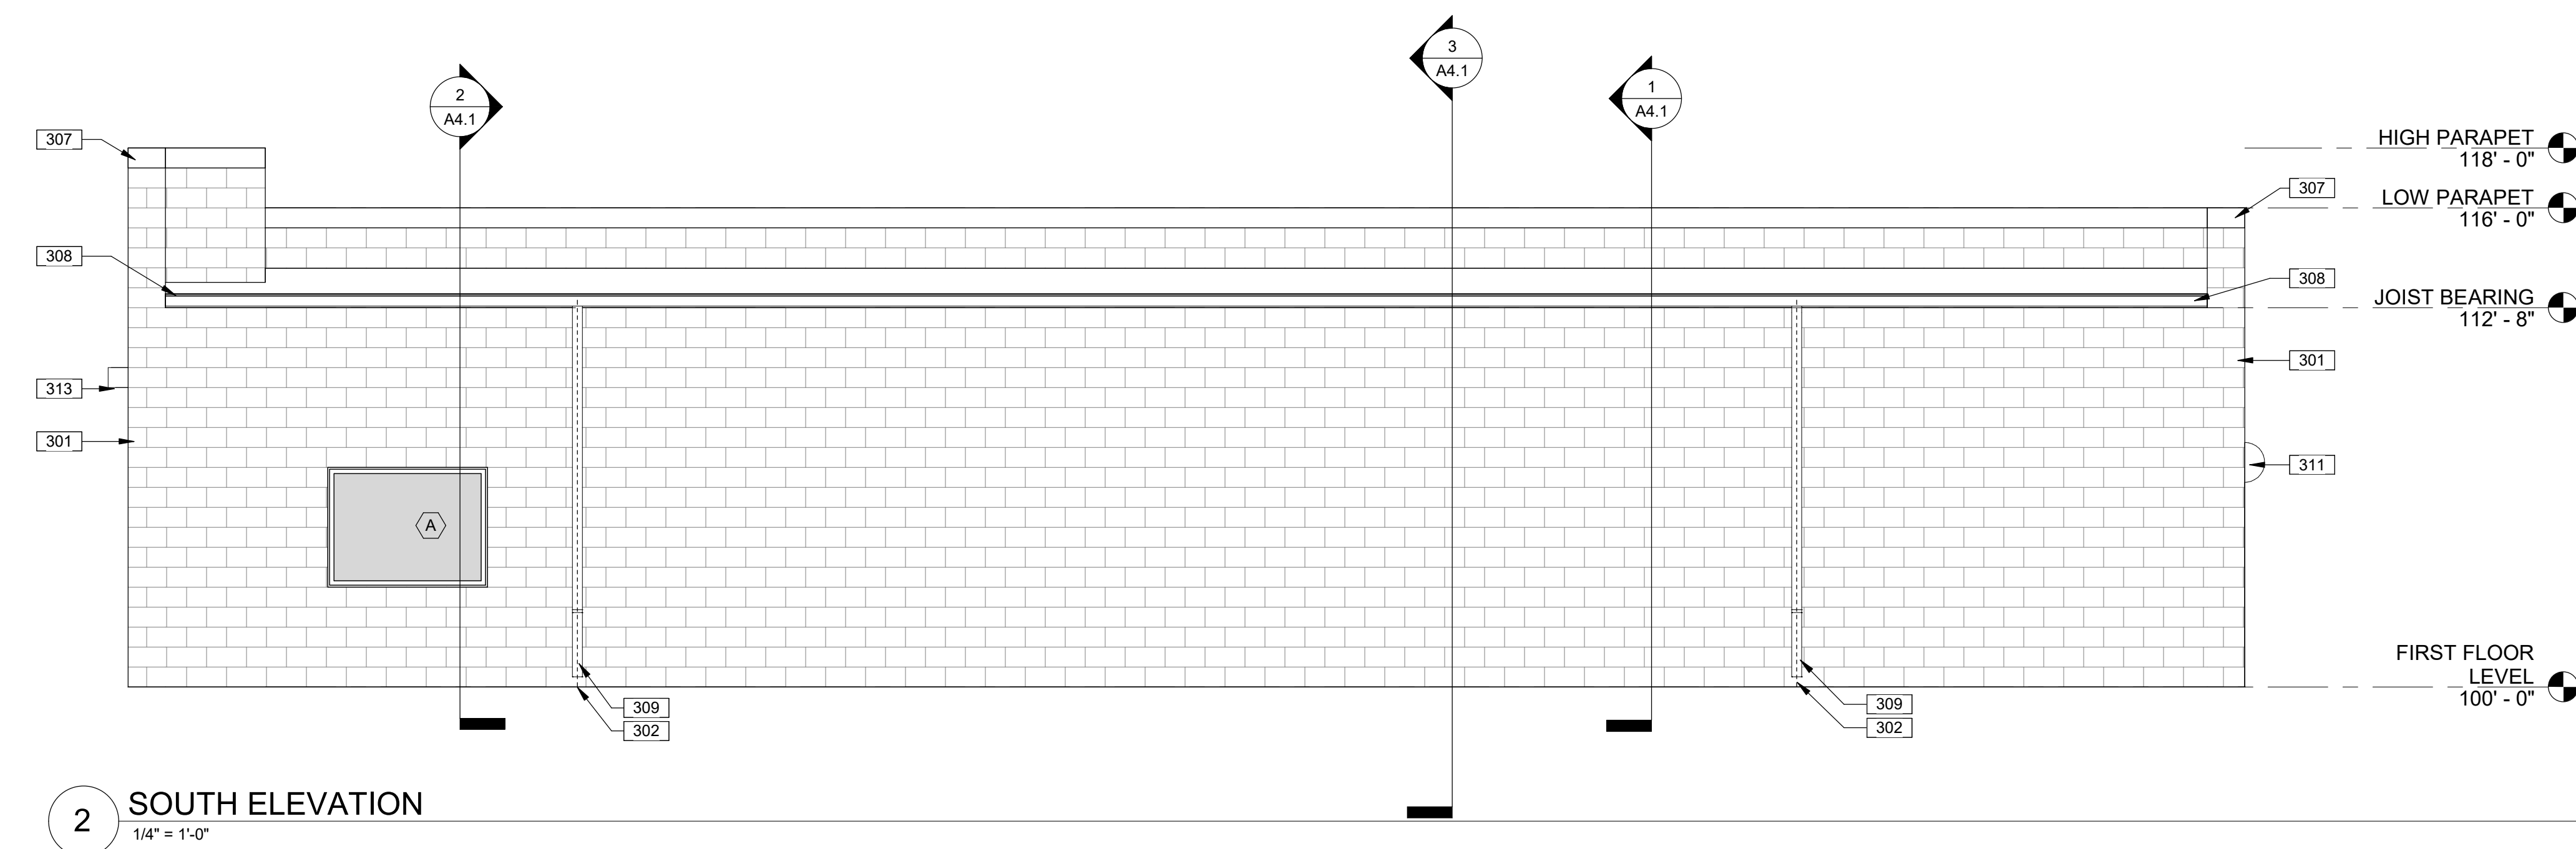
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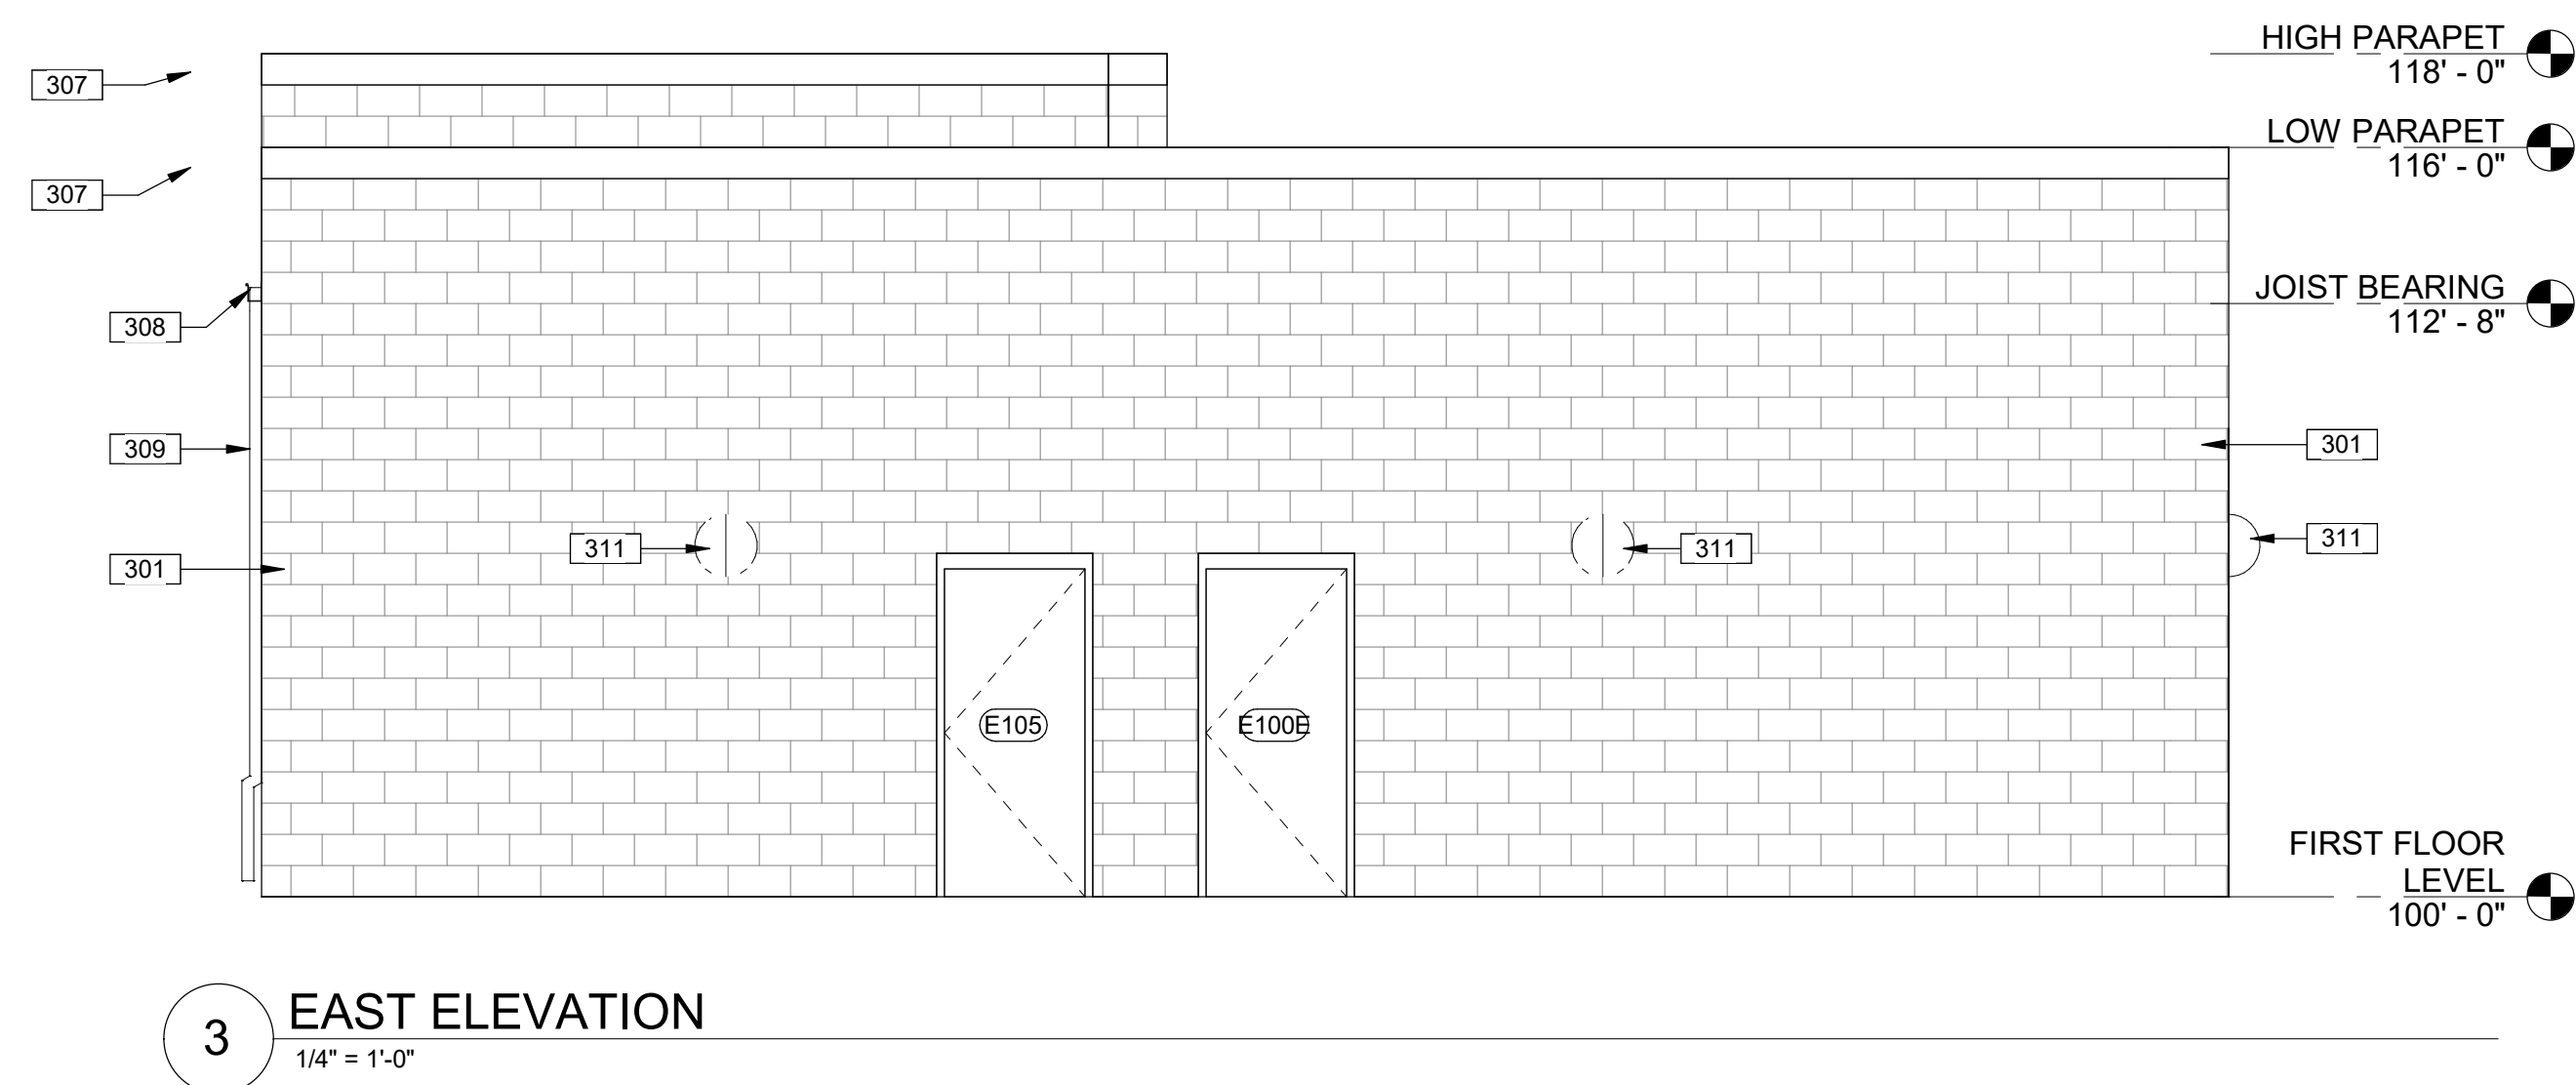
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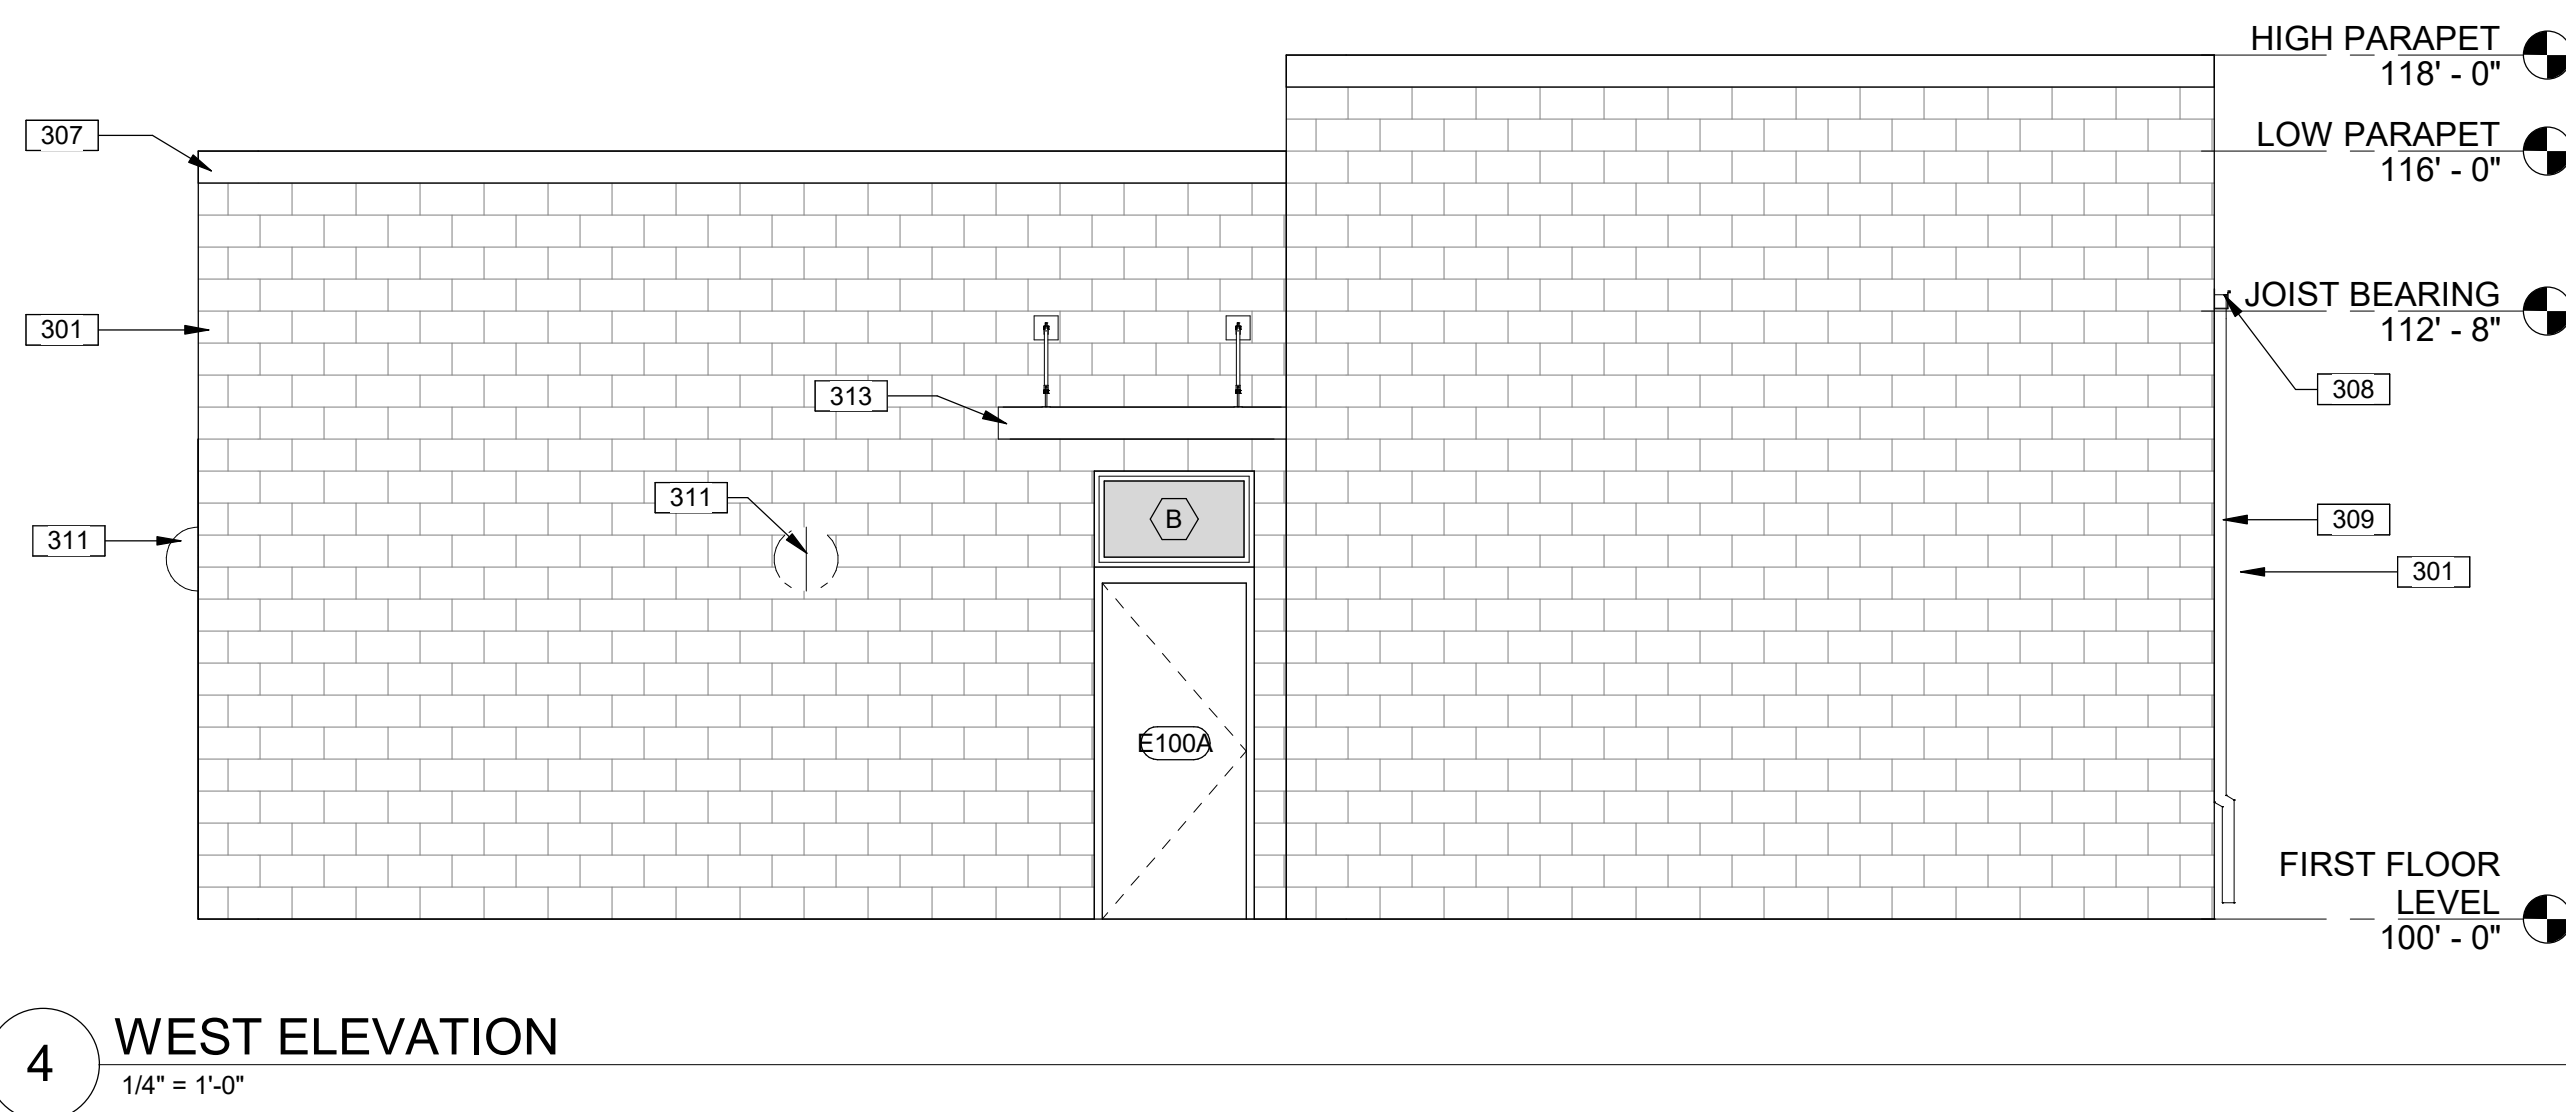
1 NORTH ELEVATION
1/4" = 1'-0"



2 SOUTH ELEVATION
1/4" = 1'-0"



3 EAST ELEVATION
1/4" = 1'-0"

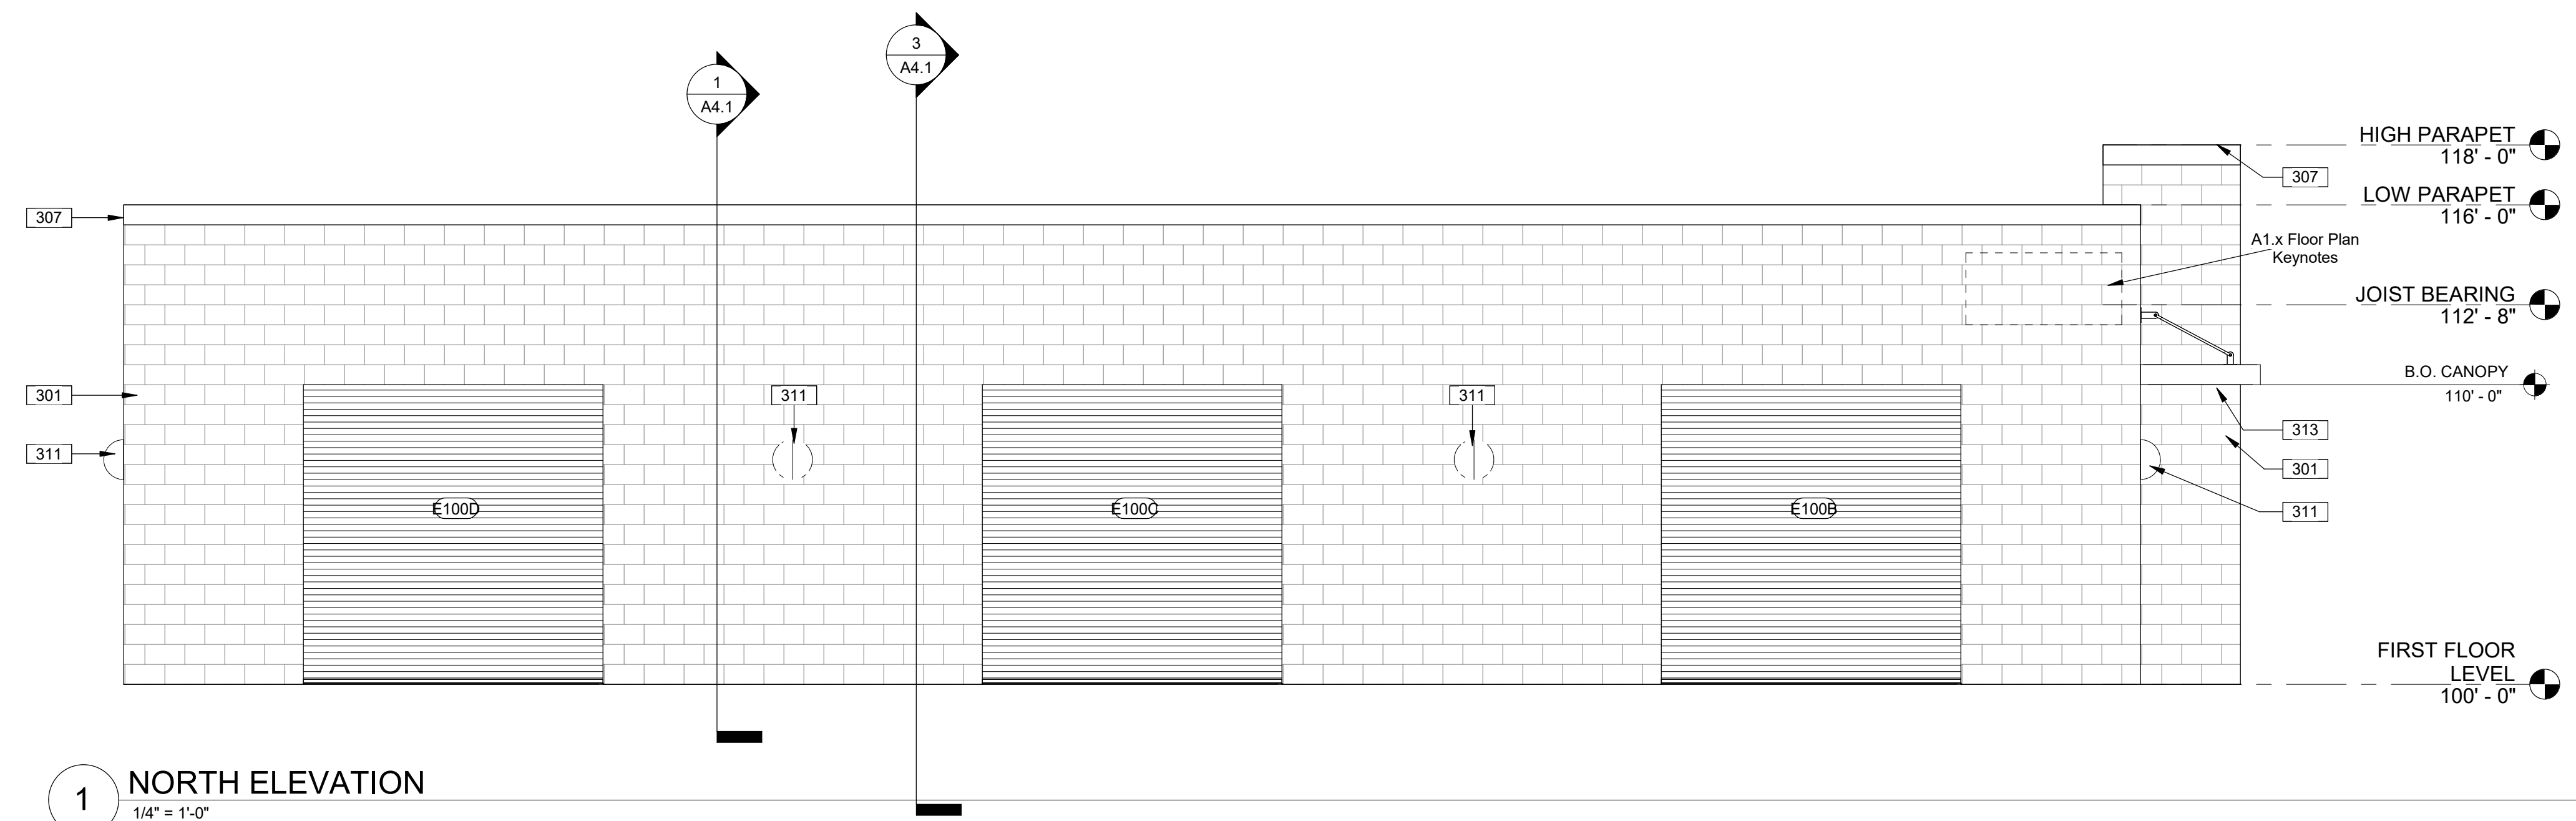

4 WEST ELEVATION
1/4" = 1'-0"

ELEVATION GENERAL NOTES

- A VERTICAL DIMENSIONS SHOWN ON BUILDING ELEVATIONS APPLY TO OTHER ELEVATIONS WHERE SHOWN U.N.O.
- B LINES REPRESENTING PAVING AND FINISH GRADES ARE SHOWN FOR REFERENCE PURPOSES ONLY. REFER TO SITE PLANS FOR SPECIFIC GRADE AND SPOT ELEVATIONS.
- C REFER TO FLOOR PLANS FOR LOCATIONS OF OPENINGS. REFER TO DOOR, WINDOW AND FRAME SCHEDULES FOR FULL EXTENT OF AND COMPLETE DESCRIPTION OF DOOR, WINDOW AND FRAME TYPES. PORTION OF DOORS, WINDOWS, STOREFRONTS, AND CURTAIN WALLS MAY BE CONCEALED BY OTHER BUILDING FEATURES SHOWN.
- D MASONRY & DOOR / WINDOW CONTRACTORS SHALL COORDINATE OPENING SIZES AS SHOWN, PROVIDE DIMENSIONS ON SHOP DRAWINGS FOR VERIFICATION.
- E EXPOSED EXTERIOR SHEET METAL COPINGS AND TRIM SHALL BE PREFINISHED GALV. SHEET METAL, U.N.O.
- F EXPOSED SEALANT IN MASONRY & MASONRY JOINTS SHALL MATCH THE COLOR OF ADJACENT MASONRY. PROVIDE SEALANT IN LIEU OF MORTAR AT MASONRY LINTEL BEARING LOCATIONS WHERE MASONRY JOINT DEPTH IS LESS THAN 1".
- G EXPOSED EXTERIOR MASONRY SHALL RECEIVE WATER REPELLENT - SEE SPECIFICATIONS.
- H CONTRACTORS (INCL. MASONRY, STONE & SIDING) SHALL COORDINATE LOCATIONS OF EXTERIOR ELECTRICAL OUTLETS, LIGHT FIXTURES, DOOR OPERATORS, HOSE BIBS, ETC. WHERE REQUIRED. SUCH ITEMS SHALL BE CAST IN OR PLACED BY RESPONSIBLE TRADE. NOT ALL SUCH ITEMS MAY BE SHOWN ON ELEVATIONS.
- I PROVIDE EXPANSION JOINTS AT BUILDING CORNERS U.N.O. ON BUILDING ELEVATIONS. PROVIDE MASONRY EXPANSION JOINTS AT INTERIOR BUILDING CORNERS, ADJACENT TO EXTERIOR BUILDING CORNERS (MAX. 4'-0" FROM CORNER) AND AT EVERY 25'-0" U.N.O. ON BUILDING ELEVATIONS.
- J ARCHITECT TO SELECT EXTERIOR FINISHES AND COLORS. PHYSICAL SAMPLES OF EXTERIOR FINISHES SHALL BE SUBMITTED SIMULTANEOUSLY TO COMPARE AND REVIEW ALL FINISHES TOGETHER U.N.O.
- K SEE FLOOR PLAN, SECTIONS, DETAILS & WALL TYPES FOR ADDITIONAL MATERIAL INFORMATION. SEE ROOF PLAN & DETAILS FOR ADDITIONAL ROOFING AND ROOF DRAINAGE INFORMATION. SEE WALL SECTIONS & STRUCTURAL FOR BEARING HEIGHTS.
- L MPE ITEMS SHOWN FOR REFERENCE ONLY - SEE MPE DRAWINGS FOR MORE INFORMATION.

ELEVATION KEYNOTES

- 301 8" (NOMINAL) CMU (SEALED AND PAINTED) - SEE STRUCTURAL.
- 302 MASONRY EXPANSION JOINT - OMIT MORTAR AND HORIZ. REINFORCING. FILL WITH 50% COMPOSITE FOAM CAULK. AT STONE BANDS AND TRIM, USE FLUSH 3/8" VERTICAL EXPANSION JOINTS W/ SQUARE EDGE AND SEALANT FLUSH WITH FRONT OF STONE. USE CONCAVE 3/8" VERTICAL EXPANSION JOINTS WHERE PORTIONS OF SUCH JOINTS FORM A VISIBLE PART OF THE STONE JOINT PATTERN. JOINT LOCATIONS MUST BE APPROVED BY ARCHITECT.
- 307 PREFINISHED GALVANIZED METAL COPING; COLOR TO MATCH WALL; + or - PREFINISHED METAL FASCIA WRAP - SEE ROOF PLAN, DETAILS AND WALL SECTIONS.
- 308 GUTTER; COLOR TO MATCH WALL - SEE ROOF PLAN.
- 309 DOWNSPOUT (DS); COLOR TO MATCH WALL - SEE ROOF PLAN. PROVIDE CAST IRON DS BOOT. PAINT TO MATCH DS & CONNECT TO SUBSURFACE DRAINAGE - SEE CIVIL FOR CONTINUATION.
- 311 WALL MOUNTED LIGHT - SEE ELECTRICAL FOR FIXTURE INFO & MOUNTING HEIGHT. PROVIDE ADA COMPLIANT FIXTURE WHERE MOUNTED 6'-6" OR LOWER ABOVE WALKING SURFACE. PROVIDE FRIT BLOCKING FOR SUPPORT. CENTER BETWEEN OPENINGS / ON WALL U.N.O.
- 313 PREFINISHED ALUMINUM HANGER CANOPY W/ INTERNAL DRAIN.

GENERAL SYMBOLS

- WALL TYPE, SEE A0.1
- SHEET KEYNOTES
- ROOM NUMBER, SEE FLOOR PLANS
- WINDOW TYPE, SEE A7.1
- DOOR TYPE, SEE A7.1
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2100 Fontaine Rd, Lexington,
KY 40502

SHEET NAME

BUILDING
ELEVATIONS

PROJECT NO.

2220

DATE

Mon DD, YYYY

REVISIONS

NO. DESCRIPTION DATE

SHEET NUMBER

A3.1