




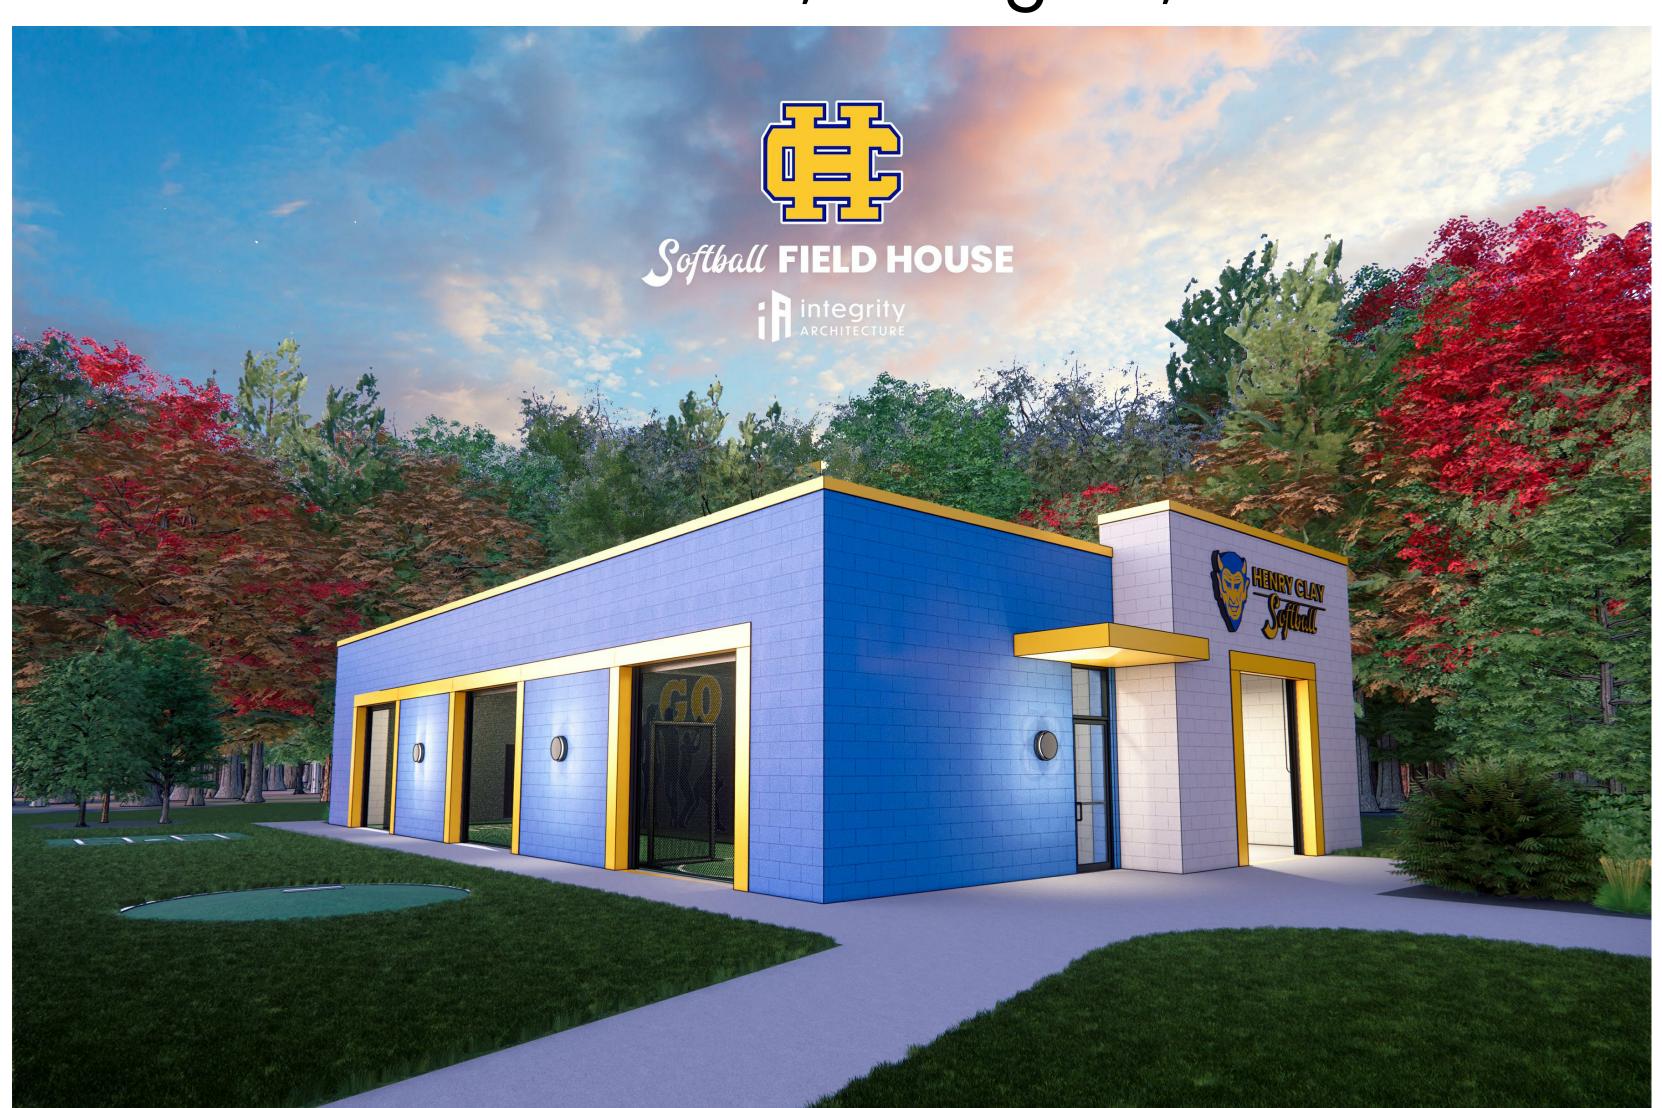


HENRY CLAY HS SOFTBALL FIELD HOUSE

2100 Fontaine Rd, Lexington, KY 40502



*IMAGE SHOWN FOR ILLUSTRATIVE PURPOSES ONLY. REFER TO DRAWINGS.

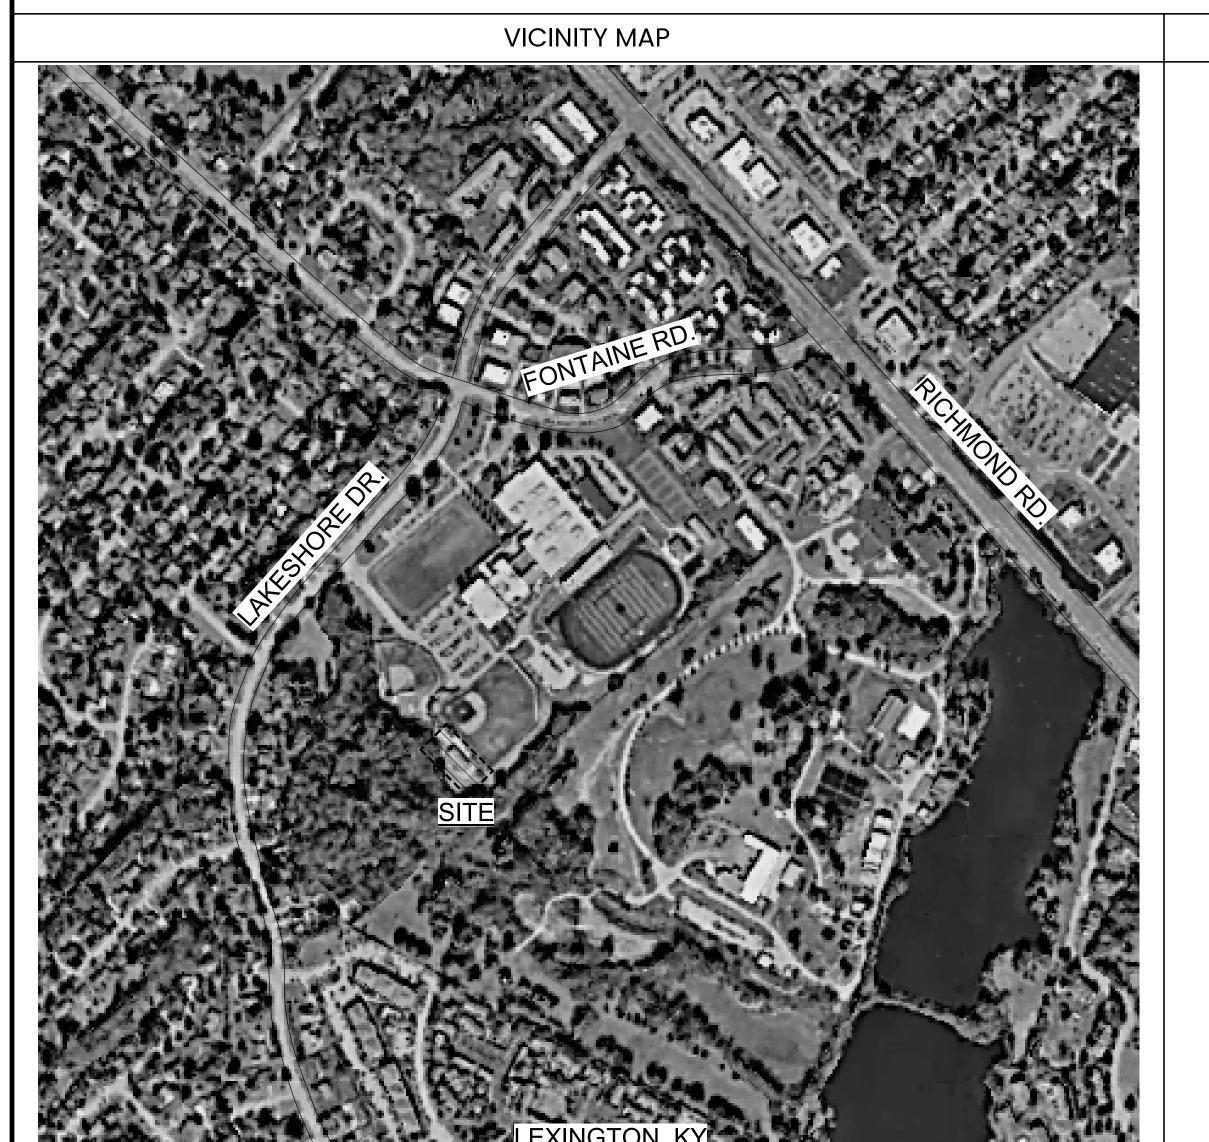

ARCHITECT integrity / Architecture, PLLC 2414 Palumbo Drive, Suite 125 Lexington, KY 40509 (859) 368-9712


PROJECT TEAM

E Tech Group 378 Park Ave. Lexington, KY 40502 (859)254-4200

Element Design 366 South Broadway Lexington, KY 40508 (859)389-6533

STRUCTURAL

Poage Engineering 880 Sparta Ct. Lexington, KY 40504 (859)255-9034

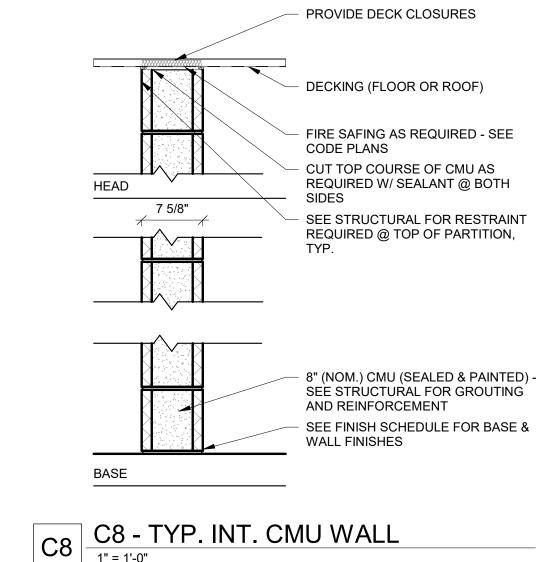

PROVIDE DECK CLOSURES DECKING (FLOOR OR ROOF)

FIRE SAFING AS REQUIRED - SEE CUT TOP COURSE OF CMU AS REQUIRED W/ SEALANT @ BOTH HEAD SEE STRUCTURAL FOR RESTRAINT REQUIRED @ TOP OF PARTITION,

6" (NOM.) CMU (SEALED & PAINTED) AND REINFORCEMENT

C6 - TYP. INT. CMU WALL

SEE STRUCTURAL FOR GROUTING SEE FINISH SCHEDULE FOR BASE &

FIRE EXTINGUISHER CABINET CONT. SEALANT (TYP.) S.S. SOLID OR —PARTIAL LITE DOOR

■ PARTIAL LITE DOOR

■ PARTIAL LITE DOOR LTWT W/ 2 1/2" ROLLED SEMI-RECESSED FIRE EXTINGUISHER MATL NOTE: PROVIDE REQUIRED FIRE MECH EXTINGUISHER UNIT W/ WEIGHT < 40 LBS → INTERRUPT CHAIR RAIL @ FEC, WHERE APPLICABLE 2x FRT WOOD BLKG. AS REQ'D HIGH DENSITY **GYPSUM BOARD** WHERE APPLICABLE, MTL REFER TO PLANS -MULL SEE FLOOR PLANS & WALL LEGEND FOR WALL TYPES AT EACH ELEVATION VIEW (N.T.S)

A-A SECTION VIEW (N.T.S.) ALL WORK PERTAINING TO FIRE EXTINGUISHERS SHALL BE DONE IN

ACCORDANCE WITH NFPA 10

WALL VARIATIONS

RI RATED CMU AND/OR CONCRETE PARTITION W/ FIRE

SEALANT AT PENETRATIONS. REFER TO CODE

W/ DESIGNATED WALL RATING AS NECESSARY.

GRID PERIMETER), BOTTOM, AND OPENINGS OF

STC RATING OF 50 U.N.O.

STRUCTURE ABOVE.

ASSEMBLIES. CONTRACTOR TO PROVIDE &

COMPLIANCE PLANS FOR UL NUMBERS OF RATED

COORDINATE APPROPRIATE FIRE RATED ASSEMBLY

PROVIDE 3" MIN. SOUND ATTENUATION BLANKETS &

ACOUSTICAL SEALANT @ TOP (INCLUDING CEILING

WALL PARTITION. PROVIDE SAND FILLED CORES IN

OTE: UNLESS NOTED OTHERWISE BY PARTITION TYPE OR

PARTITION AND GYPSUM BOARD 6" ABOVE CEILING

HEIGHT AND PROVIDE ADEQUATE BRACING TO

SAMPLE WALL TAG

BOARD FINISH.)

VARIATIONS "D", "X", OR "S", EXTEND WALL

CMU WALL PARTITIONS. CONTRACTOR TO MEET MIN. | HTR

(AT VARIATION TYPE "A", PARTITION

VARIATIONS "A" & "C"

- WALL TYPE "C8"

TAG IS LOCATED ON WALL SIDE

INTENDED TO RECEIVE GYPSUM

DRAWING INDEX

BUILDING ELEVATIONS

10" WIDE SCHEDULE.

STRUCTURAL TITLE SHEET

SCHEDULE & DETAILS

COVER SHEET & PROJECT NOTES

FIRE PROTECTION LEAD SHEET

PLUMBING LEAD SHEET

MECHANICAL LEAD SHEE

ELECTRICAL LEAD SHEET

MECHANICAL

DOOR & WINDOW ELEVATIONS, DOOR

RCP, ROOF PLAN AND DETAILS

BUILDING AND WALL SECTIONS

SIZED FOR A 2-PART SPLIT SCHEDULE

SO BOTH ADD UP TO 10" WIDE. IF A SPLIT

SCHEDULE IS NOT USED, THIS COLUMN

SHOULD BE WIDENED TO 9" TO MAKE A

Air Conditioning

Air Handling Un

Bottom Ot

BOT or BTM Bottom

CLR

CMU

COL

CONC

COND

CONST

CONTR

CONT

ESMT

FLASH

FLEX

FRT

FTG

HORIZ

C/C or OC Center to Cente

Beam, Bench Marl

Cast in Place

Control Joint

Clear

Concrete

Construction

Continuous

Countersink

Expansion Join

Floor Drain

Foundation

Flat Head

Furring

Field Verify

Finish, Finished

Finished Floor Elevation

Fire Retardant Treated

Ground Fault Interrupt

Glazed Structural Tile

Glass, Glazing

GLUE LAM Glue-Laminated

Grade

Heating

Inside Face

Inner Radius

Junction Box

Angle, Long

Laminated

Left Hand

Long Leg Vertical

Laugh Out Loud

Kentucky Building Code

Light Fixture, Linear Feet

Miscellaneous Channel

Mechanical, Plumbing, &

Mounting

Mullion

Hot Water, Hard White

Insulated Concrete Form

Inside Diameter / Inside Dim

Integrated Framing Assembly

Cold Water, Clockwise

Contractor

Contractor Furnished & Installed

Condition.Condenser,Condensate

R or RAD Radius **REINF** REQD or REQ'D **RESIL** SCHD Schedule SECT Similar Square STL STOR Storage STRUCT TDS TOC Top of Concrete TOIL TOS Top of Steel TOW **UNFIN** VCT

VERT

WND

Welded Wire Fabric

PROJECT GENERAL NOTES ABBREVIATIONS Not Applicable Means Exact Dimension Reg'd. Not in Contract NO. or # NTS Not to Scale On Center Outside Diameter Outside Diameter Owner Furnished, Contractor OPG OPP Poured Concrete PART Partition PART BD Partical Board PASS Pre-Engineered Metal Building PERF Perforated Perpendicular PF CMU Prefaced Conc. Mas. Unit PLAS PLUMB POL Polished **POLY** Polycarbonate Sheet Project, Projected Point, Pressure Treated Reinforcing Bar Refrigerator Reinforce, Reinforced, Reinforcing Retaining, Return Right-Hand Rough Opening Separate, Separation Square Feet, Split Face Specifications Stainless Steel Tounge & Groove Top of Masonry

SEALANT CONDITIONS (TYP.). WHERE SPECIFIC CONDITIONS DO NOT ALLOW BACKER ROD TO BE USED, A BOND BREAKER SHALL BE USED AT THE BACK OF THE JOINT. PAINTED ACCESS PANELS SHALL BE PROVIDED AN INSTALLED WHERE REQUIRED TO MAINTAIN CONCEALED ELEC., MECH. SYSTEMS AND ACCESS POINTS WHETHER OR NOT INDICATED ON THESE DRAWINGS, LOCATIONS SHALL BE APPROVED BY CORNER BEADS SHALL BE USED AT ALL GYPSUM BOARD OUTSIDE CORNERS, TYP. CASING BEADS SHALL BE USED AT ALL GYPSUM BOARD TERMINATIONS, TYP. BATT INSULATION SHALL BE MECHANICALLY FASTENED TO WALLS. PAINT ALL EXPOSED GAS PIPING TO PREVENT RUST - IF PIPING IS VISIBLE, ARCHITECT TO SELECT FINISH 19 FLOOR FINISHING TRANSITIONS HAPPEN AT DOOR PROVIDED AS REQUIRED BY MANUFACTURER OR INSTALLER OF WALL-MOUNTED EQUIPMENT OR ALL WOOD BLOCKING, NAILERS AND PLYWOOD SHALL BE FIRE RETARDANT TREATED (FRT), EXCEP AT COPINGS WHERE BLOCKING SHALL BE PRESSURE TREATED (PT). ALL FRT WOOD FRAMING AND/OR BLOCKING IN CONTACT W/CONCRETE AND/OR MASONRY SHALL SEPARATE PT WOOD FROM METALS W/ BUILDING FELT, TAPE OR APPROVED METHOD. ANCHORS IN P WOOD SHALL BE STAINLESS STEEL OR HOT-DIPPED 24 THE LOCATION OF ALL HVAC, ELEC. & PLUMBING COMPONENTS (I.E. DUCTWORK, ELEC. SERVICE, TUBS, TOILETS) SHALL BE COORDINATED PRIOR T THE PLACEMENT OF CONC. SLABS, PLANKS & FLOOF Turned Down Slab 25 LABELED ITEMS ARE NEW, (N), UNLESS LABELED AS EXISTING, (E), OR U.N.O. (E) PORTIONS OF THE BUILDING MAY NOT BE LABELED OR DETAILED; (E) Top of Footing Top of Footing Elevation AREAS SHOWN FOR REFERENCE ONLY. Thick, Thickness IF (E) CONDITIONS VARY FROM THOSE SHOWN ON DRAWINGS, BRING TO THE ATTENTION OF Threshold ARCHITECT BEFORE PROCEEDING. INFORMATION

Top of Wall THE CONTRACTOR SHALL FIELD VERIFY (E) DIMENSIONS, ELEVATIONS AND ALL CONDITIONS Thermoplastic Polyolefin RELATED TO (N) WORK. Structural Steel Tubing, Tack Strip (E) PAINTED SURFACES IN AREAS OF (N) WORK SHALL BE CLEANED AND PAINTED U.N.O. COLORS 1 BE SELECTED BY ARCHITECT. Underground CONTRACTOR SHALL BE RESPONSIBLE FOR ALL **Underwriters Laboratory** PATCHING AND REPAIRING DUE TO DEMOLITION Unfinished AND/OR REMOVAL OF ITEMS TO CREATE A FLUSH Unless Noted Otherwise SMOOTH SURFACE PROPERLY PREPARED TO RECEIVE (N) FINISHES AS SCHEDULED. CONTRACTOR SHALL SOAP IN (N) CMU OR BRICK Vapor Barrier MATCH (E) ADJACENT AREAS WHERE REQUIRED. Vinyl-Composition Tile IN AREAS OF DEMOLISHING OR REMOVAL, CAP/SEA Vertical AND/OR RE-ROUTE EXISTING UTILITIES AS Verify in Field REQUIRED FOR COMPLETE, FUNCTIONING AND FINISHED PROJECT. CONTRACTOR TO COORDINATE Vent Through Roof UTILITY DEACTIVATION, SWITCH OVER AND ACTIVATION WITH OWNER / ARCHITECT PRIOR TO Wide DEMOLITION. Window

THE CONTRACTOR SHALL BE RESPONSIBLE FOR A DAMAGE TO (E) ITEMS TO REMAIN CAUSED BY THE DEMOLITION, WORK OR WEATHER EXPOSURE. FIRE RATED ASSEMBLIES AND STRUCTURAL SYSTEMS TO REMAIN COMPLETE AND INTACT PATCH/REPAIR/REPLACE IN AREAS OF WORK TO PROVIDE COMPLETE FINISHED SURFACES. CONTRACTOR IS RESPONSIBLE FOR PHASING / SCHEDULING OF WORK WITH EXISTING BUILDING

COMPILED FROM FIELD MEASUREMENTS AND

ORIGINAL CONSTRUCTION DOCUMENTS SUPPLIED

AND SERVICES - COORDINATE W/ OWNER & ARCHITECT PRIOR TO CONSTRUCTION. IDENTIFYING WORK PLACE HAZARDS AND HAZARDOUS MATERIALS PRIOR TO CONSTRUCTION RENOVATION, OR DEMOLITION. INTEGRITY / ARCHITECTURE ASSUMES NO LIABILITY, EXPRESSE OR IMPLIES NO OR ANY WARRANTY OR GUARANTE AS TO THE COMPLETENESS OF THE OWNERS OR IT CONSULTANTS DUE DILIGENCE TO IDENTIFY WORK PLACE HAZARDS OR HAZARDOUS MATERIALS THAT MAY BE ENCOUNTERED DURING THE CONTRACTOR SCOPE OF WORK.

DETAILS SHOWN ARE TYPICAL, SIMILAR DETAILS APPLY IN SIMILAR CONDITIONS. IF CONDITIONS ARISE THAT ARE NOT COVERED BY A TYPICAL DETAIL, THE CONTRACTOR SHALL CONTACT THE ARCHITECT FOR CLARIFICATION BEFORE

PROVIDE MECHANICAL, PLUMBING, ELECTRICAL INCLUDING EXIT SIGNS AND EMERGENCY LIGHTING AND FIRE PROTECTION ITEMS FOR EACH ROOM/SPACE AS REQUIRED PER CODE AND OWNER REQUIREMENTS.

TAKE PRECEDENCE OVER SCALED DIMENSIONS. AN

DELIVER TO THE PROJECT SITE. "INSTALL" MEANS

DISCREPANCIES SHALL BE BROUGHT TO THE

THE TERM "FURNISH" MEANS TO SUPPLY AND

O PLACE IN POSITION FOR SERVICE OR USE.

NOTES INDICATED AS N.I.C. (NOT IN CONTRACT) AF

LOCATION, CONNECTIONS, REINFORCEMENT AND

SCHEDULE, WHERE STEEL PLATES ARE A PART OF

FACE OF CMU. ALL RELIEF ANGLES AND EXPOSED

COMPONENTS OF STEEL LINTELS AND SUPPORTS

EXPOSED PORTIONS OF LINTELS AND SUPPORTS

COLUMN LINES INDICATED ARE REFERENCE LINES ONLY AND MAY NOT INDICATE CENTER OF COLUMN SEE ENLARGED PLANS / DETAILS AND STRUCTURA

PROVIDE ADDITIONAL HEADERS AS REQUIRED TO

CONTACT BETWEEN DISSIMILAR METALS SHALL BE

PENETRATIONS THROUGH SLABS AS REQUIRED

MANUFACTURER'S UL TESTED ASSEMBLY FOR

RATING OF THAT ASSEMBLY. RATED WALLS FILL

ALL GYPSUM BOARD SHALL BE TYPE "X" AT FIRE

MASONRY VENEER SHALL RETURN TO SHEATHING

CONTROL JOINTS IN CONCRETE AND MASONRY.

VOIDS W/ FIRE SAFING AND PROVIDE BACKER ROD

AND FIRE RATED SEALANT ON BOTH SIDES OF WAL

NOT REQUIRED AT SLAB PENETRATIONS WHICH AF

ACCOMMODATE ELECTRICAL, HVAC AND PLUMBING

EXTERIOR WALLS SHALL BE GALVANIZED. ALL

LINTELS, FACE OF LINTEL SHALL BE INSET 1/2" FROM

SHOWN FOR COORDINATION PURPOSES ONLY.

OTHER REQUIREMENTS PERTAINING TO

SEE STRUCTURAL DRAWINGS FOR LINTEL

SHALL BE PAINTED, TYP.

DRAWINGS WHERE APPLICABLE

SEPARATED WITH BUTYL TAPE.

FIRESTOPPING SHALL BE INSTALLED AT

SHALL BE FIRESTOPPED - USE THE

ATTENTION OF THE ARCHITECT.

integrity ARCHITECTUR 2414 Palumbo Drive, Suite 1 Lexington, KY 40509 O: 859.368.9712 W: www.integrityarch.com © COPYRIGHT 2022


PROJECT NAME **HENRY CLAY HS SOFTBALL FIELD**


PROJECT ADDRESS 2100 Fontaine Rd, Lexington

SHEET NAME **COVER SHEET & PROJECT NOTES**


Mon DD, YYYY **REVISIONS** NO. DESCRIPTION DATE

SHEET NUMBER A0.0

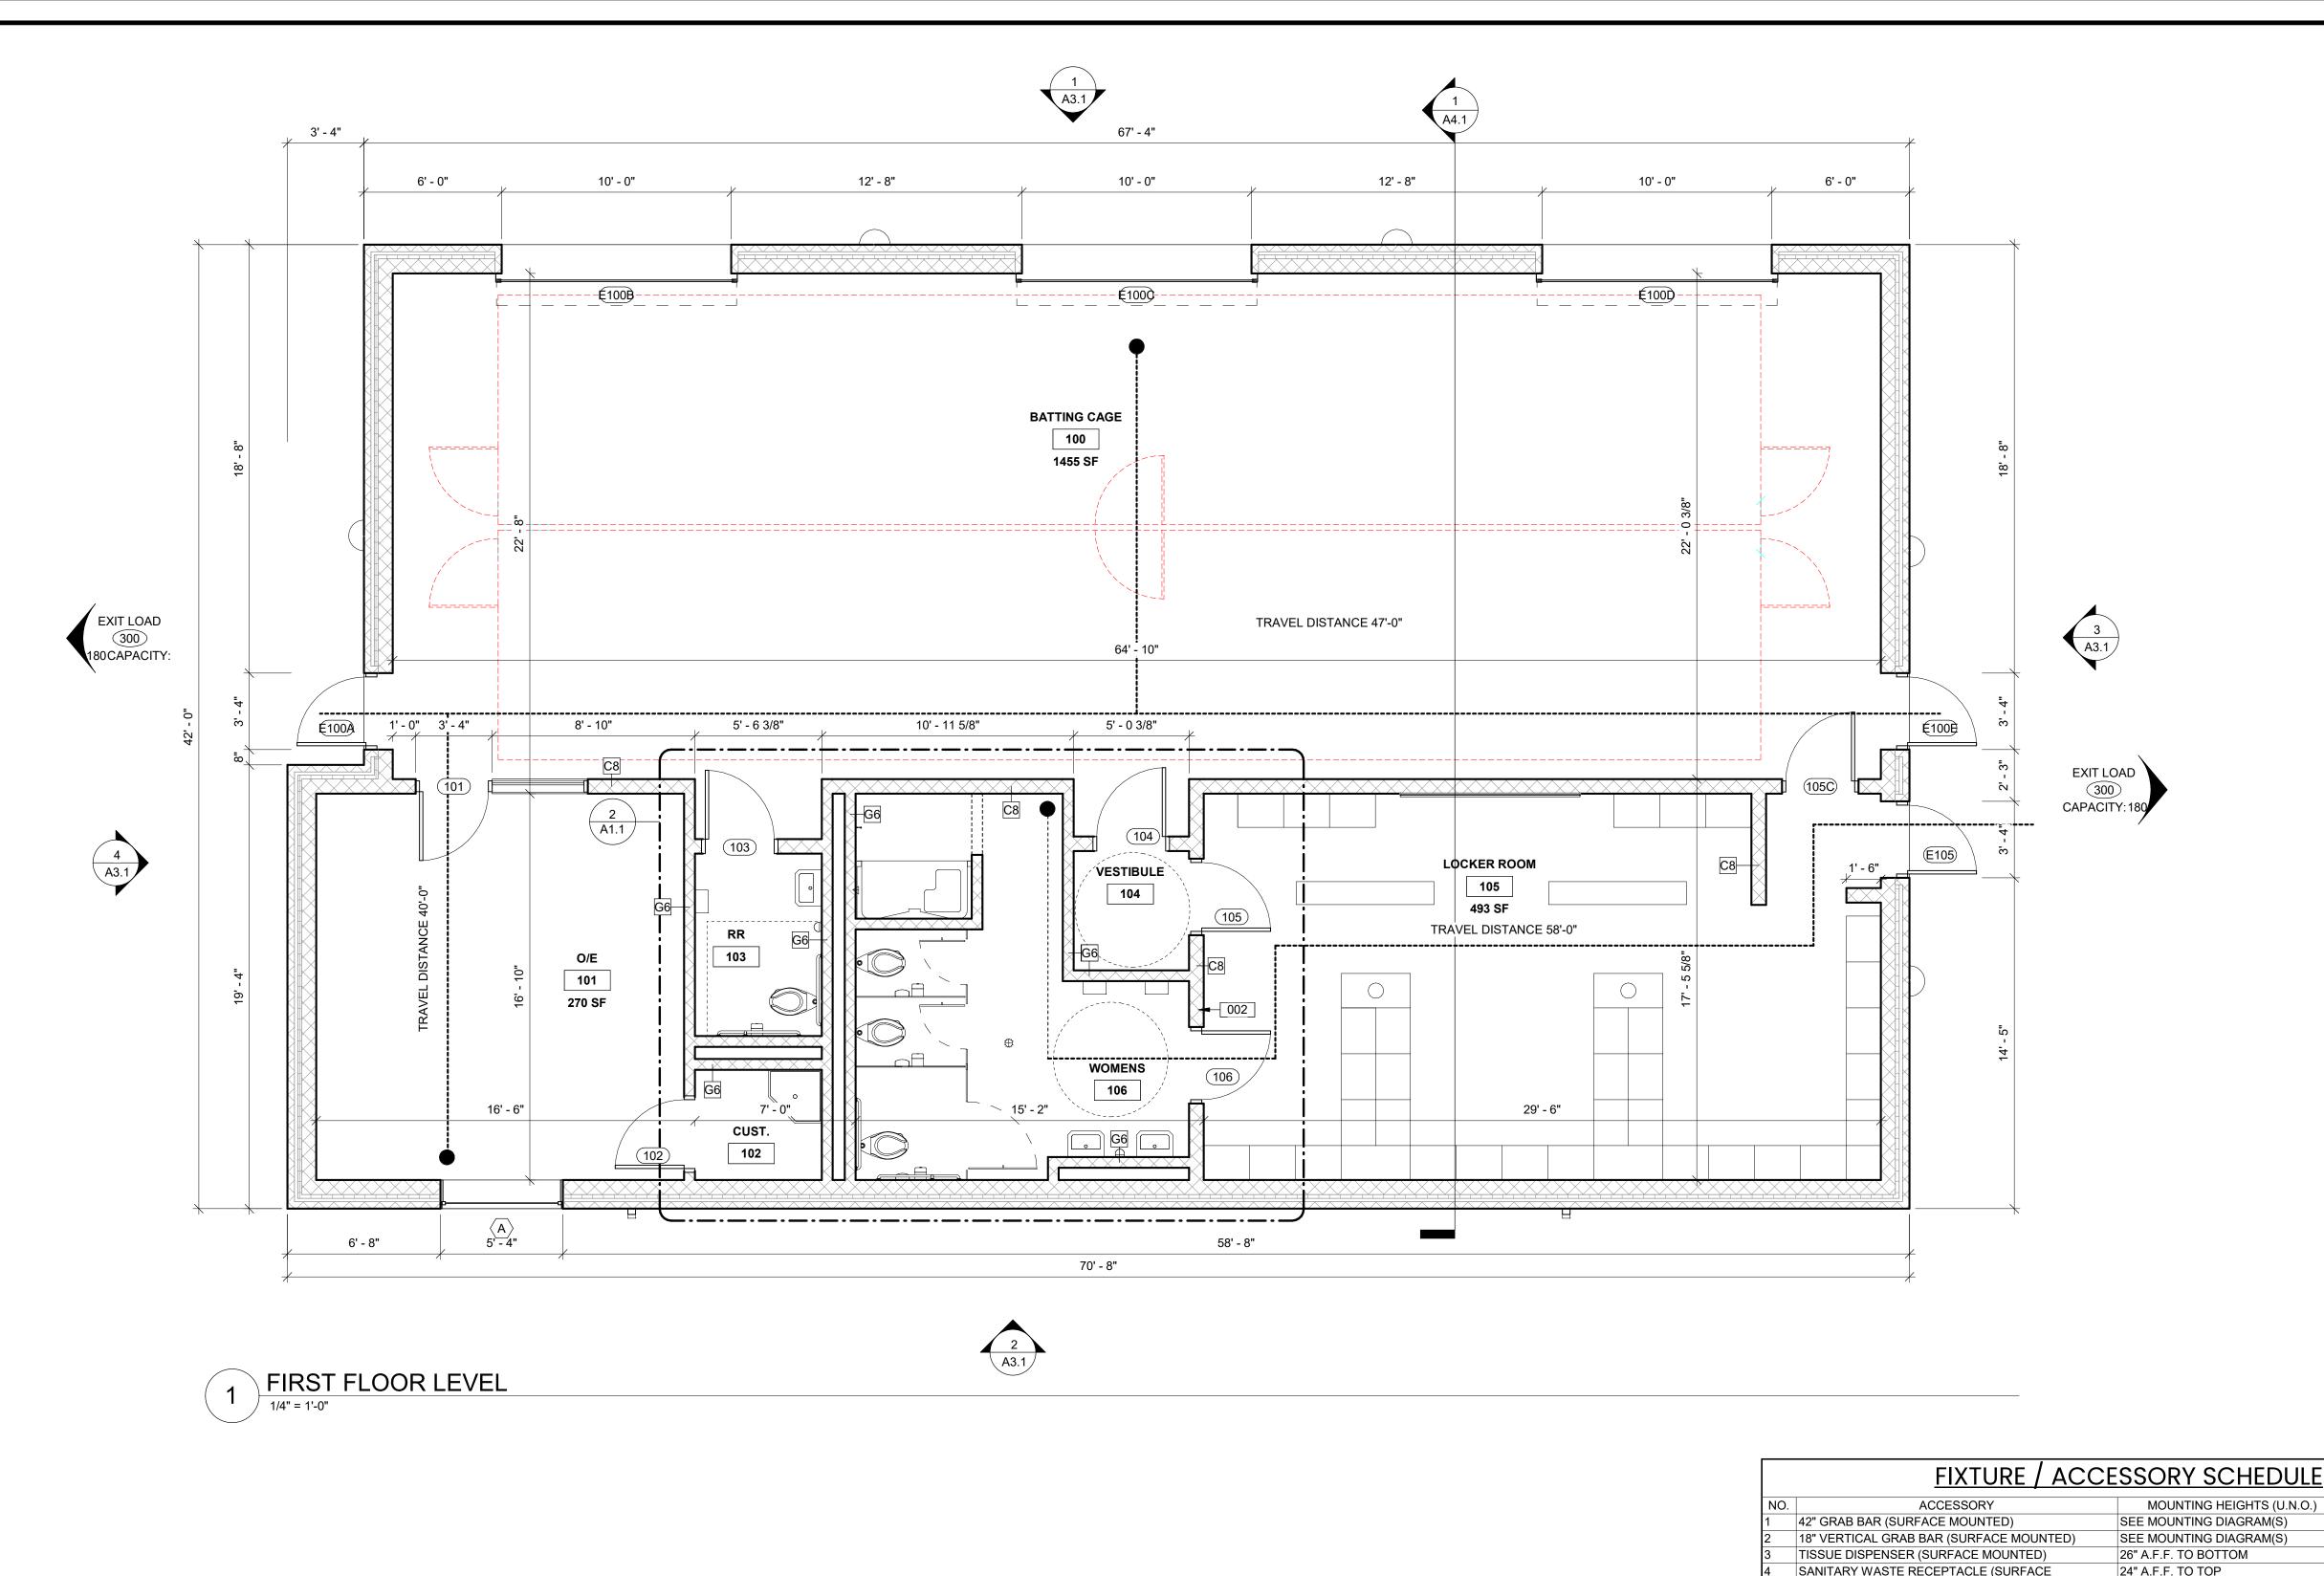

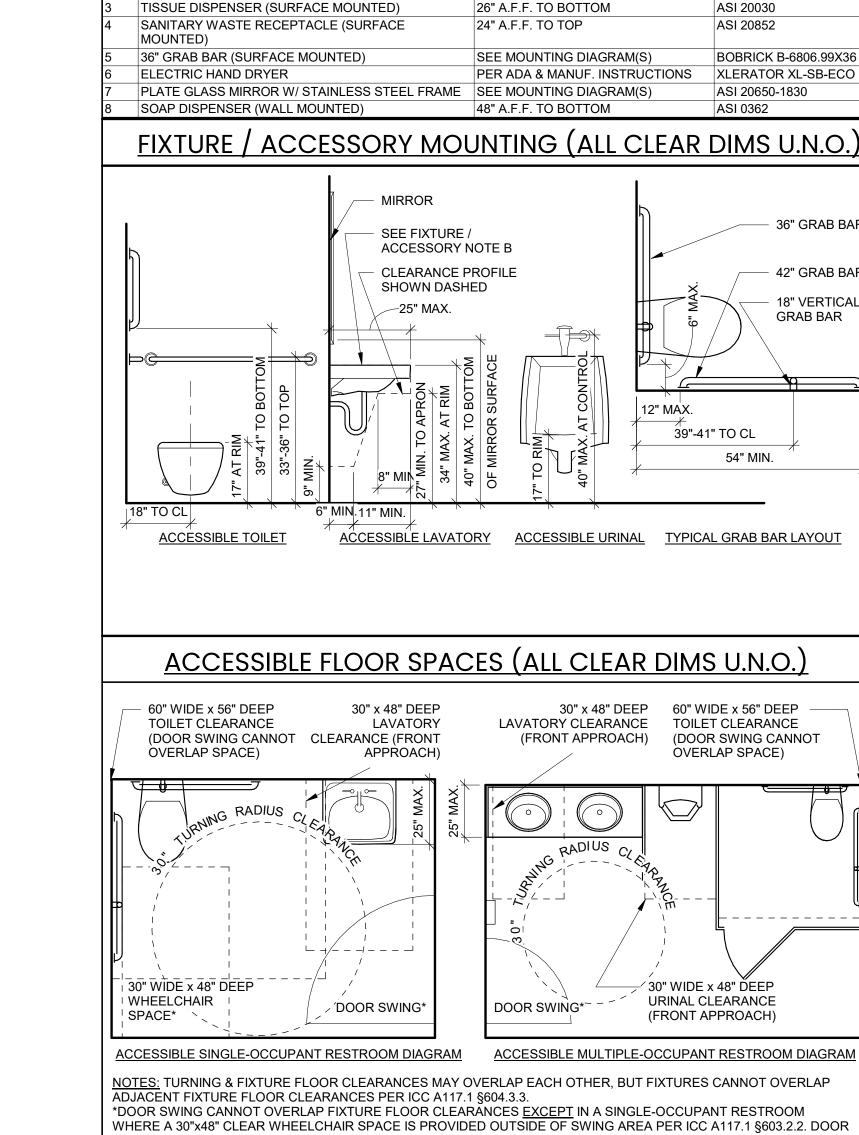

SWING MAY OVERLAP TURNING CLEARANCES UNLESS NOTED OTHERWISE PER ICC A117.1 §304.4.

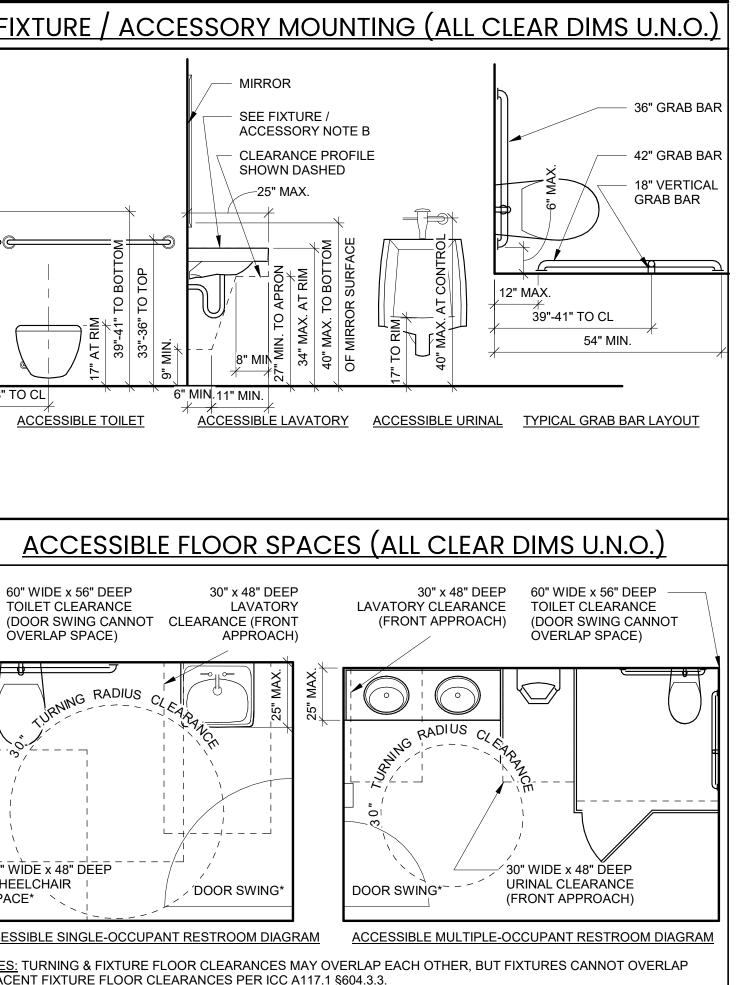

MANUF. / MODEL NO.

BOBRICK B-6806.99X42

BOBRICK B-6806.99X18

WOMEN'S RESTROOM SIGN PICTOGRAM IN 6" HIGH FIELD, RAISED 1/32" FROM SURFACE OF SIGN RAISED LETTERS ON SIGN FACE, MIN. 5/8" TALL ACRYLIC SIGN PANEL **GRADE 2 BRAILLE** NOTE: SEE SIGNAGE GENERAL NOTES FOR MORE INFO.

TYPICAL ROOM SIGN

RESTROOM SIGN (UNISEX & FAMILY)

FLOOR PLAN GENERAL NOTES CODE COMPLIANCE DATA

APPLICABLE BUILDING CODE: IBC 2015 (WITH 2018 KY AMENDMENTS)

MAX ALLOWABLE TRAVEL DISTANCE (PER KBC TABLE 1017.2): 200 FT

MAX COMMON PATH OF EGRESS TRAVEL (PER KBC TABLE 1006.2.1):

MINIMUM FIRE RESISTANCE RATINGS (PER KBC TABLE 601 / 602):

ROOFS/CEILING CONSTRUCTION & SECONDARY MEMBERS 0HR

DESIGN OCCUPANT LOAD FACTORS (PER KBC TABLE 1004.1.2):

A. ASSEMBLY (UNCONCENTRATED) 15 NET SF / PERSON

OWNER IS RESPONSIBLE FOR CONFIRMING ALL SPECIAL INSPECTIONS OWNER SHALL PROVIDE ALL DOCUMENTATION REQUIRED PER CODE.

THESE FACILITIES MUST BE DESIGNED TO COMPLY WITH ALL APPLICABLE

REQUIREMENTS OF THE AMERICANS WITH DISABILITIES ACT. ALL RESIDENTIAL DWELLING UNITS ARE TYPE "B" UNITS PER KBC 1107.6.2.2.2.

ITEMS INSTALLED IN FIRE SEPARATION PARTITIONS AND OTHER FIRE RESISTANT CONSTRUCTION SHALL BE INSTALLED WITH PROPER LABELING FOR THE RATED ASSEMBLY. ALL PENETRATIONS SHALL BE FIRE STOPPED / FIRE BLOCKED AS REQUIRED BY CODE WITH AN

RAISED NUMBERS ON SIGN

REMOVABLE NAME PLATE

GRADE 2 BRAILLE (ROOM #

FACE, MIN. 5/8" TALL

ACRYLIC SIGN PANEL

PICTOGRAM IN 6" HIGH

SURFACE OF SIGN

RAISED 1/32" FROM

SURFACE OF SIGN

2" HIGH PICTOGRAM

RAISED 1/32" FROM

SURFACE OF SIGN

FACE, MIN. 5/8" TALL

GRADE 2 BRAILLE

ACRYLIC SIGN PANEL

FIELD, RAISED 1/32" FROM

2" HIGH RED PICTOGRAM,

RAISED LETTERS ON SIGN

60 GROSS SF / PERSON

200 GROSS SF / PERSON

200 GROSS SF / PERSON

300 GROSS SF / PERSON

EXTERIOR WALLS W/ FIRE SEPARATION DISTANCE >10'

INTERIOR NONBEARING WALLS & PARTITIONS

E. MECH. EQUIPMENT/STORAGE AREA

APPROVED UL METHOD AND MATERIALS.

FLOOR CONSTRUCTION & SECONDARY MEMBERS

OCCUPANCY CLASSIFICATION (CH3 KBC): E (EDUCATIONAL)

ACTUAL BUILDING HEIGHT: 1 STORY, 18'-0"

MAX ALLOWABLE AREA PER FL: 9,500 SF

ACTUAL MAXIMUM TRAVEL DISTANCE:

PRIMARY STRUCTURAL FRAME

EXTERIOR BEARING WALLS

INTERIOR BEARING WALLS

B. MERCANTILÈ

D. RESIDENTIAL

C. PARKING GARAGE

ALLOWABLE HEIGHT: 1 STORY, 40'-0"

CONSTRUCTION TYPE: 5B

FIRE PROTECTION: NONE

ACTUAL FLOOR BUILDING AREA: FIRST FLOOR = 2,904 SF

- A SEE PROJECT GENERAL NOTES ON A0.1 FOR MORE THE FOLLOWING NOTES ARE TYPICAL FOR ALL FLOOR PLANS IN THIS SET. NOT ALL NOTES MAY
 - APPLY TO THIS SHEET. SEE ENLARGED PLANS FOR NOTES OF ENLARGED AREAS. DIMENSIONS ARE TO FACE OF STUD OR MASONRY
 - U.N.O. EXTERIOR WALLS ON FLOORS ABOVE ALIGN WITH WALLS BELOW U.N.O. STAIR DIMENSIONS ARE TO NOSE OF TREAD/RISER U.N.O. SEE STRUCTURAL FOR FOUNDATION WALL DIMS. - EXTERIOR WALL ASSEMBLIES VARY. DOOR / WINDOW OPENINGS IN STUD WALLS SHALL
 - BEGIN 6" FROM NEAREST WALL OR CENTERED ON WALL U.N.O. FIELD VERIFY LOCATIONS TO RECEIVE MILLWORK. SEE DOOR SCHEDULE FOR MORE INFO. EXTERIOR WINDOWS & DOORS DIMENSIONED TO OUTSIDE EDGE OF FRAME OR MASONRY OPENING
 - (WHERE OCCURS), CONTRACTOR TO COORDINATE R.O. WITH WINDOW MANUFACTURER. WINDOWS & DOORS SHOWN AS GENERIC UNITS. SE
 - SHEET A7.1 FOR MORE INFORMATION. SEE CIVIL DRAWINGS FOR EXTERIOR HARDSCAPE
 - AND SITE INFORMATION. SEE PLUMBING FOR PLUMBING FIXTURE INFORMATION.

SEE FINISH PLANS FOR FINISH TRANSITIONS & PAINT

- COLORS TO BE SELECTED BY ARCHITECT U.N.O.

SEE INTERIOR ELEVATIONS & DETAILS FOR CASEWORK. FURNITURE AND APPLIANCES SHOWN FOR

COORDINATION PURPOSES ONLY U.N.O.

- **FLOOR PLAN KEYNOTES**
- ROOM SIGNAGE [- SEE SHEET A9.1 FOR DETAILS]. PROVIDE RESTROOM SIGNAGE PER CODE REQUIREMENTS.

SIGNAGE GENERAL NOTES

- CHARACTERS SHOWN ARE COMPUTER GENERATE SPACING OF CHARACTERS MAY NOT BE ACCURATE. CORRECT "VISUAL" SPACING IS THE RESPONSIBILIT OF THE MANUFACTURER. B PICTOGRAMS ARE SHOWN HEREIN FOR
- THE SIGNAGE CONTRACTOR. C COLORS TO BE SELECTED BY ARCHITECT D SIGNS TO BE MOUNTED BESIDE DOORS AT 4'-6" A.F.F. TO CENTER OF SIGN AND 2" FROM EDGE OF DOOR FRAME ON THE STRIKE SIDE U.N.O. THE

INFORMATION AND INTENT ONLY. MECHANICAL, CAMERA - READY ARTWORK SHALL BE SUPPLIED BY

- ARCHITECT SHALL BE CONSULTED BEFORE PLACEMENT OF SIGNAGE FOR LEFTHAND AND RIGHTHAND ORIENTATION OF SIGNS.
- E * = THREE CHARACTER NUMBER TO BE COORDINATED BY SIGN MFR WITH OWNER. F ALL SIGNAGE SHALL MEET REQUIREMENTS OF ADAAG OF THE AMERICANS WITH DISABILITIES ACT
- SIGNS MOUNTED ON GLAZING TO HAVE A MATCHING BLANK ON THE OPPOSITE SIDE OF GLAZING.
- MESSAGE (COPY) TO BE DETERMINED BY OWNER. I SEE SPECIFICATIONS FOR MORE INFO.

FIXTURE/ACCESS. GEN.NOTES

- PROVIDE SOLID FIRE RETARDANT TREATED WOOD BLOCKING AS REQUIRED FOR SUPPORT OF FIXTURES AND ACCESSORIES IN STUD PARTITIONS MAINTAIN PROPER FIRE RATING WHERE MOUNTED
- IN / ON RATED WALLS. EXPOSED WATER SUPPLY AND DRAINPIPES UNDER SINKS AND LAVATORIES SHALL BE INSULATED AND COVERED WITH A RIGID JACKET TO PROTECT AGAINST CONTACT. THERE SHALL BE NO SHARP OR ABRASIVE SURFACES UNDER LAVATORIES AND
- ALL ITEMS SHALL BE MOUNTED TO SPECIFIC POINTS ABOVE FINISH FLOOR SURFACES, LOCATED HORIZONTALLY, AND MAINTAIN CLEARANCES IN ACCORDANCE WITH ALL APPLICABLE
- REQUIREMENTS OF THE AMERICANS WITH DISABILITIES ACT (ADA) AND KBC CHAPTER 11 (ACCESSIBILITY). ALL TOILET PARTITIONS AND DOORS SHALL BE SOLID PHENOLIC, U.N.O. MINIMUM 3/4" THICK PANELS ON ALL WALLS, DOORS AND DIVIDER PANELS -
- FLOOR MOUNTED WITH OVERHEAD BRACED TOP RAILS, U.N.O. COLOR TO BE SELECTED BY ARCHITECT. 36" WIDE ACCESSIBLE STALL DOORS, 34" WIDE AMBULATORY STALL DOORS, 24" WIDE STANDARD STALL DOORS TYP, 12" A.F.F. TO BOTTOM, U.N.O. CONTRACTOR TO PROVIDE BLOCKING AS REQUIRED FOR PARTITION INSTALLATION.
- TOILET ROOM ACCESSORIES SHALL BE ASI OR AS NOTED AND REPRESENT THE LEVEL OF QUALITY SEE MECHANICAL, PLUMBING AND ELECTRICAL
- DRAWINGS AND SPECIFICATIONS FOR ALL REQUIREMENTS PERTAINING TO PLUMBING FIXTURES AND CONTROLS. SEE FIXTURE/ACCESSORY MOUNTING & ACCESSIBLE
- FLOOR SPACES DIAGRAMS FOR ADDITIONAL MOUNTING AND LAYOUT DIMENSION INFORMATION. SEE FLOOR PLANS FOR INFORMATION NOT SHOWN SEE FINISH SCHEDULE FOR FLOOR, BASE & WALL
- ALL ITEMS ARE (N) U.N.O.

GENERAL SYMBOLS WALL TYPE, SEE A0.1

SHEET KEYNOTES ROOM NUMBER, SEE FLOOR PLANS WINDOW TYPE, SEE A7.1

(-) DOOR TYPE, SEE A7.1 PLUMBING/ACCESSORY TYPE, SEE A2.1 BID ALTERNATE, SEE A0.0

BUILDING ELEVATION, SEE A3.1-A3.2 BUILDING OR WALL SECTION, SEE A4.1-A4.3 DETAIL OR ENLARGED PLAN

- - - INTERIOR ELEVATION, SEE A10.1 — ELEVATION MARK

WALL FIRE RATING DESIGNATION: SEE A0.2 & SECTIONS FOR RATED CONST. LOCATIONS & UL ASSEMBLIES SP -----SMOKE PARTITION

FP1)1 HOUR FIRE RATING (FP = FIRE PARTITION) FB2 --- 2 HOUR FIRE RATING (FB = FIRE BARRIER) $-\cdots$ FW3)3 HOUR FIRE RATING (FW = FIRE WALL)

PROJECT NAME

HENRY CLAY HS

SOFTBALL FIELD

integrity ARCHITECTURE

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Lexington, KY 40509

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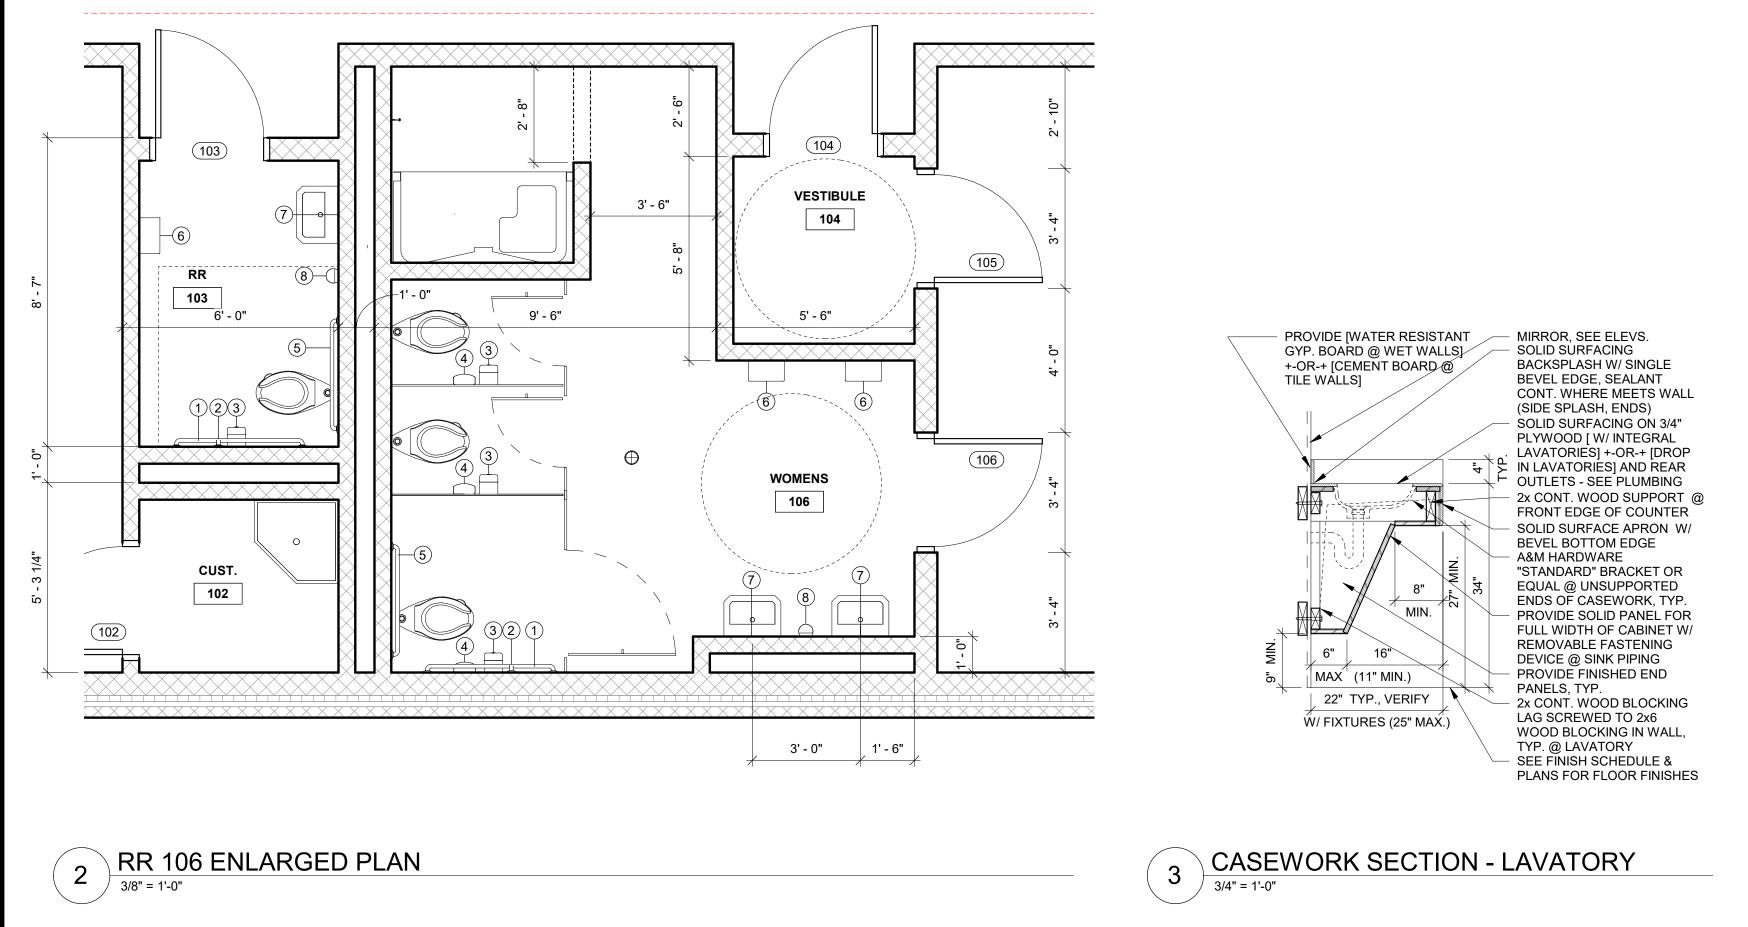
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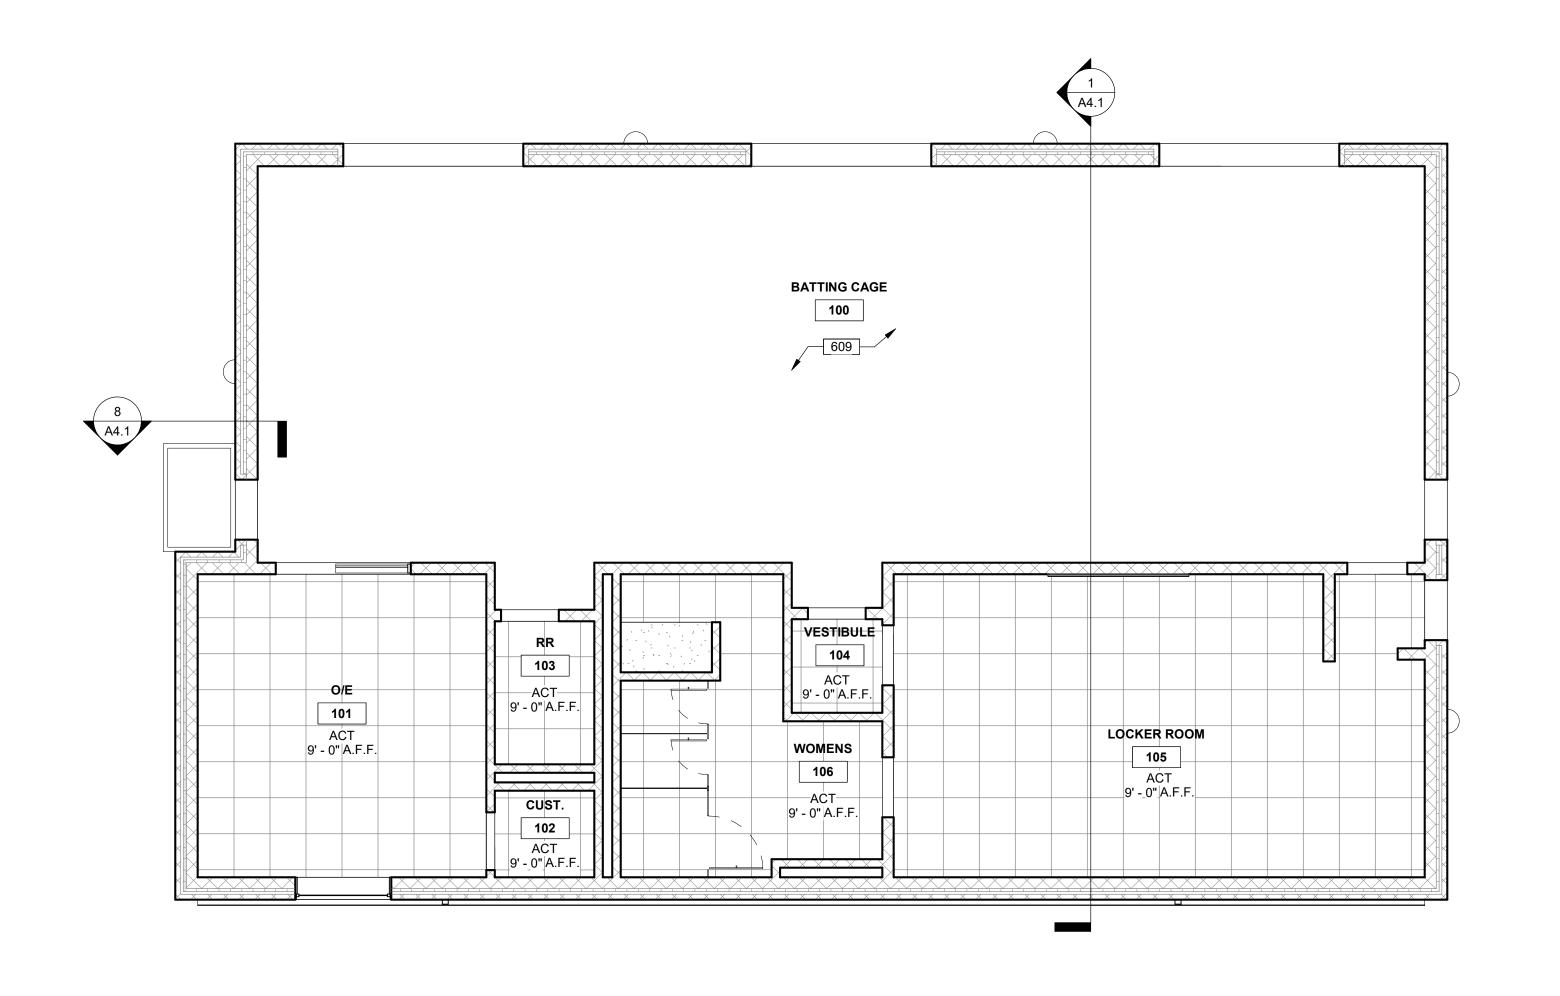
SHEET NAME FLOOR PLAN


DATE Mon DD, YYYY **REVISIONS**


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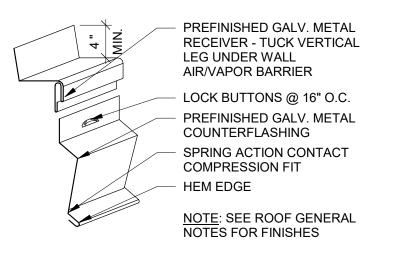
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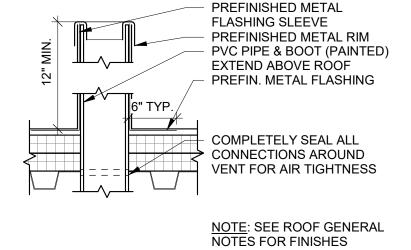









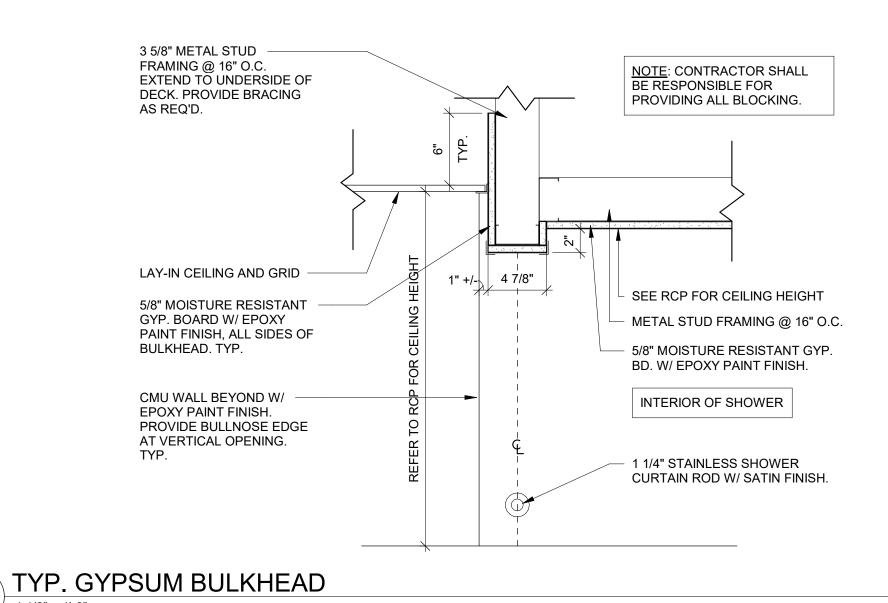

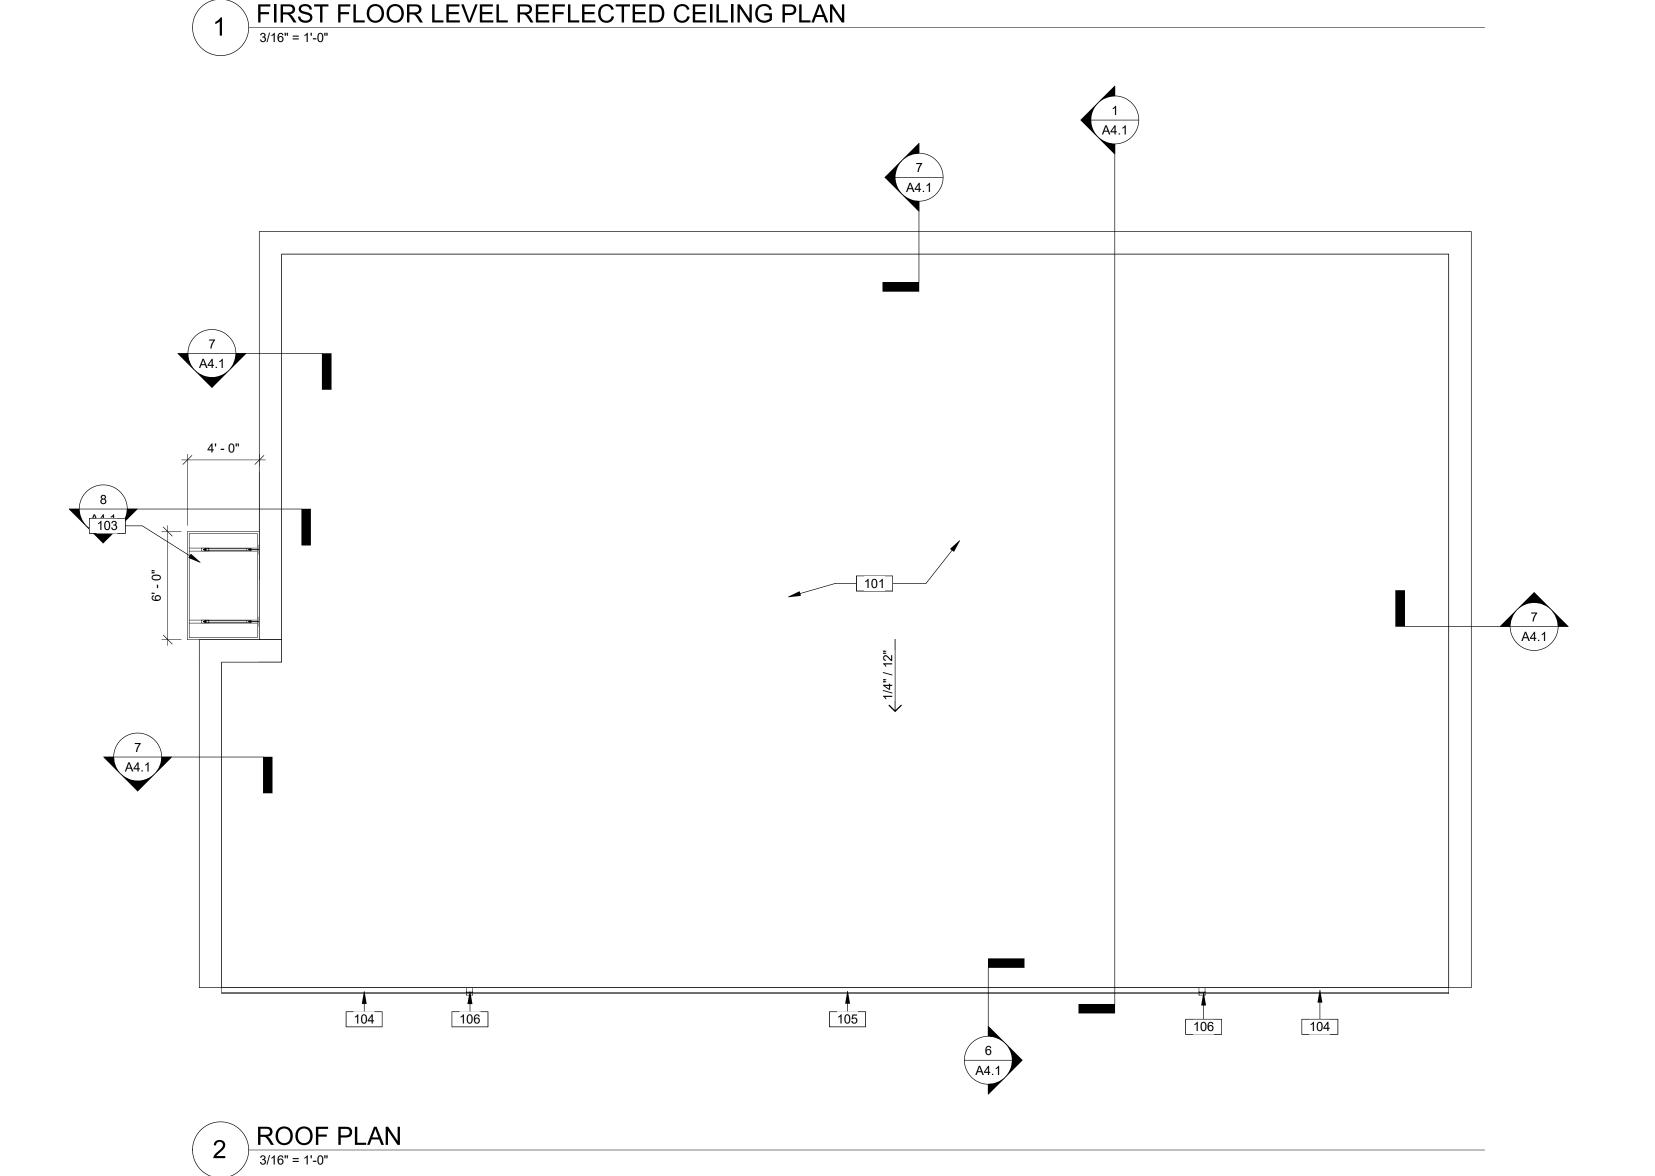




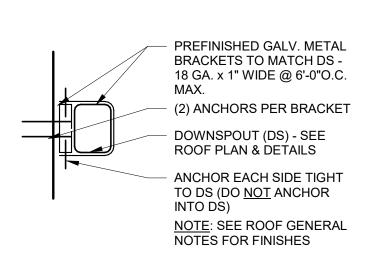



TYP. VENT THRU FLAT ROOF 1 1/2" = 1'-0"

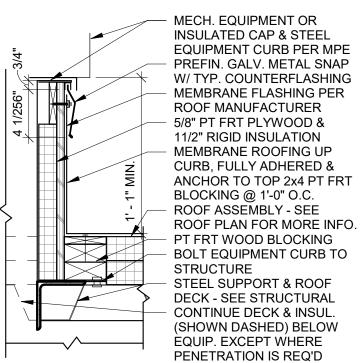

NOTE: SEE ROOF GENERAL NOTES FOR FINISHES

TYP. MECH EQUIPMENT CURB

RCP GENERAL NOTES

- A SEE FLOOR PLANS AND PARTITION TYPES FOR EXTENT OF GYPSUM BOARD ABOVE FINISHED
- B FINISHED VERTICAL FACES OF SOFFITS AND BULKHEADS SHALL ALIGN W/ FINISHED VERTICAL FACES OF ADJACENT PARTITIONS WHERE APPLICABLE U.N.O.
- CEILING GRIDS OR PANELS ARE CENTERED ON TH PRIMARY SPACE, ROOM OR CORRIDOR AS INDICATED U.N.O. BY DIMENSION OR ALIGNMENT W
- WALL OR SOFFIT. PROVIDE HOLD-DOWN CLIPS FOR CEILING PANELS AT COMMERCIAL KITCHEN AREAS AND WITHIN 10'-0
- OF AN EXTERIOR DOOR. SEE WALL SECTIONS AND OTHER DETAILS FOR CEILING CONDITIONS AND ADDITIONAL REQUIREMENTS AT EXTERIOR WALLS OF BUILDING OR SPECIFIC LOCATION NOT INDICATED ON REFERENCED TYPICAL DETAILS. GYPSUM BOARD CONTROL JOINTS SHALL BE PROVIDED AS INDICATED ON DRAWINGS AND AT 30'-0" MAX. INTERVALS, AT EACH CHANGE OF DIRECTION, AND AS OTHERWISE REQUIRED BY SPECIFICATIONS OR INDUSTRY STANDARDS. COORDINATE LOCATIONS WITH ARCHITECT PRIOR TO INSTALLATION.
- VERTICAL STUD SOFFIT FRAMING SHALL EXTEND AND BE ANCHORED TO THE UNDERSIDE OF STRUCTURE OR FRAMING ATTACHED TO STRUCTURE, TYP. U.N.O.
- SEE MPEF PLANS FOR ITEMS NOT SHOWN ON ARCHITECTURAL REFLECTED CEILING PLANS (E.G. SPEAKERS, EMERGENCY LIGHTING, EXT. LIGHTING,
- WHERE LIGHTING, ELECTRICAL WIRING OR HVAC EQUIPMENT IS PRESENT IN AREAS OF ACCESS PANELS, CONTRACTOR TO COORDINATE SLACK IN WIRING AND DUCT WORK.
- CEILING HEIGHTS LISTED ABOVE FINISH FLOOR ASSUMED ELEVATION OF 0'-0". WHERE A SPACE HAS VARIED FINISHED FLOOR LEVELS, THE HEIGHT OF CEILING IS ABOVE THE HIGHEST FINISHED FLOOR ELEVATION IN THE SPACE. SEE SECTIONS AND FLOOR PLANS FOR VARIED FINISHED FLOOR LEVEL

RCP KEYNOTES

609 PAINT EXPOSED CEILING - [SEE ROOM FINISH SCHEDULE FOR MORE INFO] +-or-+ [INCLUDES STRUCTURE, DECK, INSULATION, EQUIPMENT, DUCTWORK, PIPING, CONDUIT, ETC. U.N.O. PROTECT / DO NOT PAINT DATA LINES & SPRINKLER HEADS. COLOR SELECTED BY ARCHITECT].

ROOF PLAN GENERAL NOTES

- A ROOFING SYSTEM SHALL INCLUDE ALL MATERIALS AND ASSEMBLIES AS REQUIRED TO ACHIEVE THE MANUFACTURER'S SPECIFIED WARRANTY FOR A WEATHERPROOF AND WATERTIGHT SYSTEM. MATERIALS AND ASSEMBLIES REQUIRED BY THE MANUFACTURER MAY INCLUDE, BUT ARE NOT LIMITED TO, MISC. FLASHING, VAPOR RETARDER, ROOF VENTING SYSTEMS, AND EXPANSION JOINT SYSTEMS.
- ROOF SLOPES SHALL CONFORM TO THE SPECIFIC SLOPES INDICATED. WHERE NO SPECIFIC SLOPES ARE INDICATED, SUCH SLOPES SHALL BE CONFIGURED TO PRODUCE THE GEOMETRY SHOWN, WITHOUT PONDING. GUTTERS AND DOWNSPOUTS SHALL BE
- REQUIRED BY LOCAL CODES AND JURISDICTION. CONTRACTOR TO COORDINATE INSTALLATION OF
- ROOFING / FLASHING W/ OTHER TRADES FOR ADDITIONAL WORK REQUIRED (E.G.: FLASHING OF EQUIPMENT CURBS).
- ADDITIONAL NOTES. SEE WALL SECTIONS & DETAILS FOR BEARING HEIGHTS.
- F EXTERIOR SHEET METAL COPINGS, FLASHING AND TRIM SHALL BE PREFINISHED GALV. SHEET METAL ARCHITECT TO SELECT EXTERIOR FINISHES AND

SEE FLOOR PLANS, ELEVATIONS & SECTIONS FOR

- COLORS. PHYSICAL SAMPLES OF EXTERIOR FINISHES SHALL BE SUBMITTED SIMULTANEOUSLY TO COMPARE AND REVIEW ALL FINISHES TOGETHER
- NOT ALL PENETRATIONS, UTILITY LINES, VENTS AND EQUIPMENT MAY BE SHOWN ON ROOF PLAN. MAINTAIN MIN. 36" BETWEEN ALL ROOF PENETRATIONS AND ADJACENT EAVES, HIPS,

ROOF PLAN KEYNOTES

- 101 FULLY-ADHERED SINGLE PLY REFLECTIVE WHITE TPO MEMBRANE ROOFING SYSTEM (60 mil THICKNESS, 20 YEAR WARRANTY, FIRESTONE ULTRAPLY BASIS OF DESIGN) ON (2) STAGGERED LAYERS OF 2" CONTINUOUS RIGID INSULATION (MIN R-25) W/ SOLID FRT BLOCKING WHERE REQUIRED. SLOPE TO DRAIN, SEE WALL SECTIONS &
- STRUCTURAL FOR ROOF FRAMING & DECKING. 103 PRE-ENGINEERED ALUMINUM CANOPY W/ INTEGRAL GUTTERS, SOFFIT PANELS, CONNECTIONS & HANGER RODS BY MANUF. (MAPES CANOPY SUPER LUMIDECK FLAT SOFFIT BASIS OF DESIGN) - SEE WALL SECTIONS & DETAILS. ALIGN HANGER RODS A NOTED OR AS REQUIRED BY MANUF. U.N.O. DESIGN BY MANUFACTURER - SHOWN FOR COORDINATION PURPOSES ONLY. USE HOLLOW BOLT OR
- EQUIVALENT @ BLIND CONNECTIONS, TYP. 104 PREFINISHED GALV. METAL GUTTER, 24 GA. U.N.O., CLOSE ENDS OF GUTTER SOLID - SEE DETAIL [?/??]. 105 1" GUTTER EXPANSION JOINT AT 45' MAX. SPACING OR REQUIRED BY MANUFACTURER, TYP. FOR REFERENCE ONLY - CONTRACTOR TO FIELD VERIFY
- ACTUAL LOCATIONS. 106 PREFINISHED GALV. METAL DOWNSPOUT (DS) -CONTRACTOR TO FIELD VERIFY ACTUAL LOCATIONS SEE CIVIL FOR CONTINUATION, SEE DETAIL [?/??]

GENERAL SYMBOLS

ROOM NUMBER, SEE FLOOR PLANS

WALL TYPE, SEE A0.1

WINDOW TYPE, SEE A7.1

DETAIL OR ENLARGED PLAN

- - - INTERIOR ELEVATION, SEE A10.1

FW3 3 HOUR FIRE RATING (FW = FIRE WALL)

ELEVATION MARK

DOOR TYPE, SEE A7.1

SHEET KEYNOTES

-

FOR ATTACHMENT.

SHEET NAME RCP, ROOF PLAN AND DETAILS

PROJECT NAME

HOUSE

KY 40502

HENRY CLAY HS

SOFTBALL FIELD

PROJECT ADDRESS

2100 Fontaine Rd, Lexington

DATE Mon DD, YYYY


REVISIONS


PLUMBING/ACCESSORY TYPE, SEE A2.1 NO. DESCRIPTION DATE BID ALTERNATE, SEE A0.0 BUILDING ELEVATION, SEE A3.1-A3.2 BUILDING OR WALL SECTION, SEE A4.1-A4.3


WALL FIRE RATING DESIGNATION: SEE A0.2 & SECTIONS FOR RATED CONST. LOCATIONS & UL ASSEMBLIES SHEET NUMBER


SP -----SMOKE PARTITION FP1)1 HOUR FIRE RATING (FP = FIRE PARTITION) (FB2) 2 HOUR FIRE RATING (FB = FIRE BARRIER)

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WEST ELEVATION

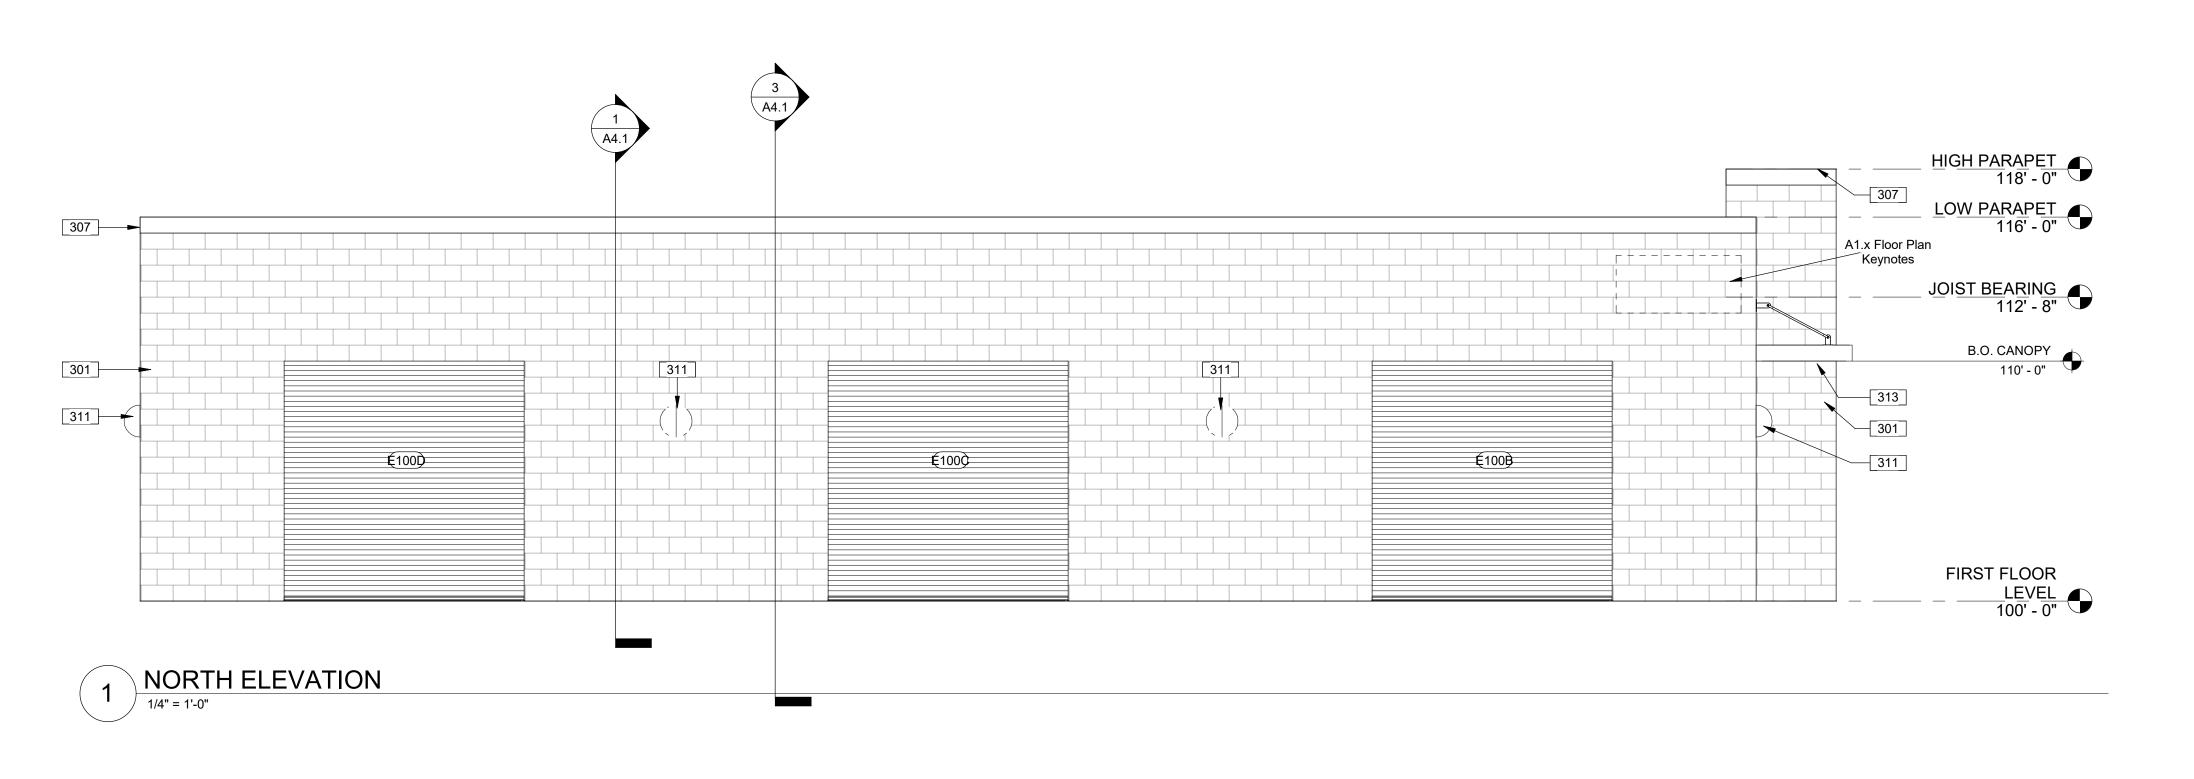ELEVATION GENERAL NOTES

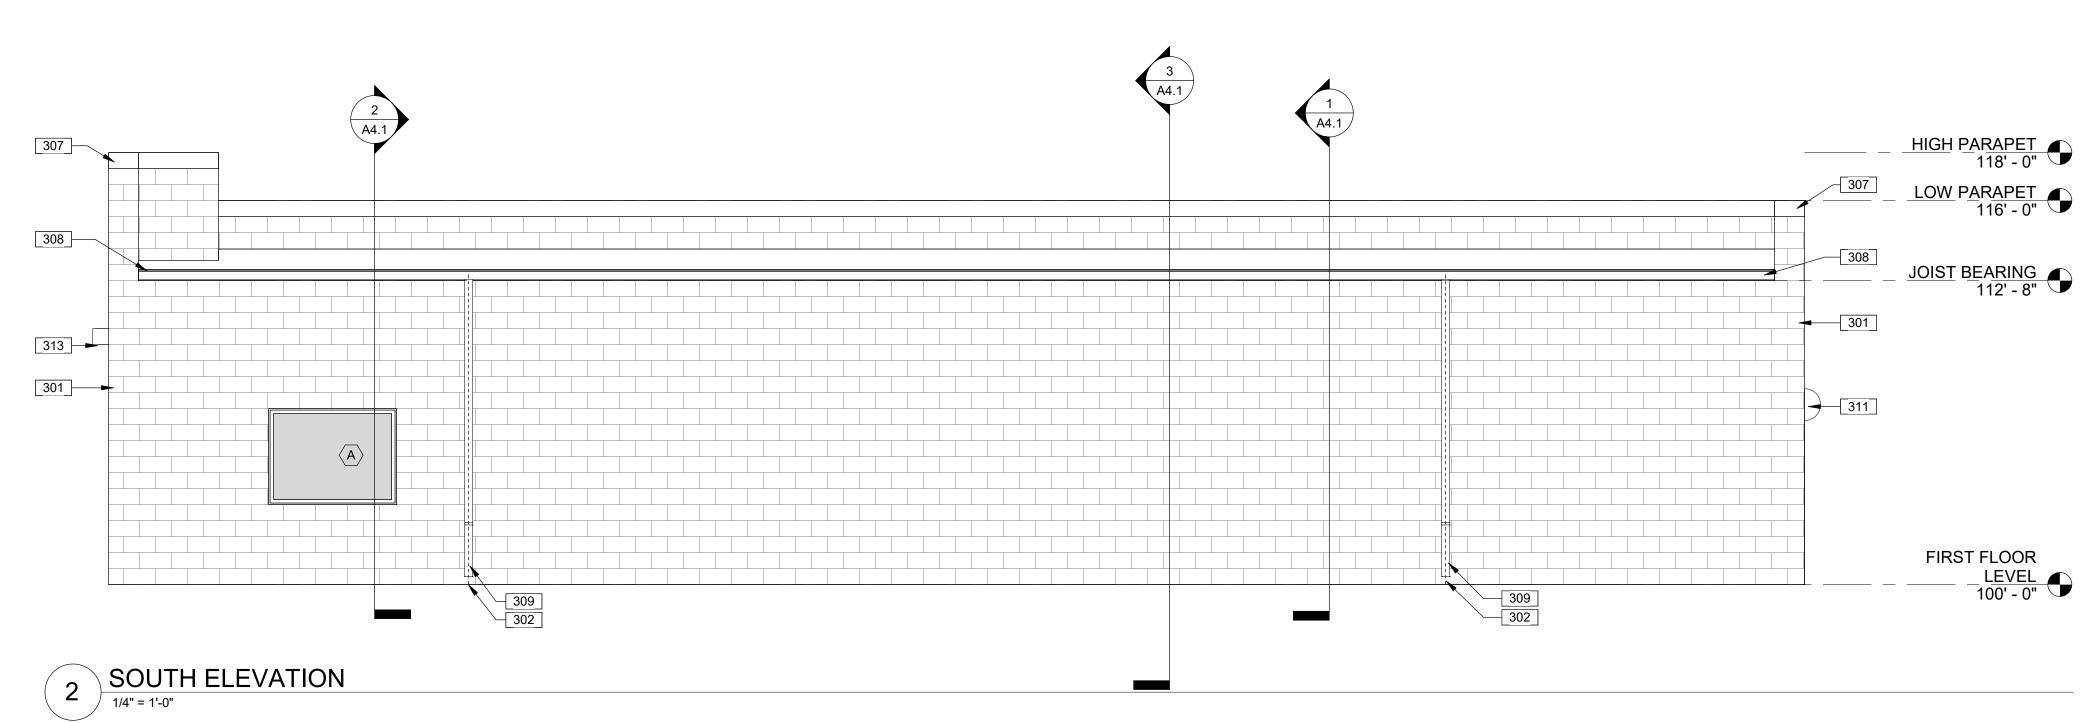- A VERTICAL DIMENSIONS SHOWN ON BUILDING ELEVATIONS APPLY TO OTHER ELEVATIONS WHERE SHOWN U.N.O. B LINES REPRESENTING PAVING AND FINISH GRADES ARE SHOWN FOR REFERENCE PURPOSES ONLY.
- REFER TO SITE PLANS FOR SPECIFIC GRADE AND SPOT ELEVATIONS. REFER TO FLOOR PLANS FOR LOCATIONS OF OPENINGS. REFER TO DOOR, WINDOW AND FRAME SCHEDULES FOR FULL EXTENT OF AND COMPLETE DESCRIPTION OF DOOR, WINDOW AND FRAME
- TYPES. PORTION OF DOORS, WINDOWS, STOREFRONTS, AND CURTAIN WALLS MAY BE CONCEALED BY OTHER BUILDING FEATURES D MASONRY & DOOR / WINDOW CONTRACTORS SHALL
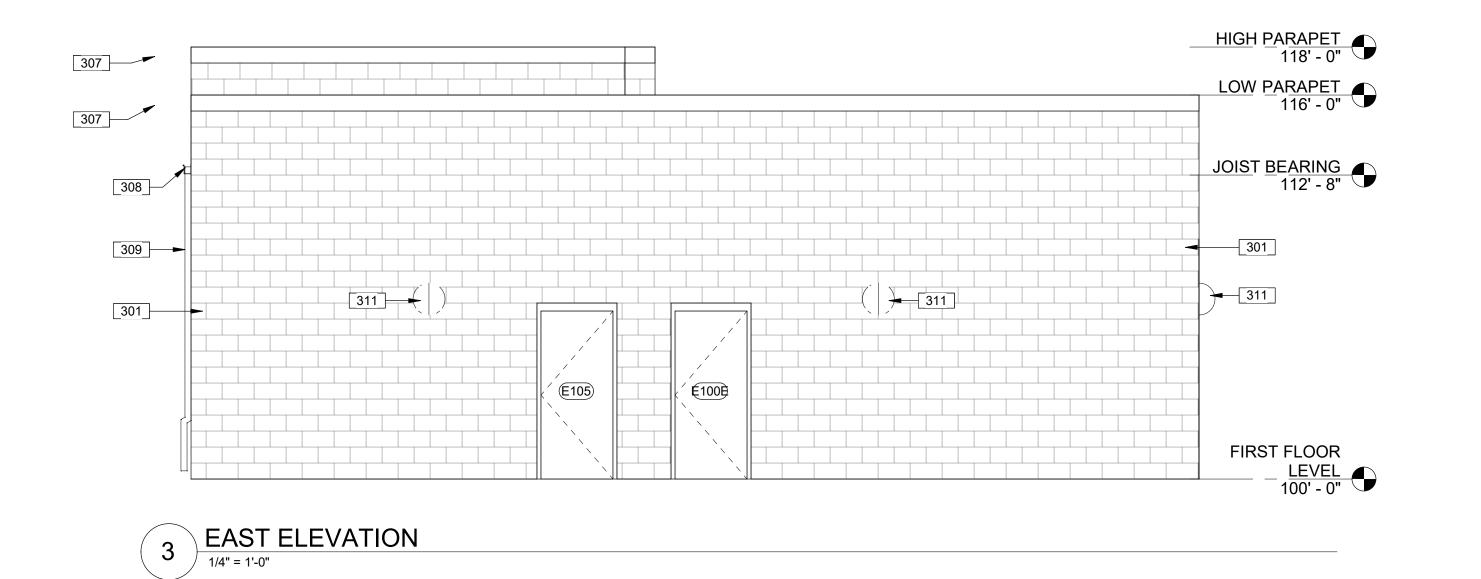
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- COORDINATE OPENING SIZES AS SHOWN; PROVIDE DIMENSIONS ON SHOP DRAWINGS FOR VERIFICATION. E EXPOSED EXTERIOR SHEET METAL COPINGS AND
- TRIM SHALL BE PREFINISHED GALV. SHEET METAL EXPOSED SEALANT IN MASONRY & MASONRY JOINTS SHALL MATCH THE COLOR OF ADJACENT MASONRY.
- PROVIDE SEALANT IN LIEU OF MORTAR AT MASONRY LINTEL BEARING LOCATIONS WHERE MASONRY JOINT DEPTH IS LESS THAN 1". G EXPOSED EXTERIOR MASONRY SHALL RECEIVE
- WATER REPELLENT SEE SPECIFICATIONS. H CONTRACTORS (INCL. MASONRY, STONE & SIDING) SHALL COORDINATE LOCATIONS OF EXTERIOR ELECTRICAL OUTLETS, LIGHT FIXTURES, DOOR OPERATORS, HOSE BIBS, ETC. WHERE REQUIRED SUCH ITEMS SHALL BE CAST IN OR PLACED BY RESPONSIBLE TRADE. NOT ALL SUCH ITEMS MAY BI SHOWN ON ELEVATIONS.
- PROVIDE EXPANSION JOINTS AT BUILDING CORNERS U.N.O. ON BUILDING ELEVATIONS. PROVIDE MASONRY EXPANSION JOINTS AT INTERIOR BUILDING CORNERS, ADJACENT TO EXTERIOR BUILDING CORNERS (MAX. 4'-0" FROM CORNER) AND AT EVERY 25'-0" U.N.O. ON BUILDING ELEVATIONS. ARCHITECT TO SELECT EXTERIOR FINISHES AND COLORS. PHYSICAL SAMPLES OF EXTERIOR FINISHES SHALL BE SUBMITTED SIMULTANEOUSLY TO COMPARE AND REVIEW ALL FINISHES TOGETHER
- K SEE FLOOR PLAN, SECTIONS, DETAILS & WALL TYPES FOR ADDITIONAL MATERIAL INFORMATION. SEE ROOF PLAN & DETAILS FOR ADDITIONAL ROOFING AND ROOF DRAINAGE INFORMATION. SEE WALL SECTIONS & STRUCTURAL FOR BEARING MPE ITEMS SHOWN FOR REFERENCE ONLY - SEE MPE DRAWINGS FOR MORE INFORMATION.

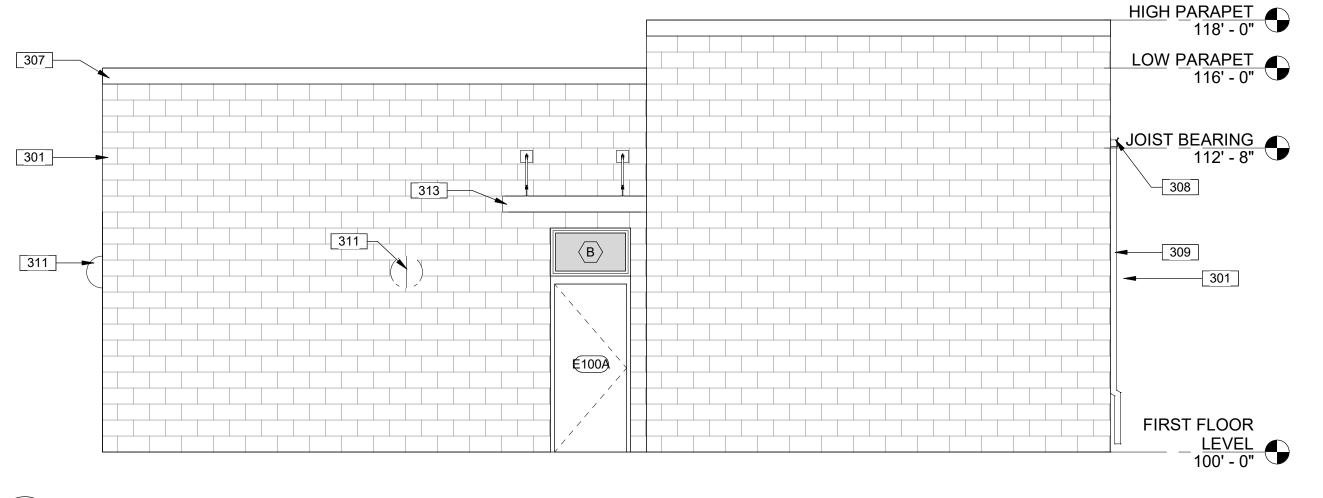ELEVATION KEYNOTES

- 301 8" (NOMINAL) CMU (SEALED AND PAINTED) SEE STRUCTURAL. 302 MASONRY EXPANSION JOINT - OMIT MORTAR AND HORIZ. REINFORCING, FILL WITH 50% COMPOSITE FOAM CAULK. AT STONE BANDS AND TRIM, USE FLUSH 3/8" VERTICAL EXPANSION JOINTS W/ SQUARE EDGE AND SEALANT FLUSH WITH FRONT OF STONE. USE CONCAVE 3/8" VERTICAL EXPANSION JOINTS WHERE PORTIONS OF SUCH JOINTS FORM A VISIBLE PART OF THE STONE JOINT PATTERN. JOINT
- 307 PREFINISHED GALVANIZED METAL COPING[, COLOR TO MATCH WALL] +-or-+ PREFINISHED METAL FASCIA WRAP - SEE ROOF PLAN, DETAILS AND WALL SECTIONS.

LOCATIONS MUST BE APPROVED BY ARCHITECT.

- 308 GUTTER[, COLOR TO MATCH WALL] SEE ROOF 309 DOWNSPOUT (DS)[, COLOR TO MATCH WALL] - SEE ROOF PLAN. PROVIDE CAST IRON DS BOOT, PAINT TO MATCH DS & CONNECT TO SUBSURFACE DRAINAGE - SEE CIVIL FOR CONTINUATION.
- 311 WALL MOUNTED LIGHT SEE ELECTRICAL FOR FIXTURE INFO & MOUNTING HEIGHT, PROVIDE ADA COMPLIANT FIXTURE WHERE MOUNTED 6'-8" OR LOWER ABOVE WALKING SURFACE. PROVIDE FRT BLOCKING FOR SUPPORT. CENTER BETWEEN OPENINGS / ON WALL U.N.O.

313 PREFINISHED ALUMNINUM HANGER CANOPY W/

PROJECT NAME HENRY CLAY HS SOFTBALL FIELD HOUSE

PROJECT ADDRESS 2100 Fontaine Rd, Lexington KY 40502

SHEET NAME BUILDING **ELEVATIONS**

Mon DD, YYYY

SHEET KEYNOTES ROOM NUMBER, SEE FLOOR PLANS WINDOW TYPE, SEE A7.1 DATE DOOR TYPE, SEE A7.1 REVISIONS PLUMBING/ACCESSORY TYPE, SEE A2.1 NO. DESCRIPTION DATE BID ALTERNATE, SEE A0.0

BUILDING ELEVATION, SEE A3.1-A3.2 BUILDING OR WALL SECTION, SEE A4.1-A4.3 DETAIL OR ENLARGED PLAN - - INTERIOR ELEVATION, SEE A10.1

GENERAL SYMBOLS

WALL TYPE, SEE A0.1

-

ELEVATION MARK WALL FIRE RATING DESIGNATION: SEE A0.2 & SECTIONS FOR RATED CONST. LOCATIONS & UL ASSEMBLIES

SP SMOKE PARTITION FP1)1 HOUR FIRE RATING (FP = FIRE PARTITION) 2 HOUR FIRE RATING (FB = FIRE BARRIER)

FW3 3 HOUR FIRE RATING (FW = FIRE WALL)

SHEET NUMBER