ESTILL COUNTY SAFETY & ADA UPGRADES

Irvine, Kentucky

1A1.2 SECOND FLOOR PLAN

1E0.1 ELECTRICAL LEGENDS AND GENERAL N

1E1.1 ESTILL CO MIDDLE SCHOOL POWER &
LOW-VOLTAGE PLAN

| rosstarrant | architect

for the

Estill County Board of Education 253 Main St, Irvine, Kentucky 40336 p 606.723.2181 BG # 23-087 RTA # 2253

VOLUME 1
Estill County Middle School



101 old lafayette avenue lexington, kentucky 40502 p 859.254.4018 www.rosstarrant.com

1000 South Irvine

Irvine, Ky 40336

enhancing education through great design

MEP ENGINEER:

KFI ENGINEERS
3264 Lochness Dr.
p 859.271.3246

Lexington, KY 40517

HARDWARE CONSULTANT:

CALVERT INDEPENDENT HARDWARE SPECIFICATIONS, LLC 307 Oakwood Circle Vine Grove, Kentucky 40175 p 502.930.2039

VICINITY MAP

Fill Configuration of the Script of the Scri

PROJECT SITE ADDRESS:

Road

51 Patriot Drive,

Irvine, KY 40336

SITE

PROJECT VICINITY MAP

ESTILL COUNTY

 BG#
 23-087

 Project No:
 2253

 Drawn By:
 SW / JR

 Rev'd By:
 RB / PF / DS

 SHEET RELEASE

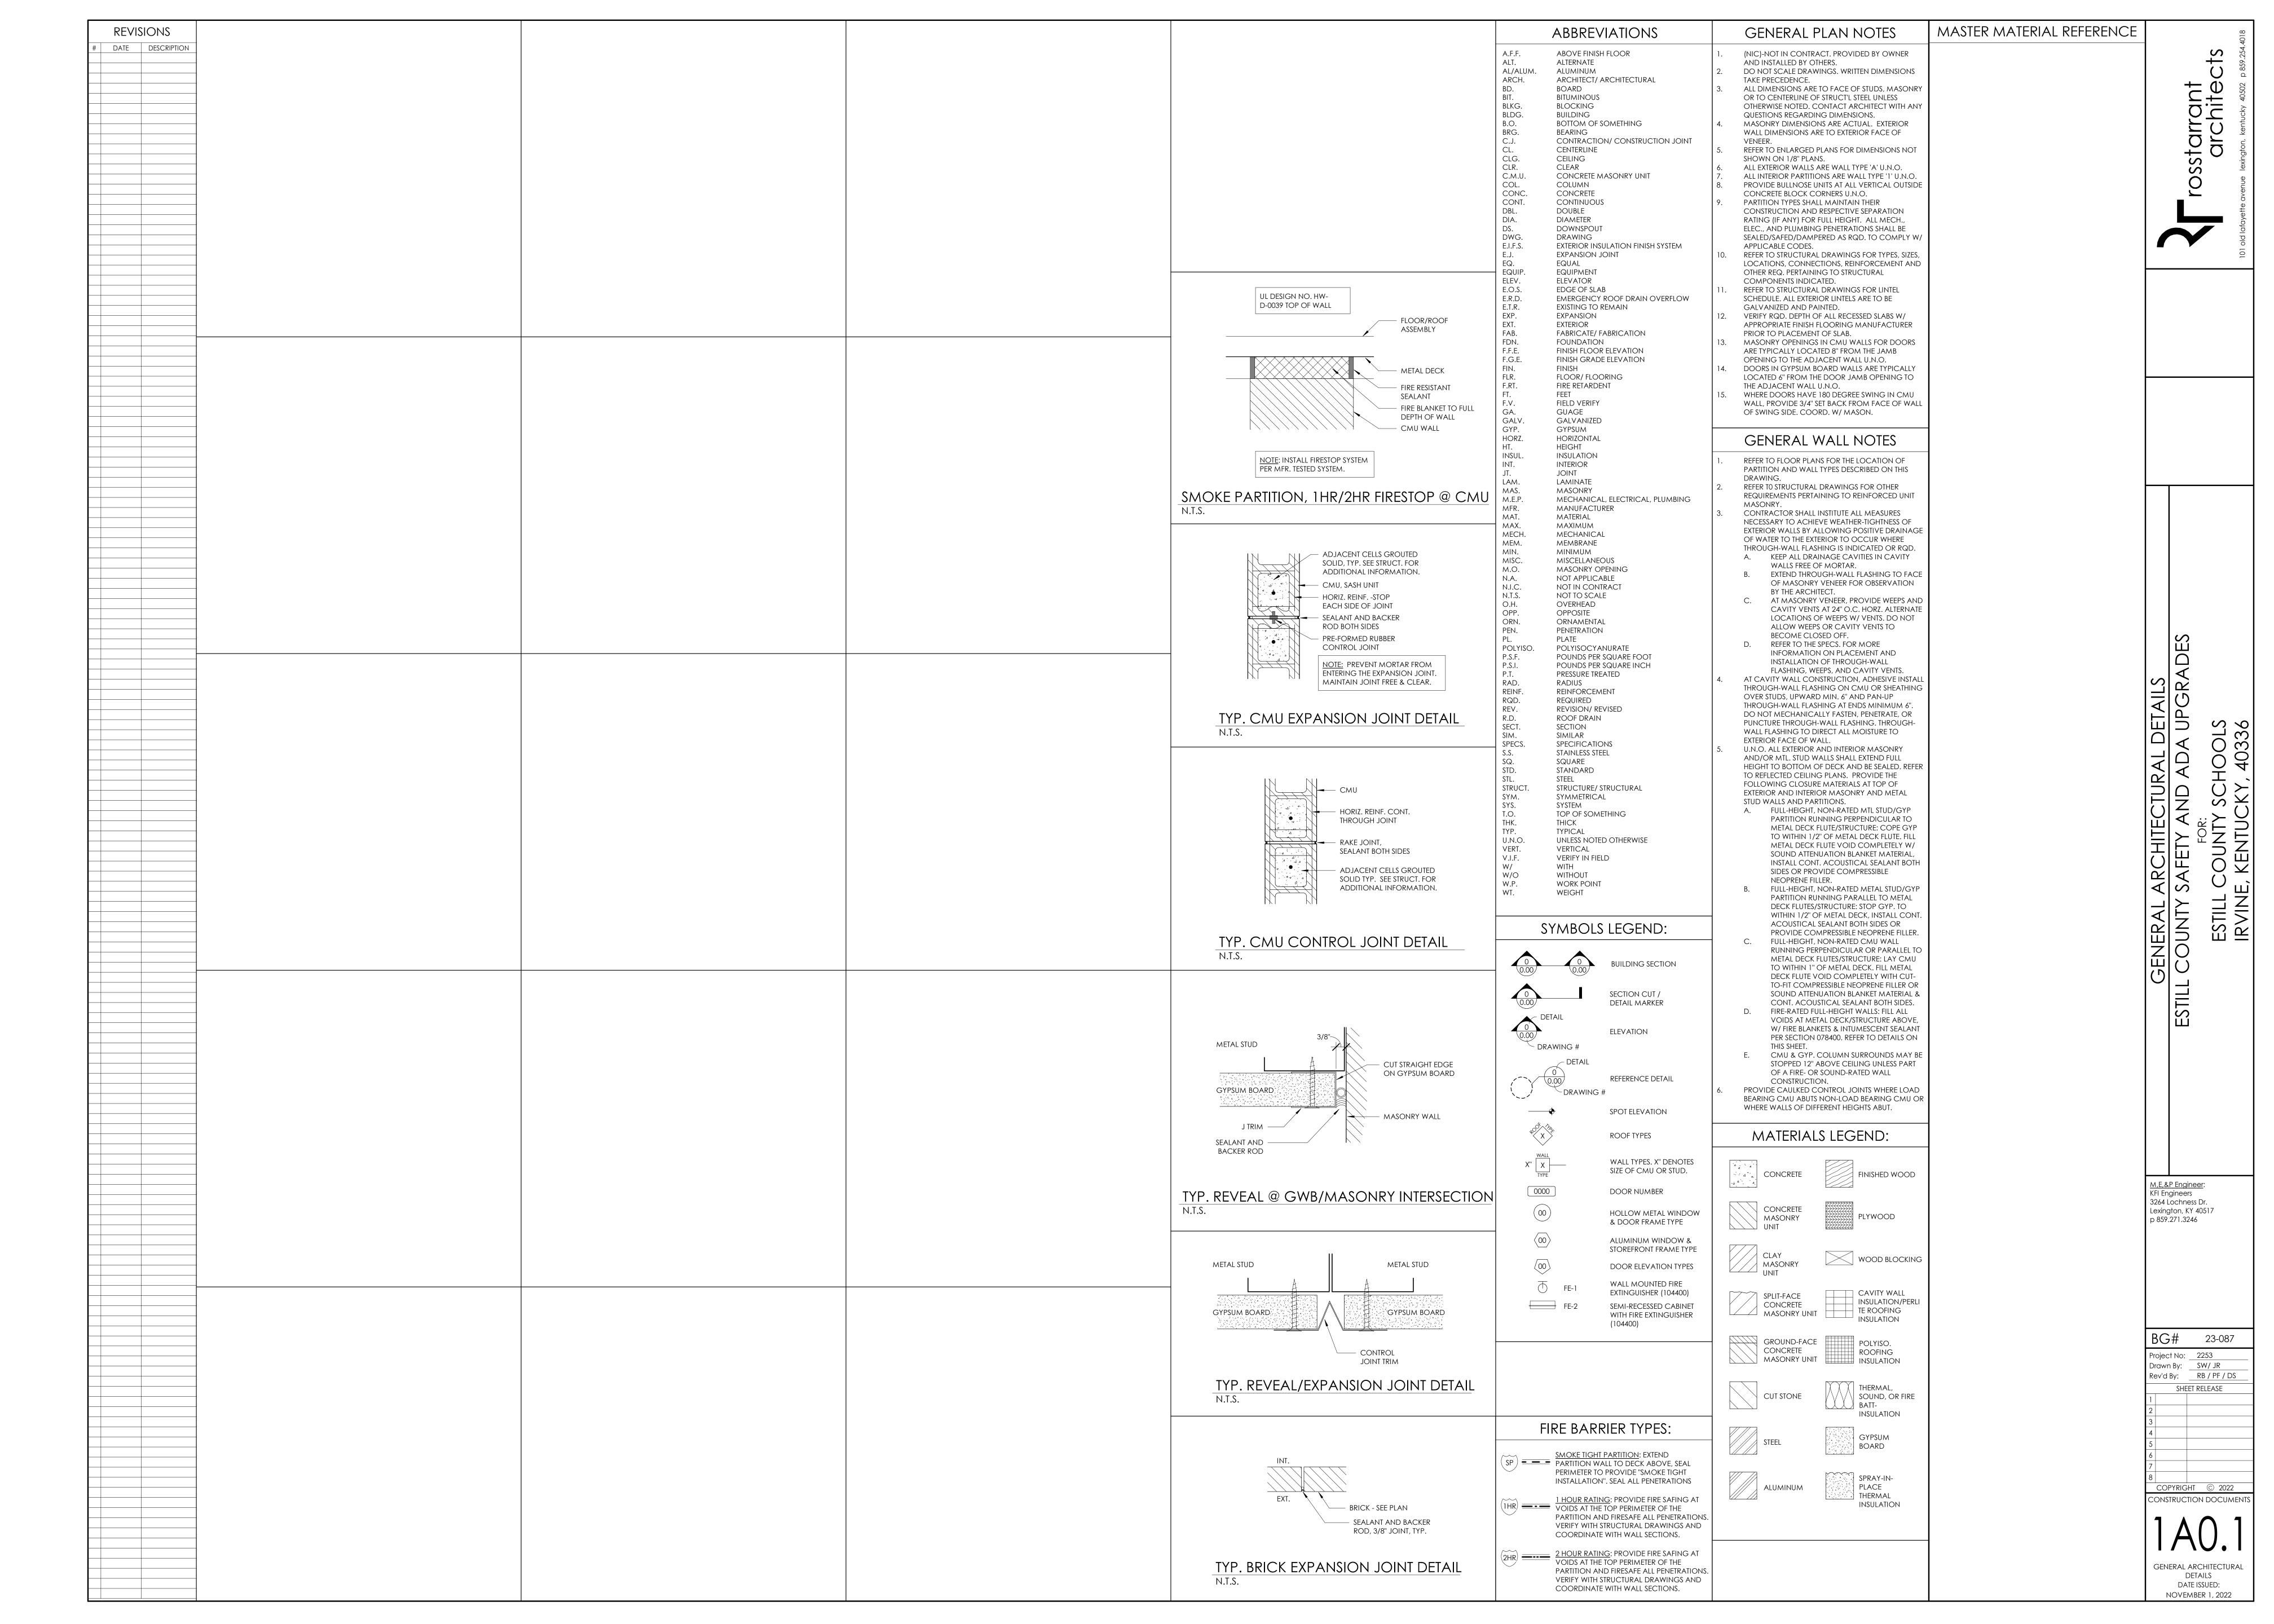
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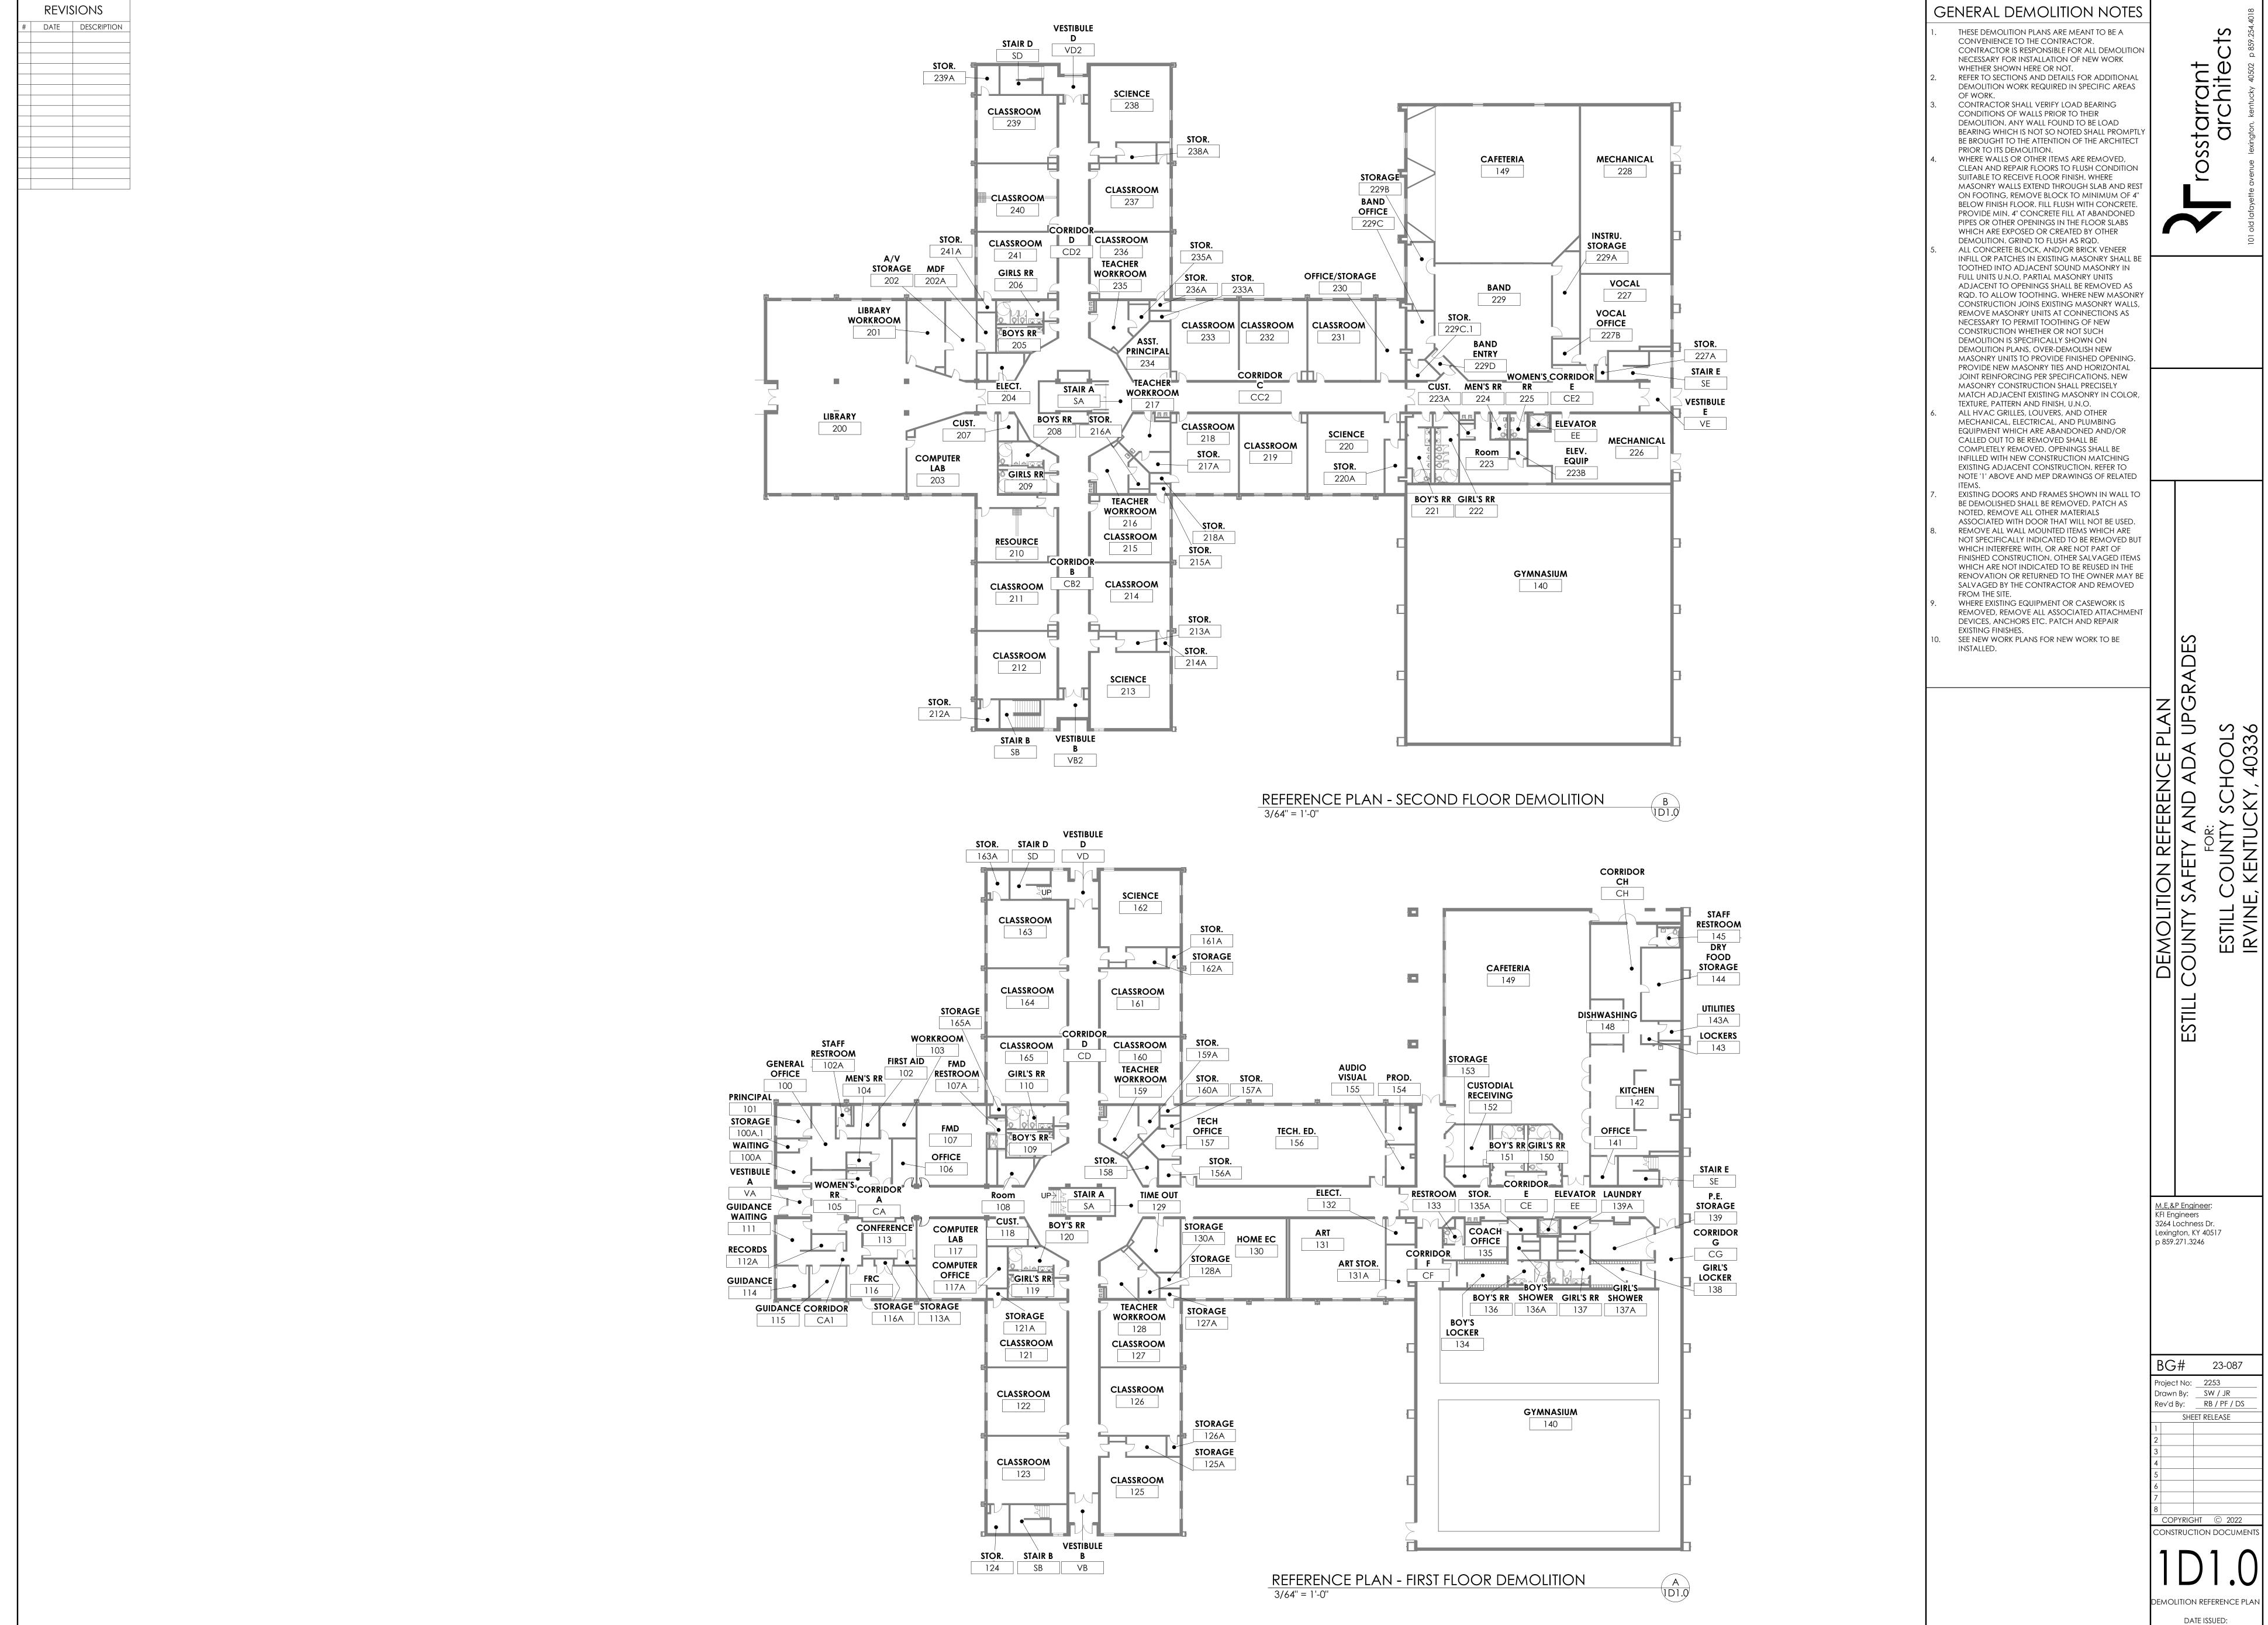
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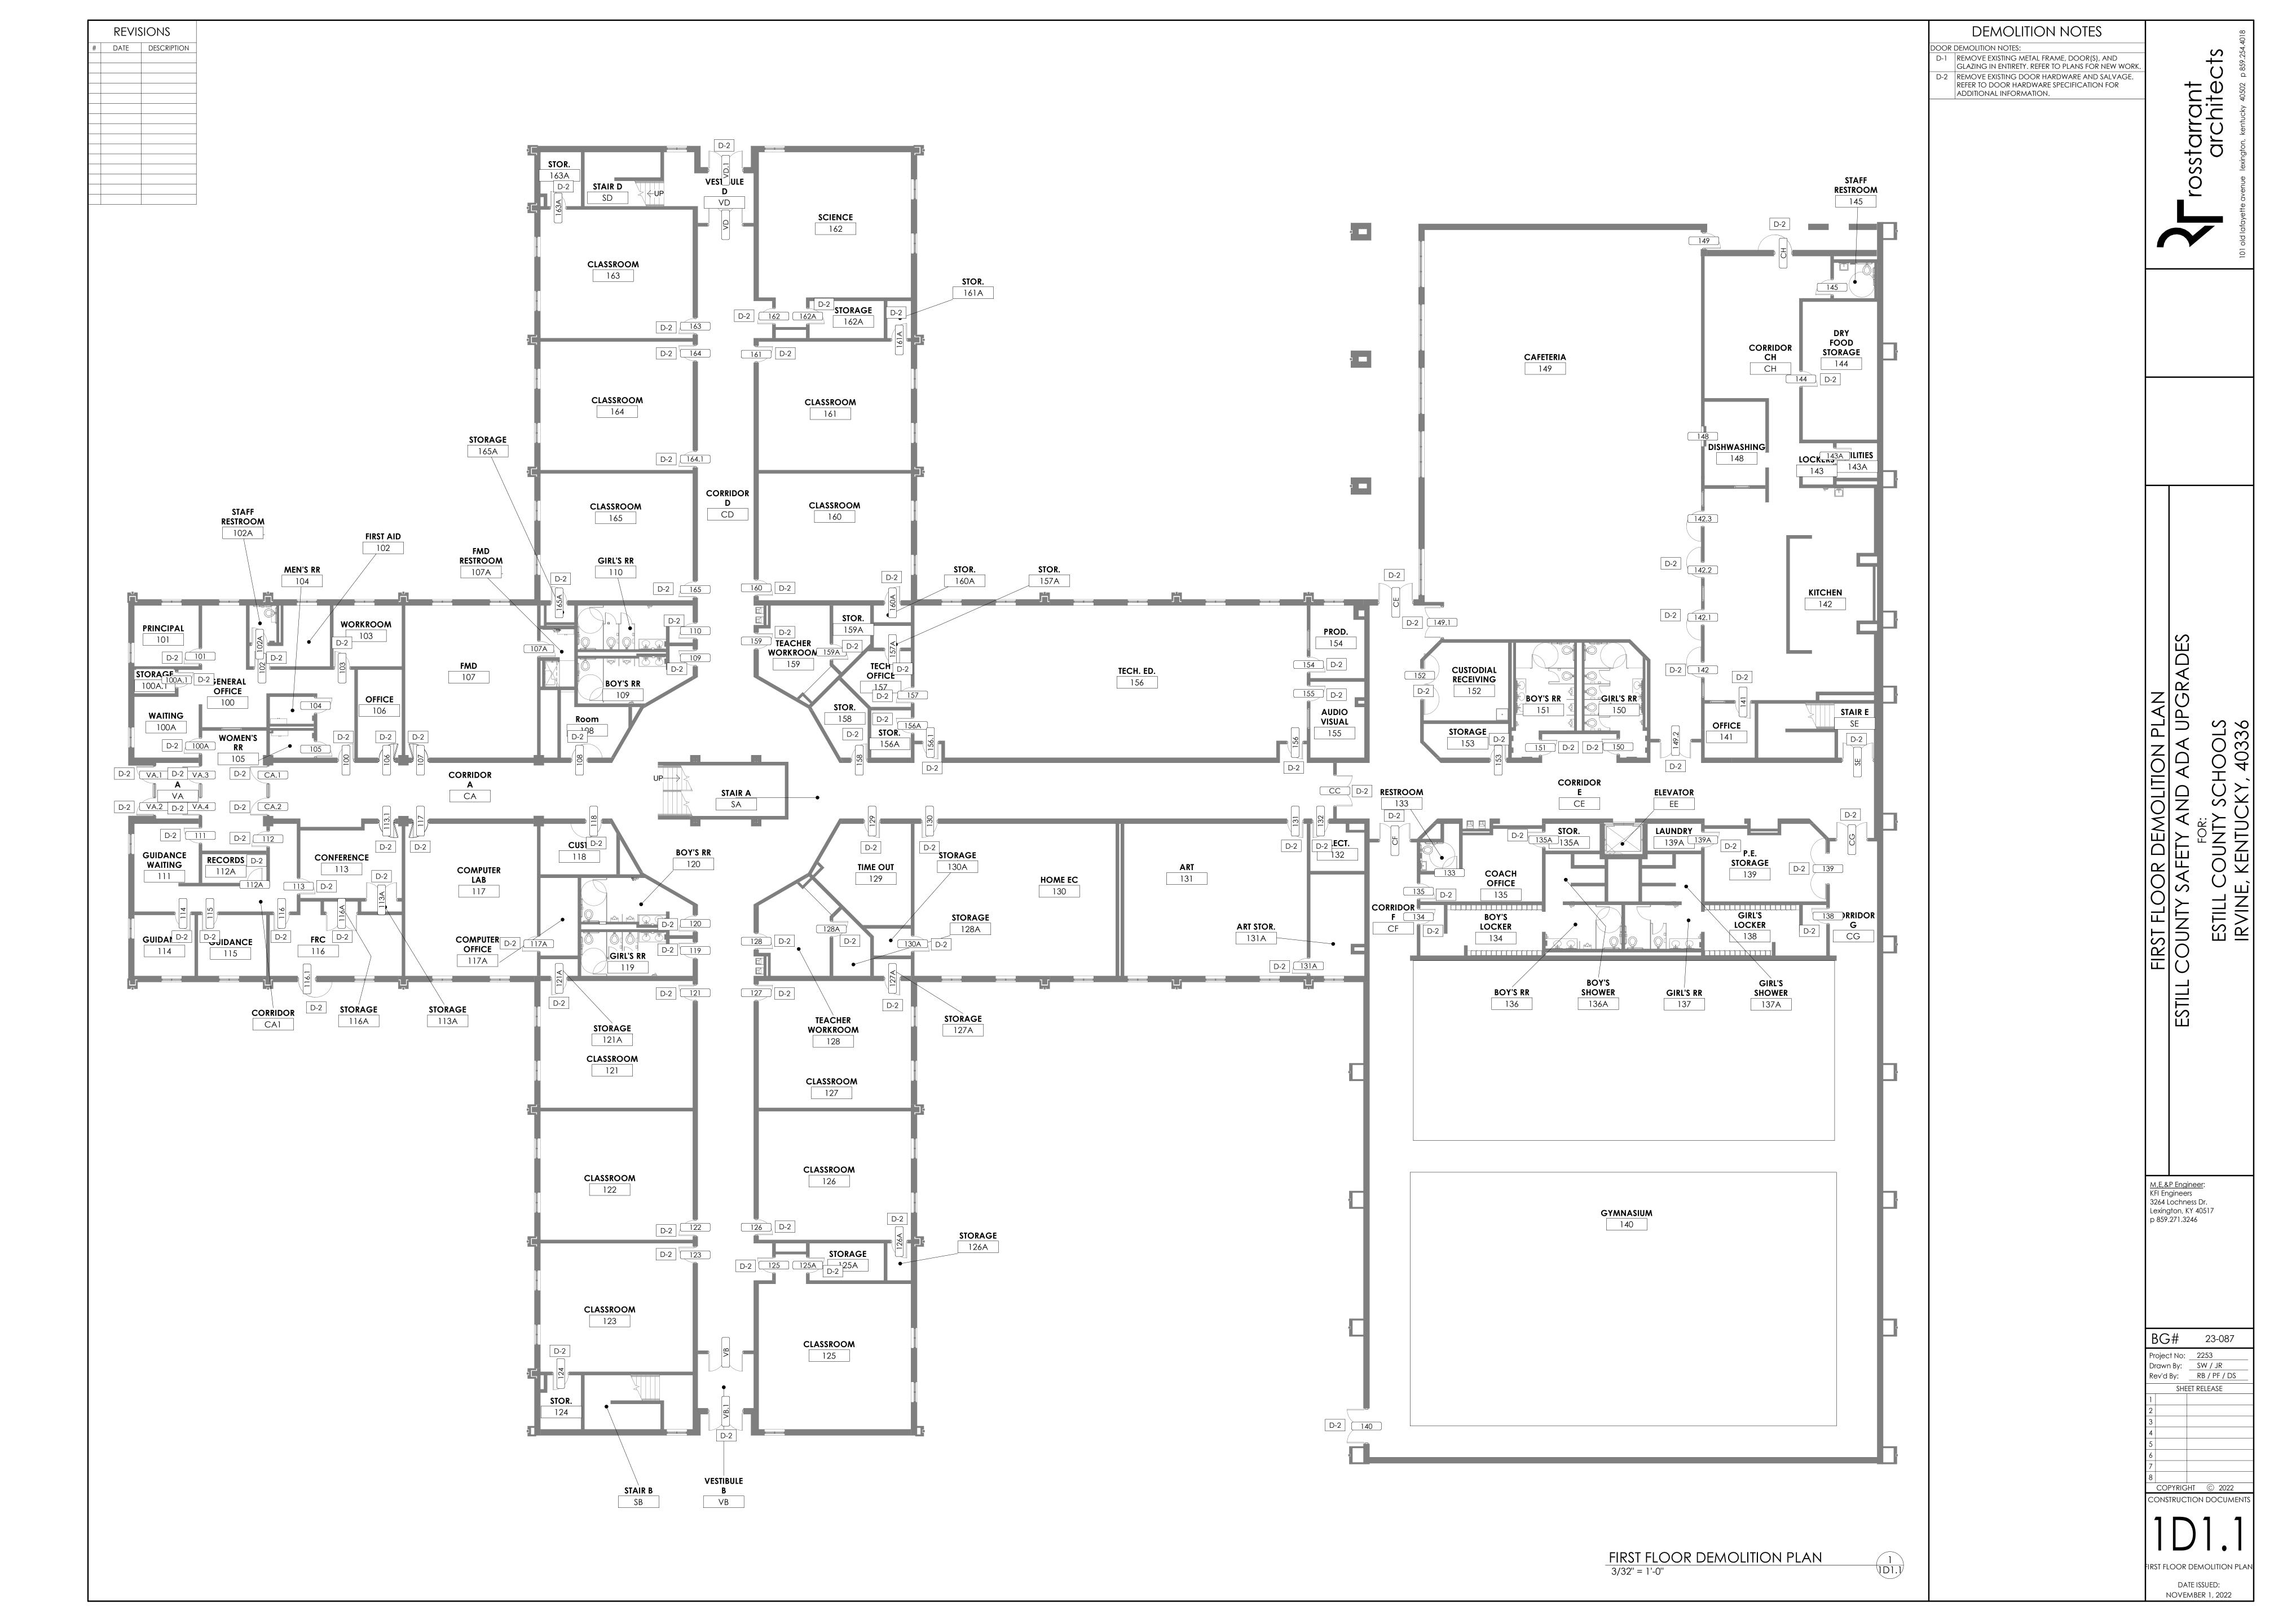


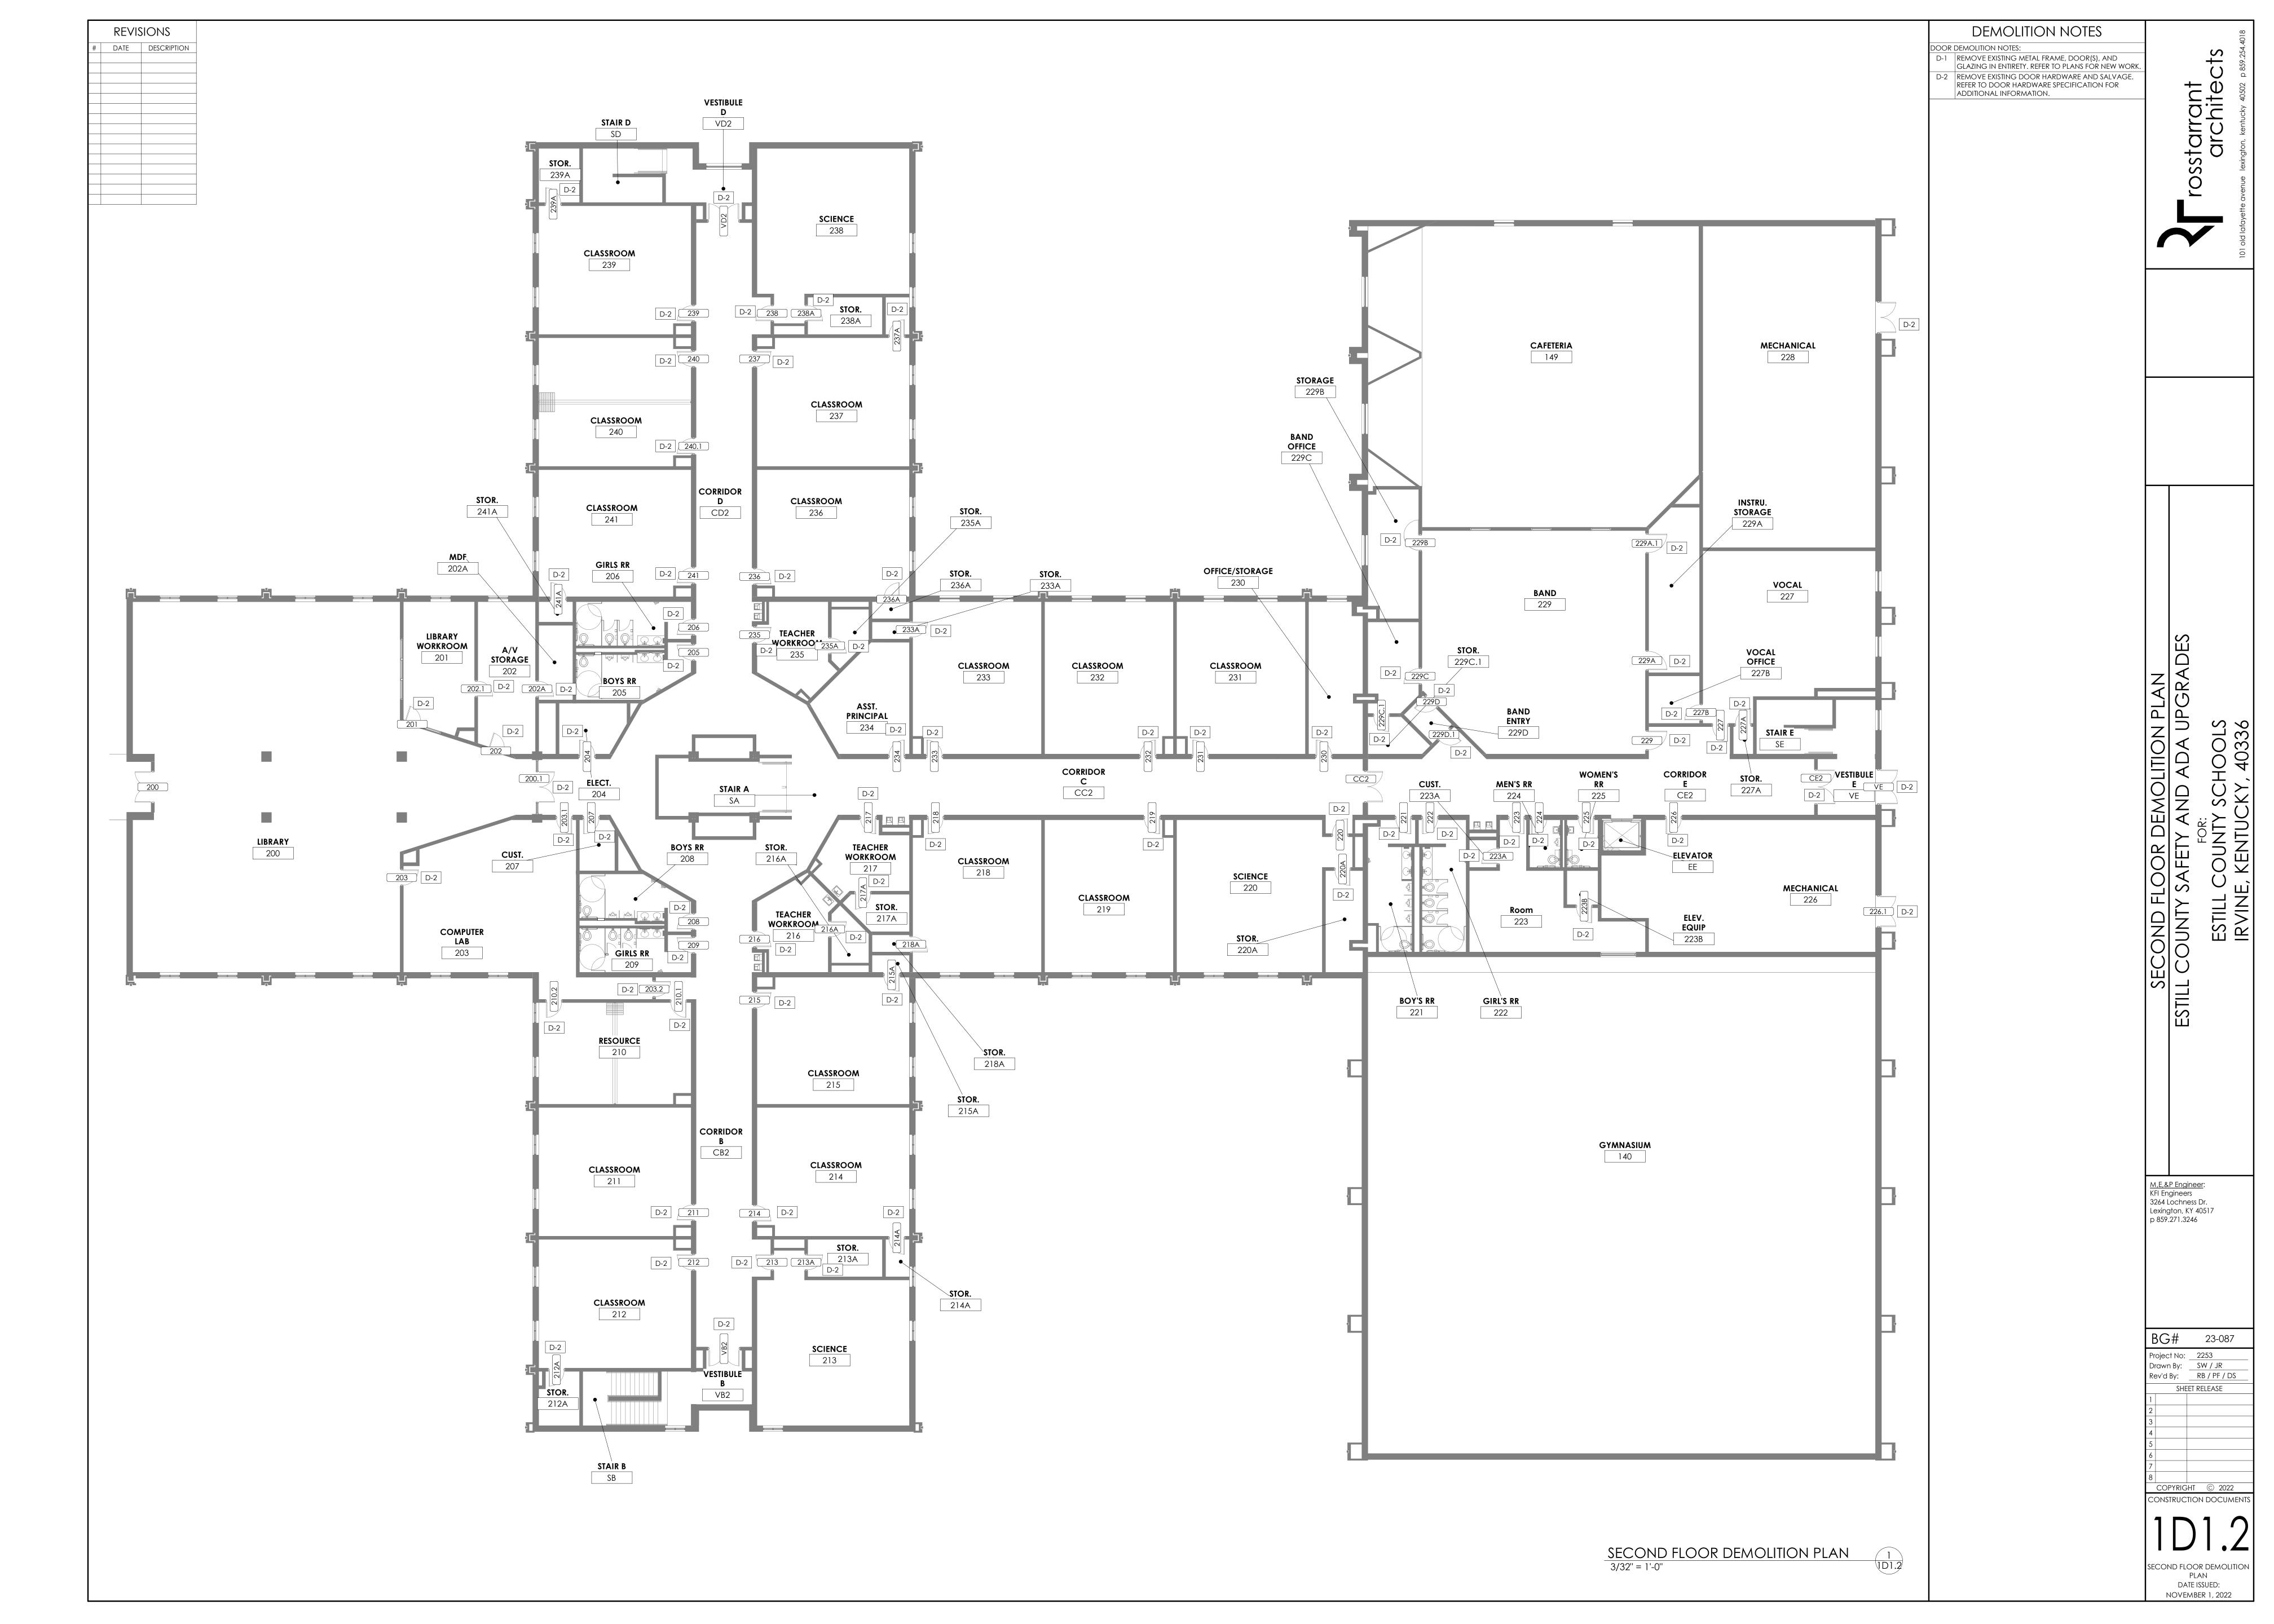
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 Project No:
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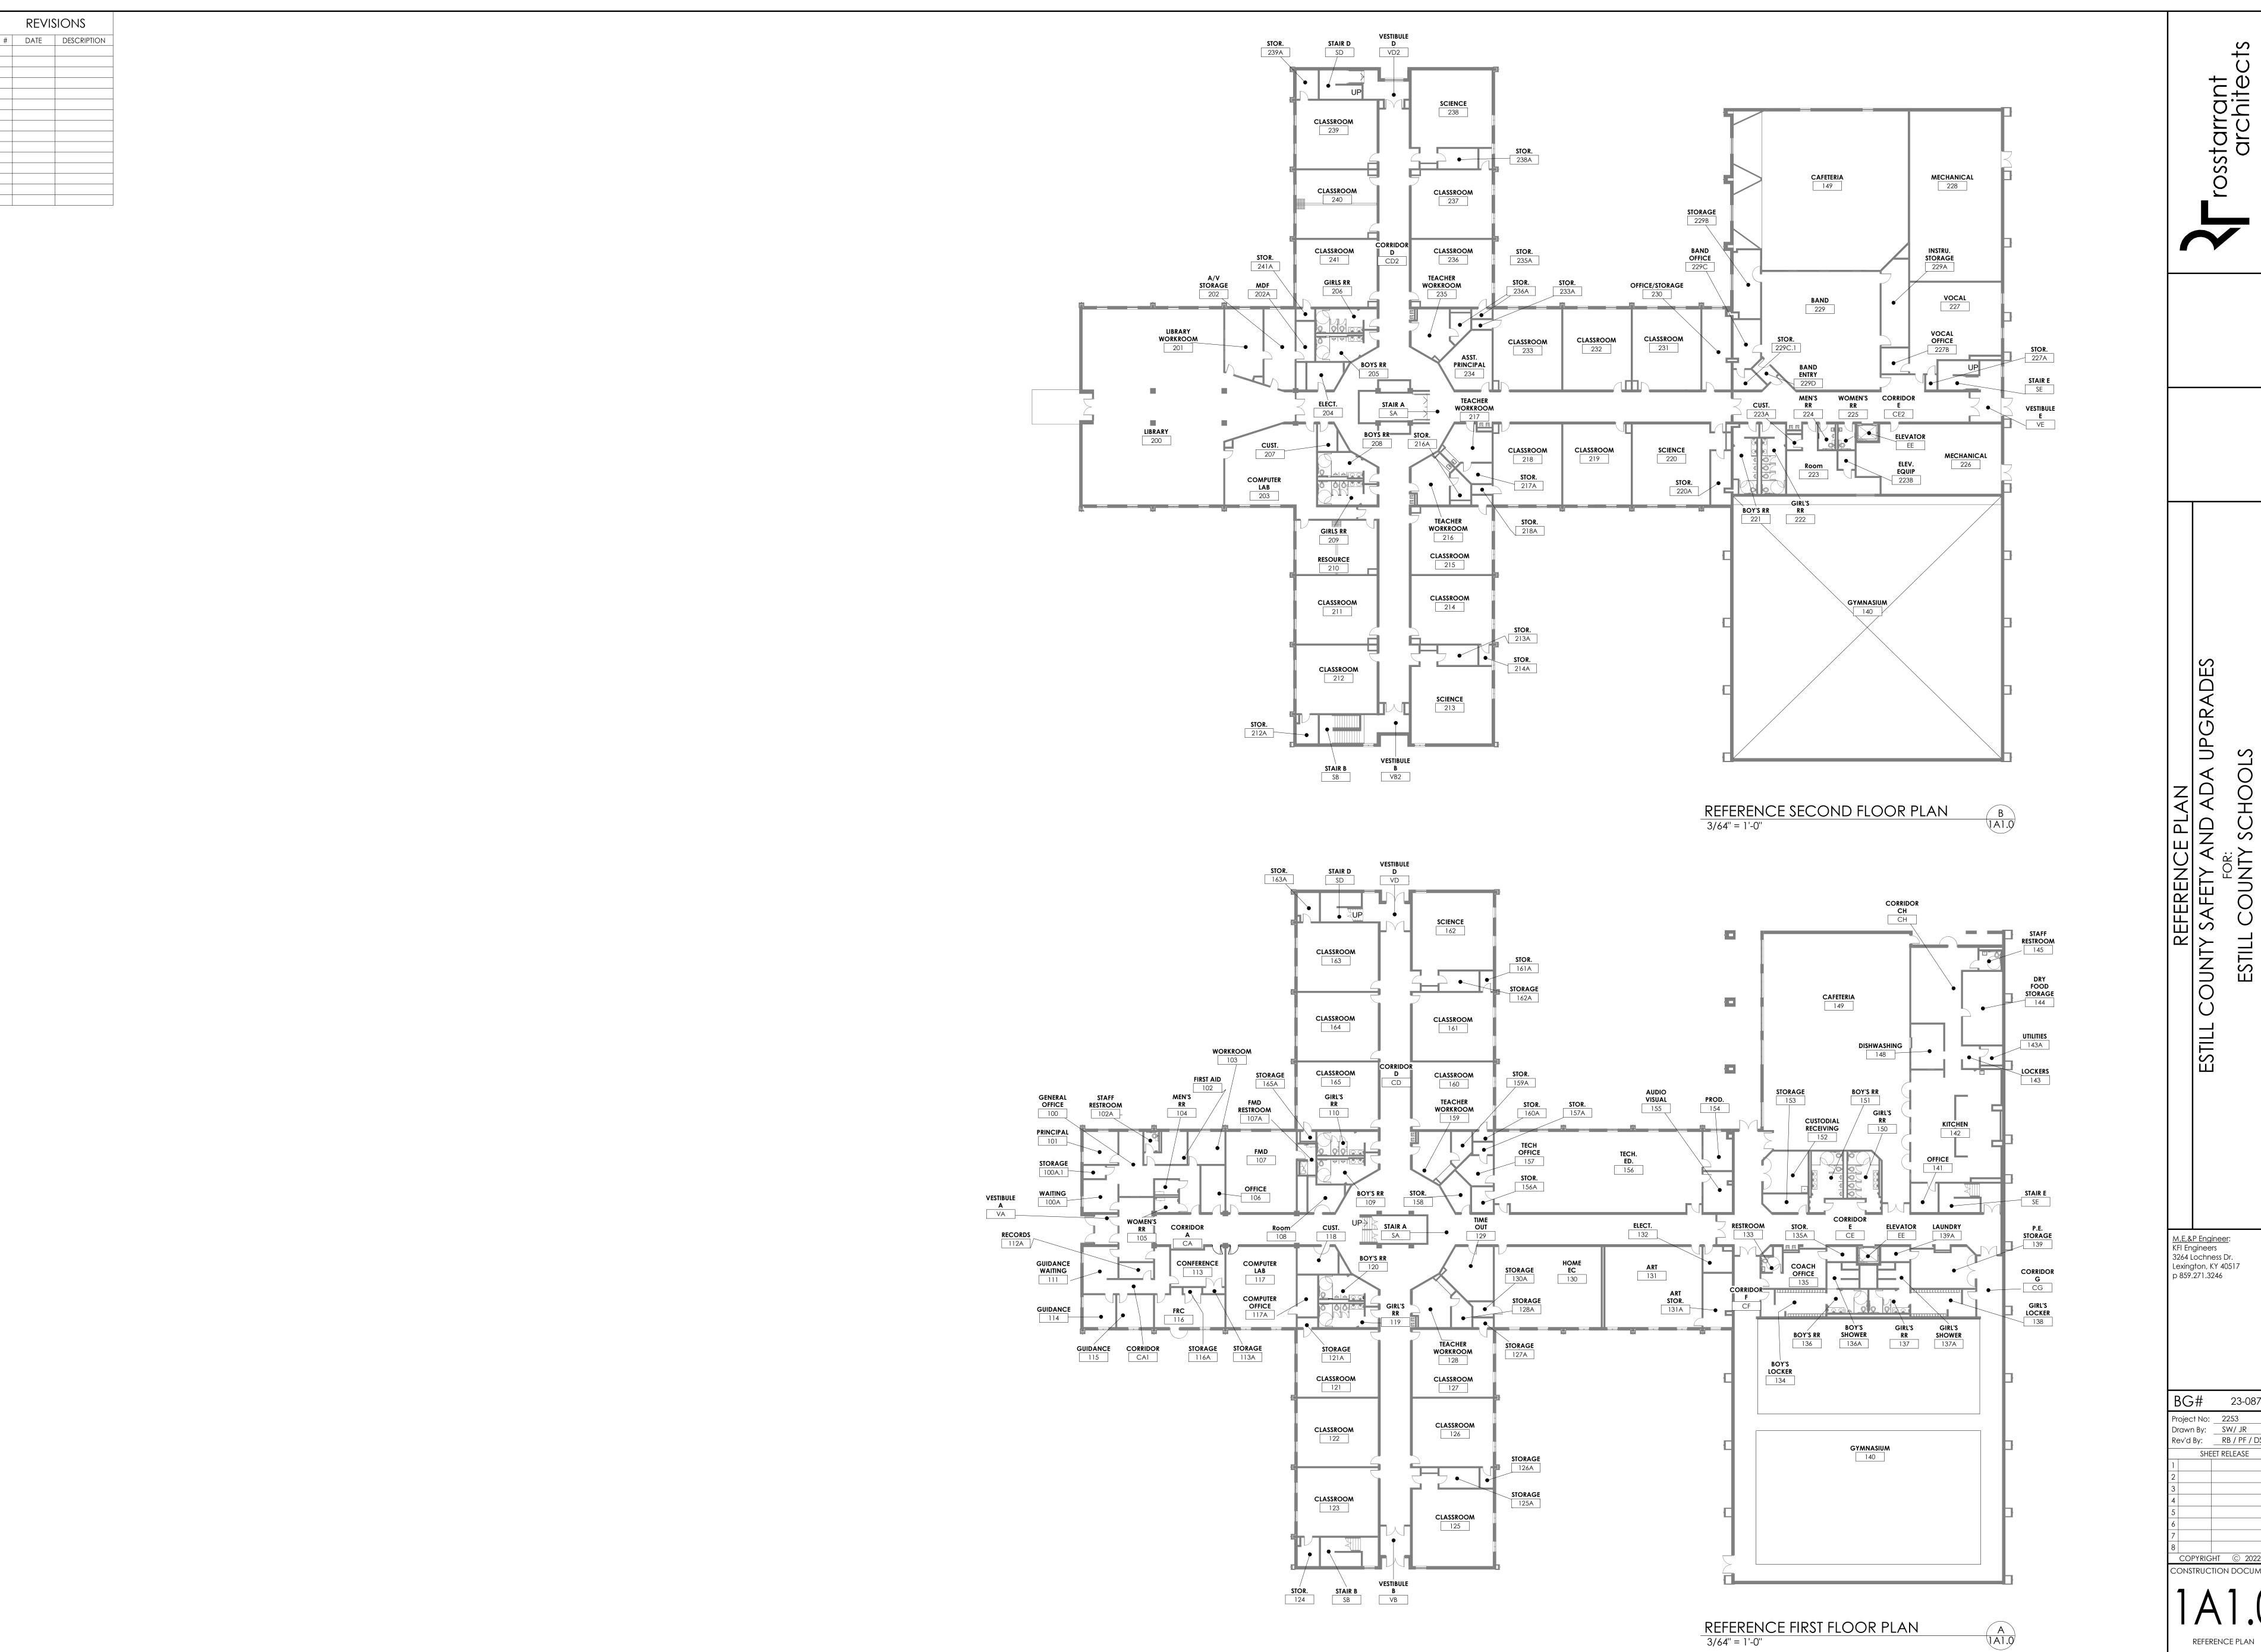
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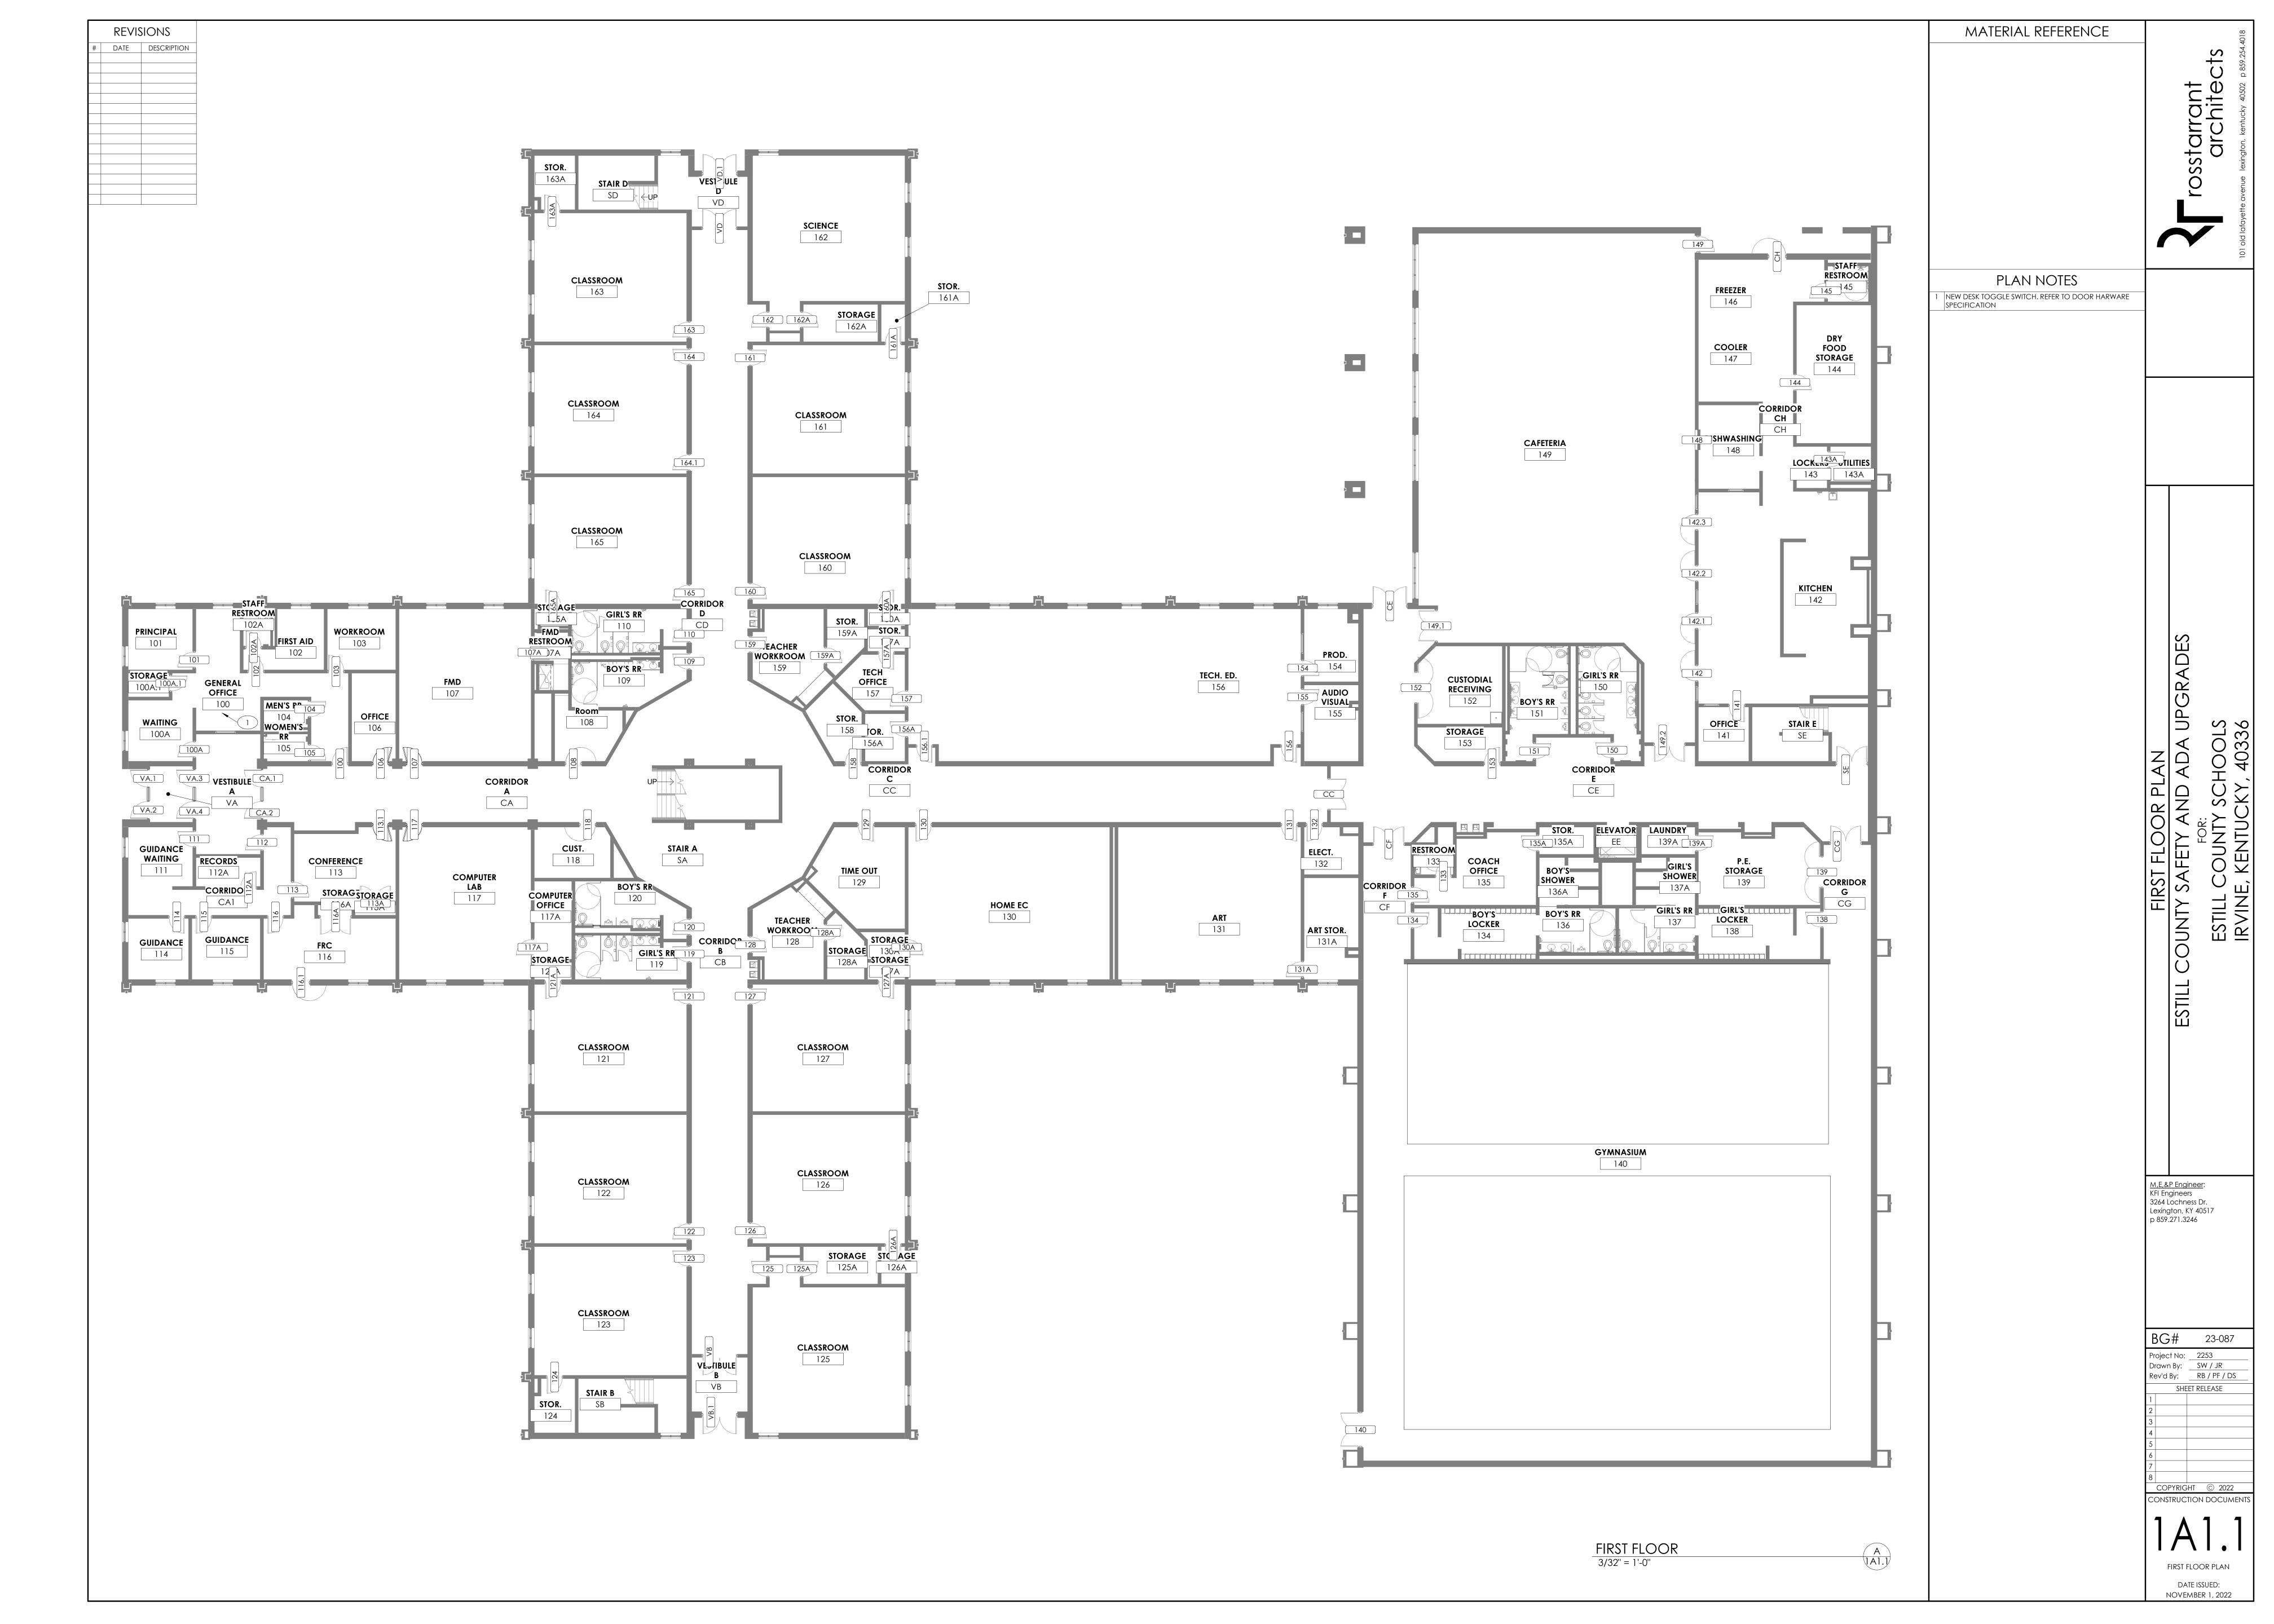


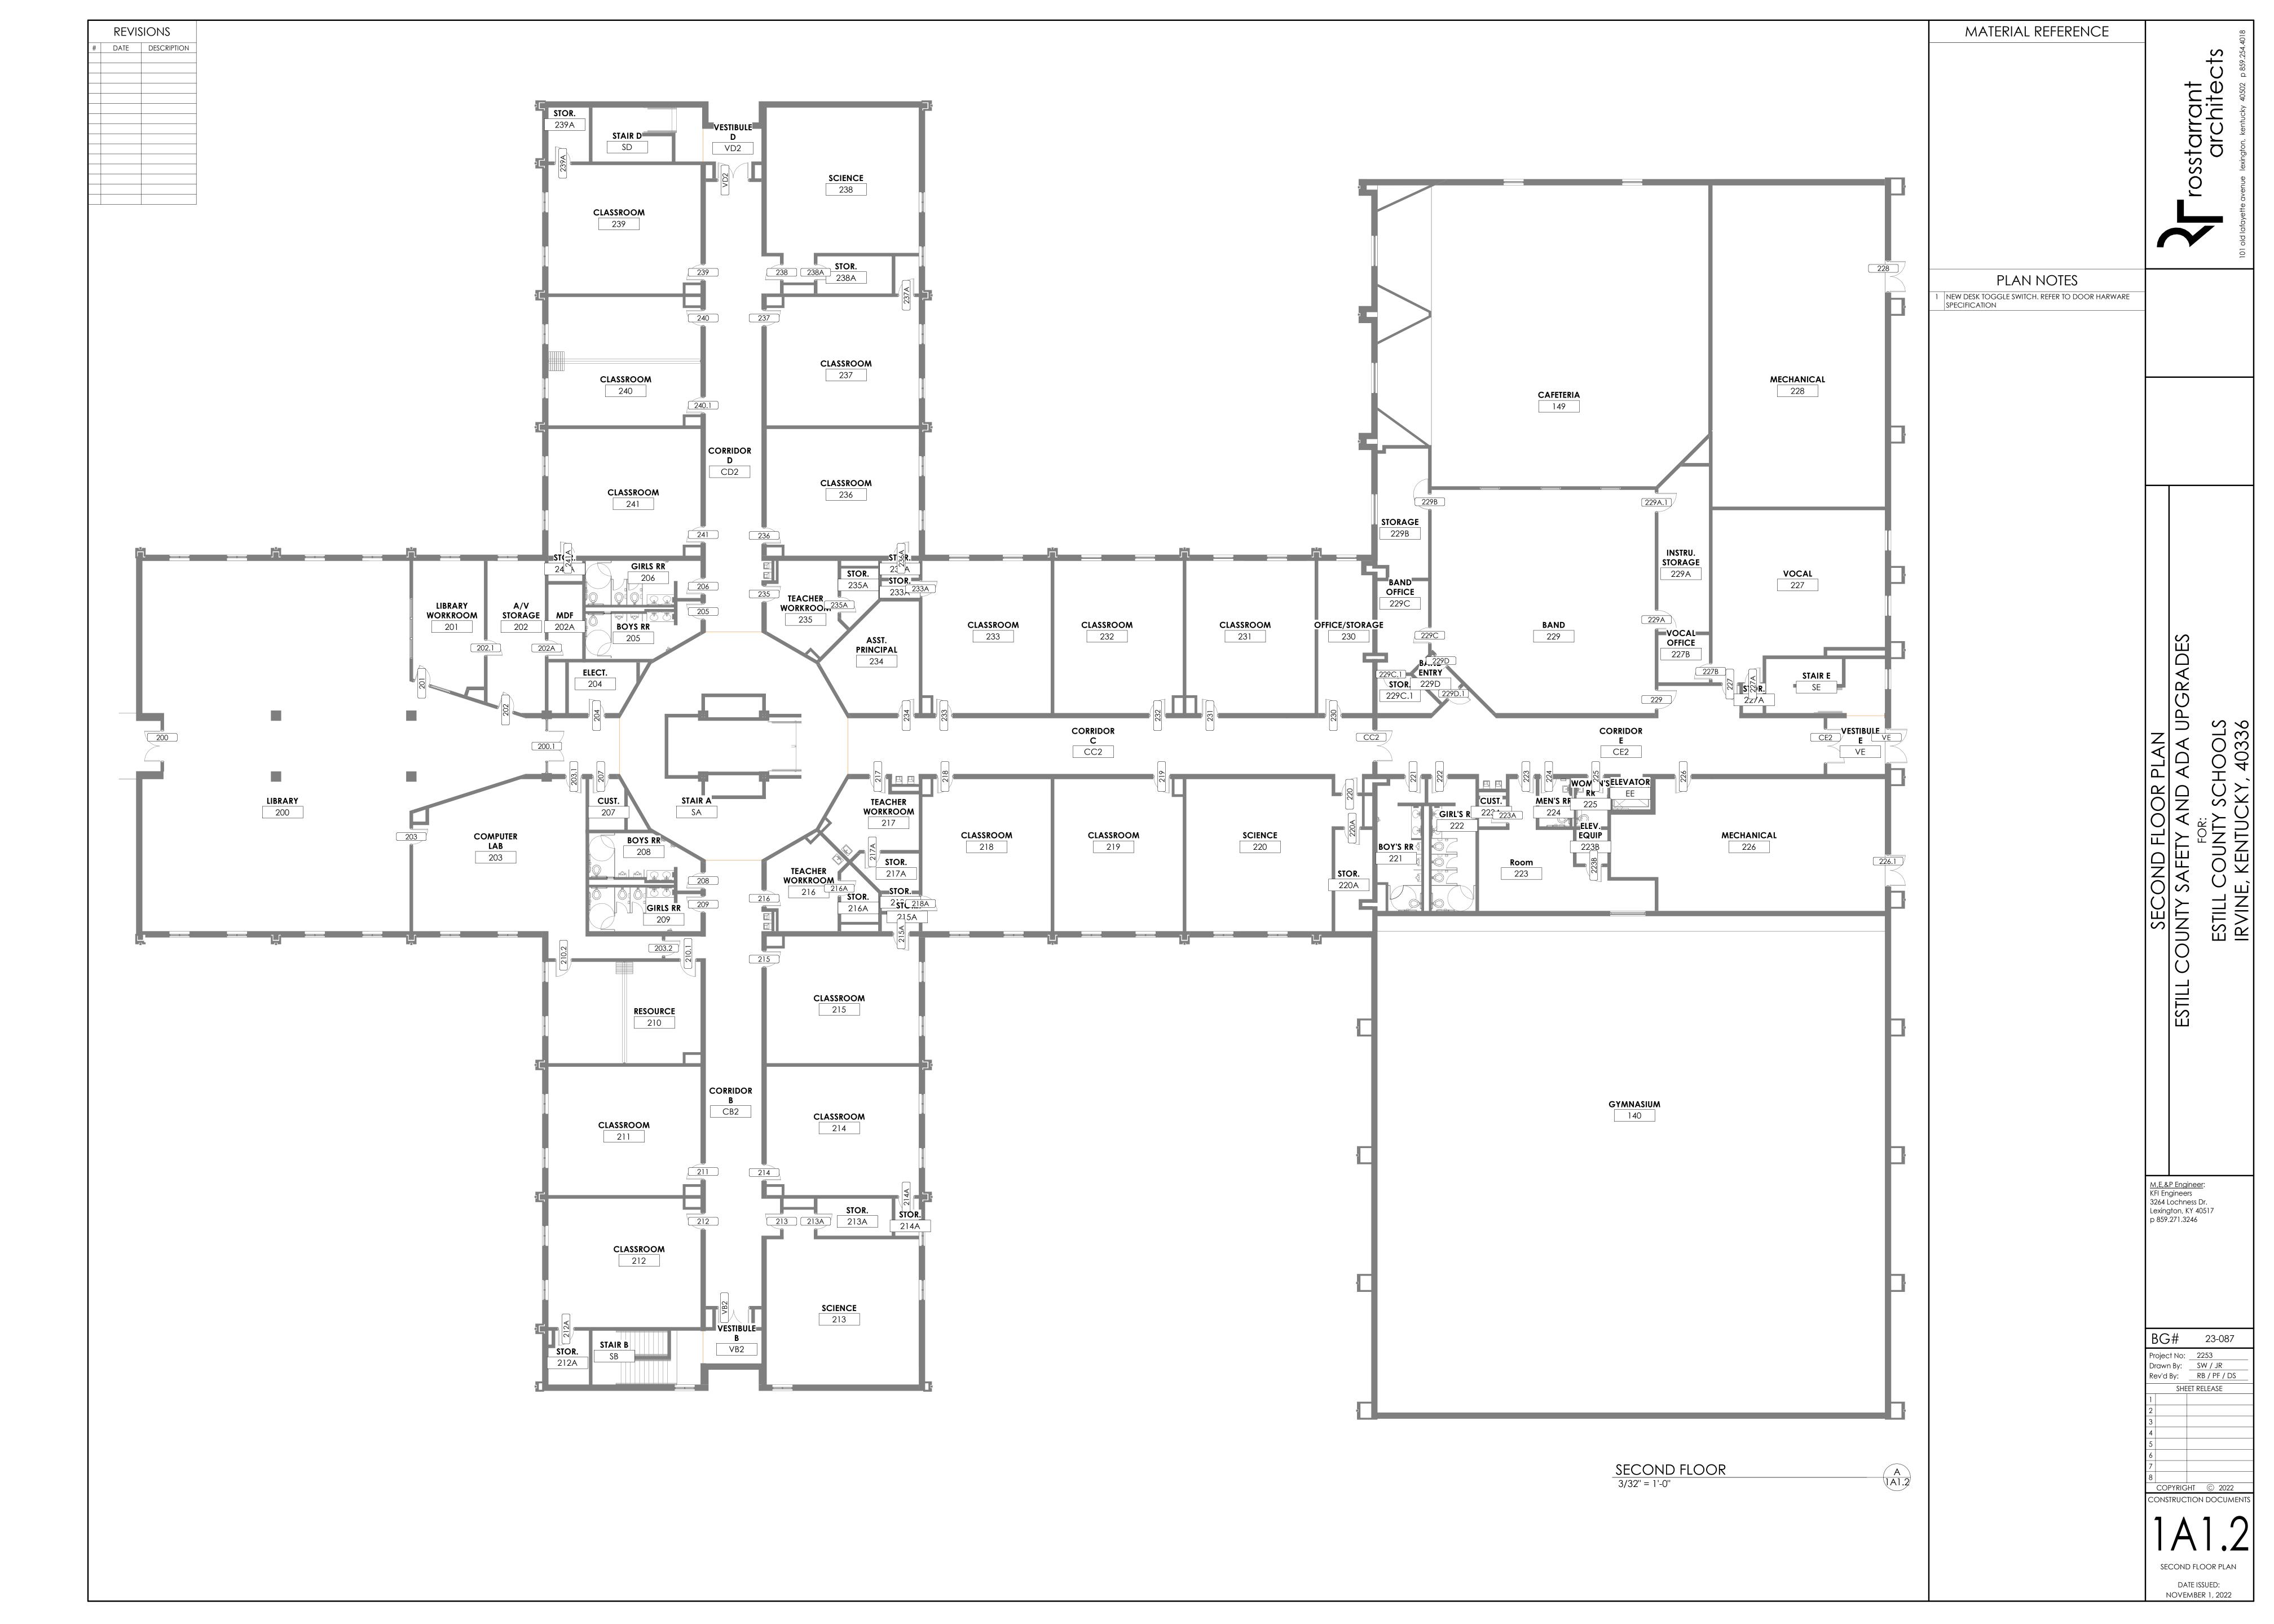
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ESTILL COUNTY SCHOOLS IRVINE, KENTUCKY, 40336

BG# 23-087 Project No: 2253
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SF = SMOKE
SF = STOREFRONT
SPG. = SPANDREL GLAZING
T. = TEMPERED
T.I. = TEMPERED INSULATED
W = WIRE GLASS
WD = WOOD doors and frame schedule DATE ISSUED: NOVEMBER 1, 2022 *SEE DRAWING A0.1 FOR MORE ABBREVIATIONS.

ESTILL COUNTY SAFETY & ADA UPGRADES

Irvine, Kentucky

for the

Estill County Board of Education

253 Main St, Irvine, Kentucky 40336 p 606.723.2181 BG # 23-087 RTA # 2253

VOLUME 2

South Irvine Early Childhood Center



101 old lafayette avenue lexington, kentucky 40502 p 859.254.4018 www.rosstarrant.com

enhancing education through great design

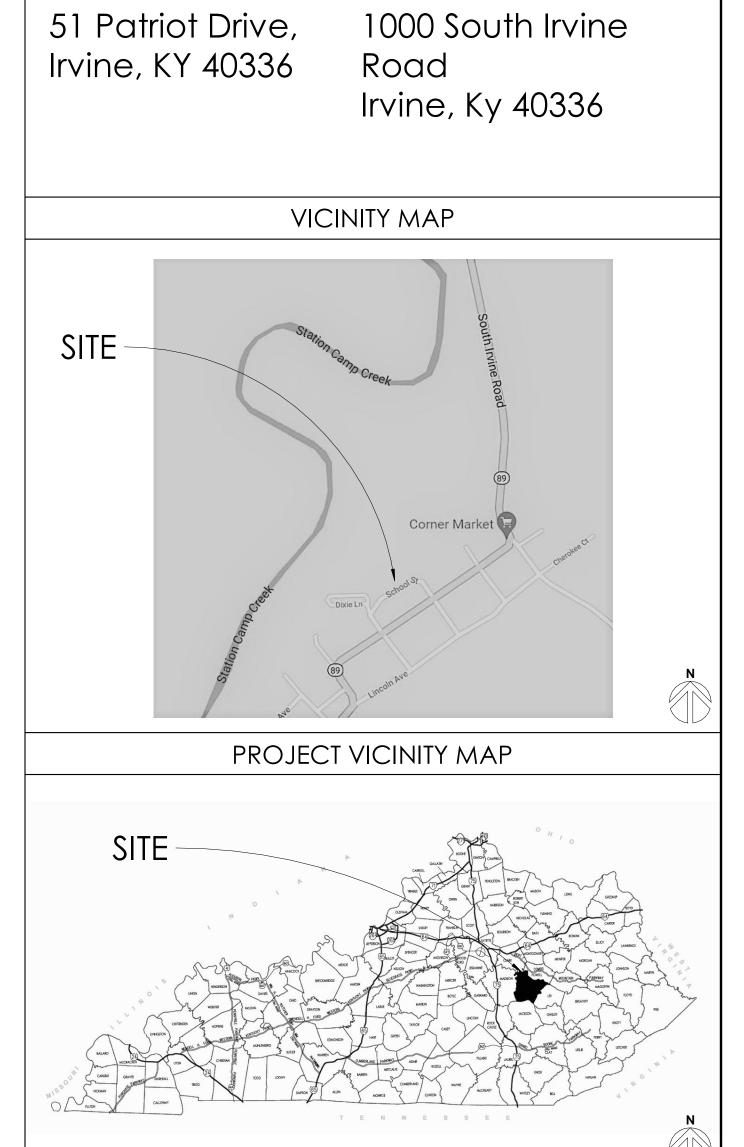
MEP ENGINEER:

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Lexington, KY 40517

HARDWARE CONSULTANT:

CALVERT INDEPENDENT HARDWARE SPECIFICATIONS, LLC 307 Oakwood Circle Vine Grove, Kentucky 40175 p 502.930.2039



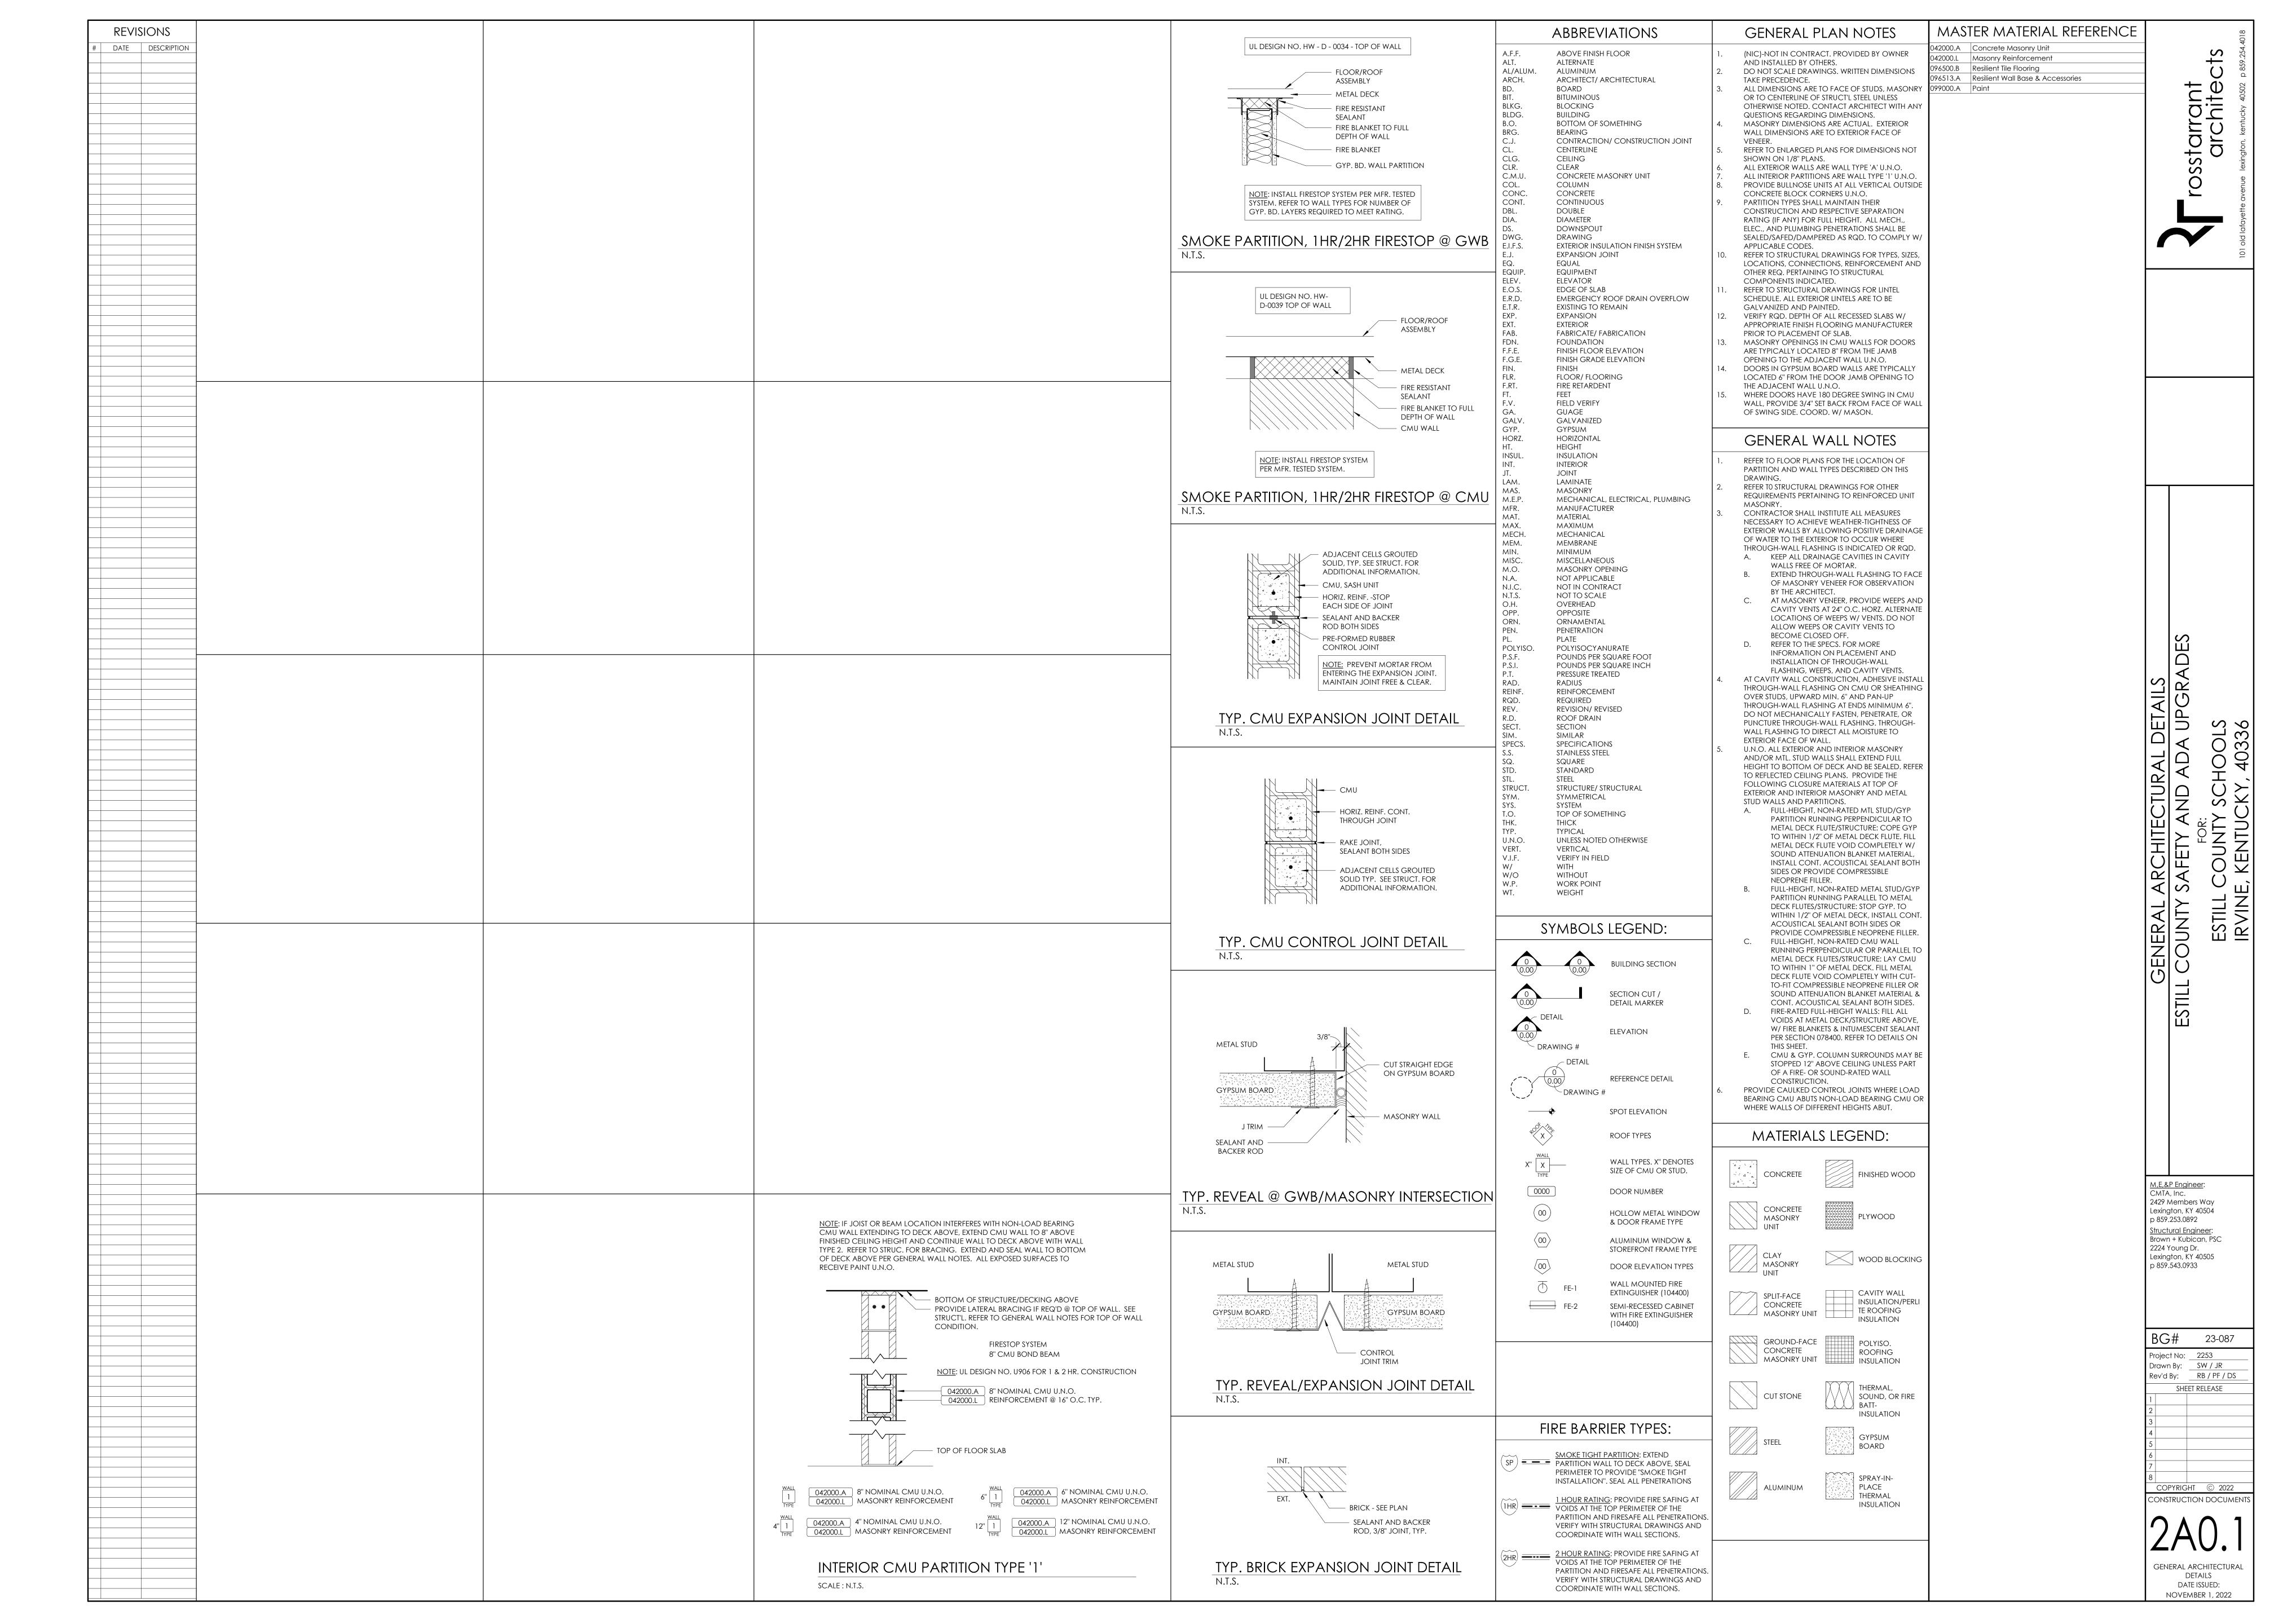
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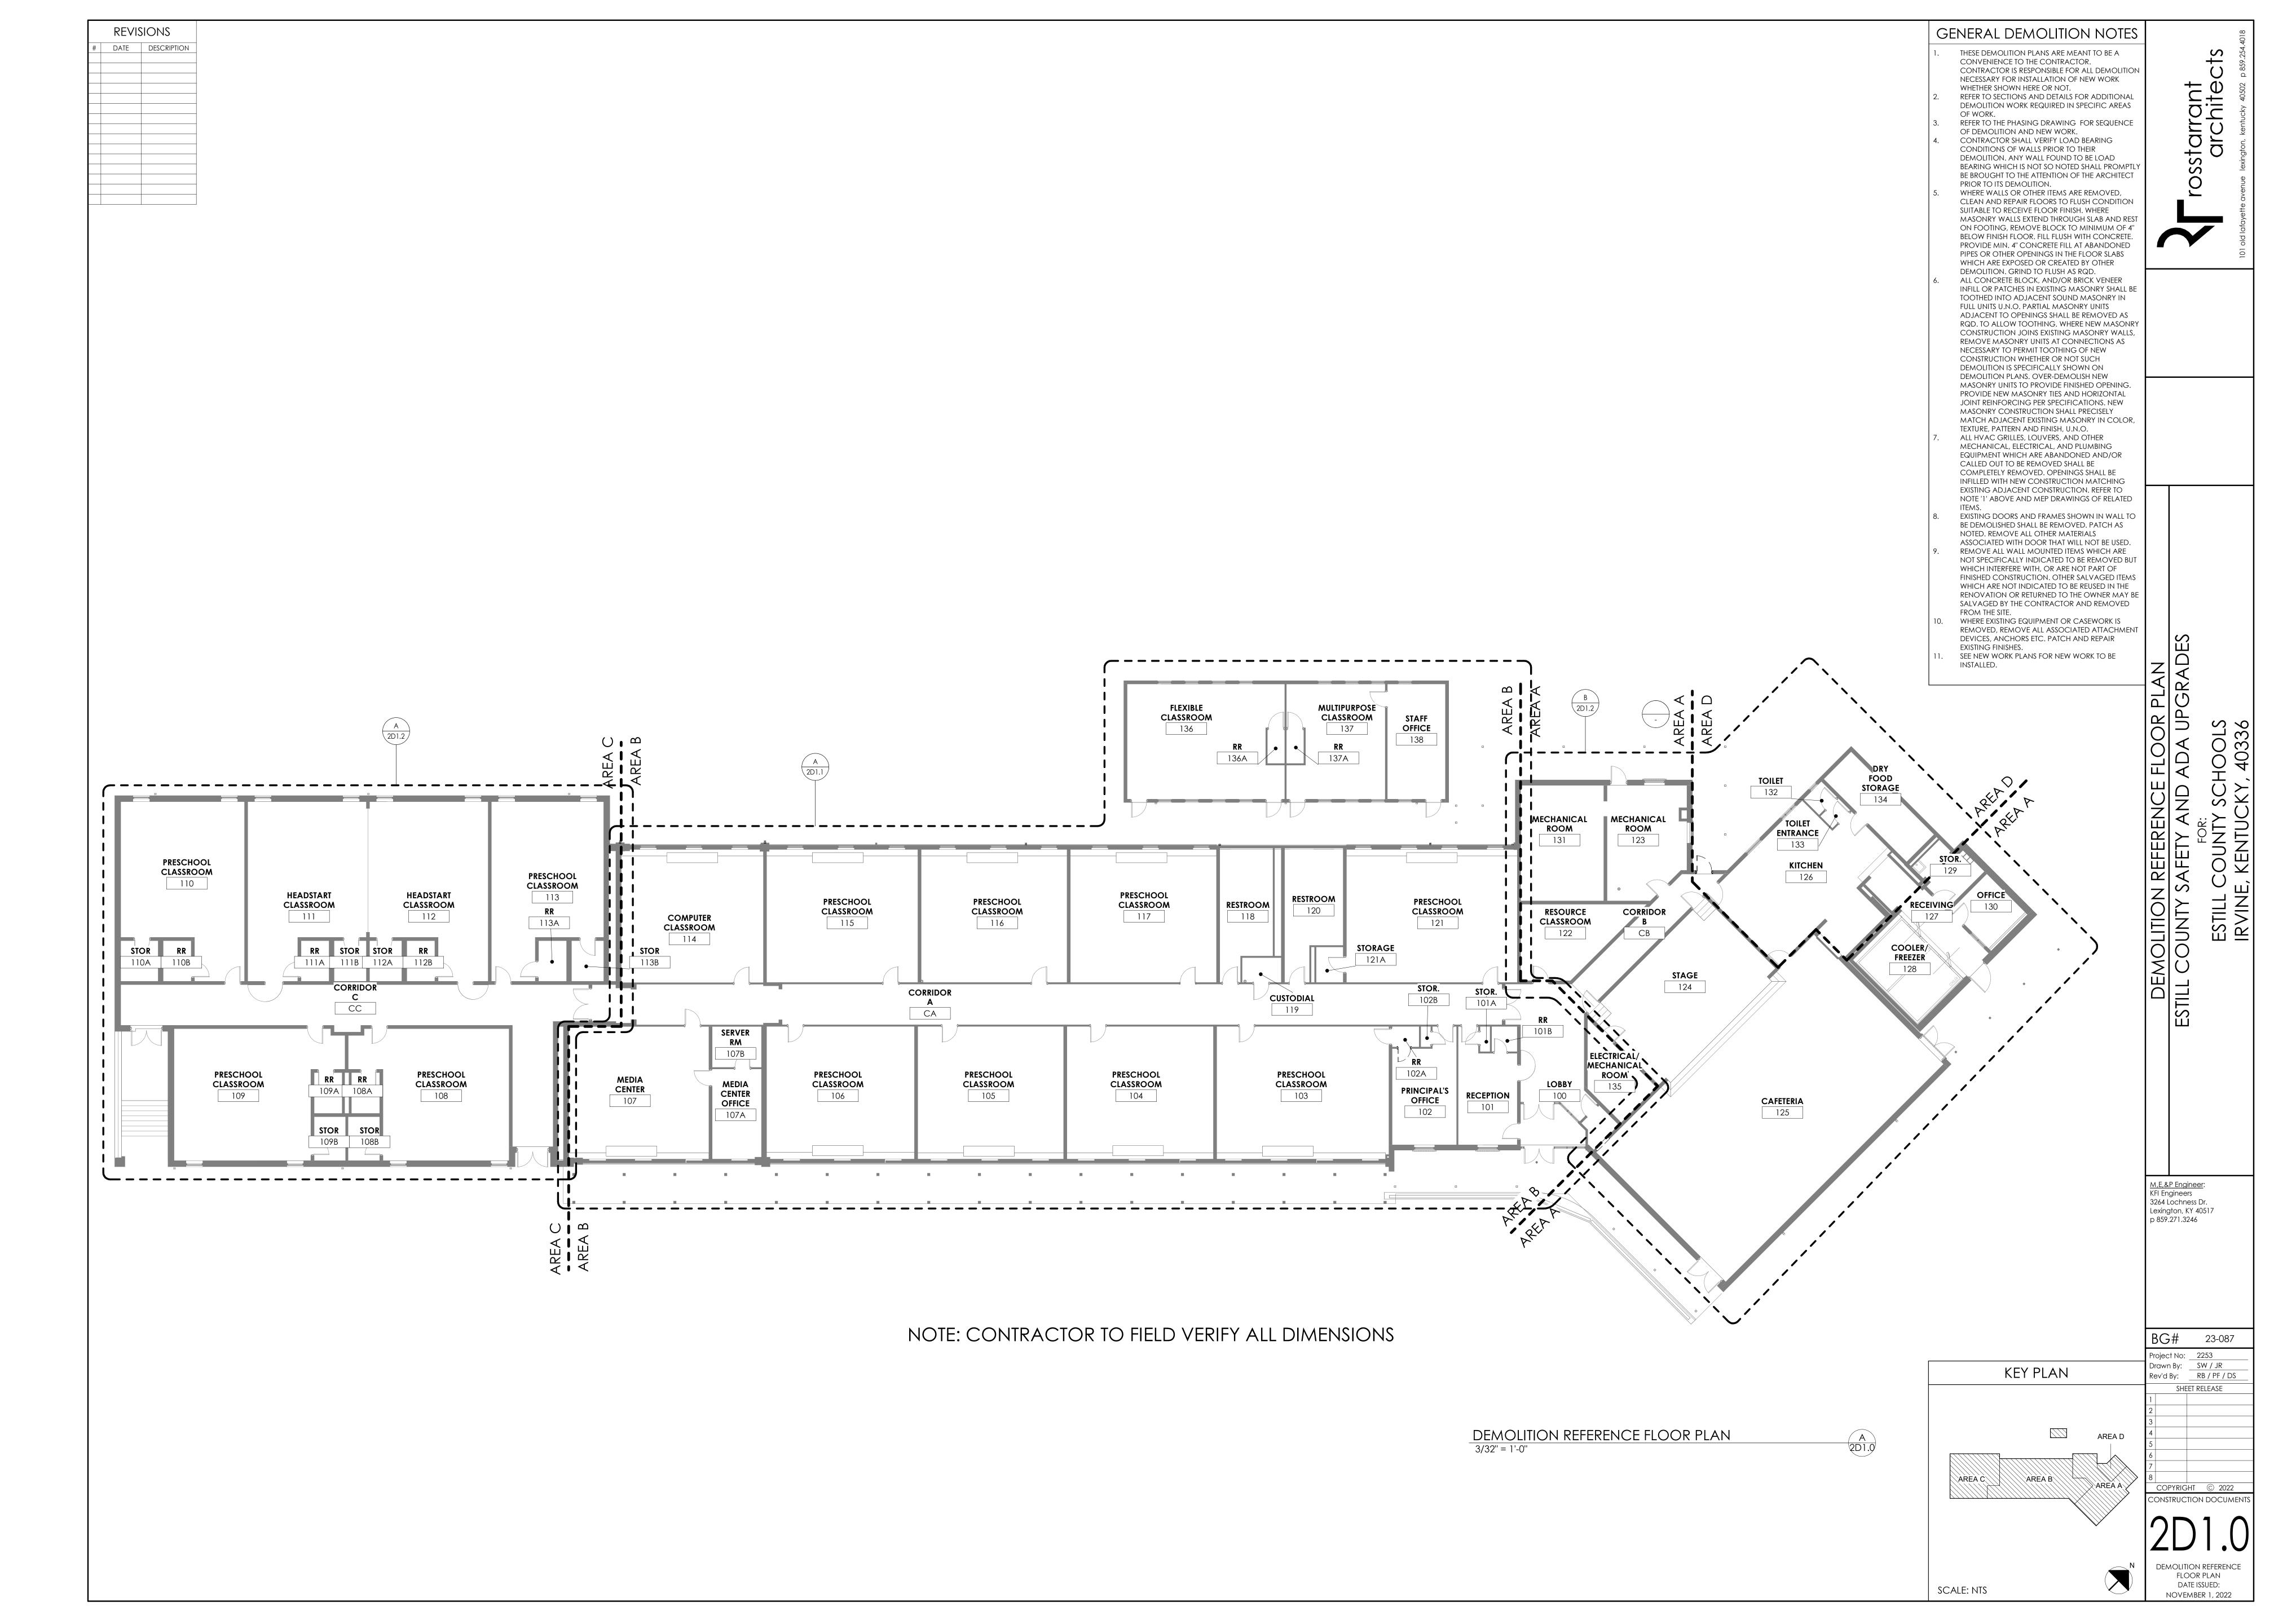
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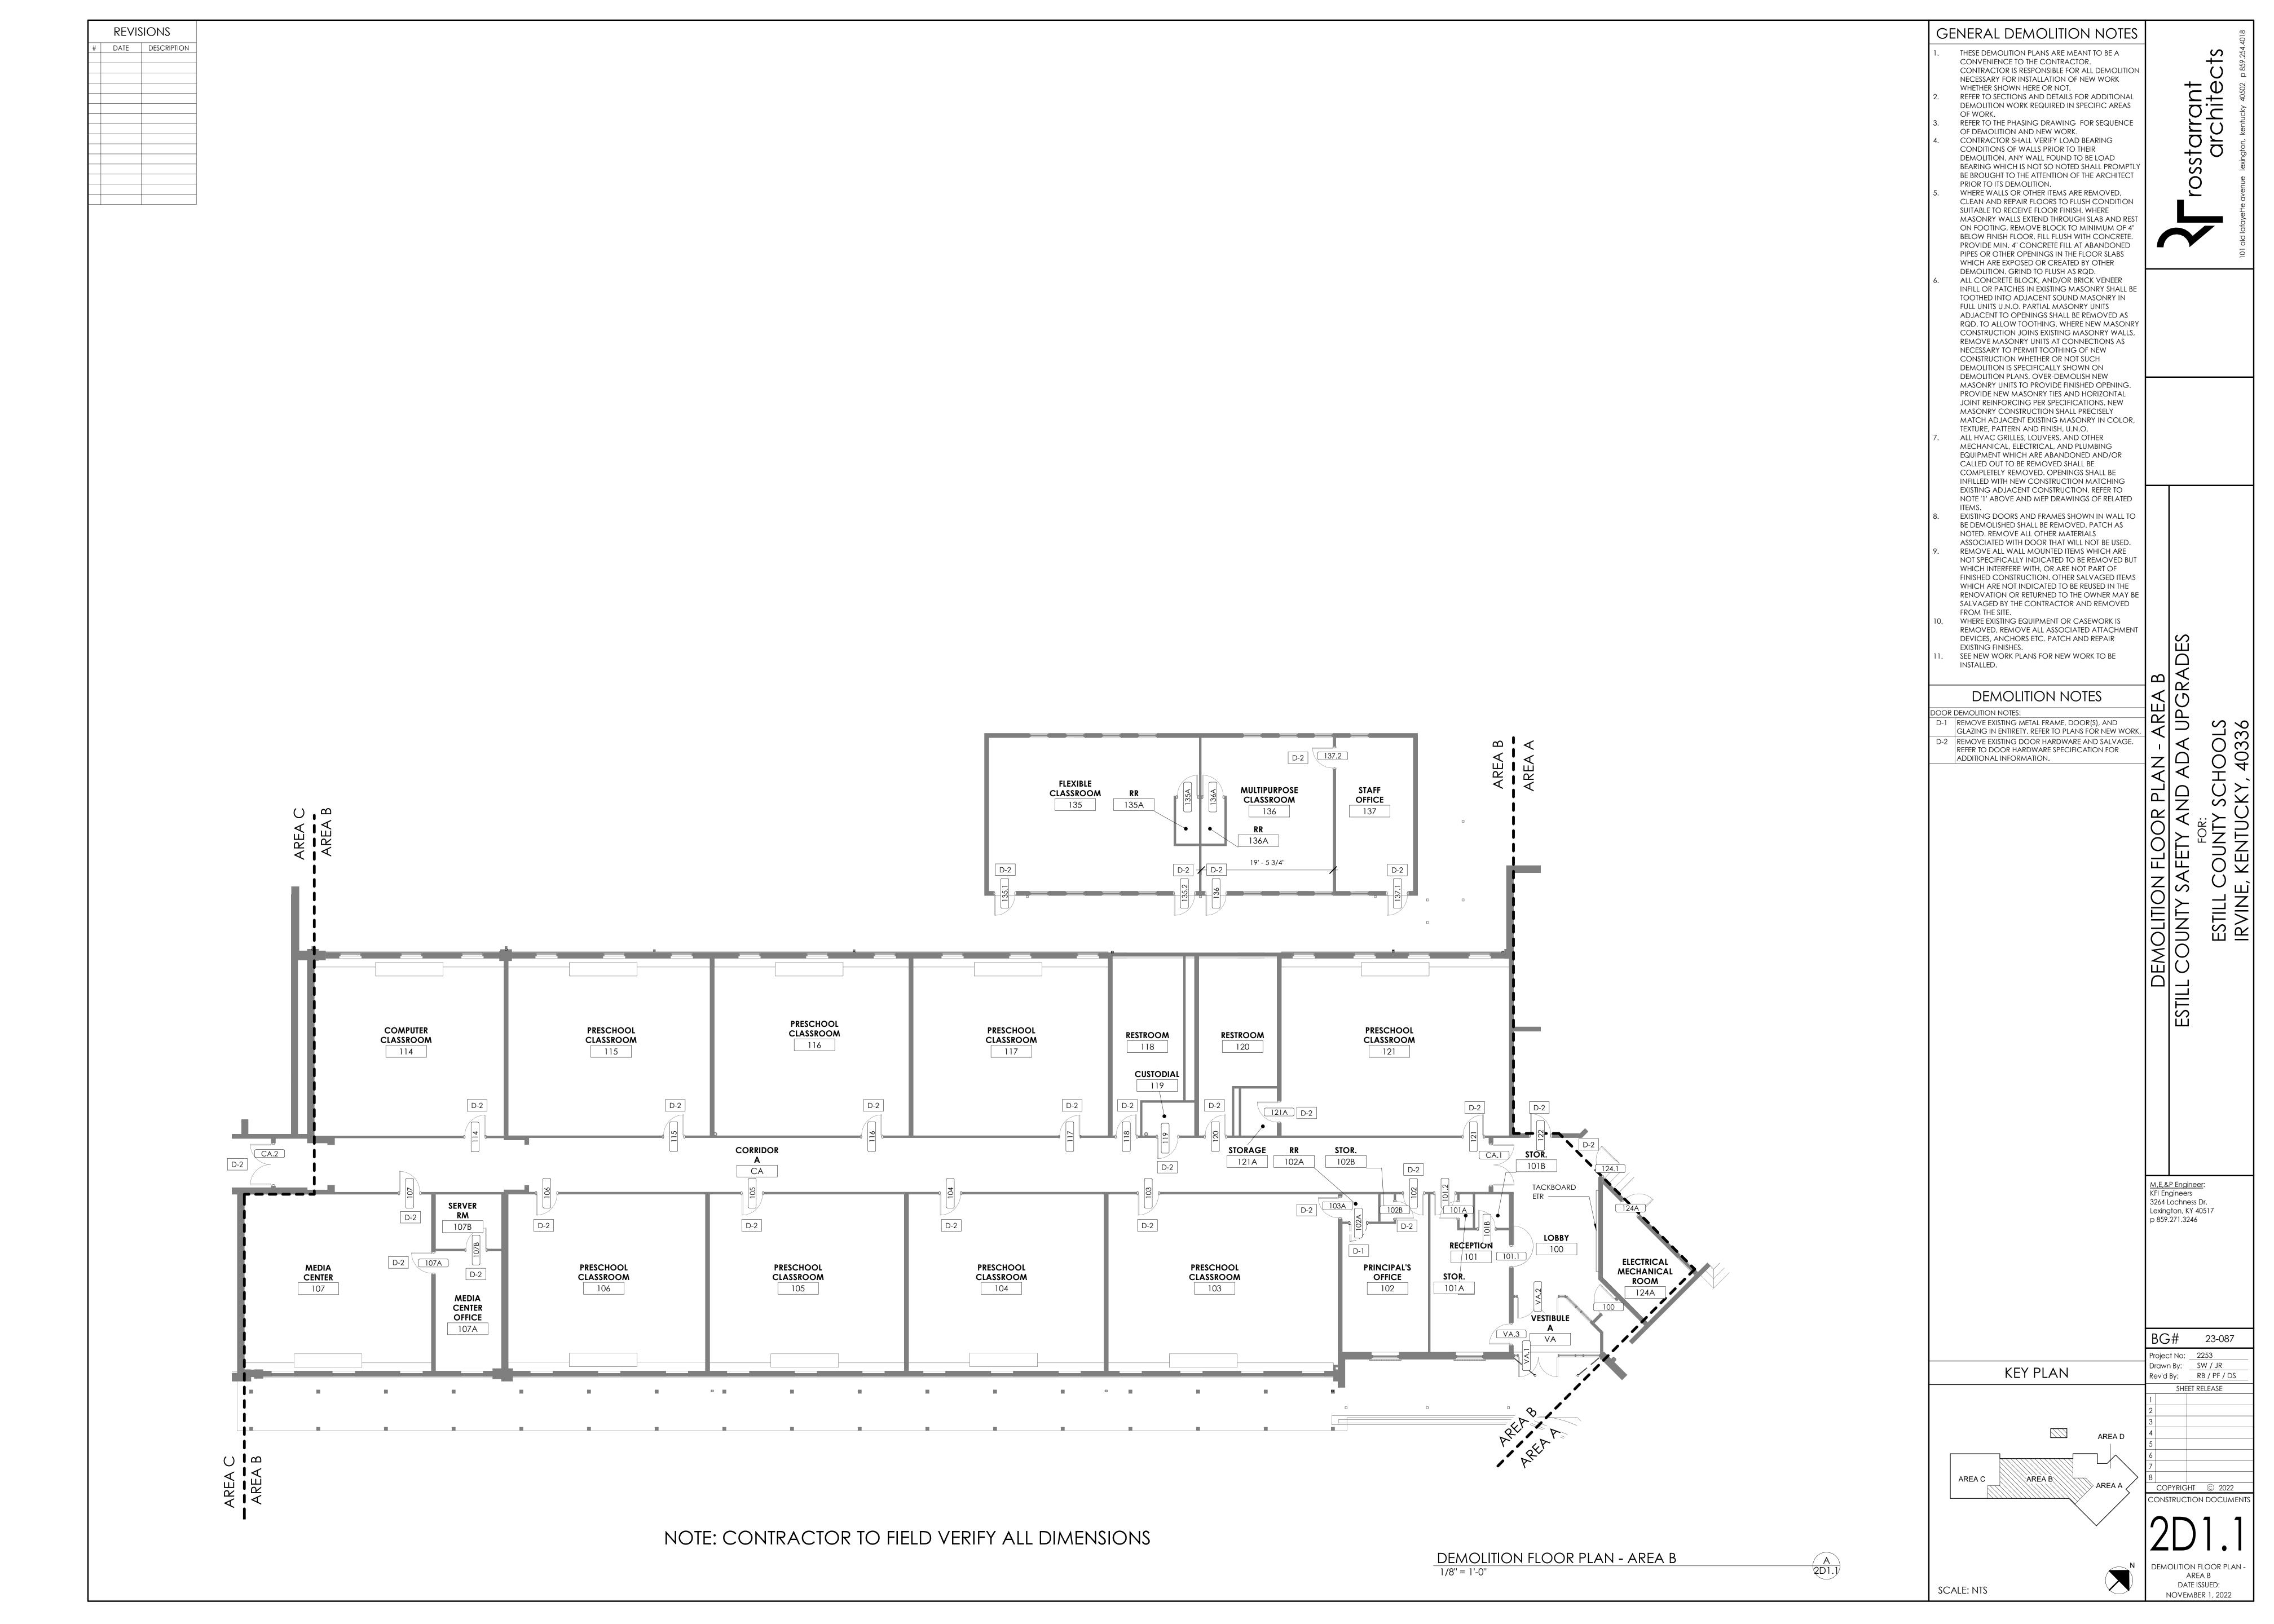
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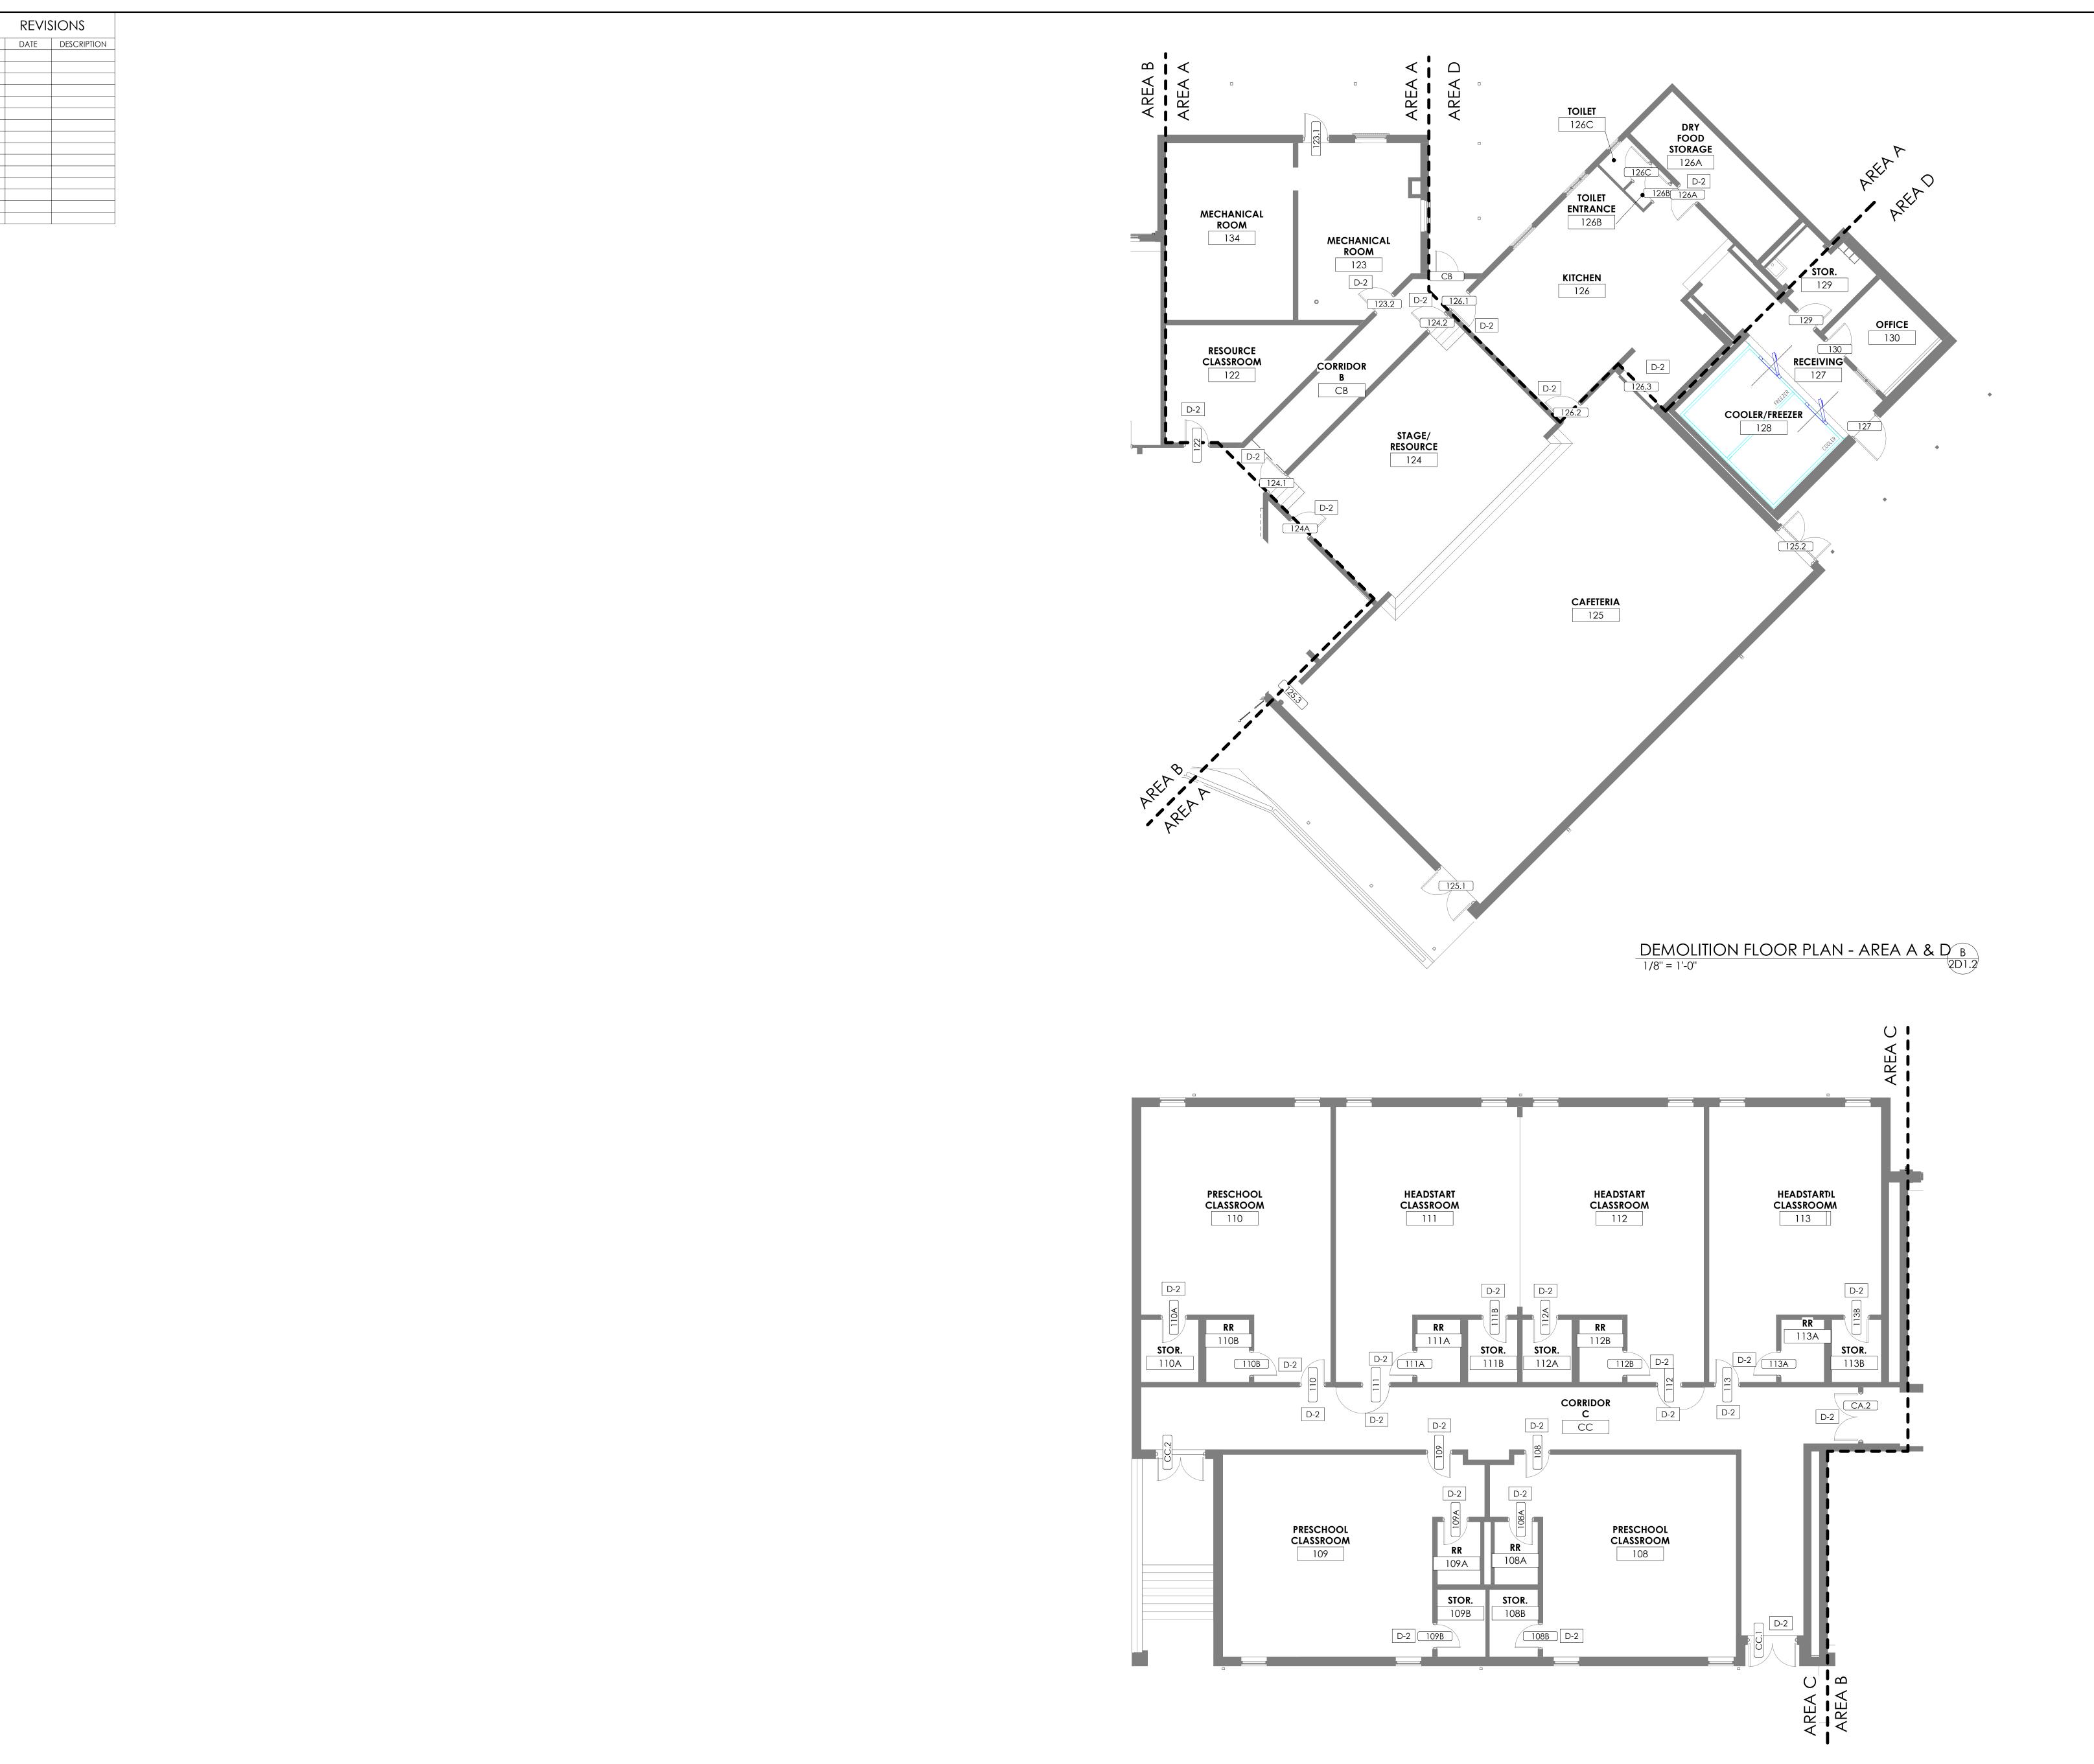
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DATE ISSUED: NOVEMBER 1, 2022









GENERAL DEMOLITION NOTES THESE DEMOLITION PLANS ARE MEANT TO BE A

CONVENIENCE TO THE CONTRACTOR. CONTRACTOR IS RESPONSIBLE FOR ALL DEMOLITION NECESSARY FOR INSTALLATION OF NEW WORK WHETHER SHOWN HERE OR NOT. REFER TO SECTIONS AND DETAILS FOR ADDITIONAL

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DEMOLITION WORK REQUIRED IN SPECIFIC AREAS OF WORK. REFER TO THE PHASING DRAWING FOR SEQUENCE OF DEMOLITION AND NEW WORK.

CONTRACTOR SHALL VERIFY LOAD BEARING CONDITIONS OF WALLS PRIOR TO THEIR DEMOLITION. ANY WALL FOUND TO BE LOAD BEARING WHICH IS NOT SO NOTED SHALL PROMPTLY PRIOR TO ITS DEMOLITION.

BE BROUGHT TO THE ATTENTION OF THE ARCHITECT WHERE WALLS OR OTHER ITEMS ARE REMOVED, CLEAN AND REPAIR FLOORS TO FLUSH CONDITION SUITABLE TO RECEIVE FLOOR FINISH. WHERE MASONRY WALLS EXTEND THROUGH SLAB AND REST ON FOOTING, REMOVE BLOCK TO MINIMUM OF 4" BELOW FINISH FLOOR. FILL FLUSH WITH CONCRETE. PROVIDE MIN. 4" CONCRETE FILL AT ABANDONED PIPES OR OTHER OPENINGS IN THE FLOOR SLABS WHICH ARE EXPOSED OR CREATED BY OTHER

DEMOLITION. GRIND TO FLUSH AS RQD. ALL CONCRETE BLOCK, AND/OR BRICK VENEER INFILL OR PATCHES IN EXISTING MASONRY SHALL BE TOOTHED INTO ADJACENT SOUND MASONRY IN FULL UNITS U.N.O. PARTIAL MASONRY UNITS ADJACENT TO OPENINGS SHALL BE REMOVED AS RQD. TO ALLOW TOOTHING. WHERE NEW MASONRY CONSTRUCTION JOINS EXISTING MASONRY WALLS, REMOVE MASONRY UNITS AT CONNECTIONS AS NECESSARY TO PERMIT TOOTHING OF NEW CONSTRUCTION WHETHER OR NOT SUCH DEMOLITION IS SPECIFICALLY SHOWN ON DEMOLITION PLANS. OVER-DEMOLISH NEW

MASONRY UNITS TO PROVIDE FINISHED OPENING. PROVIDE NEW MASONRY TIES AND HORIZONTAL JOINT REINFORCING PER SPECIFICATIONS. NEW MASONRY CONSTRUCTION SHALL PRECISELY MATCH ADJACENT EXISTING MASONRY IN COLOR, TEXTURE, PATTERN AND FINISH, U.N.O. ALL HVAC GRILLES, LOUVERS, AND OTHER MECHANICAL, ELECTRICAL, AND PLUMBING EQUIPMENT WHICH ARE ABANDONED AND/OR CALLED OUT TO BE REMOVED SHALL BE

COMPLETELY REMOVED. OPENINGS SHALL BE INFILLED WITH NEW CONSTRUCTION MATCHING EXISTING ADJACENT CONSTRUCTION. REFER TO NOTE '1' ABOVE AND MEP DRAWINGS OF RELATED EXISTING DOORS AND FRAMES SHOWN IN WALL TO BE DEMOLISHED SHALL BE REMOVED. PATCH AS NOTED. REMOVE ALL OTHER MATERIALS ASSOCIATED WITH DOOR THAT WILL NOT BE USED. REMOVE ALL WALL MOUNTED ITEMS WHICH ARE NOT SPECIFICALLY INDICATED TO BE REMOVED BUT

WHICH INTERFERE WITH, OR ARE NOT PART OF FINISHED CONSTRUCTION. OTHER SALVAGED ITEMS WHICH ARE NOT INDICATED TO BE REUSED IN THE

RENOVATION OR RETURNED TO THE OWNER MAY BE SALVAGED BY THE CONTRACTOR AND REMOVED FROM THE SITE. WHERE EXISTING EQUIPMENT OR CASEWORK IS REMOVED, REMOVE ALL ASSOCIATED ATTACHMENT DEVICES, ANCHORS ETC. PATCH AND REPAIR EXISTING FINISHES.

SEE NEW WORK PLANS FOR NEW WORK TO BE INSTALLED.

DEMOLITION NOTES

DOOR DEMOLITION NOTES:

-1 REMOVE EXISTING METAL FRAME, DOOR(S), AND GLAZING IN ENTIRETY. REFER TO PLANS FOR NEW WORK. REMOVE EXISTING DOOR HARDWARE AND SALVAGE.
REFER TO DOOR HARDWARE SPECIFICATION FOR
ADDITIONAL INFORMATION.

ESTILL COUNTY SCHOOLS IRVINE, KENTUCKY, 40336

M,E,&P Engineer: KFI Engineers 3264 Lochness Dr. Lexington, KY 40517 p 859.271.3246

BG#

23-087

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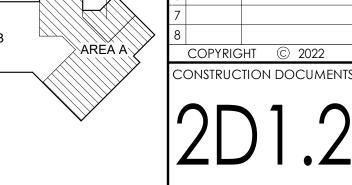
SHEET RELEASE

AREA A, C, D
DATE ISSUED:

NOVEMBER 1, 2022

KEY PLAN

AREA D AREA B AREA C AREA A



SCALE: NTS

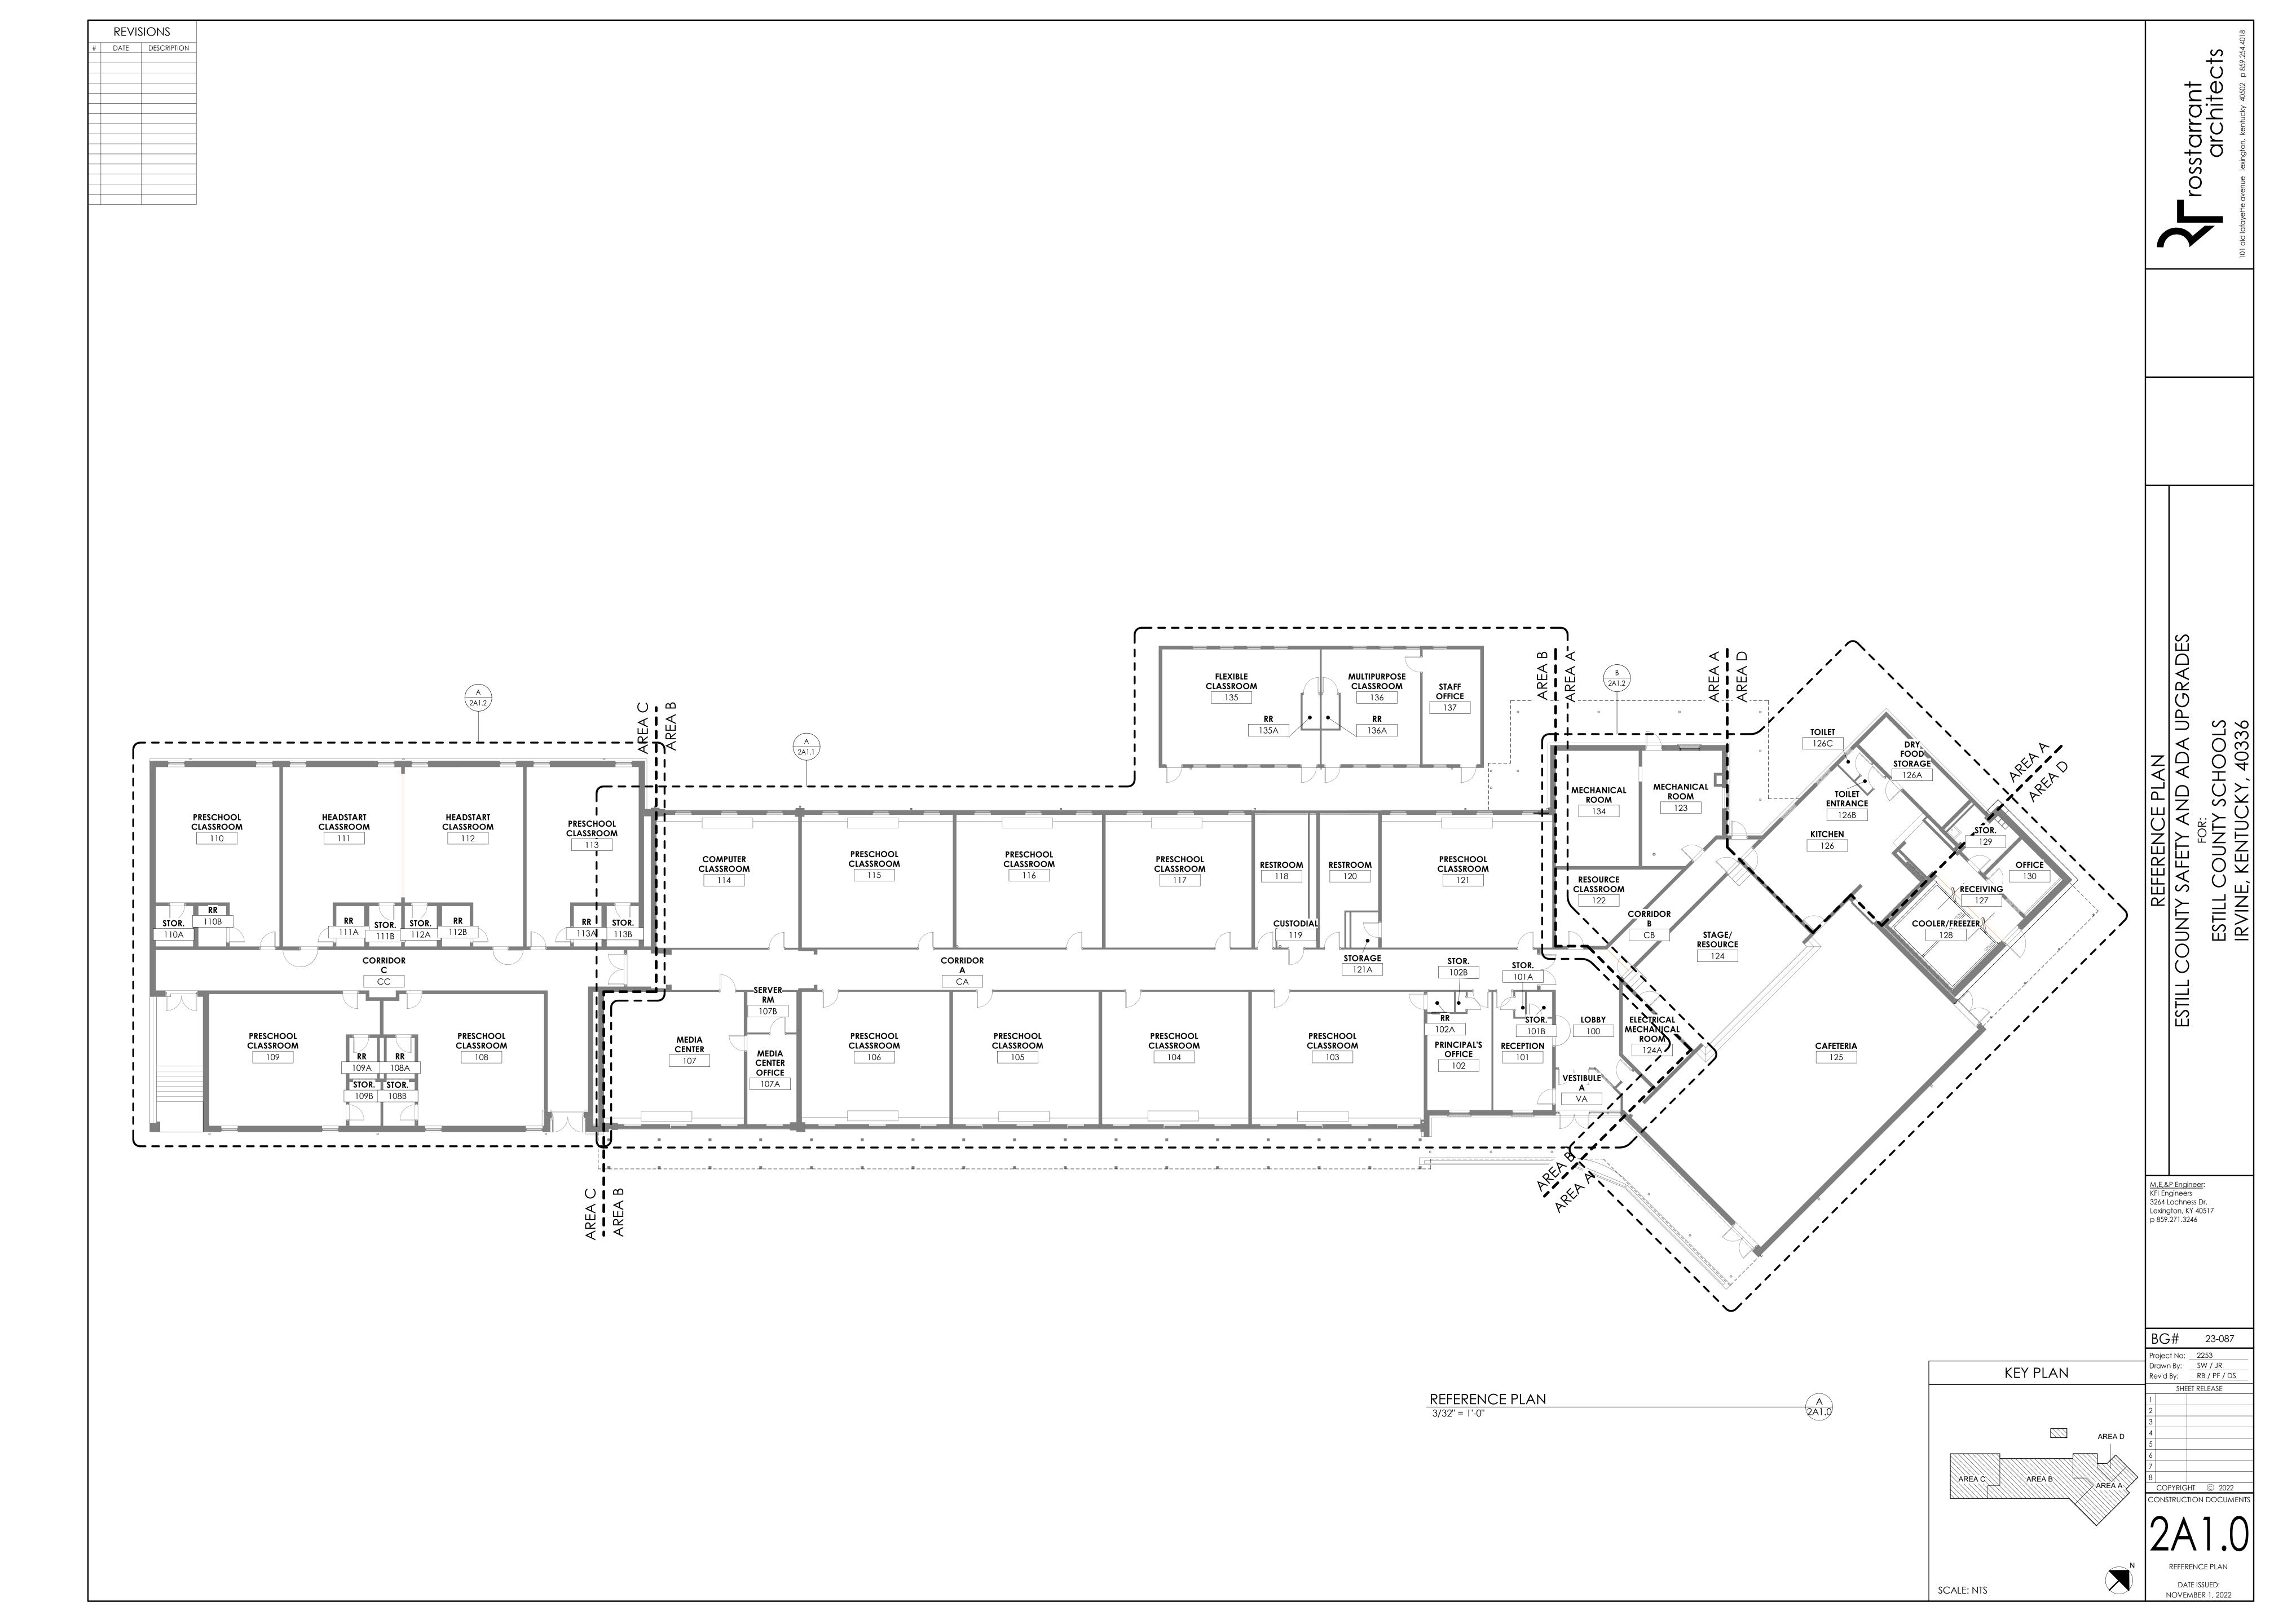
DEMOLITION FLOOR PLAN - AREA C

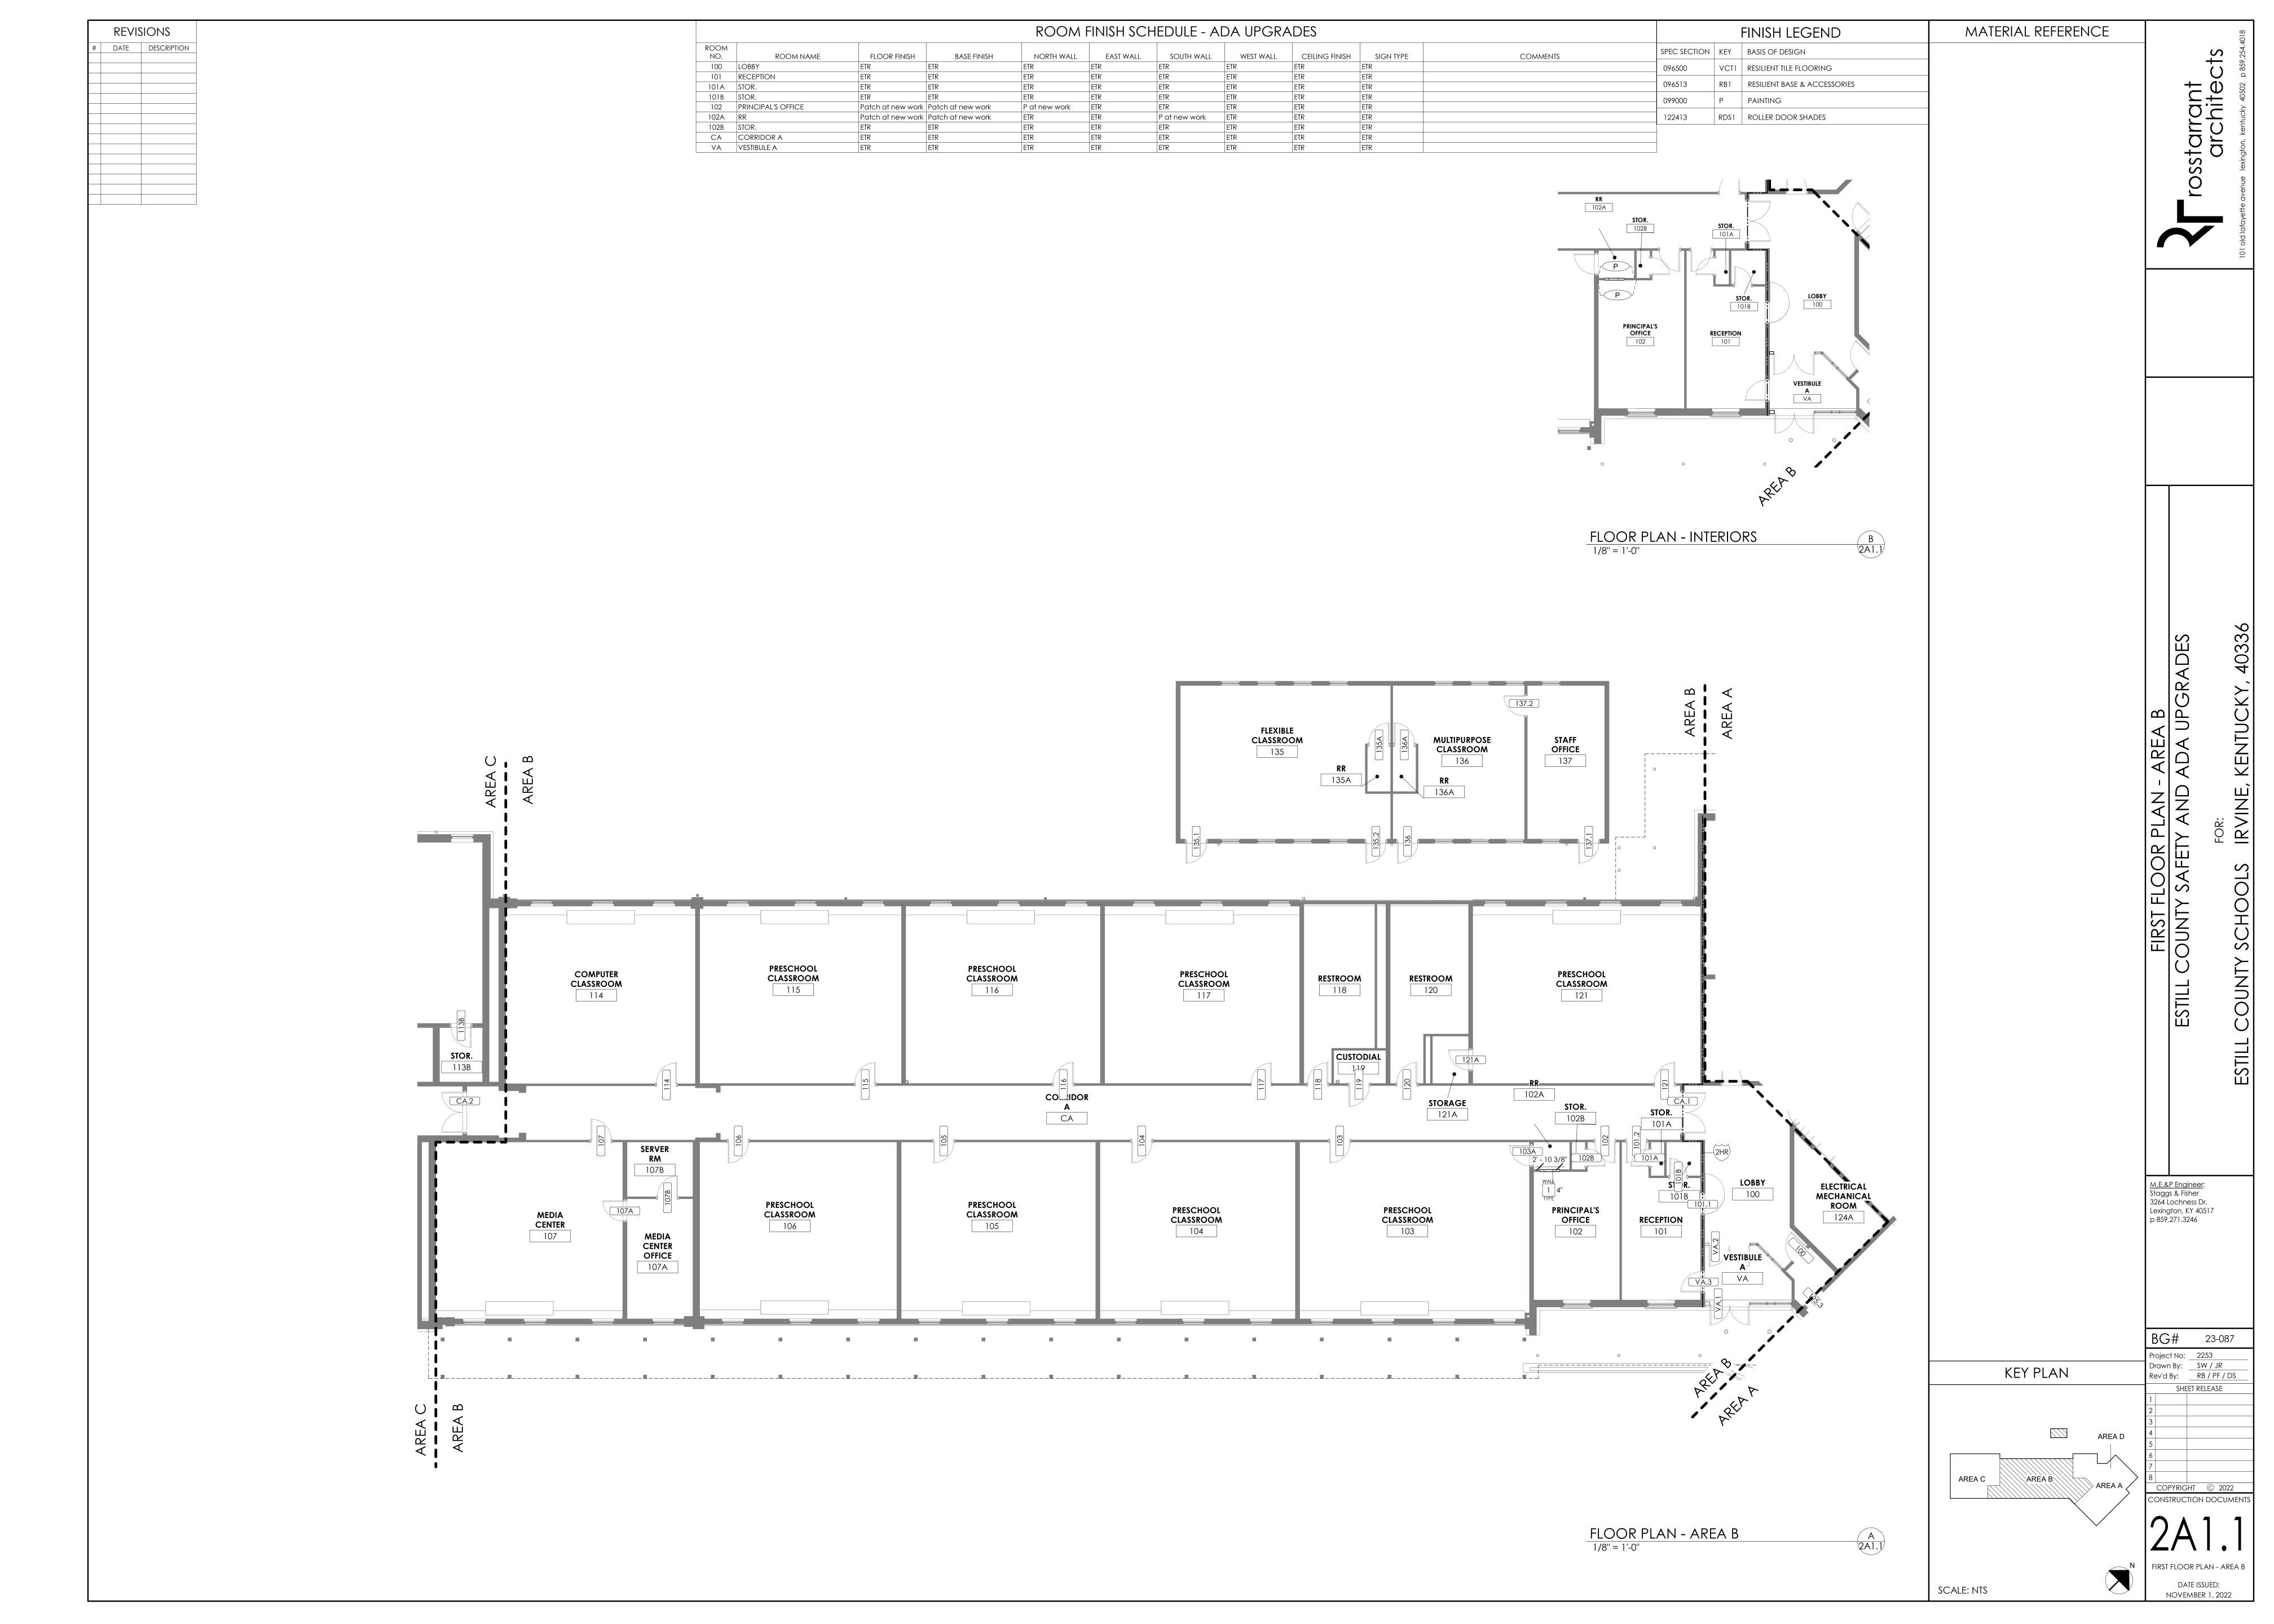
1/8" = 1'-0"

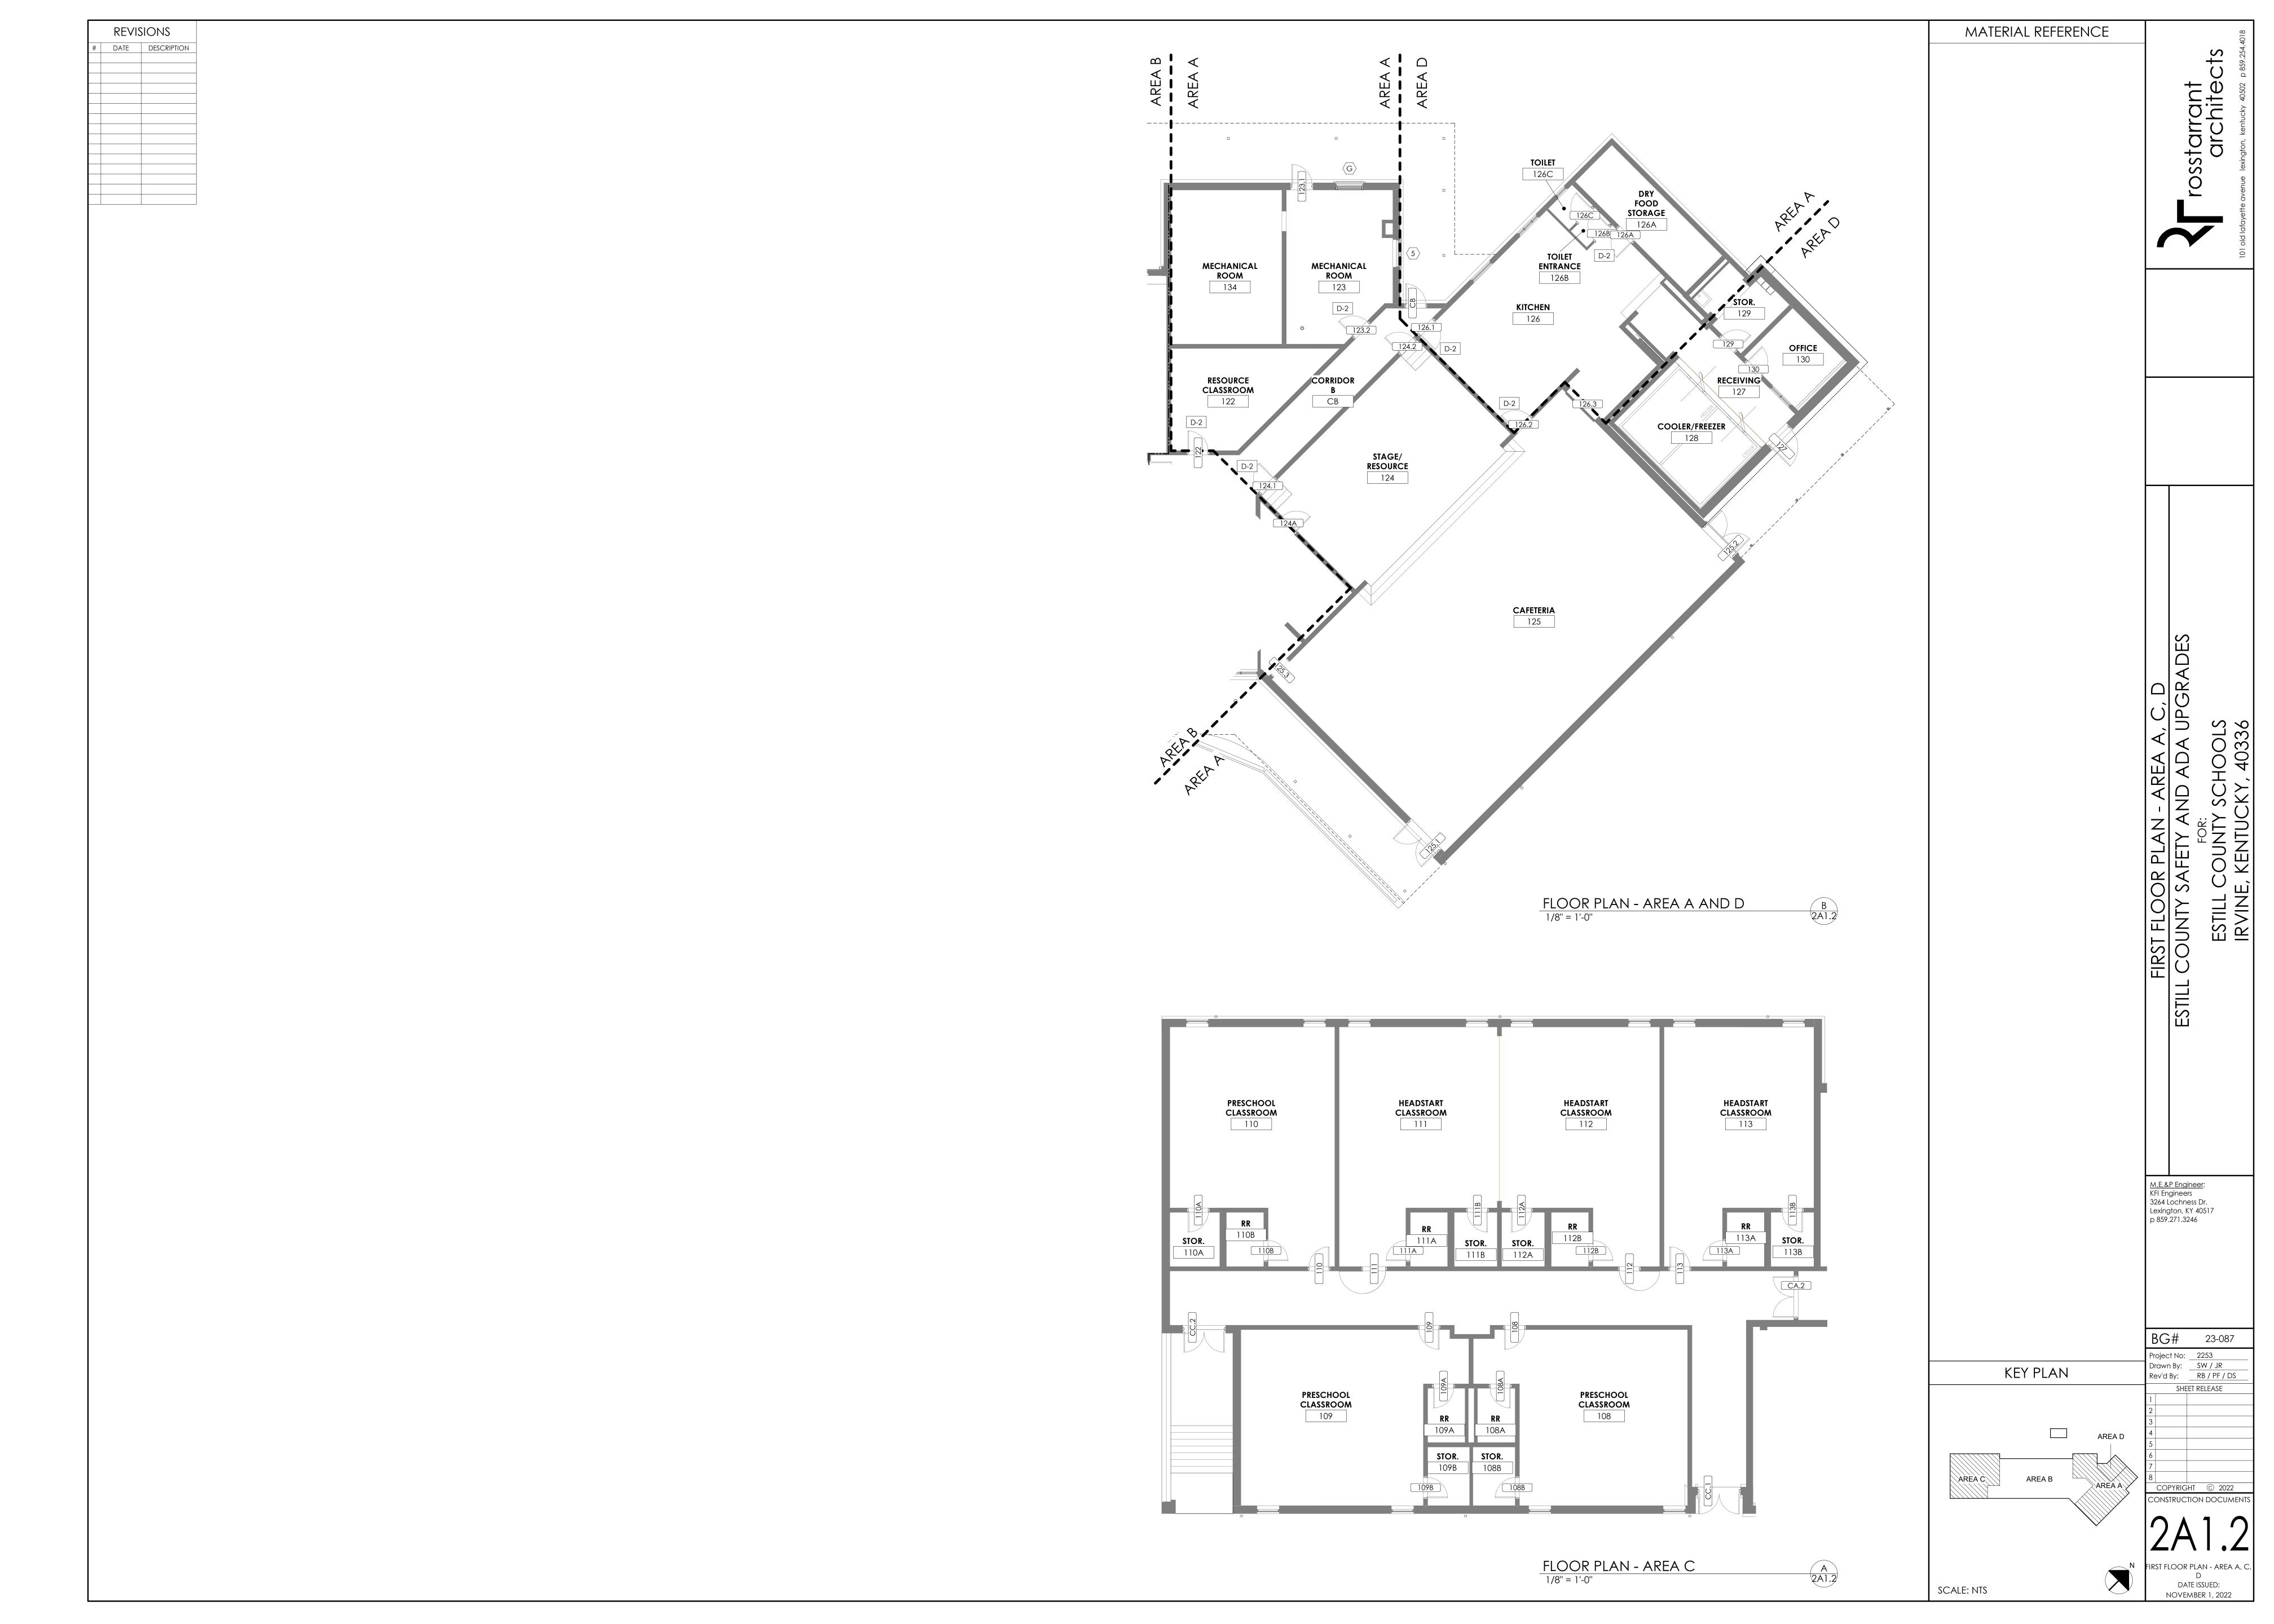
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2D1.2

DEMOLITION FLOOR PLAN -







REVISIONS # DATE DESCRIPTION	SCHEDULE OF EXISTING DOORS AN	CARD	MATERIAL REFERENCE	S 254.4018
	NUMBER ROOM PAIR W H THICK FIRE RATING 100 LOBBY 3' - 0" 7' - 0" 1 3/4" - 101.1 RECEPTION 3' - 0" 7' - 4" 1 3/4" - 101.2 RECEPTION 3' - 0" 7' - 0" 1 3/4" - 101A RECEPTION 2' - 6" 7' - 0" 1 3/4" 101B RR 2' - 6" 7' - 0" 1 3/4"	SET NO. ACCESS COMMENTS NO WORK NO WORK NO WORK NO WORK NO WORK NO WORK		ant fant hitect
	102 PRINCIPAL'S OFFICE 3' - 0" 7' - 0" 1 3/4" 102B PRINCIPAL'S OFFICE 2' - 6" 7' - 0" 1 3/4" 103 PRESCHOOL CLASSROOM 3' - 0" 7' - 0" 1 3/4" 103A PRESCHOOL CLASSROOM 3' - 0" 7' - 0" 1 3/4"	\$02 \$02 \$02 \$06		SSTAIRC AICC
	104 PRESCHOOL CLASSROOM 3' - 0" 7' - 0" 1 3/4" 105 PRESCHOOL CLASSROOM 3' - 0" 7' - 0" 1 3/4" 106 PRESCHOOL CLASSROOM 3' - 0" 7' - 0" 1 3/4"	\$02 \$02 \$02		Cayette avenue
	107 CORRIDOR A 3' - 0" 7' - 0" 1 3/4" 107A MEDIA CENTER 3' - 0" 7' - 0" 1 3/4" 107B SERVER RM 3' - 0" 7' - 0" 1 3/4" 108 PRESCHOOL 3' - 0" 7' - 0" 1 3/4" 108A PRESCHOOL 3' - 0" 7' - 0" 1 3/4"	\$02A \$02A \$03A \$04		101 old la
	CLASSROOM 3' - 0" 7' - 0" 1 3/4"	S04 S04		
	110 PRESCHOOL CLASSROOM 3' - 0" 7' - 0" 1 3/4" 110A STOR 3' - 0" 7' - 0" 1 3/4" 110B PRESCHOOL 3' - 0" 7' - 0" 1 3/4"	\$05 \$04 \$04 \$04 \$05		
	CLASSROOM	\$04 \$05 \$04 \$04		
	CLASSROOM	S04 S05 S04		
	114 COMPUTER 3' - 0" 7' - 0" 1 3/4"	S05 S04 S02A S02		
	CLASSROOM 3' - 0" 7' - 0" 1 3/4" 116 PRESCHOOL CLASSROOM 3' - 0" 7' - 0" 1 3/4" 117 PRESCHOOL CLASSROOM 3' - 0" 7' - 0" 1 3/4" 118 RESTROOM 3' - 0" 7' - 0" 1 3/4"	\$02 \$02 \$07		
	120 RESTROOM 3' - 0" 7' - 0" 1 3/4"	\$03 \$07 \$02 \$03 \$02		A D ES
	123.1 MECHANICAL ROOM 123.2 MECHANICAL ROOM 124.1 LOBBY 124.2 CORRIDOR B 124.2 STAGE 3'-0" 7'-0" 13/4" 13/4" 13/4" 13/4" 13/4" 13/4"	S03 S02 S02 S03		HEDULE A UPGR/ OLS 336
	126A KITCHEN 3' - 0" 7' - 0" 1 3/4"	NO WORK NO WORK S02 S02 S06 S02		SC A S S S S S S S S S S S S S S S S S S
	126C TOILET 3' - 0" 7' - 0" 1 3/4" 127 RECEIVING 4' - 0" 7' - 0" 1 3/4" - 129 RECEIVING 3' - 0" 7' - 0" 1 3/4" 130 RECEIVING 3' - 0" 7' - 0" 1 3/4"	S06 S06 NO WORK NO WORK NO WORK		FRAME TY AND FOR: NTUCKY
		S01 S01 S06 S01 S06		AND SAFE COU
	137.1 STAFF OFFICE 3' - 0" 6' - 8" 1 3/4" 137.2 STAFF OFFICE 3' - 0" 7' - 0" 1 3/4" CA.1 LOBBY X 6' - 0" 7' - 0" 1 3/4" CA.2 CORRIDOR C X 6' - 0" 7' - 0" 1 3/4" CB CORRIDOR B 3' - 0" 7' - 0" 1 3/4" -	\$01 \$06 \$06 \$08 NO WORK		OORS AN OUNTY SA ESTILL C IRVINE,
	CC.1 CORRIDOR C X 6' - 0" 7' - 0" 1 3/4" - CC.2 CORRIDOR C X 6' - 0" 7' - 0" 1 3/4" - VA.1 X 5' - 10" 13' - 10" 1 3/4" VA.2 X 6' - 0" 7' - 0" 1 3/4" VA.3 3' - 0" 7' - 0" 1 3/4"	ES01 X ELECTRIFIED NO WORK NO WORK NO WORK NO WORK		STILL C
				ŭi
				M E & P Engineer
				M,E,&P Engineer: KFI Engineers 3264 Lochness Dr. Lexington, KY 40517 p 859.271.3246
				BG# 23-087
			DOOR SCHEDULE ABBREVIATION LEGEND AL = ALUMINUM	Project No: 2253 Drawn By: SW / JR Rev'd By: RB / PF / DS SHEET RELEASE 1
			AW = ALUMINUM WINDOW ARG = ASSAULT RESISTANT GLAZING BN = BULLNOSE BR = BULLET RESISTANT GLAZING CW = CURTAINWALL F = FIRE RATED GLAZING	3 4 5 6
			HM = HOLLOW METAL I = INSULATED IFA = INTEGRATED FRAME ASSEMBLY IP = INFILL PANEL L = LAMINATED O = OBSCURE GLAZING S = SMOKE	7 8 COPYRIGHT © 2022 CONSTRUCTION DOCUMENTS
			S = SMOKE SF = STOREFRONT SPG. = SPANDREL GLAZING T. = TEMPERED T.I. = TEMPERED INSULATED W = WIRE GLASS WD = WOOD	2A6.1 DOORS AND FRAME SCHEDULE
			*SEE DRAWING A0.1 FOR MORE ABBREVIATIONS.	DATE ISSUED: NOVEMBER 1, 2022

REVISIONS				
#	DATE	DESCRIPTION		

ELECTRICAL LEGEND WALL SWITCHES (BOTTOM 44" A.F.F.) RECEPTACLES (BOTTOM 16" A.F.F.) **EQUIPMENT, CONDUITS, ETC. ELECTRICAL ABBREVIATIONS** (EXCEPT AS NOTED OTHERWISE) $\models = = = = = = \Rightarrow \mid$ CONDUIT BELOW FLOOR DUPLEX CONVENIENCE OUTLET ABOVE FINISHED FLOOR SINGLE POLE AFF AUTOMATIC TEMPERATURE \longrightarrow QUADRAPLEX CONVENIENCE OUTLET CONDUIT ABOVE FLOOR DOUBLE POLE ATCP CONTROL PANEL ENTRANCE POINT OF CONDUIT THREE-WAY CONDUIT THROUGH FLOOR BACKSPLASH/COUNTER DUPLEX OUTLET. COORDINATE WITH ARCHITECTURAL FOUR-WAY FA FIRE ALARM WIREWAY OR CABLE TRAY LOW-VOLTAGE, MOMENTARY GFI GROUND FAULT INTERRUPTER GROUND FAULT INTERRUPTING OUTLET WIRF MOLD OCCUPANCY/VACANCY SENSOR SWITCH ISOLATED GROUND WEATHERPROOF OUTLET (FOR POWER AND/OR DATA) PANELBOARD OR TERMINAL CABINET DIMMER JUNCTION BOX SWITCHED/CONTROLLED DUPLEX OUTLET (REFER TO PLANS AND RISER FOR SIZE) DUPLEX RECEPTACLE ON EMERGENCY PILOT LIGHT TELEPHONE TERMINAL CABINET TTC SECTIONAL SWITCH GEAR (REFER TO PLANS AND RISER FOR NUMBER OF SECTIONS AND LAYOUT) THERMAL OVERLOAD CEILING MOUNTED RECEPTACLE. THERMAL OVERLOAD WITH PILOT LIGHT USB DUPLEX RECEPTACLE. FLUSH (REFER TO PLANS AND RISER FOR SIZE) SIMPLEX WALL OUTLET JUNCTION BOX KEY OPERATED SWITCH PEDESTAL \rightarrow (RATING AS NOTED) WALL OUTLET (240V, 1-PHASE) ENCLOSED CIRCUIT BREAKER LIGHTING CONTROL STATION CKT CIRCUIT (RATING AS NOTED) WALL OUTLET (240V, 3-PHASE) DISCONNECT SWITCH MASTER LIGHTING CONTROL STATION RECEPTACLE(S) REC(S) (RATING AS NOTED) FLOOR BOX / POKE-THRU FOR FUSED DISCONNECT LTG LIGHTING POWER AND/OR DATA SECURITY COMBINATION MAGNETIC STARTER AND HOOD CONNECTION NIGHT LIGHT FUSED SWITCH CARD READER / PROXIMITY READER MOTOR EQUIPMENT CONNECTION AMPERE INTERRUPTING CAPACITY DOOR PUSH PLATE - GROUND CONTROL RELAY UON UNLESS OTHERWISE NOTED KEY PAD WIRE / CONDUIT WP WEATHER PROOF \bowtie DOOR CONTACTS BOTTOM OF DEVICE (IN INCHES A.F.F.) FACP FIRE ALARM CONTROL PANEL V./SECURITY CAMERA OUTLET (1)— SEE NOTE 1 THIS SHEET FIRE ALARM ANNUNCIATOR PANEL FAAP T.V./SECURITY CAMERA OUTLET WALL MOUNTED LCP LIGHTING CONTOL PANEL HEADWALL - FOR SERVICES, SEE DETAILS MOTION DETECTOR GROUND >\$< SIREN

THE SYMBOLS LISTED ON THIS SHEET MAY NOT ALL BE USED ON THIS SET OF CONTRACT DRAWINGS, HOWEVER, WHEREVER A SYMBOL IS USED THE ITEM SHALL BE FURNISHED AND INSTALLED.

AUDIO OR GLASS BREAK SENSOR

DOOR TOGGLE SWITCH

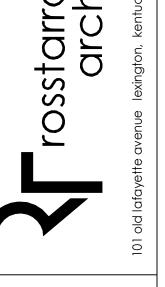
ELECTRICAL GENERAL NOTES

- 1. PROVIDE SUPPORTS FOR ALL VERTICAL CONDUIT RUNS IN ACCORDANCE WITH THE NATIONAL ELECTRICAL CODE.
- 2. ELECTRICAL CONTRACTOR SHALL INSTALL ALL ELECTRICAL EQUIPMENT IN ACCORDANCE WITH THE NATIONAL ELECTRICAL CODE.
- 3. CONTRACTOR SHALL CHECK ALL DOOR SWINGS AND SHALL BE RESPONSIBLE FOR INSTALLING ALL ROOM LIGHT SWITCHES/CONTROL STATIONS ASSOCIATED WITH DOORS ON THE STRIKE SIDE OF THE DOORS REGARDLESS OF THE INDICATION ON THE ELECTRICAL DRAWINGS. SWITCHES NOT COMPLYING SHALL BE RELOCATED AT THE CONTRACTOR'S
- 4. ALL CONDUIT SHALL BE HOMERUN TO PANELBOARD AS INDICATED ON THE DRAWINGS. COMBINING OF CIRCUITS IN HOMERUNS WILL NOT BE ACCEPTABLE. ANY DEVIATIONS IN SUCH WORK WILL NOT BE APPROVED EXCEPT AS REQUIRED TO MEET THE NATIONAL ELECTRICAL CODE OR BY PERMISSION OF THE ENGINEER.
- 5. ALL CONDUIT SHALL BE CONCEALED IN EXISTING AND NEW WALLS AND CEILINGS EXCEPT MECHANICAL ROOMS. REFER
- 6. ELECTRICAL CONTRACTOR SHALL LOCATE ALL ELECTRICAL EQUIPMENT AS REQUIRED TO INSURE MINIMUM
- CLEARANCES ARE PROVIDED IN ACCORDANCE WITH THE N.E.C. 7. ALL SCHEMATICS ARE FOR BID PURPOSES ONLY. SYSTEMS SHALL BE INSTALLED IN ACCORDANCE WITH WIRING
- DIAGRAMS OBTAINED FROM THE MANUFACTURER. 8. ALL DEVICES SHALL BE LOCATED ON CLEAR WALL SPACES, CLEAR OF ALL SHELVING, CHALKBOARDS, TACKBOARDS,
- CASEWORK, ETC. OUTLETS NOT COMPLYING WITH THE ABOVE SHALL BE RELOCATED AT THE CONTRACTOR'S EXPENSE. 9. ROUGH-IN FOR EQUIPMENT SHALL BE DONE IN ACCORDANCE WITH APPROVED SHOP DRAWINGS.
- 10. ELECTRICAL CONTRACTOR SHALL COORDINATE HEIGHT OF ALL DEVICES AT ALL CASEWORK LOCATIONS TO AVOID CONFLICTS. ALL OUTLETS SHALL BE ROUGHED-IN IN ACCORDANCE WITH ARCHITECTURAL CASEWORK ELEVATIONS. EXACT LOCATION OF ALL OUTLETS SHALL BE AS DIRECTED BY THE OWNER.
- 11. COORDINATE EXACT LOCATION OF ALL DEVICES IN THE CEILING WITH THE EXISTING DEVICES.

16. ABSOLUTELY NO "LB'S" ARE ALLOWED IN ANY COMMUNICATIONS CONDUIT INSTALLATION.

- 12. THE CONTRACTOR SHALL PROVIDE EQUIPMENT GROUNDING CONDUCTORS IN ALL FEEDERS TO GROUND BUS IN PANELBOARDS AND IN ALL CIRCUITS TO EQUIPMENT AND RECEPTACLES. SEE SPECIFICATIONS.
- 13. PROVIDE 5' EXCESS CABLE COILED ABOVE THE CEILING FOR EACH DATA DROP.
- 14. LABEL CABLES BOTH AT THE RACK AND AT THE INDIVIDUAL OUTLET.
- 15. NO MORE THAN AN EQUIVALENT OF 270 DEGREES OF BEND, INCLUDING OFFSETS, IS ALLOWED IN A CONDUIT RUN BETWEEN JUNCTION BOXES OR PULL BOXES.
- 17. CONDUIT ENDS AT A CABLE TRAY WILL HAVE PLASTIC BUSHINGS AND BE WIRE BONDED TO THE TRAY.
- 18. CONDUIT THAT TERMINATES IN THE TELECOMMUNICATIONS ROOM MUST HAVE PLASTIC BUSHINGS AND BE WIRE BONDED TO THE GROUND BAR LOCATED IN THE ROOM.

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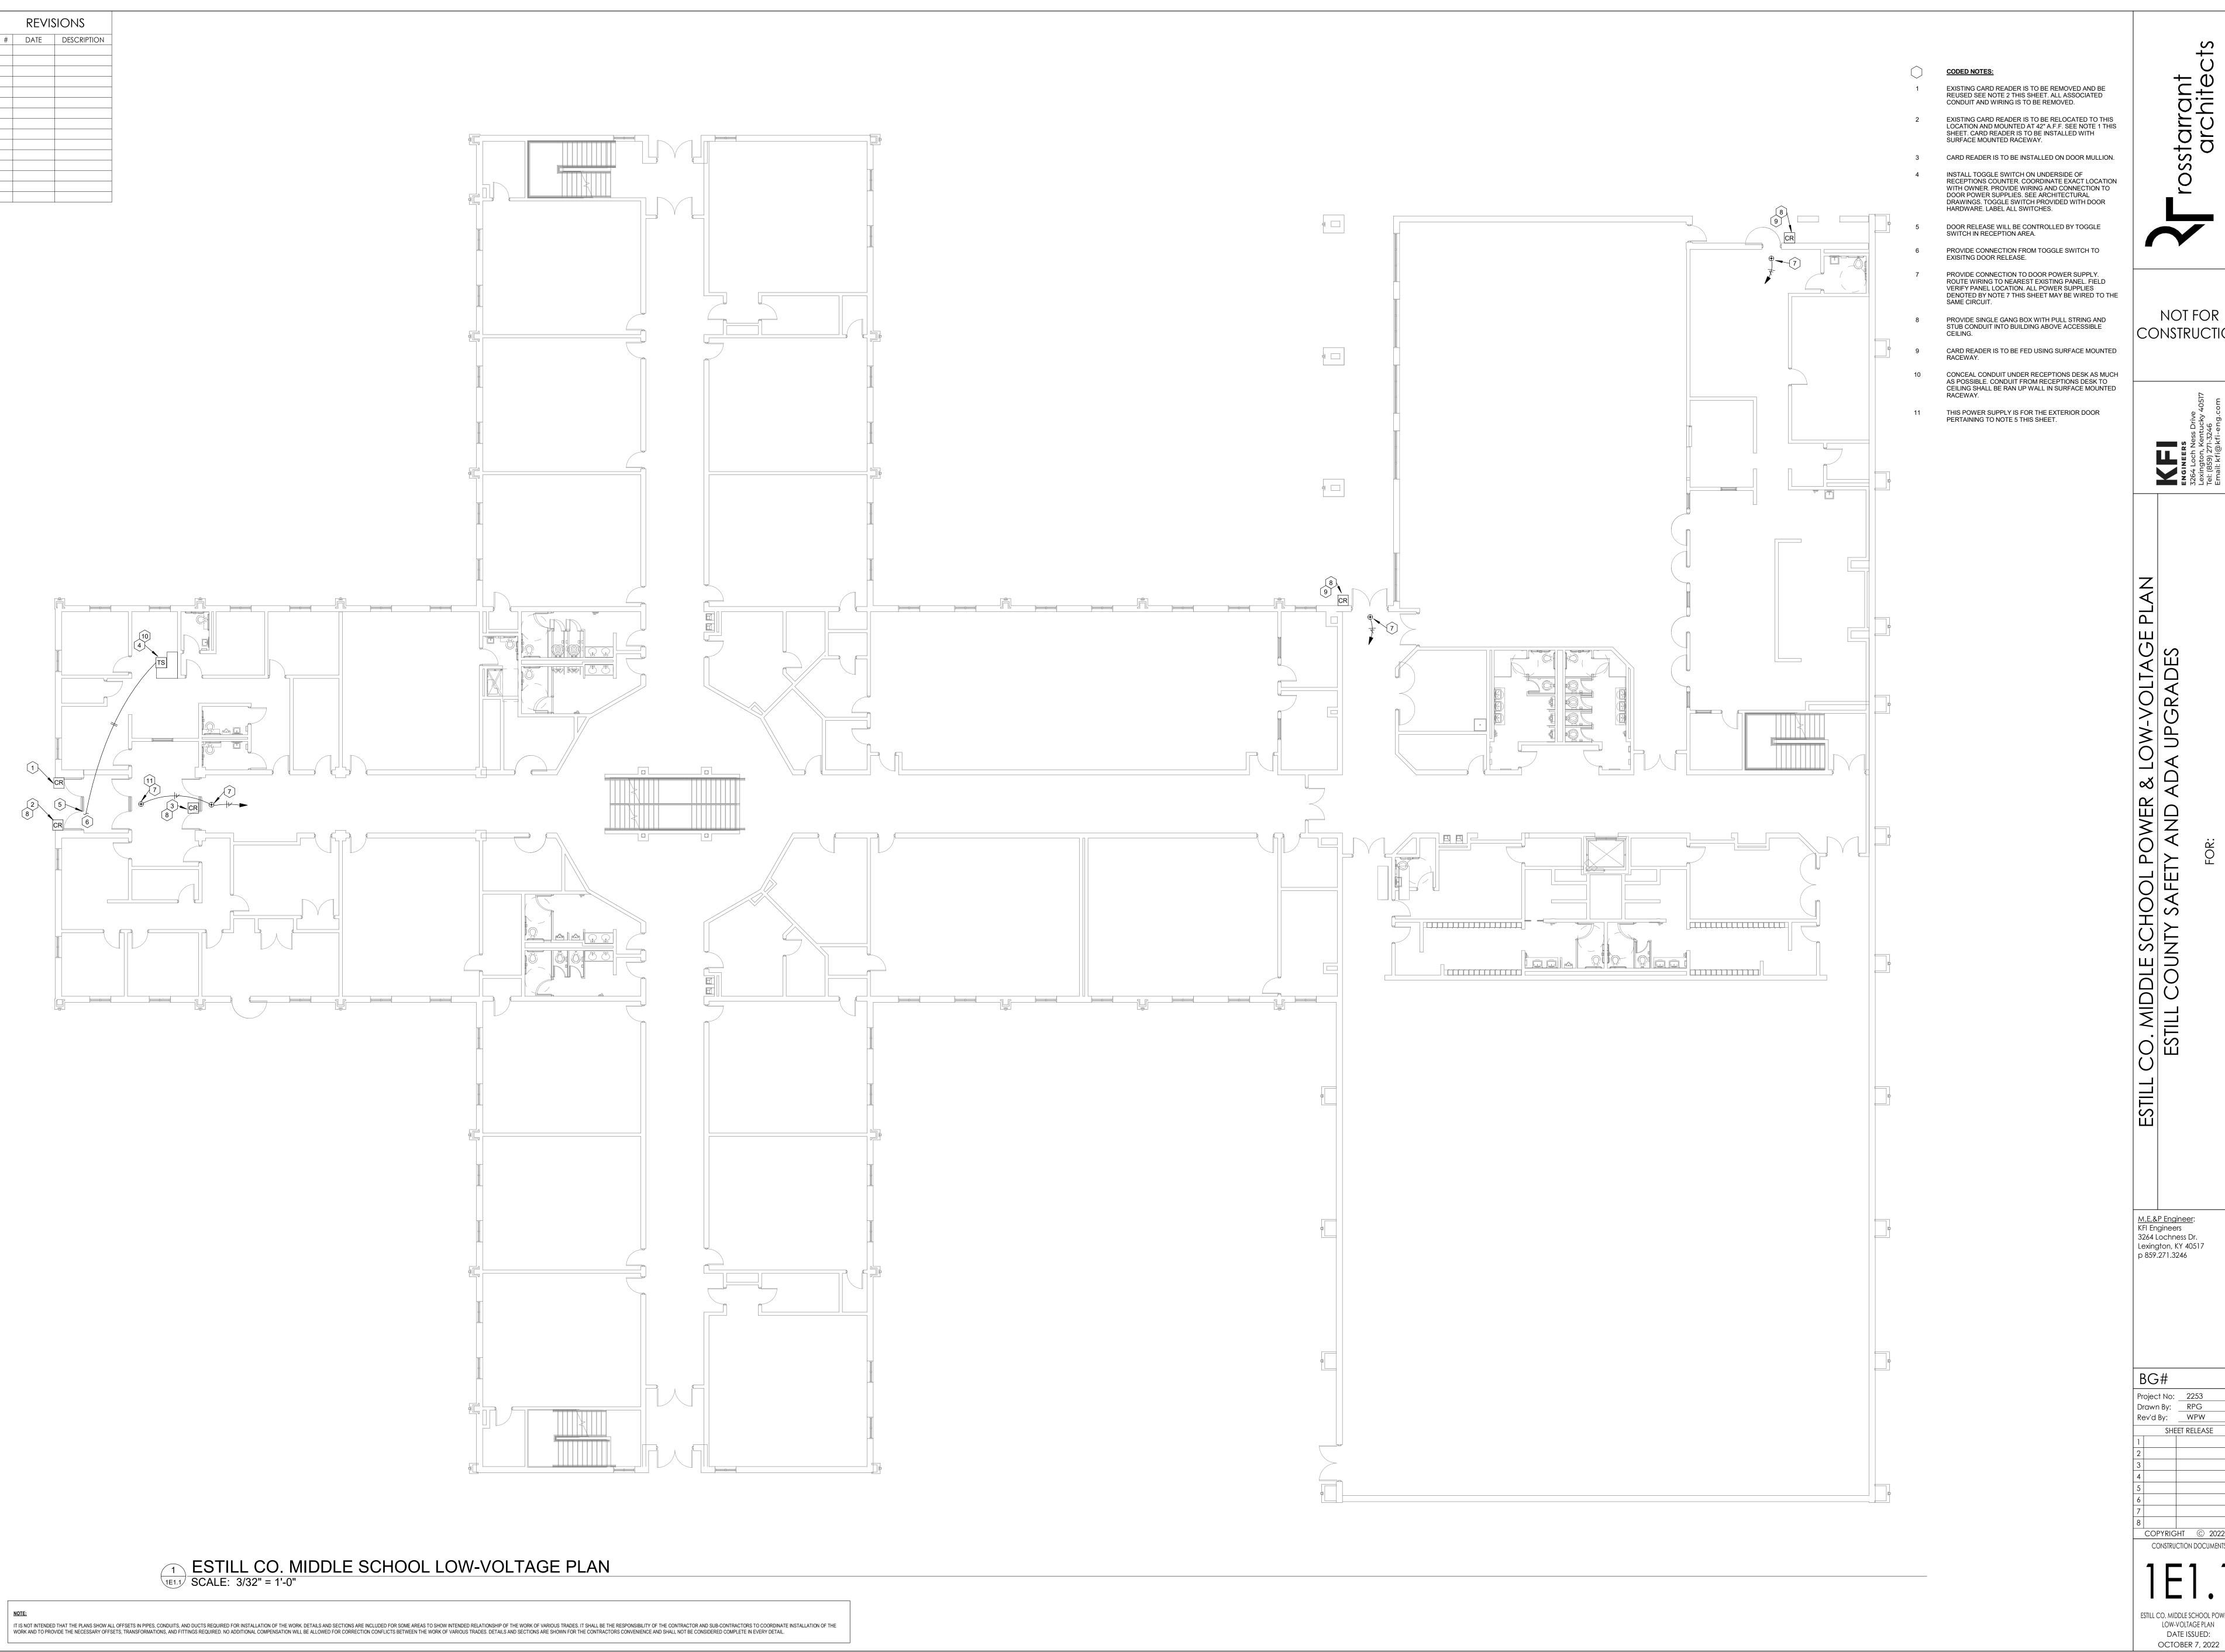


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Project No: 2253
Drawn By: RPG
Rev'd By: WPW SHEET RELEASE CONSTRUCTION DOCUMENTS

ELECTRICAL LEGEND AND GENERAL NOTES DATE ISSUED:

OCTOBER 7, 2022



CONSTRUCTION

M,E,&P Engineer: KFI Engineers 3264 Lochness Dr. Lexington, KY 40517 p 859.271.3246

Drawn By: RPG
Rev'd By: WPW SHEET RELEASE CONSTRUCTION DOCUMENTS

ESTILL CO. MIDDLE SCHOOL POWER & LOW-VOLTAGE PLAN

- **CODED NOTES:**
- PROVIDE CONNECTION TO DOOR POWER SUPPLY. TIE IN TO NEAREST CORRIDOR CIRCUIT. FIELD VERIFY.
- PROVIDE SINGLE GANG BOX WITH PULL STRING AND STUB CONDUIT INTO BUILDING ABOVE ACCESSIBLE CEILING.
- 3 CARD READER IS TO BE FED USING SURFACE MOUNTED RACEWAY.

NOT FOR CONSTRUCTION

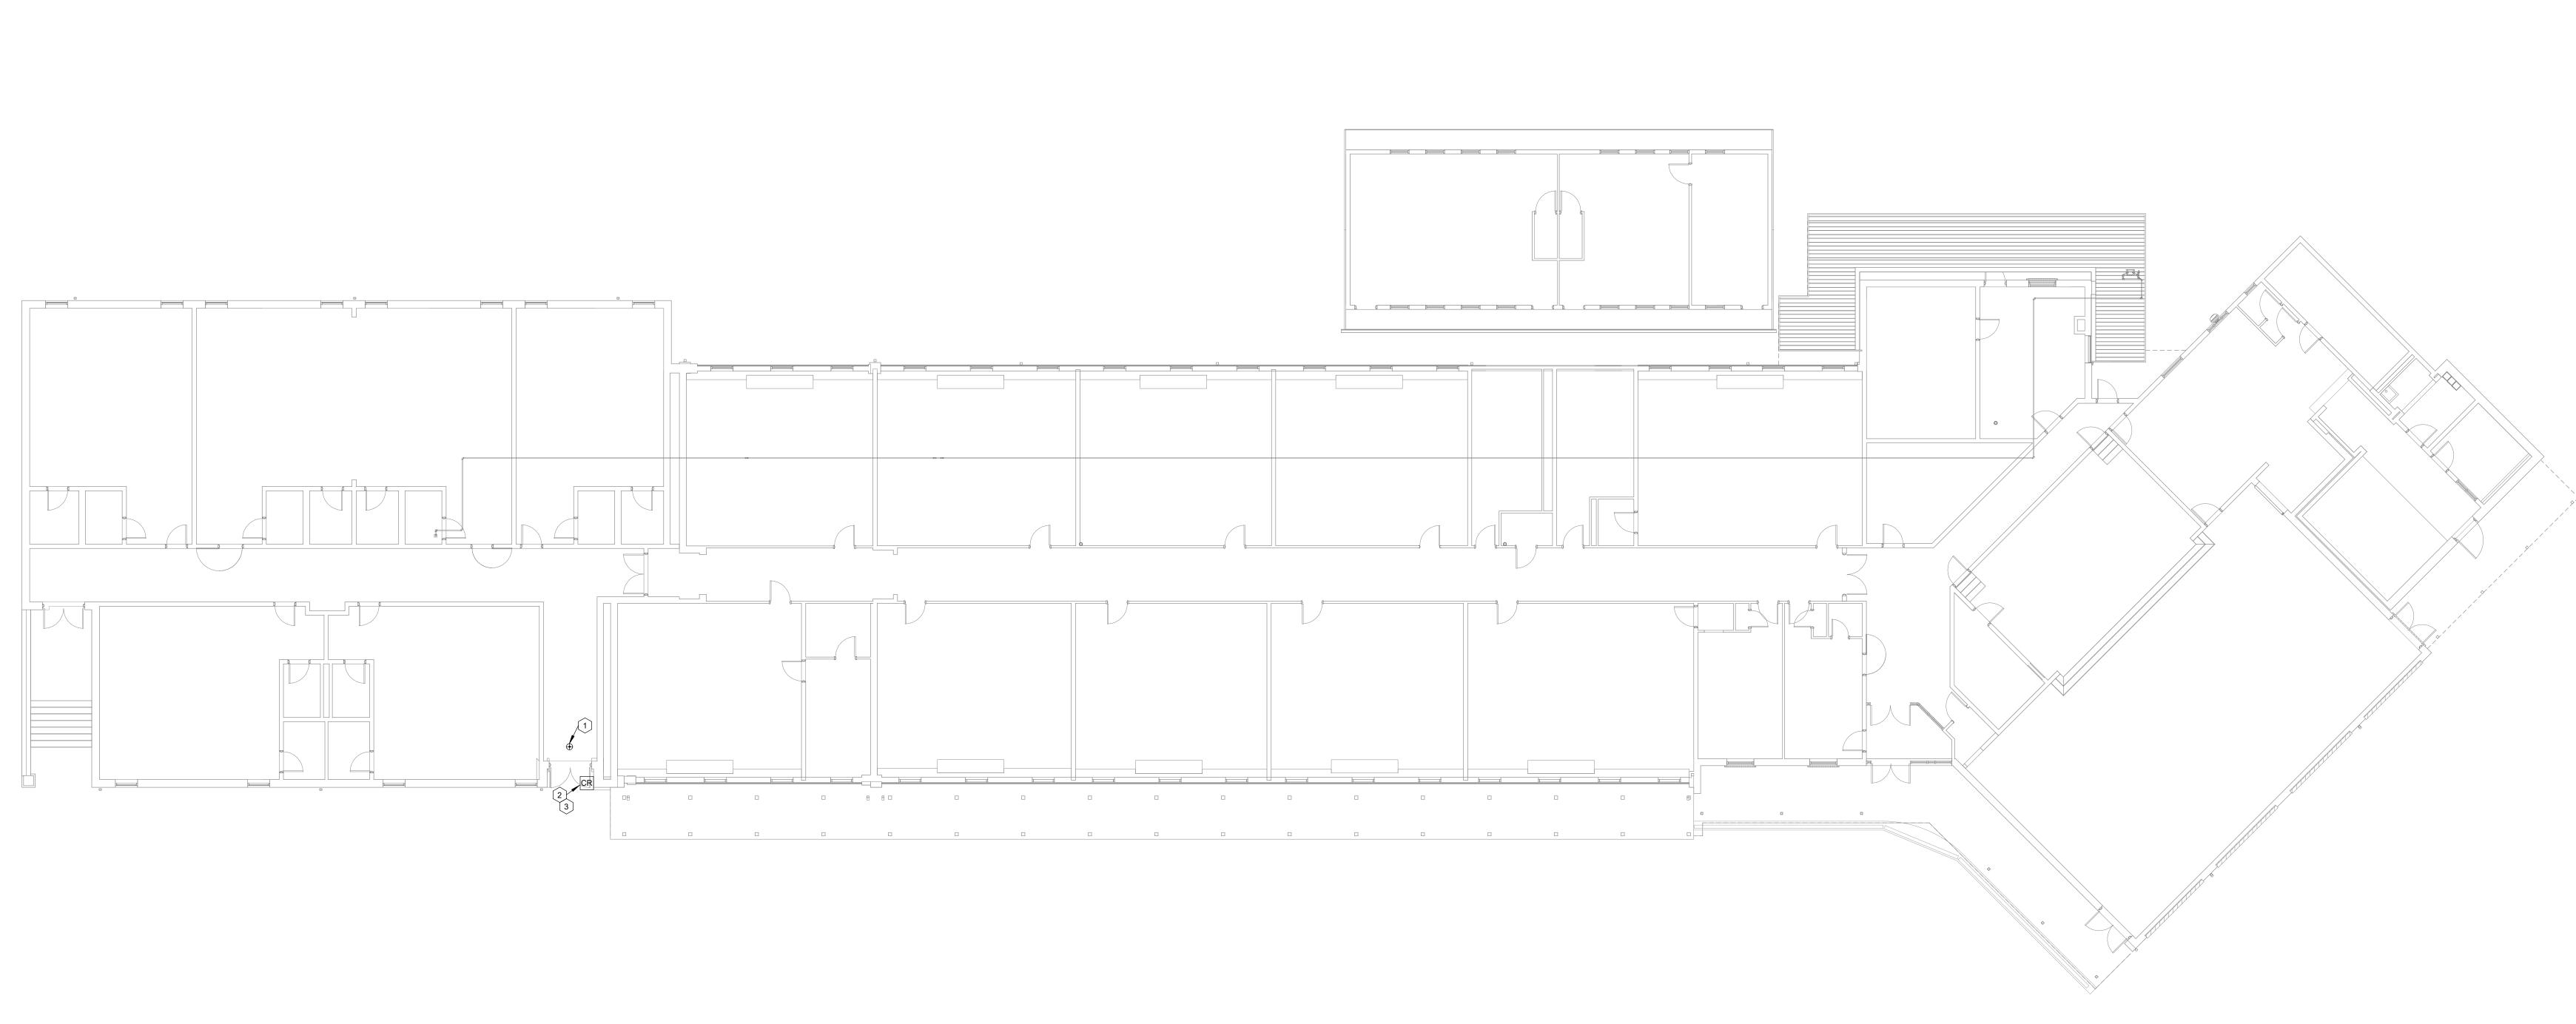
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Rev'd By: WPW SHEET RELEASE

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SOUTH IRVINE POWER & LOW-VOLTAGE PLAN DATE ISSUED: OCTOBER 7, 2022



SOUTH IRVINE LOW-VOLTAGE PLAN
SCALE: 3/32" = 1'-0"