

# NEW FCPS COMBINED CTE SCHOOL

## PERMIT SET

07/20/2022

100 MIDLAND AVE., LEXINGTON, KY 40508

FAYETTE COUNTY PUBLIC SCHOOLS  
DEMETRUS LIGGINS, SUPERINTENDENT

TYLER MURPHY, CHAIR  
AMY GREEN, VICE CHAIR  
CHRISTY MORRIS  
TOM JONES  
STEPHANIE ASCHMANN SPIRES



### GENERAL NOTES

THE PURPOSE OF THE CONTRACT DOCUMENTS IS TO PROVIDE DESIGN INTENT. IN SOME INSTANCES THE DOCUMENTS REQUIRE PROPRIETARY COMPONENTS TO MEET THE DESIGN INTENT. THE CONTRACTOR SHALL VERIFY NO COMPROMISE WILL BE MADE AFTER BID AND TO BRING WORK INTO COMPLIANCE.

THE CONTRACTOR SHALL PROVIDE BIDDING FOR ALL ITEMS TO BE ANCHORED OR SECURED TO WALLS, FLOORS, & CEILING WHICH MAY INCLUDE BUT IS NOT LIMITED TO WALL & CEILING RELATED EQUIPMENT, OWNER-FURNISHED CONTRACTOR-INSTALLED ITEMS, & OWNER-FURNISHED OWNER-INSTALLED ITEMS. PROVIDE FIRE TREATED MATERIAL WHERE REQUIRED BY THE APPLICABLE BUILDING CODE.

ALL WORK INCLUDED ON THESE DRAWINGS IS NEW & A CONTRACTOR UNLESS NOTED OTHERWISE.

ALL SECTIONS, DETAIL MATERIALS, & METHODS SHOWN & REFERRED TO ON ANY SHEET SHALL APPLY TO ALL OTHER SIMILAR LOCATIONS UNLESS NOTED OTHERWISE.

NO CONTRACTOR HAS THE AUTHORITY TO PERMIT THE USE OF ANY PORTION OF THE SITE OR BUILDING TO AVOID, EXCEPT FOR BUSINESS CONNECTED TO THE CONSTRUCTION WITH WHICH THIS CONTRACT IS CONCERNED.

REMOVE & EQUALIZE DEPTH OF DEBRIS, RUBBISH & OTHER DEBRIS/REMOVE MATERIALS FROM THE SITE.

THE CONTRACTOR SHALL MAINTAIN & PROTECT ALL EXISTING UTILITIES AND SERVICES. THE CONTRACTOR SHALL MAINTAIN & PROTECT ALL EXISTING UTILITIES AND SERVICES. THE CONTRACTOR SHALL MAINTAIN & PROTECT ALL EXISTING UTILITIES AND SERVICES.

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INSTALL SEALANTS BETWEEN BUILDING SYSTEMS AT BOTH INTERIOR & EXTERIOR LOCATIONS TO ENSURE A WATER-TIGHT ENCLOSURE. UTILIZE SHIM, JANT MATERIALS, & BACKER ROD TO ENHANCE & MAINTAIN CONTACT BETWEEN SYSTEMS. REFER TO SPECIFICATIONS FOR ADDITIONAL REQUIREMENTS.

PROVIDE SHIMS BETWEEN BUILDING SYSTEMS & COMPONENTS AS REQUIRED FOR PROPER ALIGNMENT.

REMOVE NON-COMPATIBLE METALS & DISSIMILAR MATERIALS TO PREVENT GALVANIC ACTION.

INSTALL ALL DOORS, EQUIPMENT & BUILDING COMPONENTS WITH DIMENSIONAL TOLERANCES IN COMPLIANCE WITH THE AMERICANS WITH ABILITIES ACT, WHERE CONFLICTS EXIST WITH THE CONTRACT DOCUMENTS, NOTIFY ARCHITECT PRIOR TO PROCEEDING.


CONTRACTOR SHALL ASSURE THAT DIGITAL DRAWING FILES ARE NOT AVAILABLE UNLESS THEY ARE PROVIDED TO THE ARCHITECT BY THE CONTRACTOR.

ALL DIMENSIONS SHOWN ON PLANS ARE TO CENTERLINE OF COLUMN FACE OF MASONRY/CONCRETE/TALL DOOR. DO NOT INCLUDE THICKNESS OF FINISHES SUCH AS CEILING, UNLESS OTHERWISE NOTED. CONTRACTOR SHALL NOT SCALE DRAWINGS FOR DIMENSIONS. REFER TO ENLARGED PLAN FOR ADDITIONAL DIMENSIONS.

### SHEET LIST

SHT. No.	SHEET NAME	SHT. No.	SHEET NAME	SHT. No.	SHEET NAME	SHT. No.	SHEET NAME
COV	COVER SHEET	A108	OVERALL COLUMN PLANS	A095	ENL. FURN. PLANS - ADMIN. & COMMON AREAS LEVELS 3 & 4	M010	FIRST FLOOR PLAN - MECHANICAL PIPING
D01	DOOR DETAILS	A109	PLAN DETAILS	A096	ENL. FURN. PLANS - CULINARY ARTS INTER. CLIMB & LAB	M011	SECOND FLOOR PLAN - MECHANICAL PIPING
D02	DOOR DETAILS	A110	ENL. FURN. PLANS - CULINARY ARTS CLIMB & SPAN LAB	A097	ENL. FURN. PLANS - CULINARY ARTS CLIMB & SPAN LAB	M012	THIRD FLOOR PLAN - MECHANICAL PIPING
EXT	EXISTING SITE SURVEY	A111	EXTERIOR COLUMN DETAILS	A098	ENL. FURN. PLANS - CINEMA & VIDEO CLIMB (LAB & COMP) / FLEX CLIMB	M013	THIRD FLOOR PLAN - MECHANICAL PIPING
EXT	EXISTING SITE SURVEY	A112	EXTERIOR COLUMN DETAILS	A099	ENL. FURN. PLANS - DIS. DESIGN & GAME DEV. CLIMB & LAB	M014	FOURTH FLOOR PLAN - MECHANICAL PIPING
U08A	UTILE UTILITY PLAN - WEST	A113	LEVEL 124 ENLARGED RESTROOM PLANS & ELEVATIONS	A100	ENL. FURN. PLANS - HEAVY EQUIPMENT CLIMB & LAB	M015	FOURTH FLOOR PLAN - MECHANICAL PIPING
U08B	UTILE UTILITY PLAN - WEST	A114	LEVEL 124 ENLARGED RESTROOM PLANS & ELEVATIONS	A101	ENL. FURN. PLANS - AVIATION CLIMB & LAB	M016	MECHANICAL SCHEDULES
U08C	UTILE UTILITY PLAN - WEST	A115	LEVEL 124 ENLARGED RESTROOM PLANS & ELEVATIONS	A102	ENL. FURN. PLANS - MULTI-PURPOSE ROOF - UPPER LEVEL	M017	MECHANICAL SCHEDULES
U08D	UTILE UTILITY PLAN - EAST	A116	LEVEL 124 ENLARGED RESTROOM PLANS & ELEVATIONS	A103	OVERALL RESTROOM PLANS & ELEVATIONS	M018	MECHANICAL SCHEDULES
U08E	UTILE UTILITY PLAN - EAST	A117	LEVEL 124 ENLARGED RESTROOM PLANS & ELEVATIONS	A104	OVERALL RESTROOM PLANS & ELEVATIONS	M019	MECHANICAL SCHEDULES
U08F	UTILE UTILITY PLAN - EAST	A118	LEVEL 124 ENLARGED RESTROOM PLANS & ELEVATIONS	A105	OVERALL RESTROOM PLANS & ELEVATIONS	M020	MECHANICAL SCHEDULES
U08G	UTILE UTILITY PLAN - EAST	A119	LEVEL 124 ENLARGED RESTROOM PLANS & ELEVATIONS	A106	OVERALL RESTROOM PLANS & ELEVATIONS	M021	MECHANICAL SCHEDULES
U08H	UTILE UTILITY PLAN - EAST	A120	LEVEL 124 ENLARGED RESTROOM PLANS & ELEVATIONS	A107	OVERALL RESTROOM PLANS & ELEVATIONS	M022	MECHANICAL SCHEDULES
U08I	UTILE UTILITY PLAN - EAST	A121	LEVEL 124 ENLARGED RESTROOM PLANS & ELEVATIONS	A108	OVERALL RESTROOM PLANS & ELEVATIONS	M023	MECHANICAL SCHEDULES
U08J	UTILE UTILITY PLAN - EAST	A122	LEVEL 124 ENLARGED RESTROOM PLANS & ELEVATIONS	A109	OVERALL RESTROOM PLANS & ELEVATIONS	M024	MECHANICAL SCHEDULES
U08K	UTILE UTILITY PLAN - EAST	A123	LEVEL 124 ENLARGED RESTROOM PLANS & ELEVATIONS	A110	OVERALL RESTROOM PLANS & ELEVATIONS	M025	MECHANICAL SCHEDULES
U08L	UTILE UTILITY PLAN - EAST	A124	LEVEL 124 ENLARGED RESTROOM PLANS & ELEVATIONS	A111	OVERALL RESTROOM PLANS & ELEVATIONS	M026	MECHANICAL SCHEDULES
U08M	UTILE UTILITY PLAN - EAST	A125	LEVEL 124 ENLARGED RESTROOM PLANS & ELEVATIONS	A112	OVERALL RESTROOM PLANS & ELEVATIONS	M027	MECHANICAL SCHEDULES
U08N	UTILE UTILITY PLAN - EAST	A126	LEVEL 124 ENLARGED RESTROOM PLANS & ELEVATIONS	A113	OVERALL RESTROOM PLANS & ELEVATIONS	M028	MECHANICAL SCHEDULES
U08O	UTILE UTILITY PLAN - EAST	A127	LEVEL 124 ENLARGED RESTROOM PLANS & ELEVATIONS	A114	OVERALL RESTROOM PLANS & ELEVATIONS	M029	MECHANICAL SCHEDULES
U08P	UTILE UTILITY PLAN - EAST	A128	LEVEL 124 ENLARGED RESTROOM PLANS & ELEVATIONS	A115	OVERALL RESTROOM PLANS & ELEVATIONS	M030	MECHANICAL SCHEDULES
U08Q	UTILE UTILITY PLAN - EAST	A129	LEVEL 124 ENLARGED RESTROOM PLANS & ELEVATIONS	A116	OVERALL RESTROOM PLANS & ELEVATIONS	M031	MECHANICAL SCHEDULES
U08R	UTILE UTILITY PLAN - EAST	A130	LEVEL 124 ENLARGED RESTROOM PLANS & ELEVATIONS	A117	OVERALL RESTROOM PLANS & ELEVATIONS	M032	MECHANICAL SCHEDULES
U08S	UTILE UTILITY PLAN - EAST	A131	LEVEL 124 ENLARGED RESTROOM PLANS & ELEVATIONS	A118	OVERALL RESTROOM PLANS & ELEVATIONS	M033	MECHANICAL SCHEDULES
U08T	UTILE UTILITY PLAN - EAST	A132	LEVEL 124 ENLARGED RESTROOM PLANS & ELEVATIONS	A119	OVERALL RESTROOM PLANS & ELEVATIONS	M034	MECHANICAL SCHEDULES
U08U	UTILE UTILITY PLAN - EAST	A133	LEVEL 124 ENLARGED RESTROOM PLANS & ELEVATIONS	A120	OVERALL RESTROOM PLANS & ELEVATIONS	M035	MECHANICAL SCHEDULES
U08V	UTILE UTILITY PLAN - EAST	A134	LEVEL 124 ENLARGED RESTROOM PLANS & ELEVATIONS	A121	OVERALL RESTROOM PLANS & ELEVATIONS	M036	MECHANICAL SCHEDULES
U08W	UTILE UTILITY PLAN - EAST	A135	LEVEL 124 ENLARGED RESTROOM PLANS & ELEVATIONS	A122	OVERALL RESTROOM PLANS & ELEVATIONS	M037	MECHANICAL SCHEDULES
U08X	UTILE UTILITY PLAN - EAST	A136	LEVEL 124 ENLARGED RESTROOM PLANS & ELEVATIONS	A123	OVERALL RESTROOM PLANS & ELEVATIONS	M038	MECHANICAL SCHEDULES
U08Y	UTILE UTILITY PLAN - EAST	A137	LEVEL 124 ENLARGED RESTROOM PLANS & ELEVATIONS	A124	OVERALL RESTROOM PLANS & ELEVATIONS	M039	MECHANICAL SCHEDULES
U08Z	UTILE UTILITY PLAN - EAST	A138	LEVEL 124 ENLARGED RESTROOM PLANS & ELEVATIONS	A125	OVERALL RESTROOM PLANS & ELEVATIONS	M040	MECHANICAL SCHEDULES
U09A	UTILE UTILITY PLAN - WEST	A139	LEVEL 124 ENLARGED RESTROOM PLANS & ELEVATIONS	A126	OVERALL RESTROOM PLANS & ELEVATIONS	M041	MECHANICAL SCHEDULES
U09B	UTILE UTILITY PLAN - WEST	A140	LEVEL 124 ENLARGED RESTROOM PLANS & ELEVATIONS	A127	OVERALL RESTROOM PLANS & ELEVATIONS	M042	MECHANICAL SCHEDULES
U09C	UTILE UTILITY PLAN - WEST	A141	LEVEL 124 ENLARGED RESTROOM PLANS & ELEVATIONS	A128	OVERALL RESTROOM PLANS & ELEVATIONS	M043	MECHANICAL SCHEDULES
U09D	UTILE UTILITY PLAN - WEST	A142	LEVEL 124 ENLARGED RESTROOM PLANS & ELEVATIONS	A129	OVERALL RESTROOM PLANS & ELEVATIONS	M044	MECHANICAL SCHEDULES
U09E	UTILE UTILITY PLAN - WEST	A143	LEVEL 124 ENLARGED RESTROOM PLANS & ELEVATIONS	A130	OVERALL RESTROOM PLANS & ELEVATIONS	M045	MECHANICAL SCHEDULES
U09F	UTILE UTILITY PLAN - WEST	A144	LEVEL 124 ENLARGED RESTROOM PLANS & ELEVATIONS	A131	OVERALL RESTROOM PLANS & ELEVATIONS	M046	MECHANICAL SCHEDULES
U09G	UTILE UTILITY PLAN - WEST	A145	LEVEL 124 ENLARGED RESTROOM PLANS & ELEVATIONS	A132	OVERALL RESTROOM PLANS & ELEVATIONS	M047	MECHANICAL SCHEDULES
U09H	UTILE UTILITY PLAN - WEST	A146	LEVEL 124 ENLARGED RESTROOM PLANS & ELEVATIONS	A133	OVERALL RESTROOM PLANS & ELEVATIONS	M048	MECHANICAL SCHEDULES
U09I	UTILE UTILITY PLAN - WEST	A147	LEVEL 124 ENLARGED RESTROOM PLANS & ELEVATIONS	A134	OVERALL RESTROOM PLANS & ELEVATIONS	M049	MECHANICAL SCHEDULES
U09J	UTILE UTILITY PLAN - WEST	A148	LEVEL 124 ENLARGED RESTROOM PLANS & ELEVATIONS	A135	OVERALL RESTROOM PLANS & ELEVATIONS	M050	MECHANICAL SCHEDULES
U09K	UTILE UTILITY PLAN - WEST	A149	LEVEL 124 ENLARGED RESTROOM PLANS & ELEVATIONS	A136	OVERALL RESTROOM PLANS & ELEVATIONS	M051	MECHANICAL SCHEDULES
U09L	UTILE UTILITY PLAN - WEST	A150	LEVEL 124 ENLARGED RESTROOM PLANS & ELEVATIONS	A137	OVERALL RESTROOM PLANS & ELEVATIONS	M052	MECHANICAL SCHEDULES
U09M	UTILE UTILITY PLAN - WEST	A151	LEVEL 124 ENLARGED RESTROOM PLANS & ELEVATIONS	A138	OVERALL RESTROOM PLANS & ELEVATIONS	M053	MECHANICAL SCHEDULES
U09N	UTILE UTILITY PLAN - WEST	A152	LEVEL 124 ENLARGED RESTROOM PLANS & ELEVATIONS	A139	OVERALL RESTROOM PLANS & ELEVATIONS	M054	MECHANICAL SCHEDULES
U09O	UTILE UTILITY PLAN - WEST	A153	LEVEL 124 ENLARGED RESTROOM PLANS & ELEVATIONS	A140	OVERALL RESTROOM PLANS & ELEVATIONS	M055	MECHANICAL SCHEDULES
U09P	UTILE UTILITY PLAN - WEST	A154	LEVEL 124 ENLARGED RESTROOM PLANS & ELEVATIONS	A141	OVERALL RESTROOM PLANS & ELEVATIONS	M056	MECHANICAL SCHEDULES
U09Q	UTILE UTILITY PLAN - WEST	A155	LEVEL 124 ENLARGED RESTROOM PLANS & ELEVATIONS	A142	OVERALL RESTROOM PLANS & ELEVATIONS	M057	MECHANICAL SCHEDULES
U09R	UTILE UTILITY PLAN - WEST	A156	LEVEL 124 ENLARGED RESTROOM PLANS & ELEVATIONS	A143	OVERALL RESTROOM PLANS & ELEVATIONS	M058	MECHANICAL SCHEDULES
U09S	UTILE UTILITY PLAN - WEST	A157	LEVEL 124 ENLARGED RESTROOM PLANS & ELEVATIONS	A144	OVERALL RESTROOM PLANS & ELEVATIONS	M059	MECHANICAL SCHEDULES
U09T	UTILE UTILITY PLAN - WEST	A158	LEVEL 124 ENLARGED RESTROOM PLANS & ELEVATIONS	A145	OVERALL RESTROOM PLANS & ELEVATIONS	M060	MECHANICAL SCHEDULES
U09U	UTILE UTILITY PLAN - WEST	A159	LEVEL 124 ENLARGED RESTROOM PLANS & ELEVATIONS	A146	OVERALL RESTROOM PLANS & ELEVATIONS	M061	MECHANICAL SCHEDULES
U09V	UTILE UTILITY PLAN - WEST	A160	LEVEL 124 ENLARGED RESTROOM PLANS & ELEVATIONS	A147	OVERALL RESTROOM PLANS & ELEVATIONS	M062	MECHANICAL SCHEDULES
U09W	UTILE UTILITY PLAN - WEST	A161	LEVEL 124 ENLARGED RESTROOM PLANS & ELEVATIONS	A148	OVERALL RESTROOM PLANS & ELEVATIONS	M063	MECHANICAL SCHEDULES
U09X	UTILE UTILITY PLAN - WEST	A162	LEVEL 124 ENLARGED RESTROOM PLANS & ELEVATIONS	A149	OVERALL RESTROOM PLANS & ELEVATIONS	M064	MECHANICAL SCHEDULES
U09Y	UTILE UTILITY PLAN - WEST	A163	LEVEL 124 ENLARGED RESTROOM PLANS & ELEVATIONS	A150	OVERALL RESTROOM PLANS & ELEVATIONS	M065	MECHANICAL SCHEDULES
U09Z	UTILE UTILITY PLAN - WEST	A164	LEVEL 124 ENLARGED RESTROOM PLANS & ELEVATIONS	A151	OVERALL RESTROOM PLANS & ELEVATIONS	M066	MECHANICAL SCHEDULES
U10A	UTILE UTILITY PLAN - WEST	A165	LEVEL 124 ENLARGED RESTROOM PLANS & ELEVATIONS	A152	OVERALL RESTROOM PLANS & ELEVATIONS	M067	MECHANICAL SCHEDULES
U10B	UTILE UTILITY PLAN - WEST	A166	LEVEL 124 ENLARGED RESTROOM PLANS & ELEVATIONS	A153	OVERALL RESTROOM PLANS & ELEVATIONS	M068	MECHANICAL SCHEDULES
U10C	UTILE UTILITY PLAN - WEST	A167	LEVEL 124 ENLARGED RESTROOM PLANS & ELEVATIONS	A154	OVERALL RESTROOM PLANS & ELEVATIONS	M069	MECHANICAL SCHEDULES
U10D	UTILE UTILITY PLAN - WEST	A168	LEVEL 124 ENLARGED RESTROOM PLANS & ELEVATIONS	A155	OVERALL RESTROOM PLANS & ELEVATIONS	M070	MECHANICAL SCHEDULES
U10E	UTILE UTILITY PLAN - WEST	A169	LEVEL 124 ENLARGED RESTROOM PLANS & ELEVATIONS	A156	OVERALL RESTROOM PLANS & ELEVATIONS	M071	MECHANICAL SCHEDULES
U10F	UTILE UTILITY PLAN - WEST	A170	LEVEL 124 ENLARGED RESTROOM PLANS & ELEVATIONS	A157	OVERALL RESTROOM PLANS & ELEVATIONS	M072	MECHANICAL SCHEDULES
U10G	UTILE UTILITY PLAN - WEST	A171	LEVEL 124 ENLARGED RESTROOM PLANS & ELEVATIONS	A158	OVERALL RESTROOM PLANS & ELEVATIONS	M073	MECHANICAL SCHEDULES
U10H	UTILE UTILITY PLAN - WEST	A172	LEVEL 124 ENLARGED RESTROOM PLANS & ELEVATIONS	A159	OVERALL RESTROOM PLANS & ELEVATIONS	M074	MECHANICAL SCHEDULES
U10I	UTILE UTILITY PLAN - WEST	A173	LEVEL 124 ENLARGED RESTROOM PLANS & ELEVATIONS	A160	OVERALL RESTROOM PLANS & ELEVATIONS	M075	MECHANICAL SCHEDULES
U10J	UTILE UTILITY PLAN - WEST	A174	LEVEL 124 ENLARGED RESTROOM PLANS & ELEVATIONS	A161	OVERALL RESTROOM PLANS & ELEVATIONS	M076	MECHANICAL SCHEDULES
U10K	UTILE UTILITY PLAN - WEST	A175	LEVEL 124 ENLARGED RESTROOM PLANS & ELEVATIONS	A162	OVERALL RESTROOM PLANS & ELEVATIONS	M077	MECHANICAL SCHEDULES
U10L	UTILE UTILITY PLAN - WEST	A176	LEVEL 124 ENLARGED RESTROOM PLANS & ELEVATIONS	A163	OVERALL RESTROOM PLANS & ELEVATIONS	M078	MECHANICAL SCHEDULES
U10M	UTILE UTILITY PLAN - WEST	A177	LEVEL 124 ENLARGED RESTROOM PLANS & ELEVATIONS	A164	OVERALL RESTROOM PLANS & ELEVATIONS	M079	MECHANICAL SCHEDULES
U10N	UTILE UTILITY PLAN - WEST	A178	LEVEL 124 ENLARGED RESTROOM PLANS & ELEVATIONS	A165	OVERALL RESTROOM PLANS & ELEVATIONS	M080	MECHANICAL SCHEDULES
U10O	UTILE UTILITY PLAN - WEST	A179	LEVEL 124 ENLARGED RESTROOM PLANS & ELEVATIONS	A166	OVERALL RESTROOM PLANS & ELEVATIONS	M081	MECHANICAL SCHEDULES
U10P	UTILE UTILITY PLAN - WEST	A180	LEVEL 124 ENLARGED RESTROOM PLANS & ELEVATIONS	A167	OVERALL RESTROOM PLANS & ELEVATIONS	M082	MECHANICAL SCHEDULES
U10Q	UTILE UTILITY PLAN - WEST	A181	LEVEL 124 ENLARGED RESTROOM PLANS & ELEVATIONS	A168	OVERALL RESTROOM PLANS & ELEVATIONS	M083	MECHANICAL SCHEDULES
U10R	UTILE UTILITY PLAN - WEST	A182	LEVEL 124 ENLARGED RESTROOM PLANS & ELEVATIONS	A169	OVERALL RESTROOM PLANS & ELEVATIONS	M084	MECHANICAL SCHEDULES
U10S	UTILE UTILITY PLAN - WEST	A183	LEVEL 124 ENLARGED RESTROOM PLANS & ELEVATIONS	A170	OVERALL RESTROOM PLANS & ELEVATIONS	M085	MECHANICAL SCHEDULES
U10T	UTILE UTILITY PLAN - WEST	A184	LEVEL 124 ENLARGED RESTROOM PLANS & ELEVATIONS	A171	OVERALL RESTROOM PLANS & ELEVATIONS	M086	MECHANICAL SCHEDULES
U10U	UTILE UTILITY PLAN - WEST	A185	LEVEL 124 ENLARGED RESTROOM PLANS & ELEVATIONS	A172	OVERALL RESTROOM PLANS & ELEVATIONS	M087	MECHANICAL SCHEDULES
U10V	UTILE UTILITY PLAN - WEST	A186	LEVEL 124 ENLARGED RESTROOM PLANS & ELEVATIONS	A173	OVERALL RESTROOM PLANS & ELEVATIONS	M088	MECHANICAL SCHEDULES
U10W	UTILE UTILITY PLAN - WEST	A187	LEVEL 124 ENLARGED RESTROOM PLANS & ELEVATIONS	A174	OVERALL RESTROOM PLANS & ELEVATIONS	M089	MECHANICAL SCHEDULES
U10X	UTILE UTILITY PLAN - WEST	A188	LEVEL 124 ENLARGED RESTROOM PLANS & ELEVATIONS	A175	OVERALL RESTROOM PLANS & ELEVATIONS	M090	MECHANICAL SCHEDULES
U10Y	UTILE UTILITY PLAN - WEST	A189	LEVEL 124 ENLARGED RESTROOM PLANS & ELEVATIONS	A176	OVERALL RESTROOM PLANS & ELEVATIONS	M091	MECHANICAL SCHEDULES
U10Z	UTILE UTILITY PLAN - WEST	A190	LEVEL 124 ENLARGED RESTROOM PLANS & ELEVATIONS	A177	OVERALL RESTROOM PLANS & ELEVATIONS	M092	MECHANICAL SCHEDULES
U11A	UTILE UTILITY PLAN - WEST	A191	LEVEL 124 ENLARGED RESTROOM PLANS & ELEVATIONS	A178	OVERALL RESTROOM PLANS & ELEVATIONS	M093	MECHANICAL SCHEDULES
U11B	UTILE UTILITY PLAN - WEST	A192	LEVEL 124 ENLARGED RESTROOM PLANS & ELEVATIONS	A179	OVERALL RESTROOM PLANS & ELEVATIONS	M094	MECHANICAL SCHEDULES
U11C	UTILE UTILITY PLAN - WEST	A193	LEVEL 124 ENLARGED RESTROOM PLANS & ELEVATIONS	A180	OVERALL RESTROOM PLANS & ELEVATIONS	M095	MECHANICAL SCHEDULES
U11D	UTILE UTILITY PLAN - WEST	A194	LEVEL 124 ENLARGED RESTROOM PLANS & ELEVATIONS	A181	OVERALL RESTROOM PLANS & ELEVATIONS	M096	MECHANICAL SCHEDULES
U11E	UTILE UTILITY PLAN - WEST	A195	LEVEL 124 ENLARGED RESTROOM PLANS & ELEVATIONS	A182	OVERALL RESTROOM PLANS & ELEVATIONS	M097	MECHANICAL SCHEDULES
U11F	UTILE UTILITY PLAN - WEST	A196	LEVEL 124 ENLARGED RESTROOM PLANS & ELEVATIONS	A183	OVERALL RESTROOM PLANS & ELEVATIONS	M098	MECHANICAL SCHEDULES
U11G	UTILE UTILITY PLAN - WEST	A197	LEVEL 124 ENLARGED RESTROOM PLANS & ELEVATIONS	A184	OVERALL RESTROOM PLANS & ELEVATIONS	M099	MECHANICAL SCHEDULES
U11H	UTILE UTILITY PLAN - WEST	A198	LEVEL 124 ENLARGED RESTROOM PLANS & ELEVATIONS	A185	OVERALL RESTROOM PLANS & ELEVATIONS	M100	MECHANICAL SCHEDULES
U11I	UTILE UTILITY PLAN - WEST	A199	LEVEL 124 ENLARGED RESTROOM PLANS & ELEVATIONS	A186	OVERALL RESTROOM PLANS & ELEVATIONS	M101	MECHANICAL SCHEDULES
U11J	UTILE UTILITY PLAN - WEST	A200	LEVEL 124 ENLARGED RESTROOM PLANS & ELEVATIONS	A187	OVERALL RESTROOM PLANS & ELEVATIONS	M102	MECHANICAL SCHEDULES
U11K	UTILE UTILITY PLAN - WEST	A201	LEVEL 124 ENLARGED RESTROOM PLANS & ELEVATIONS	A188	OVERALL RESTROOM PLANS & ELEVATIONS	M103	MECHANICAL SCHEDULES
U11L	UTILE UTILITY PLAN - WEST	A202	LEVEL 124 ENLARGED RESTROOM PLANS & ELEVATIONS	A189	OVERALL RESTROOM PLANS & ELEVATIONS	M104	MECHANICAL SCHEDULES
U11M	UTILE UTILITY PLAN - WEST	A203	LEVEL 124 ENLARGED RESTROOM PLANS & ELEVATIONS	A190	OVERALL RESTROOM PLANS & ELEVATIONS	M105	MECHANICAL SCHEDULES
U11N	UTILE UTILITY PLAN - WEST	A204	LEVEL 124 ENLARGED RESTROOM PLANS & ELEVATIONS	A191	OVERALL RESTROOM PLANS & ELEVATIONS	M106	MECHANICAL SCHEDULES
U11O	UTILE UTILITY PLAN - WEST	A205	LEVEL 124 ENL				



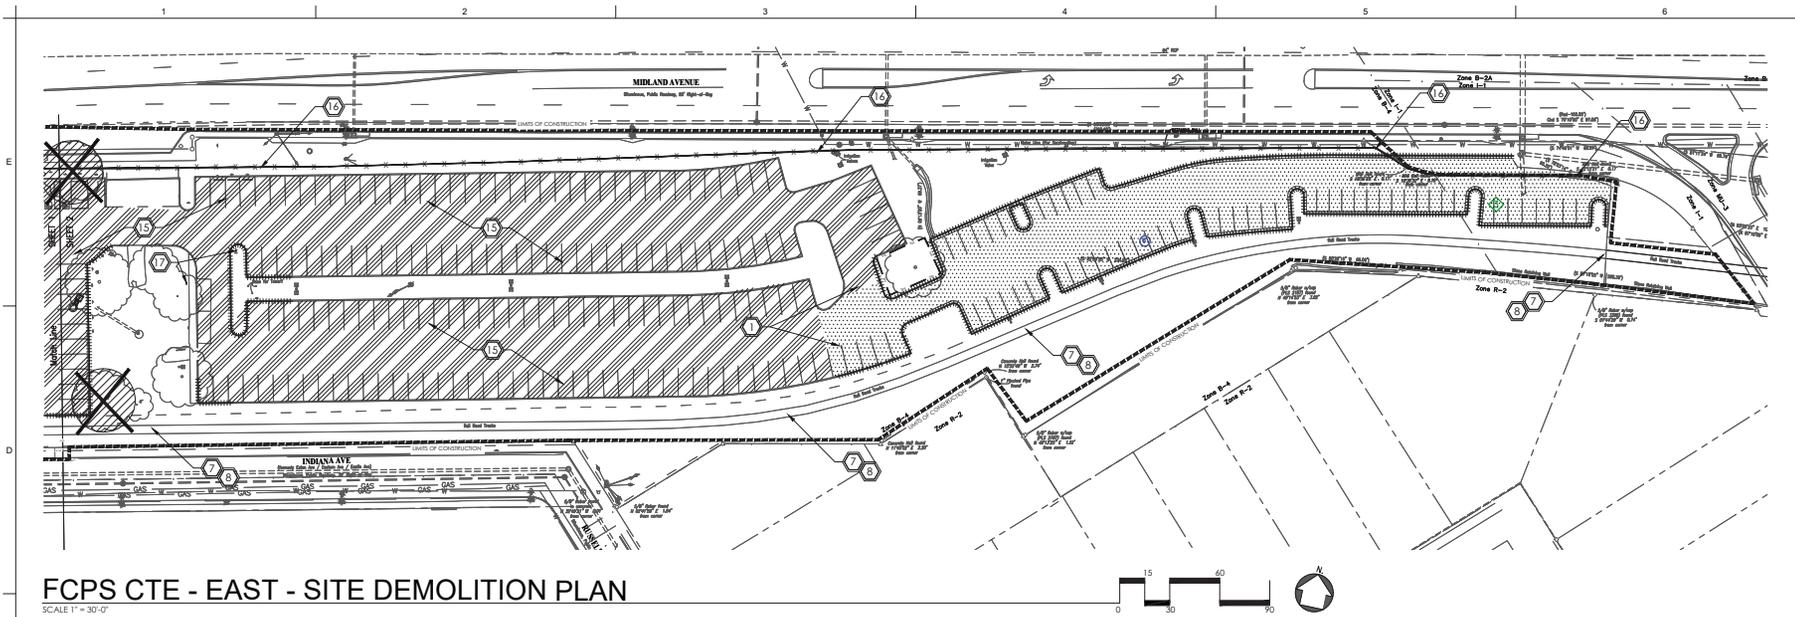

# FCPS CTE - EAST - SITE DEMOLITION PLAN

SCALE 1" = 30'-0"

## SITE DEMOLITION NOTES:

- A. THE EXISTING TOPOGRAPHIC AND SITE INFORMATION SHOWN HAS BEEN PROVIDED BY ENDRS ENGINEERING. THE INFORMATION IS PROVIDED FOR THE CONVENIENCE OF THE CONTRACTOR. THE ARCHITECT SHALL NOT BE RESPONSIBLE FOR THE ACCURACY OF THE INFORMATION SHOWN THEREON. CONTRACTOR TO VERIFY ALL INFORMATION SHOWN. THE CONTRACTOR SHALL BE RESPONSIBLE FOR REPAIRING ANY DAMAGE TO UTILITIES SHOWN ON THE SURVEY.
- B. THE DRAWINGS SHOW THE APPROXIMATE LOCATION OF EXISTING AND PROPOSED UTILITY LINES. THESE LINES HAVE BEEN IDENTIFIED AND LOCATED AS ACCURATELY AS POSSIBLE USING AVAILABLE INFORMATION; THE CONTRACTOR IS RESPONSIBLE FOR VERIFYING ALL ACTUAL LOCATIONS.
- C. SAWCUT EDGES OF EXISTING PAVEMENT WHERE NEW PAVEMENT ABUTS AND / OR EXISTING PAVEMENT IS INDICATED TO BE REMOVED.
- D. REFER TO SPECIFICATIONS FOR ADDITIONAL REQUIREMENTS.
- E. REFER TO ADDITIONAL SHEETS FOR INFORMATION AND REQUIREMENTS.
- F. THE CONTRACTOR SHALL INSTALL AND MAINTAIN TREE PROTECTION FENCING WHERE INDICATED AND FOR ALL EXISTING TREES WITHIN THE LIMITS OF THE CONSTRUCTION FENCING. TREE PROTECTION FENCING SHALL BE CONSTRUCTED OF SAFETY FENCE WITH STEEL T SECTION FENCE POSTS SPACED AT A MAXIMUM LIMIT OF FENCE TO ALIGN WITH CANOPY / DRIP EDGE OF TREES TO AVOID DAMAGE TO EXISTING TREES DURING CONSTRUCTION.
- G. UNLESS OTHERWISE INDICATED TO BE REMOVED, ALL ITEMS ARE TO REMAIN AND BE PROTECTED FROM DAMAGE DURING CONSTRUCTION. CONTRACTOR SHALL REPAIR ANY DAMAGES TO OFF OR ON SITE PROPERTY THAT IS NOT LISTED TO BE REMOVED AT NOT ADDITIONAL COST TO THE OWNER.
- H. THE CONTRACTOR SHALL MAINTAIN STORM DRAINAGE SYSTEMS TO FUNCTION THROUGHOUT THE CONSTRUCTION PERIOD.
- I. SEE EDC DRAWING FOR STORM WATER POLLUTION PREVENTION.
- J. THE CONTRACTOR SHALL PROVIDE ACCESS AND A SAFE ROUTE TO THE SOCCER FIELDS AND CEMETARY PROPERTY THROUGHOUT THE DURATION OF THE PROJECT.
- K. CONTRACTOR SHALL HIT ALL STORM LINES WITHIN THE SITE TO REMOVE ALL SEWERAGE. LINES SHALL BE CAMERA INSPECTED AND A REPORT GENERATED. REPORT AND VIDEO INSPECTION SHALL BE PROVIDED TO OWNER AND ENGINEER. REPORT SHALL INCLUDE CONDITION ANALYSIS OF PIPES, DOCUMENTATION OF ALL CONNECTIONS, DEPTH OF LINES AND LOCATION WITH SCALE. SEE EDC FOR ALL SPECIAL REQUIREMENTS FOR THE COMPLETION OF REPORT SHALL BE INCORPORATED. THIS WORK SHALL BE COMPLETED PRIOR TO THE ORDERING OF MATERIALS OR INSTALLATION OF LINES AND STRUCTURES.

## DEMOLITION KEYNOTES

1. SAWCUT EXISTING PAVEMENT WHERE NEW PAVEMENT WILL ABUT.
2. REMOVE EXISTING FLAG POLE, FOOTING, AND ACCENT LIGHTS.
3. REMOVE EXISTING SIGN.
4. EXISTING RETAINING WALL TO BE SAWCUT AND REMOVED. COORDINATE WITH ARCHITECTURAL DEMOLITION DRAWINGS.
5. EXISTING HEDGE TO BE REMOVED IN ITS ENTIRETY.
6. EXISTING IRRIGATION SYSTEM TO BE REMOVED WITHIN RAISED PLANTER.
7. FORMER LOCATION OF RAILROAD TRACKS (HAVE BEEN REMOVED BY OTHERS).
8. FORMER RAILROAD TIES (HAVE BEEN REMOVED BY OTHERS).
9. EXISTING STORM STRUCTURE TO BE REMOVED AND LEGALLY DISPOSED OF OFFSITE.
10. EXISTING STORM LINE / TRENCH DRAIN TO BE REMOVED AND LEGALLY DISPOSED OF OFFSITE.
11. EXISTING STORM LINE / PORTION OF SLOT DRAIN TO BE REMOVED AND LEGALLY DISPOSED OF OFFSITE. SEE L300A AND L308 FOR LOCATION OF NEW STORM STRUCTURE TO CONNECT TO EXISTING SLOT DRAIN.
12. EXISTING STORM STRUCTURE TO BE REMOVED. CAP CONNECTION TO EXISTING LINE. LINE TO REMAIN FUNCTIONAL THROUGHOUT CONSTRUCTION.
13. EXISTING RETAINING WALL/LOADING DOCK WALL TO BE REMOVED AND LEGALLY DISPOSED OF OFFSITE.
14. EXISTING JUNIOR ACHIEVEMENT PARK - STONE VENER WALL MONUMENT AND PAVERS TO BE REMOVED BY OTHERS PRIOR TO COMMENCEMENT OF WORK.
15. **BASE BID** - REMOVE ASPHALT FOR INSTALLATION OF GEOTHERMAL WELLS AND REPLACE WITH FULL PAVEMENT SECTION AS INDICATED ON L401B. **REDUCTIVE ALTERNATE** - EXISTING ASPHALT PAVEMENT TO BE MILLED AND RESURFACED WITH 1.5" OVERLAY.
16. EXISTING CHAINLINK FENCE TO BE REMOVED IN ITS ENTIRETY AND LEGALLY DISPOSED OF OFFSITE.
17. EXISTING SIGN TO BE REMOVED AND LEGALLY DISPOSED OF OFFSITE.

## DEMOLITION LEGEND

- EXISTING ASPHALT PAVEMENT TO BE REMOVED - FULL PAVEMENT SECTION AND SHALL BE REPLACED WITH PERMEABLE PAVERS AS INDICATED ON SITE MATERIALS PLAN (A0)
- EXISTING ASPHALT PAVEMENT TO BE REMOVED - FULL PAVEMENT SECTION AND SHALL BE REPLACED AS INDICATED ON SITE MATERIALS PLAN (A0)
- EXISTING ASPHALT PAVEMENT TO BE MILLED AND RESURFACED SEE SITE MATERIALS PLAN (A0)
- EXISTING EVERGREEN HEDGE TO BE REMOVED IN ITS ENTIRETY
- REMOVE CONCRETE PAVEMENT TO SUBGRADE
- EXISTING JUNIOR ACHIEVEMENT PARK WALL, MONUMENT AND PAVERS TO BE REMOVED PRIOR TO COMMENCEMENT OF WORK BY OTHERS.
- EXISTING TREES (S) AND SHRUBS TO BE REMOVED. REMOVE TREE STUMP AND ROOTS. CLEAR ALL VEGETATION ALL THE WAY TO THE ROW OF WAY FENCE WITHIN THE PROPERTY THAT IS WITHIN THE LIMITS OF CONSTRUCTION.
- REMOVE CURBING; SAWCUT WHERE NEW CURBS WILL ABUT EXISTING CURB
- SAW CUT PAVEMENT; CREATE A CLEAN, STRAIGHT EDGE
- EXISTING TREES (T) TO REMAIN (TREE PROTECTION FENCING/TPF) - NO DEMOLITION ACTIVITY SHALL TAKE PLACE WITHIN DRIP LINE OF TREE(S) INCLUDING MOVING EQUIPMENT, STAKING / STORING OF MATERIALS AND PARKING OF VEHICLES AND EQUIPMENT; SEE DETAIL X
- EXISTING CHAINLINK FENCE TO BE REMOVED AND LEGALLY DISPOSED OF OFFSITE

**NEW FCPS  
COMBINED CTE  
SCHOOL  
BC# 22-167**  
100 Midland Ave.  
Lexington, KY 40508  
PERMIT SET

REVISIONS	
#	DATE DESCRIPTION




**PROJECT TEAM**  
EOP Architects  
201 W. Short Street, Suite 700  
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Job Number 2150 PLAN  
Drawn By BLMEPM  
Checked By BJM  
Date 07/20/2022

## SITE DEMOLITION PLAN - EAST

**L200-B**

**NEW FCPS  
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SCHOOL  
BG# 22-167**  
100 Midland Ave.  
Lexington, KY 40508  
PERMIT SET

REVISIONS	
#	DESCRIPTION

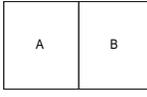


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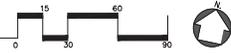
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MEP Engineers  
628 Winchester Rd.  
Lexington, KY 40505

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366 S. Broadway  
Lexington, KY 40508



**FCPS CTE - WEST - SITE LAYOUT PLAN**

SCALE 1" = 30'-0"

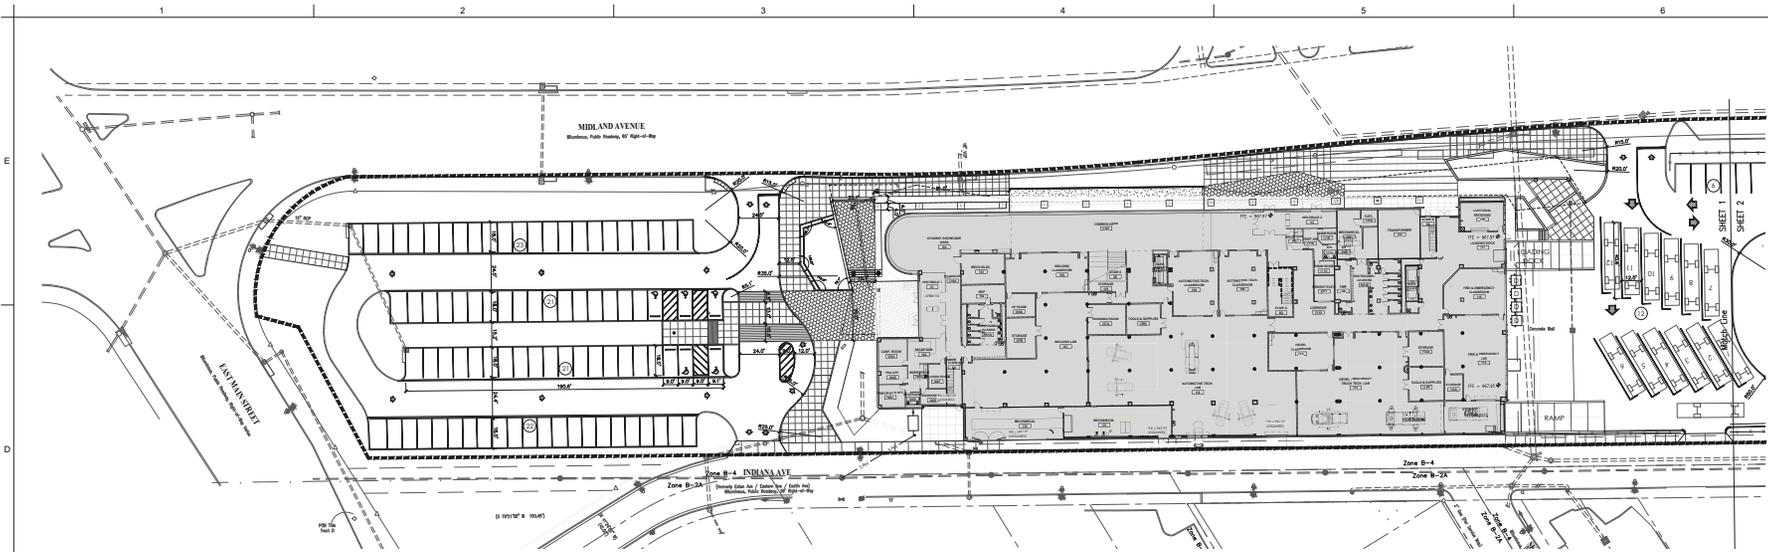

**LAYOUT GENERAL NOTES:**


- A. THE EXISTING TOPOGRAPHIC AND SITE INFORMATION SHOWN HAS BEEN PROVIDED FROM A SURVEY BY ENGINEERING. THIS INFORMATION IS PROVIDED FOR THE CONVENIENCE OF THE CONTRACTOR. THE ARCHITECT SHALL NOT BE RESPONSIBLE FOR THE ACCURACY OF THE INFORMATION SHOWN HEREIN. CONTRACTOR TO VERIFY ALL INFORMATION SHOWN.
- B. DIMENSIONS GIVEN IN RELATIONSHIP TO BUILDINGS OR OTHER SITE ELEMENTS ARE MEASURED PERPENDICULAR FROM THE OUTSIDE FACE OF BRICK, STONE OR CONCRETE UNLESS OTHERWISE INDICATED.
- C. DIMENSIONS ARE REFERENCED AT 90 DEGREE ANGLES UNLESS OTHERWISE INDICATED.
- D. COORDINATE PLACEMENT OF EXPANSION AND CONTROL JOINTS IN CURBS WITH ADJACENT WALKS WHERE APPLICABLE.
- E. UNLESS OTHERWISE INDICATED, ALL CURB RADIUS ARE 5' MEASURED AT THE OUTSIDE FACE OF CURB AND ALL RADIUS AT THE INTERSECTION OF WALKS ARE 2' UNLESS INDICATED OTHERWISE ON THE PLAN.
- F. ALIGN CONTROL AND EXPANSION JOINTS WITH CORNERS AND EDGES OF BUILDINGS AND WALLS.
- G. UNLESS OTHERWISE INDICATED, ALL WALKS CONNECTING TO THE PROPOSED BUILDING SHALL ALIGN WITH THE CENTER OF DOORWAY OR OPENING AND FLUSH WITH FINISH GRADES AT BUILDINGS.
- H. FOR SITE LIGHTING DETAILS AND REQUIREMENTS, SEE M&E DRAWINGS.
- I. THE CONTRACTOR IS RESPONSIBLE FOR COORDINATING ALL INVOLVED UTILITY COMPANIES, COORDINATING ALL CONSTRUCTION ACTIVITIES, AND VERIFYING ALL SITE UTILITIES PRIOR TO CONSTRUCTION ACTIVITY.
- J. EXPANSION JOINTS SHALL BE PLACED BETWEEN ALL EXISTING CONCRETE PAVEMENTS, BUILDINGS AND WALLS AS WELL AS ALL PROPOSED CONCRETE PAVEMENTS AND WALLS.
- K. REFER TO SPECIFICATIONS FOR ADDITIONAL REQUIREMENTS.

**LAYOUT LEGEND**

- CL  
E:204069.4193  
N:1568966.7441  
COORDINATE POINT, WHICH CONTRACTOR SHALL BECOME RESPONSIBLE FOR LOCATING PERMANENTLY.
- PI CENTERLINE
- PC CENTERLINE POINT OF INTERSECTION
- CC CENTERLINE POINT OF CURVATURE/ANGULARITY
- CC CENTERLINE OF COLUMN

**BURIED UTILITIES NOTE**  
BURIED UTILITIES ARE SHOWN AT THEIR APPROXIMATE LOCATIONS BASED UPON AVAILABLE RECORDS FROM UTILITY COMPANIES AND FIELD SURVEY. OTHER BURIED UTILITIES MAY EXIST ON THE PROJECT SITE WHICH WOULD NOT BE SHOWN HEREIN. THE CONTRACTOR SHALL VERIFY THE EXACT LOCATION OF BURIED UTILITIES PRIOR TO EXCAVATION OPERATIONS.

**KEYPLAN**

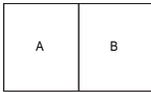

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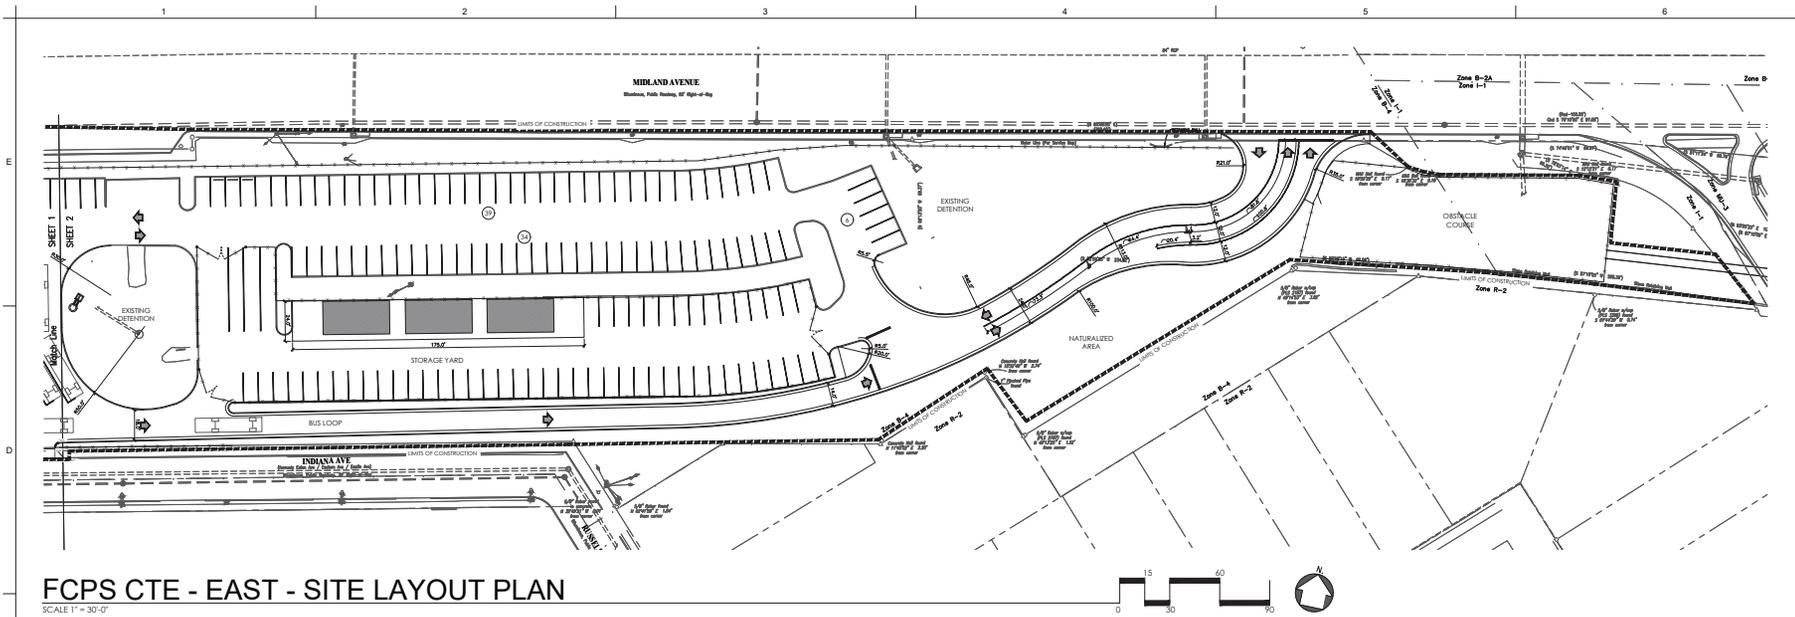
Job Number 2150  
Drawn By BLMEPM  
Checked By BJM  
Date 07/20/2022



**SITE LAYOUT PLAN  
WEST**

**L400-A**

202208 11:37:47 AM



# FCPS CTE - EAST - SITE LAYOUT PLAN

SCALE 1" = 30'-0"

### LAYOUT GENERAL NOTES:

- A. THE EXISTING TOPOGRAPHIC AND SITE INFORMATION SHOWN HAS BEEN PROVIDED FROM A SURVEY BY ENGINEERING. THIS INFORMATION IS PROVIDED FOR THE CONVENIENCE OF THE CONTRACTOR. THE ARCHITECT SHALL NOT BE RESPONSIBLE FOR THE ACCURACY OF THE INFORMATION SHOWN HEREIN. CONTRACTOR TO VERIFY ALL INFORMATION SHOWN.
- B. DIMENSIONS GIVEN IN RELATIONSHIP TO BUILDINGS OR OTHER SITE ELEMENTS ARE MEASURED PERPENDICULAR FROM THE OUTSIDE FACE OF BRICK, STONE OR CONCRETE UNLESS OTHERWISE INDICATED.
- C. DIMENSIONS ARE REFERENCED AT 90 DEGREE ANGLES UNLESS OTHERWISE INDICATED.
- D. COORDINATE PLACEMENT OF EXPANSION AND CONTROL JOINTS IN CURBS WITH ADJACENT WALKS WHERE APPLICABLE.
- E. UNLESS OTHERWISE INDICATED, ALL CURB RADIUS ARE 5' MEASURED AT THE OUTSIDE FACE OF CURB AND ALL RADIUS AT THE INTERSECTION OF WALKS ARE 2' UNLESS INDICATED OTHERWISE ON THE PLAN.
- F. ALIGN CONTROL AND EXPANSION JOINTS WITH CORNERS AND EDGES OF BUILDINGS AND WALLS.
- G. UNLESS OTHERWISE INDICATED, ALL WALKS CONNECTING TO THE PROPOSED BUILDING SHALL ALIGN WITH THE CENTER OF DOORWAY OR OPENING AND FLUSH WITH FINISH GRADES AT BUILDINGS.
- H. FOR SITE LIGHTING DETAILS AND REQUIREMENTS, SEE M&E DRAWINGS.
- I. THE CONTRACTOR IS RESPONSIBLE FOR COORDINATING ALL INVOLVED UTILITY COMPANIES, COORDINATING ALL CONSTRUCTION ACTIVITIES, AND VERIFYING ALL SITE UTILITIES PRIOR TO CONSTRUCTION ACTIVITY.
- J. EXPANSION JOINTS SHALL BE PLACED BETWEEN ALL EXISTING CONCRETE PAVEMENTS, BUILDINGS AND WALLS AS WELL AS ALL PROPOSED CONCRETE PAVEMENTS AND WALLS.
- K. REFER TO SPECIFICATIONS FOR ADDITIONAL REQUIREMENTS.

### LAYOUT LEGEND

- |                                                                                                                                               |                                                                                                                                                                                                            |
|-----------------------------------------------------------------------------------------------------------------------------------------------|------------------------------------------------------------------------------------------------------------------------------------------------------------------------------------------------------------|
| CL<br>E:204069.4193<br>N:1568966.7441<br><small>COORDINATE POINT, WHICH CONTRACTOR SHALL BECOME RESPONSIBLE FOR ADOPTING PERMANENTLY.</small> | <ul style="list-style-type: none"> <li>○ PI CENTERLINE</li> <li>○ PC CENTERLINE POINT OF INTERSECTION</li> <li>○ CC CENTERLINE POINT OF CURVAURE/ANGULARITY</li> <li>○ CC CENTERLINE OF CULVERT</li> </ul> |
|-----------------------------------------------------------------------------------------------------------------------------------------------|------------------------------------------------------------------------------------------------------------------------------------------------------------------------------------------------------------|

**NEW FCPS COMBINED CTE SCHOOL**  
**BG# 22-167**  
 100 Midland Ave.  
 Lexington, KY 40508  
**PERMIT SET**

REVISIONS	
#	DATE DESCRIPTION




**PROJECT TEAM**  
 EOP Architects  
 201 W. Short Street, Suite 700  
 Lexington, KY 40507  
 p. 859-231-7538 | f. 859-255-4380  
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Shrout Tate Wilson Consulting Engineers  
 M&E Engineers  
 628 Winchester Rd.  
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Element Design, PLLC  
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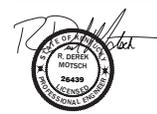
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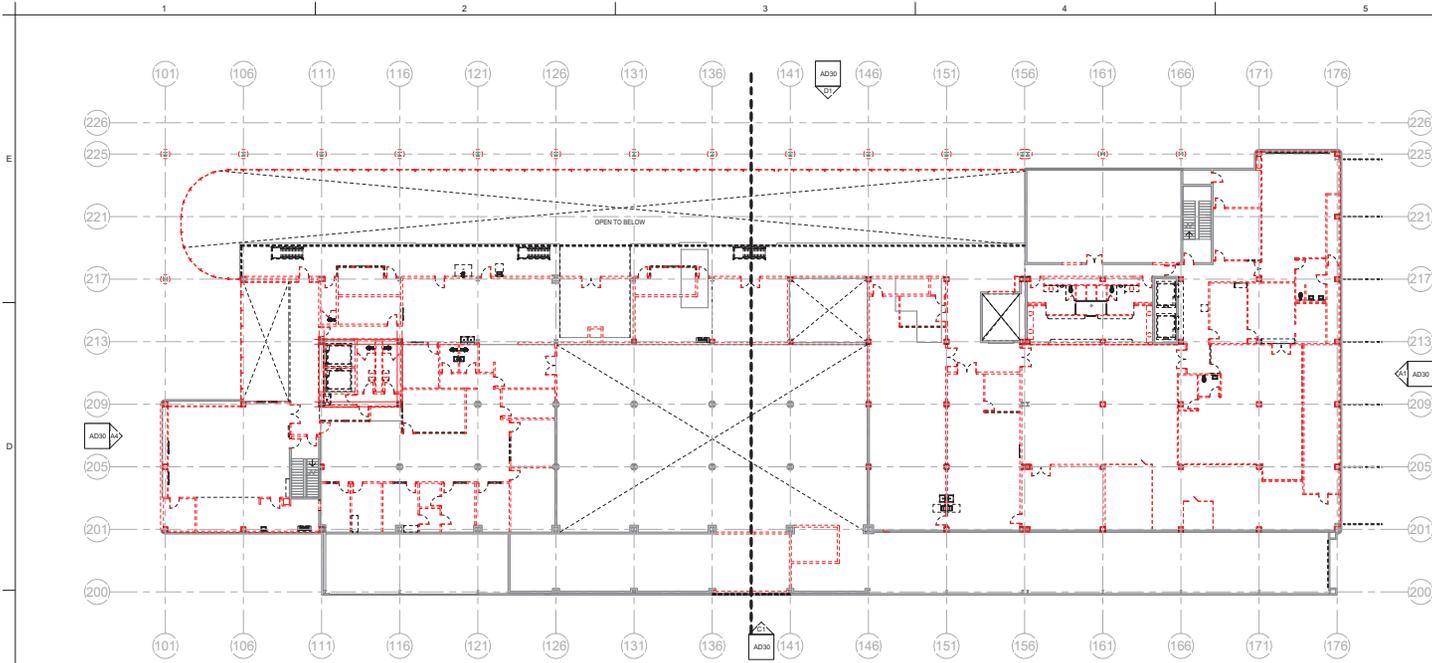
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Job Number 2150  
 Drawn By BLMEPM  
 Checked By BJM  
 Date 07/20/2022




**SITE LAYOUT PLAN EAST**

**L400-B**

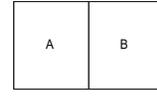

LEVEL 2 OVERALL DEMOLITION PLAN  
SCALE: 1/8" = 1'-0"

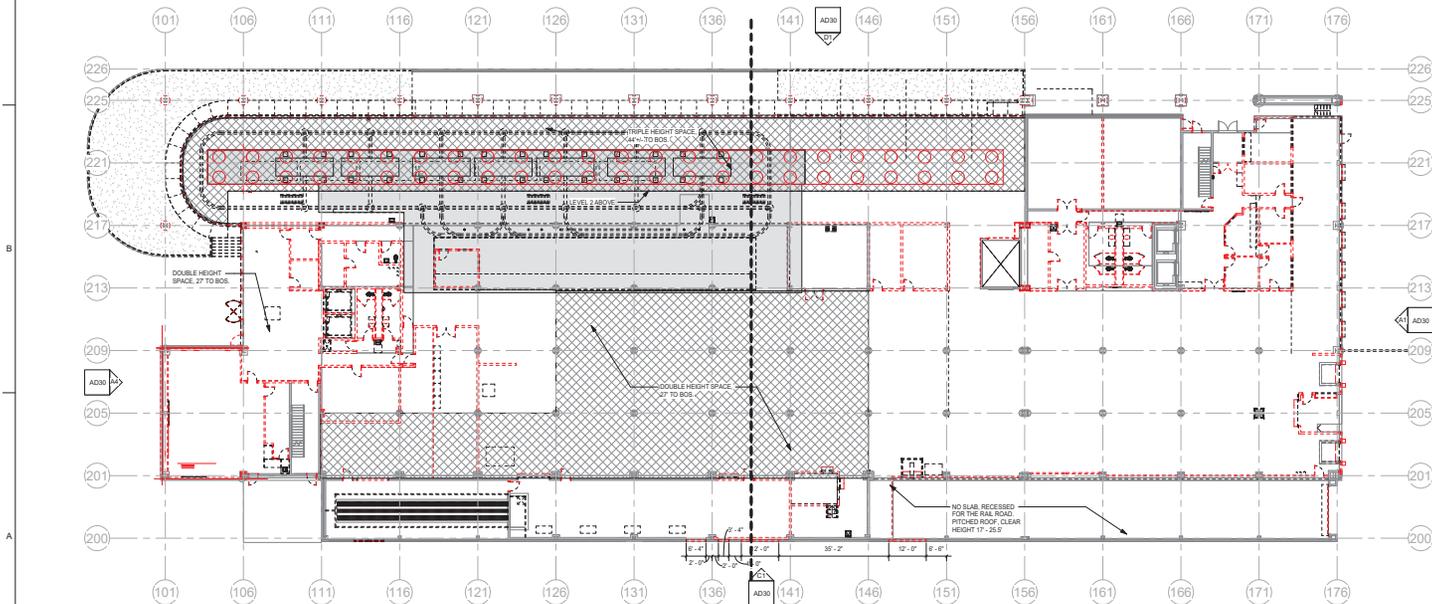

LEVEL 1 OVERALL DEMOLITION PLAN  
SCALE: 1/8" = 1'-0"

**NEW FCPS  
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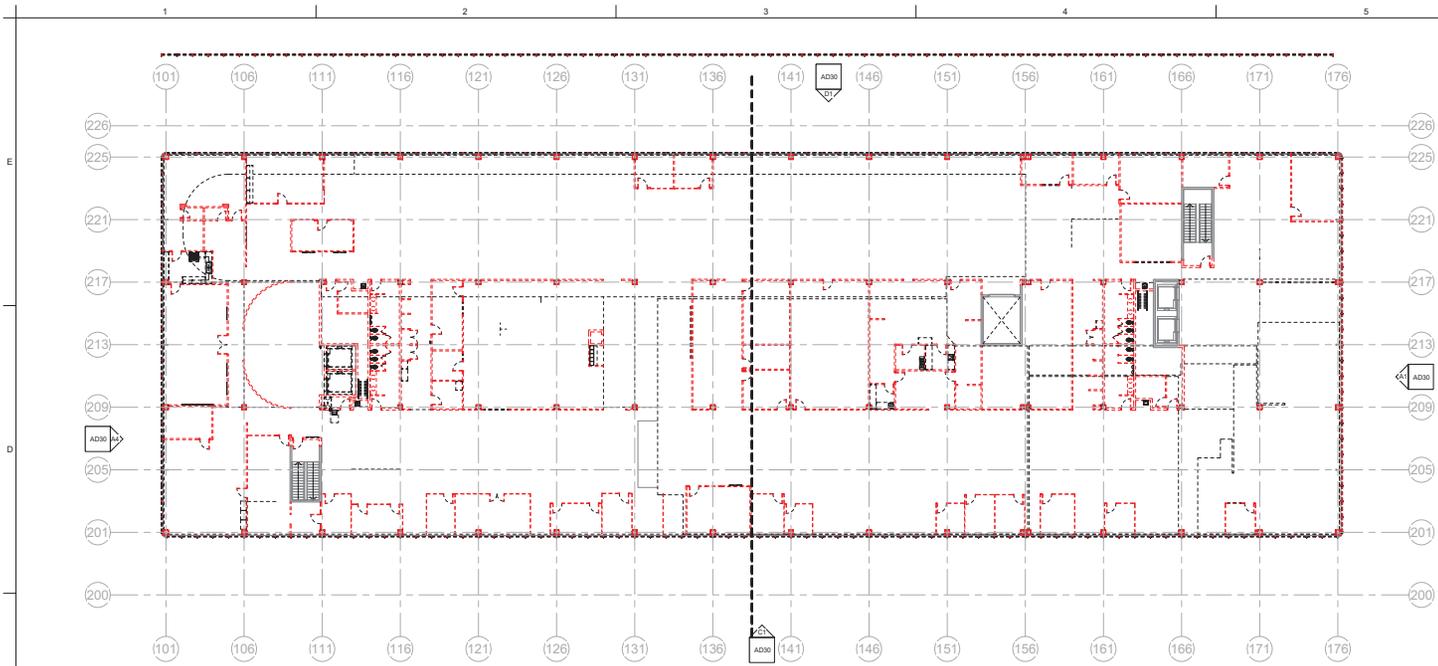
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Job Number: 2150  
Drawn By: Author  
Checked By: Checker  
Date: 07/20/2022




**OVERALL DEMOLITION PLANS**

**AD00a**



04 LEVEL 4 OVERALL DEMOLITION PLAN  
SCALE: 1/8" = 1'-0"

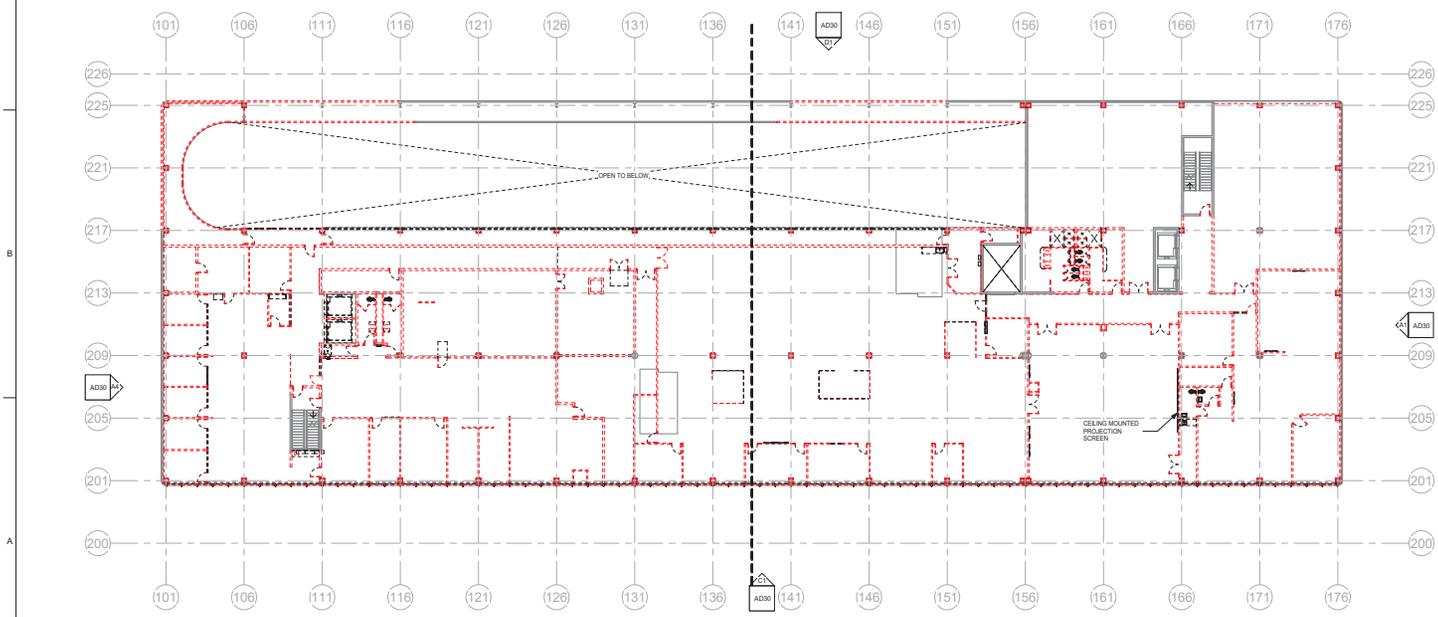

03 LEVEL 3 OVERALL DEMOLITION PLAN  
SCALE: 1/8" = 1'-0"

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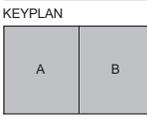
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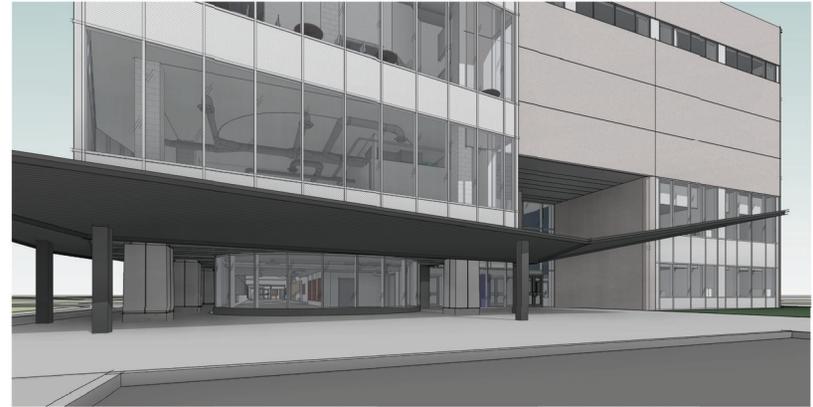
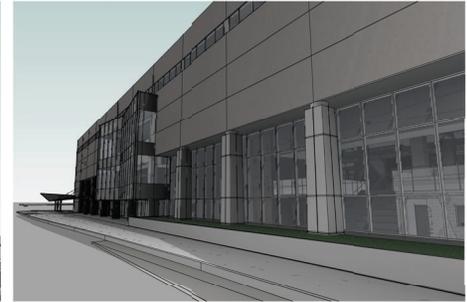
PLAN TRUE

**NOT FOR  
CONSTRUCTION**

OVERALL DEMOLITION  
PLANS

**AD00b**

PLOT DATE: 11/04/2022 11:44:30 AM



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Drawn By KLI  
Checked By JDD  
Date 07/20/2022



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CONSTRUCTION


3D VIEWS

**A000**


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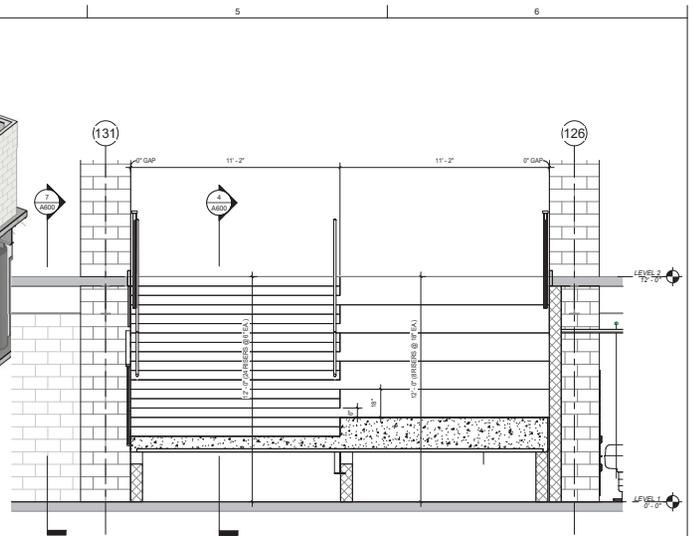





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SCALE: 1/8" = 1'-0"

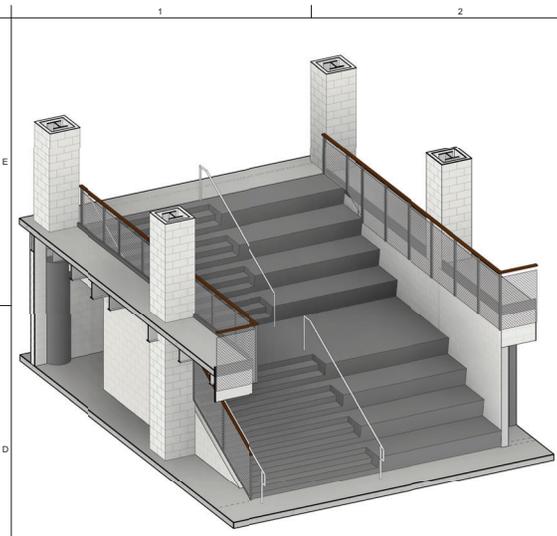


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SCALE: 1/8" = 1'-0"

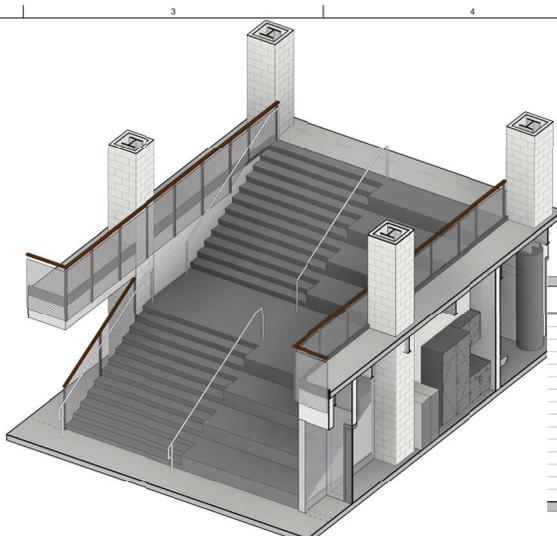


MONUMENTAL STAIR SECTION - B  
SCALE: 3/8" = 1'-0"

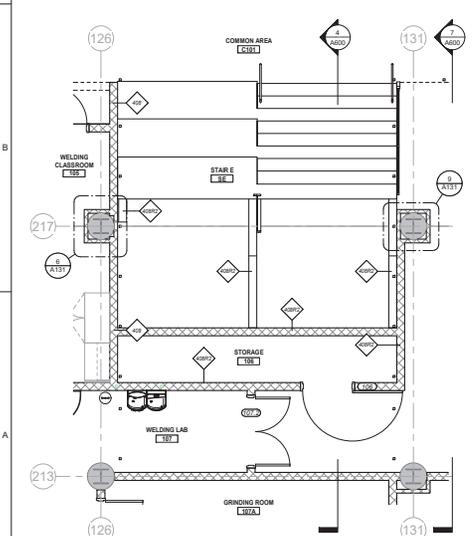


MONUMENTAL STAIR PLAN - LEVEL 1  
SCALE: 1/4" = 1'-0"

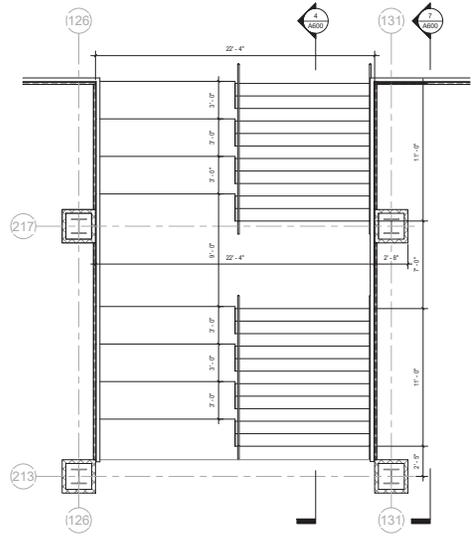

MONUMENTAL STAIR PLAN - LEVEL 2  
SCALE: 1/4" = 1'-0"

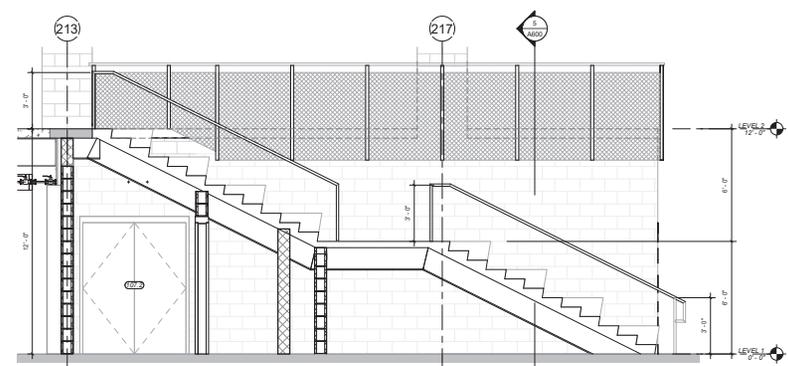

MONUMENTAL STAIR SECTION - A  
SCALE: 3/8" = 1'-0"

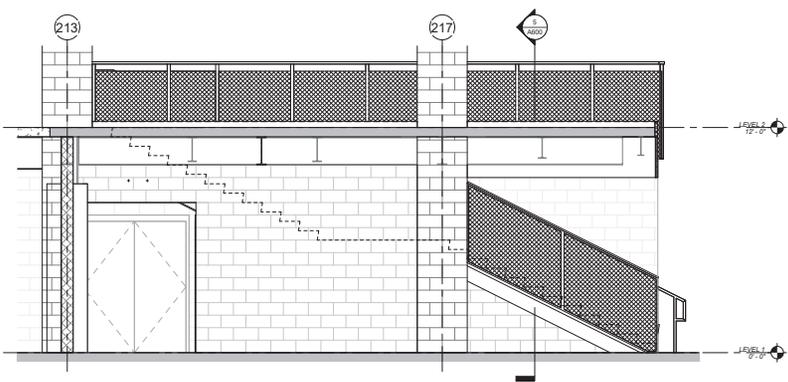

MONUMENTAL STAIR SECTION - A1  
SCALE: 3/8" = 1'-0"

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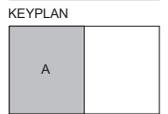
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**element  
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Job Number: 2150  
Drawn By: Author  
Checked By: Checker  
Date: 07/20/2022

**VERTICAL  
CIRCULATION - STAIRS**

**A600**

REVISED 11/4/2022 AM