

February 2, 2022

John Gilbert, AIA
Facilities Branch – Division of District Support
Kentucky Department of Educations
Office of Finance and Operations
300 Sower Blvd, 4<sup>th</sup> Floor
Frankfort, KY 40601

Re: BG 22-104- Christian Co. - New Consolidated High School Schematic Design Review - Response

Dear John:

The following is our response to your Schematic Design Review Dated 1/28/22, item by item:

RESPONSE ITEM 1: Property Purchase

RESPONSE: The school district has closed on the property and will forward all necessary information regarding the cost, deed, etc. for BG22-103.

<u>RESPONSE ITEM 2:</u> KDE Regulation 702 KAR4:160 requires the floor elevation for new construction be a minimum of 12 inches above the 100-year flood plain. Confirm the floor elevation of the facility is a minimum of 12 inches above the 100-year flood plain.

RESPONSE: The Proposed High School School Building FFE = 553.0. The lowest elevation on the site is approximately 535.17. This property is not located in a 100-year flood hazard area as indicated by Flood Insurance Rate Map Nos. 21047C0361D, dated April 19, 2019 (attached).

RESPONSE ITEM 3A: CTE programs shall be reviewed by OCTE, and their review letter shall be submitted to our office upon receipt.

RESPONSE: CTE programs have been submitted to OCTE and Dr. Hargis for review. We will forward their review letter upon receipt.

RESPONSE ITEM 3B: Auxiliary gym is not a model program space. Provide confirmation that the area may qualify within the parameters of the locally identified program space allowance (LIPSA) or have the district provide an unrestricted fund source to provide the second gym. Currently for a 2,500-student facility the building is interpolated to qualify for up to a total of 25,040nsf if you remain under 120% in total of the building area.

RESPONSE: The Auxiliary Gym and Mezzanine are part of the LIPSA allowance. The following other spaces were identified in our program as being the LIPSA spaces:

1.05	Health Class	750
7.01	Café	1,000
7.02	School Store	1,000
7.21	Auxiliary Gym / Storm Shelter	8,946
	Auxiliary Gym Mezzanine	5,635
7.24	ISS Room	750
Total LIPSA SF		18,081

<u>RESPONSE ITEM 3C:</u> Confirm the Family 7.18 (Resource Center) is the Youth Service Center and has a separate entrance from administrative areas.

RESPONSE: The Family Resource Center is the Youth Services Center and will have an separate exterior entrance as noted on the DD set submittal.

<u>RESPONSE ITEM 4A:</u> The Media Center is broken out into open areas in a variety of locations in the school. This is not in compliance with 4:180 and 702 KAR 4:170 Part 2b.9. All the breakout office and storage areas are not fully defined or understood as they relate to compliance. Clarify what does meet compliance and correct what does not.

RESPONSE: A waiver will be requested for the Media Center to be decentralized to allow for each Academy to have its own Media Center.

<u>RESPONSE ITEM 4B</u>: Designate and illustrate an outdoor courtyard area for the Art program per regulation 702 KAR 4:170 Part 2b.7. A future addition consideration is just outside the Art Room area and would negate potential access to such area in the future. Describe intent.

RESPONSE: As part of our due diligence, we have located an area north of the building for a possible future addition if the need ever arises due to a population growth in Christian County. This future addition is not expected, but if needed we have allocated a space that would create minimal impact on infrastructure and site circulation. An art patio will be planned and reflected in the CDs. If an addition is built in the far future, the art rooms will be relocated to the north end of the addition to allow for outside access, or a courtyard will be constructed to allow the art patio to remain in place.

<u>RESPONSE ITEM 4C</u>: Dead end corridors are not allowed pursuant to 702 KAR 4:170 Part 2c.1.1.3. There are 4 instances where this occurs. Correct this condition.

RESPONSE: The two dead end corridors in the Health Academy have been eliminated and are shown resolved in the DD documents that were approved by the B.O.E. The two dead end corridors in the Business Academy have been resolved and are the solution is shown in the attached plan 1-A1.1E.

<u>RESPONSE ITEM 4D</u>: Classrooms not having exterior window (natural light) areas are not compliant with 702 KAR 4:170 Part 2c. Provide natural light. Several instructional areas do not meet this requirement.

RESPONSE: Most of the classrooms not being on an Exterior wall will have natural daylight by way of borrowed light though corridors or CTE spaces with large expanses of curtainwall or storefront.

A waiver will be submitted for the following classrooms to allow for no natural light in the case that Tubular Daylighting Devices or borrowed light cannot be utilized: A105, A106, A107 & K112, FSC Classroom D112, Mac Lab E118, & ROTC Classrooms C103 & C104 as noted on the DD Drawings and shown in Waiver Exhibit.

Thank you,

Eric Rang, AIA

2-RZ

**HAFER** 


CC: Christopher Bentzel, Christian County Public Schools

Josh Hunt, Christian County Public Schools

Jack Faber, Hafer

Attachment: Survey noting no flood plains are on property.

1-A1.1E

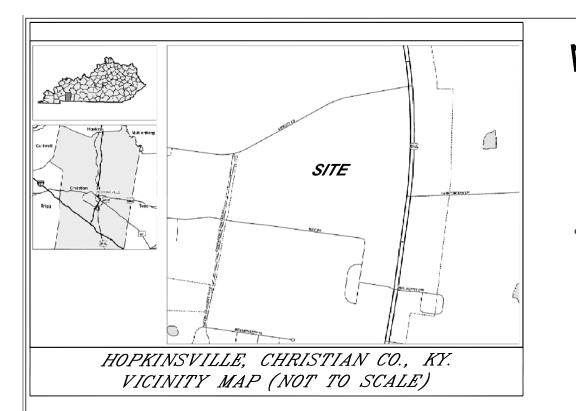

## GENERAL NOTES

1. THIS SURVEY IS SUBJECT TO ANY AND ALL LEGAL EASEMENTS AND RIGHT OF WAYS RECORDED OR UNRECORDED, INCLUDING BUT NOT LIMITED TO THOSE SHOWN HEREON.

- 2. THIS SURVEY IS SUBJECT TO ANY AND ALL FACTS THAT MAY BE DISCLOSED BY A FULL AND ACCURATE TITLE SEARCH.
- 3. THE LOCATION OF THE UNDERGROUND AND ABOVE GROUND UTILITIES SHOWN HEREON ARE BASED ON THE FIELD LOCATION OF FOUND VISIBLE STRUCTURES OR AS FLAGGED AND/OR PAINTED BY THEIR RESPECTIVE UTILITY COMPANIES. OTHER UTILITIES MAY EXIST, NO GUARANTEE IS EXPRESSED OR IMPLIED AS TO THE ACTUAL LOCATION AND/OR EXISTENCE OF SAID UNDERGROUND UTILITIES ON THIS SITE.
- 4. THE PROPERTY SHOWN HEREON IS SUBJECT TO THE RULES, REGULATIONS, SETBACKS AND ORDINANCES SET FORTH BY THE LOCAL PLANNING COMMISSION.

## 5. GPS NOTE:

50 % OF SURVEY WAS PERFORMED USING TRIMBLE - R10 - DUAL FREQUENCY GPS UNITS UTILIZING REAL TIME KINEMATIC SURVEYING TECHNIQUES. WITH AN UNADJUSTED PRECISION TO CONTROL POINTS BEING LESS THAN 0.04' OR BEING GREATER THAN 1: 10,000.

## 6.FLOOD ZONE NOTE:

THIS PROPERTY IS NOT LOCATED IN A SPECIAL FLOOD ZONE AS INDICATED BY FLOOD INSURANCE RATE MAPS COMMUNITY PANEL NO. 21047C0361D, EFFECTIVE DATE OF APRIL 19, 2019.

## DRAINAGE TABLE (CBI = CURB BOX INLET)(DBI = DRAINAGE BOX INLET) \*MANY STRUCTURES WERE FOUND WITHOUT GRATES AND DEBRIS IN BOTTOM OF STRUCTURES

	AND DEBI	RIS IN BOTTO	M OF STRU	CTURES	
STRUCTURE	RIM ELEV.:	Top Conc.	Invert	F.L. ELEV.:	Gra
CBI-1	NA	537.25	3.51	533.74	N
CBI-2	NA	537.33	3.80	533.53	N
CBI-3	NA	538.66	3.58	535.08	N
DBI-4	NA	538.55	2.93	535.62	N
CBI-5	NA	540.74	5.71	535.03	N
DBI-6	NA	540.79	3.55	537.24	N
CBI-7	NA	543.95	8.59	535.36	N
DBI-8	NA	543.92	3.57	540.35	N
CBI-9	NA	547.24	10.70	536.54	N
DBI-10	NA	547.40	3.55	543.85	N
CBI-11	NA	546.53	10.80	535.73	N
DBI-12	NA	546.53	3.59	542.94	N
CBI-13	NA	544.23	8.25	535.98	N
DBI-14	NA	544.37	3.72	540.65	N
CBI-15	NA	542.95	6.84	536.11	N
DBI-16	NA	543.17	3.59	539.58	N
CBI-17	NA	546.64	9.71	536.93	N
DBI-18	NA	546.53	6.04	540.49	N
CBI-19	NA	543.48	6.86	536.62	N
CBI-20	NA	543.37	6.67	536.70	N
CBI-21	NA	542.17	5.39	536.78	N
CBI-22	NA	542.17	5.26	536.91	N
DBI-23	541.24	NA	4.20	537.04	Ye
CBI-24	NA	541.72	4.68	537.04	N
CBI-25	NA	541.84	4.67	537.17	N
DBI-26	541.47	NA	4.21	537.26	Ye
DBI-27	NA	542.16	4.87	537.29	N
DBI-28	NA	542.46	4.86	537.60	N
CBI-29	NA	546.52	6.51	540.01	N
DBI-30	NA	546.54	4.38	542.16	N
DBI-31	NA	551.08	6.71	544.37	N
DBI-32	NA	551.18	6.57	544.61	N
DBI-33	NA	557.25	11.38	545.87	N
DBI-34	NA	557.00	8.98	548.02	N
DBI-35	NA	556.84	3.54	553.30	N
DBI-36	553.8	NA	4.48	549.32	Ye
DBI-37	553.64	NA	4.00	549.64	Ye
DBI-38	NA	545.14	3.03	542.11	N
DBI-39	NA	545.06	3.06	542.00	N
CBI-40	NA	548.84	8.23	540.61	N
CBI-41	NA	548.89	NA	NA	N
DBI-42	546.13	NA	7.08	539.05	Ye
CBI-43	547.92	NA	3.12	544.80	Ye
CBI-44	547.91	NA	2.55	545.36	Ye
CBI-44	539.29	NA	2.54	536.75	Ye
CBI-45	539.28	NA	3.05	536.23	Ye
CBI-47		NA NA			
CBI-47	537.44 537.45	NA NA	2.59	534.85 534.41	Ye
CBI-48			3.04		Ye
	535.69	NA NA	2.63	533.06	Ye
CBI-50	535.5	NA NA	2.64	532.86 534.50	YE
CBI-51	537.23	NA NA	2.64	534.59	YE
CBI-52	537.13	NA NA	3.13	534.00	YE
DBI-53	548.07 547.15	NA NA	2.55 3.59	545.52 543.56	YE
L BI-5/I	5/1/15	INI /A	4 5 U	5/14 56	V L

3.59

3.96

543.56

543.12

YES

YES

547.15

547.08

CBI-55

CBI-52

0.E.: 531.79'

O.E.: 530.39'

-HEADWALL

2+24"CMP

WEADWALL *₽*}-24"CMP

0.E.: 533.28

SANITARY MANHOLE

RIM ELEV.: 531.28'

F.L. ELEV.: 525.26'

0.E.: 533.36'

SANITARY MANHOLE

F.L. ELEV.: 525.66' 15"CPP 0.E.: 534.12'

SANITARY MANHOLE


/ RIM- ELEV .: 534.65'

F.L. ELEV : 527.52

CBI-47

PRELIMINARY

∠ RIM ELEV.: 535.17'

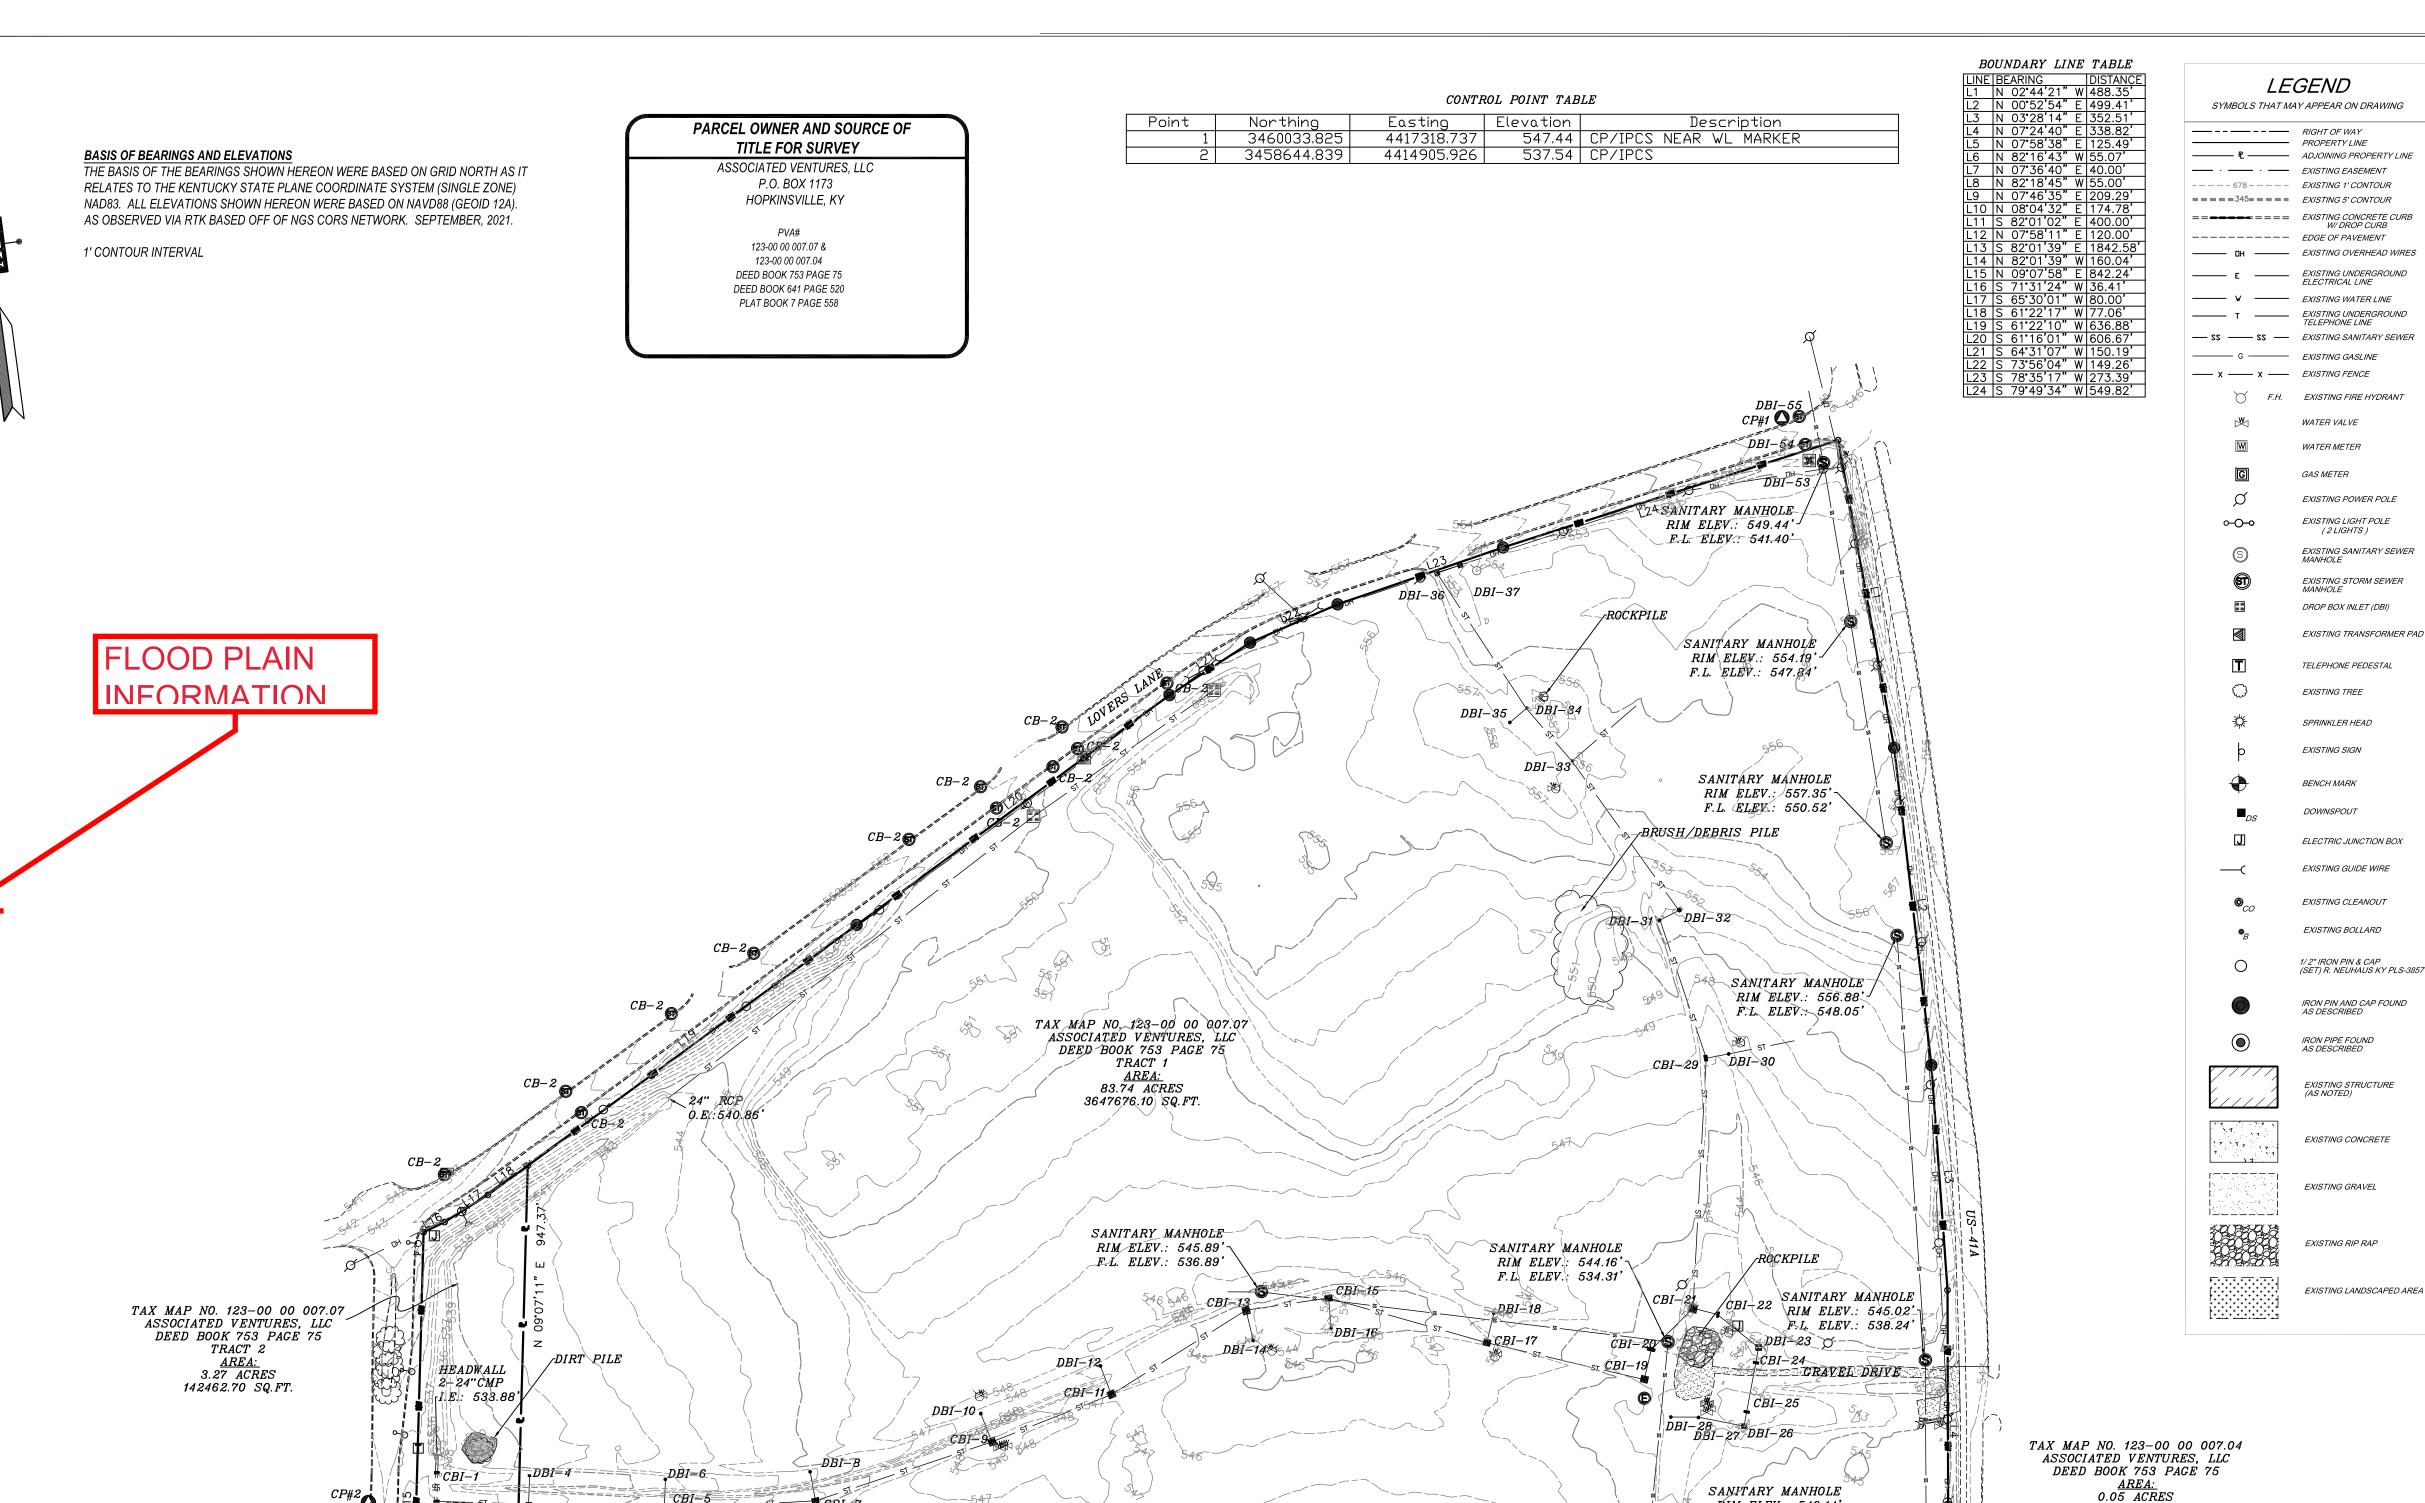

SANITARY MANHOLE

F.L. ELEV.: 527.94'

HEADWALL

0.E.: 535.67

MSU DRIVE

48"CMP

O.E.: 535.96'

SANITARY MANHOLE

RIM ELEV.: 543.03'

F.L. ELEV.: 529.19

**∕ RIM`ELEV**.: { 536.79 **'**(

NO. DATE DESCRIPTION

**REVISIONS** 

**EXISTING** TOPO

CHRISTIAN COUN SCHOOLS

EXISTING STRUCTURE (AS NOTED) EXISTING CONCRETE

, 2200.50 SQ.FT.

SANITARY MANHOLE

~RIM ELEV.: 547.63'

F.L. ELEV.: 536.62'

SANYTARY MANHOLE \_KIM ELEV.: 546.14'\

F.L. ELEV.: 535.86'

SANITARY MANHOLE

F.L. ELEV.: 536.11'

GAS LINE

SANITARY MANHOLE

F.L. ELEV.: 543.64'

RIM ELEV.: 549.41'

MARKER

SANITARY MANHOLE

RIM ELEV .: 549.78'

F.L. ELEV.: 531.45'

RIM ELEV .: 547.31'-

fHEADWALL

∕ 15"CMP

DBL 38 I.E.: 542.46

SANITARY MANHOLE 548RIM ELEV.: 545.87'

F.L. ELEV .: 532.46'

SANITARY MANHOLE

[ RHM ELEV 3 548.13"

F.L. ELEV.: 530.40'

I.E.: 545.62'

EXISTING GRAVEL

WATER VALVE

WATER METER

EXISTING POWER POLE

EXISTING LIGHT POLE

EXISTING SANITARY SEWER MANHOLE

EXISTING TRANSFORMER PAD

EXISTING STORM SEWER MANHOLE

DROP BOX INLET (DBI)

TELEPHONE PEDESTAL

EXISTING TREE

SPRINKLER HEAD

EXISTING SIGN

BENCH MARK

DOWNSPOUT

ELECTRIC JUNCTION BOX

EXISTING GUIDE WIRE

EXISTING CLEANOUT

EXISTING BOLLARD

1/ 2" IRON PIN & CAP (SET) R. NEUHAUS KY PLS-3857

IRON PIN AND CAP FOUND AS DESCRIBED

GAS METER

EXISTING RIP RAP


EXISTING LANDSCAPED AREA

1"=150' 09/20/2021

DRAWN BY: K. BILLINGSLEY

C. SMITH T:/21 PROJECTS/ .dwg

CHECKED BY:

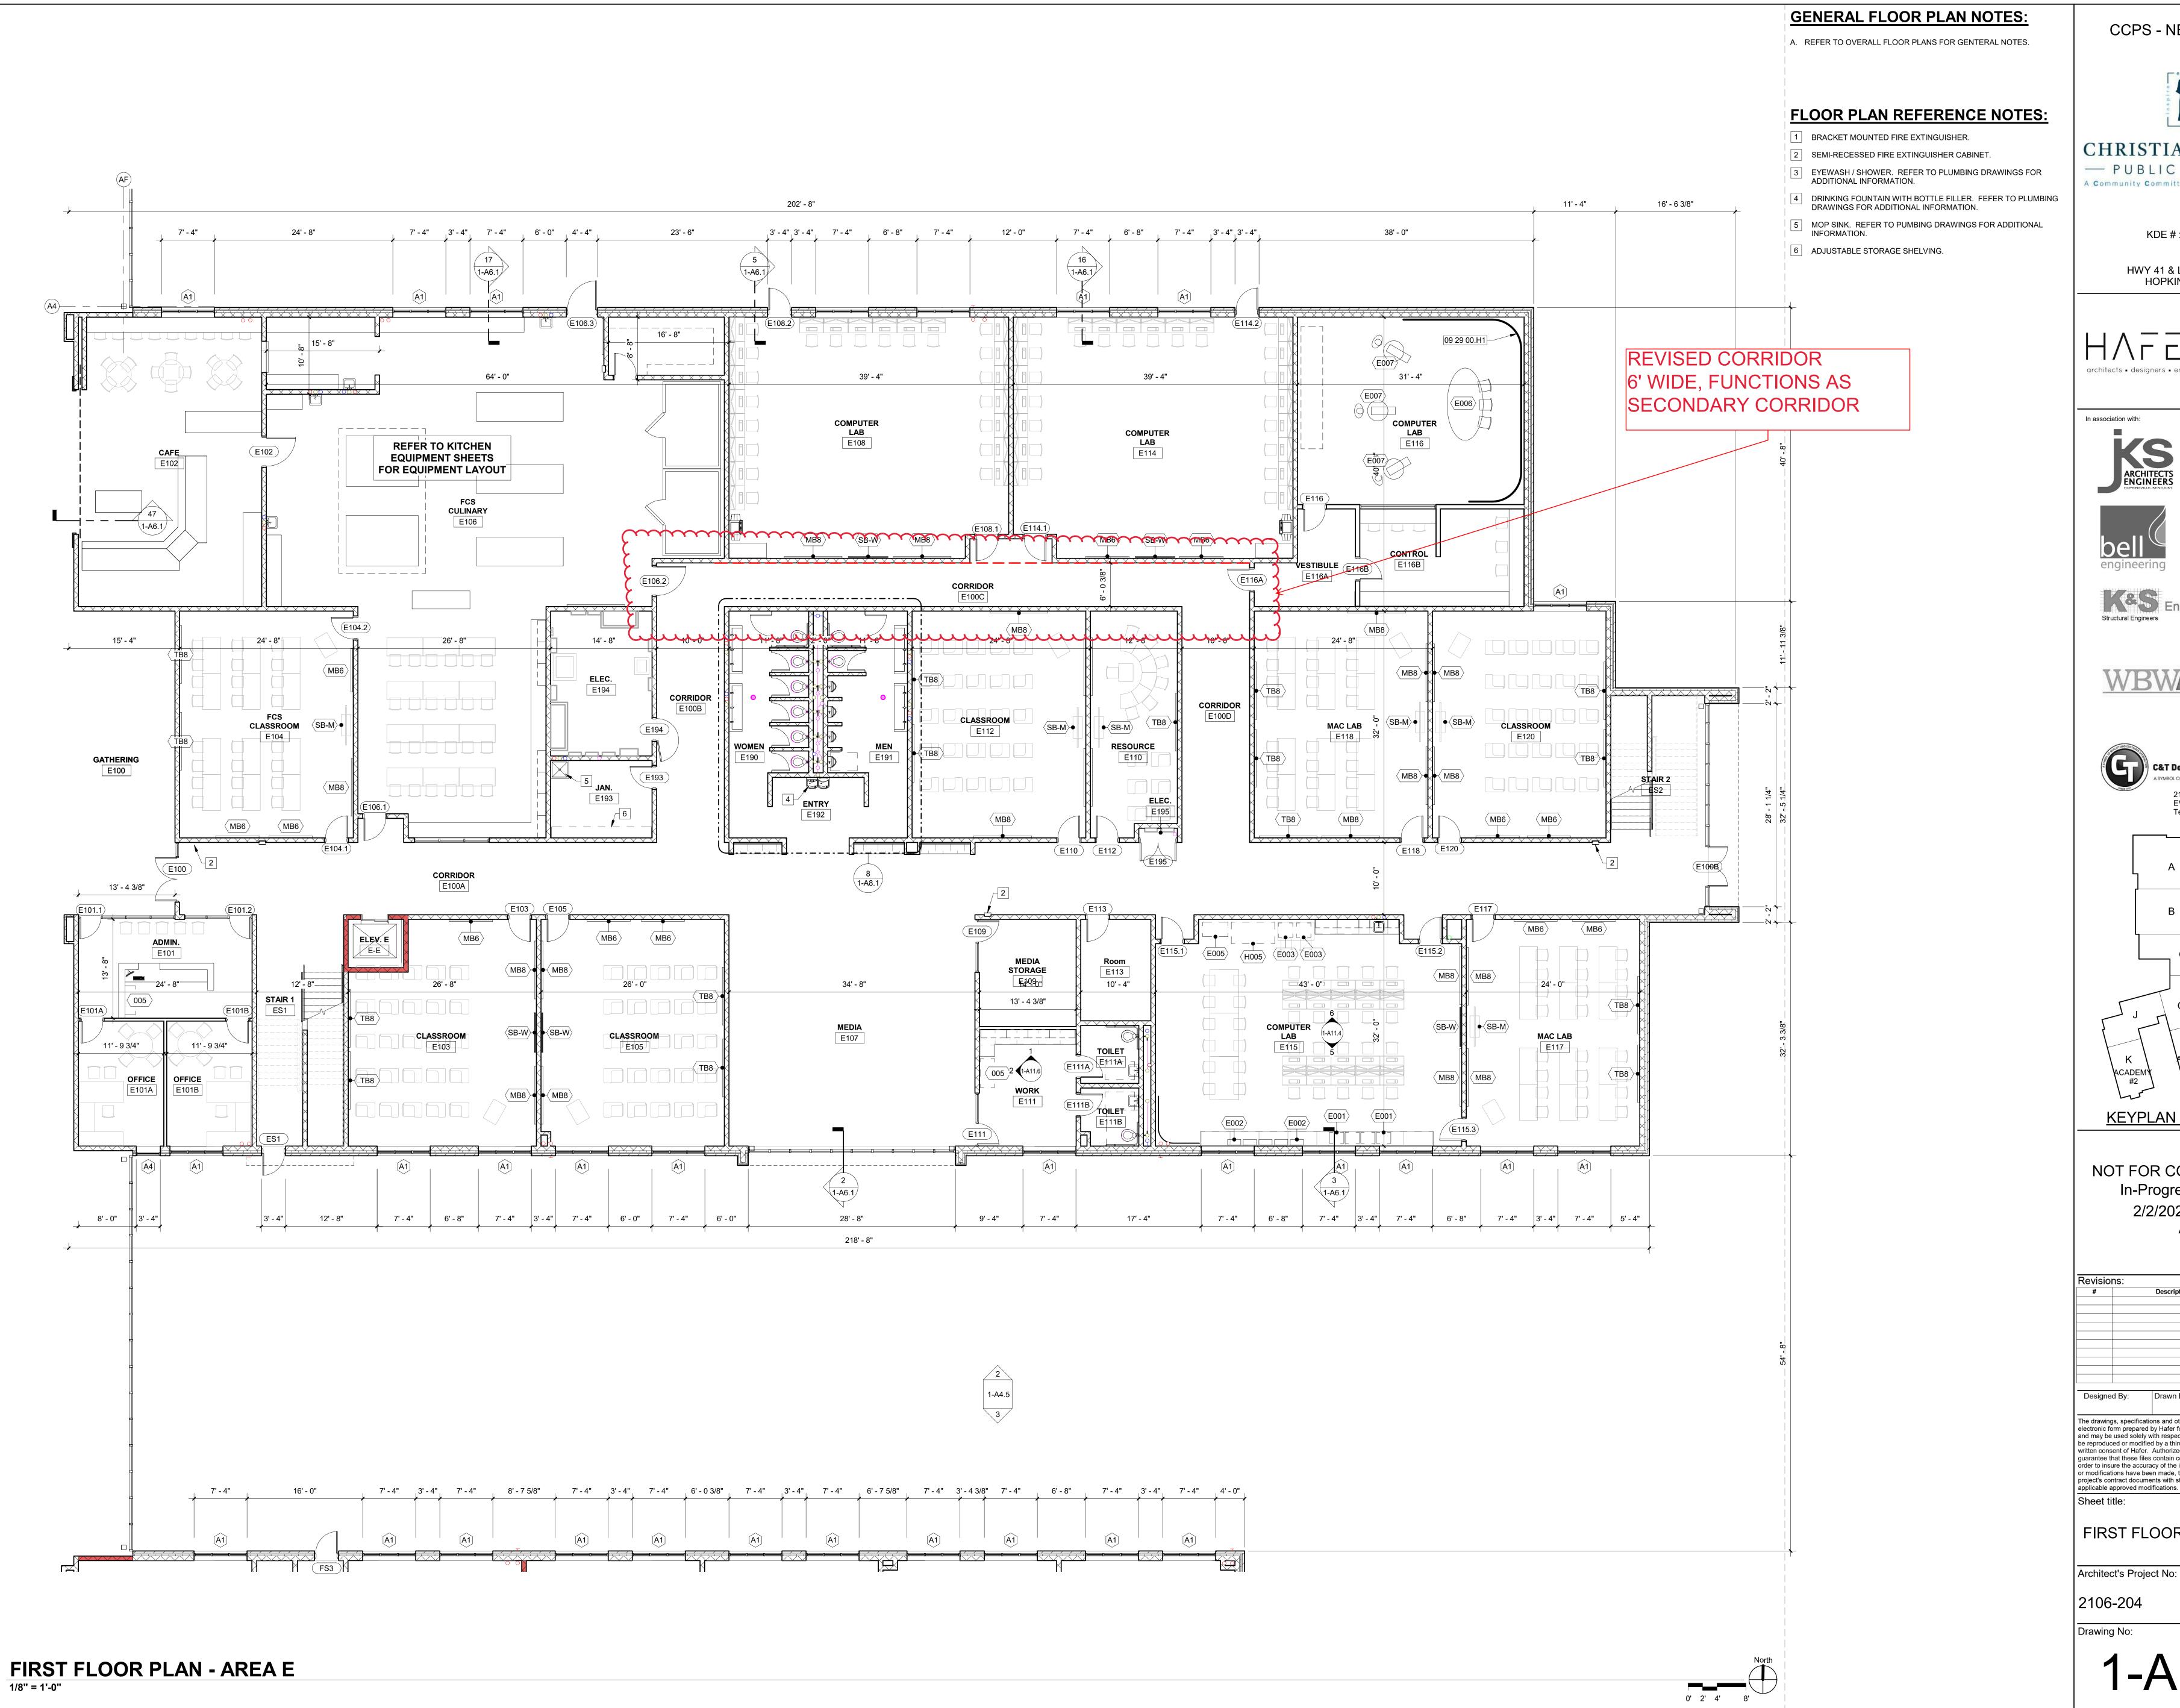

CCPS - NEW SCHOOL



CHRISTIAN COUNTY - PUBLIC SCHOOLS-A Community Committed to Phenomenal Schools

KDE # : BG 22-104

HWY 41 & LOVER'S LANE, HOPKINSVILLE, KY

21 SE Third Street, Suite 800 architects • designers • engineers F: 812.421.6776

In association with: ARCHITECTS ENGINEERS

402 Liberty Street Hopkinsville, KY 42240 Telephone: 270-885-2296



107 Forbes Drive Hopkinsville, KY 42240 Telephone: 270-886-5466


124 Hillcrest Drive Clarksville, TN 37043

Telephone: 931-647-5542

3000 Canton Street Telephone: 270-886-2536



2102 KOTTER AVENUE, SUITE C EVANSVILLE, IN Telephone: 812-421-0873

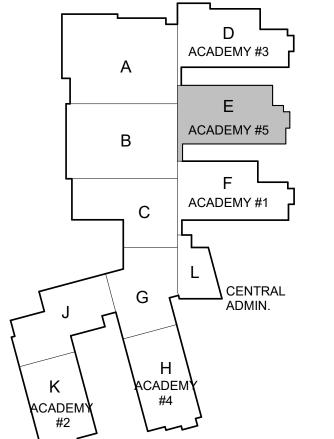

**KEYPLAN BUILDING #1** 

NOT FOR CONSTRUCTION In-Progress Dwg Set 2/2/2022 8:10:43

#	Description	
Designed By:	Drawn By:	Checked By:
,		

electronic form prepared by Hafer for this project are instruments of Service, and may be used solely with respect to this project. The documents may not be reproduced or modified by a third party without first obtaining the express written consent of Hafer. Authorized use of electronic media or file does not guarantee that these files contain complete and accurate information. In order to insure the accuracy of the information contained and that no changes or modifications have been made, these files must be compared to the project's contract documents with stamped and sealed certification and applicable approved modifications.

Sheet title: FIRST FLOOR PLAN - AREA E

2106-204

January, 2022

Date:

Drawing No: