ELIZABETHTOWN HIGH SCHOOL RESTROOM RENOVATION

Elizabethtown, Kentucky for the

Elizabethtown Independent School District

620 N Mulberry St. Elizabethtown, Kentucky 42701

p 270.769.3381

BG # 21-290

RTA # 2121



101 old lafayette avenue lexington, kentucky 40502 p 859.254.4018 www.rosstarrant.com

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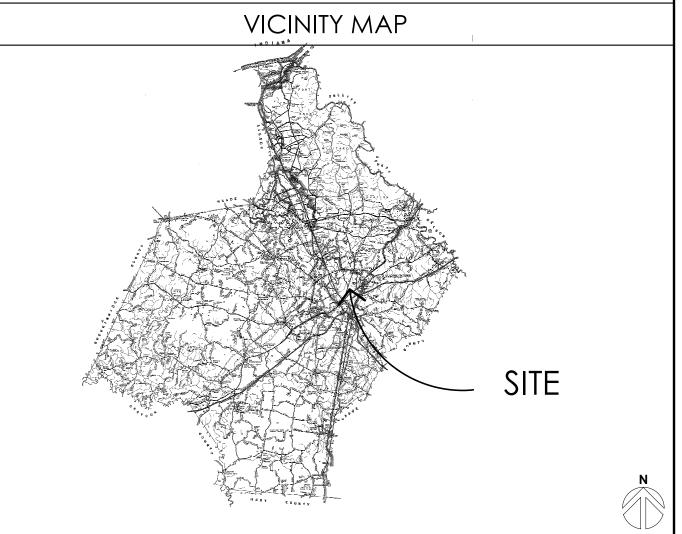
M.E.P. ENGINEER:

CMTA, INC. 2429 Members Way p 859.253.0892


Lexington, Kentucky 40504

PROJECT SITE ADDRESS:

620 N Mulberry St.
Elizabethtown,
Kentucky
42701



PROJECT VICINITY MAP

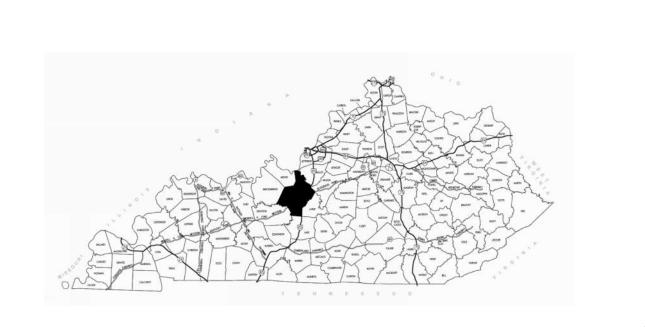

rosstarrant
alafayette avenue lexington, kentucky 40502 p 859.254.4018

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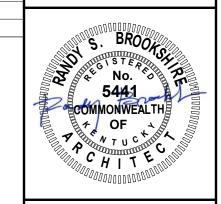
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HIGH SCHOOL RESTROOM RENOVATION
FOR:
HTOWN INDEPENDENT SCHOOLS
IZABETHTOWN, KENTUCKY

BG# 21-290

Project No: 2121
Drawn By: FB/TS
Rev'd By: GH


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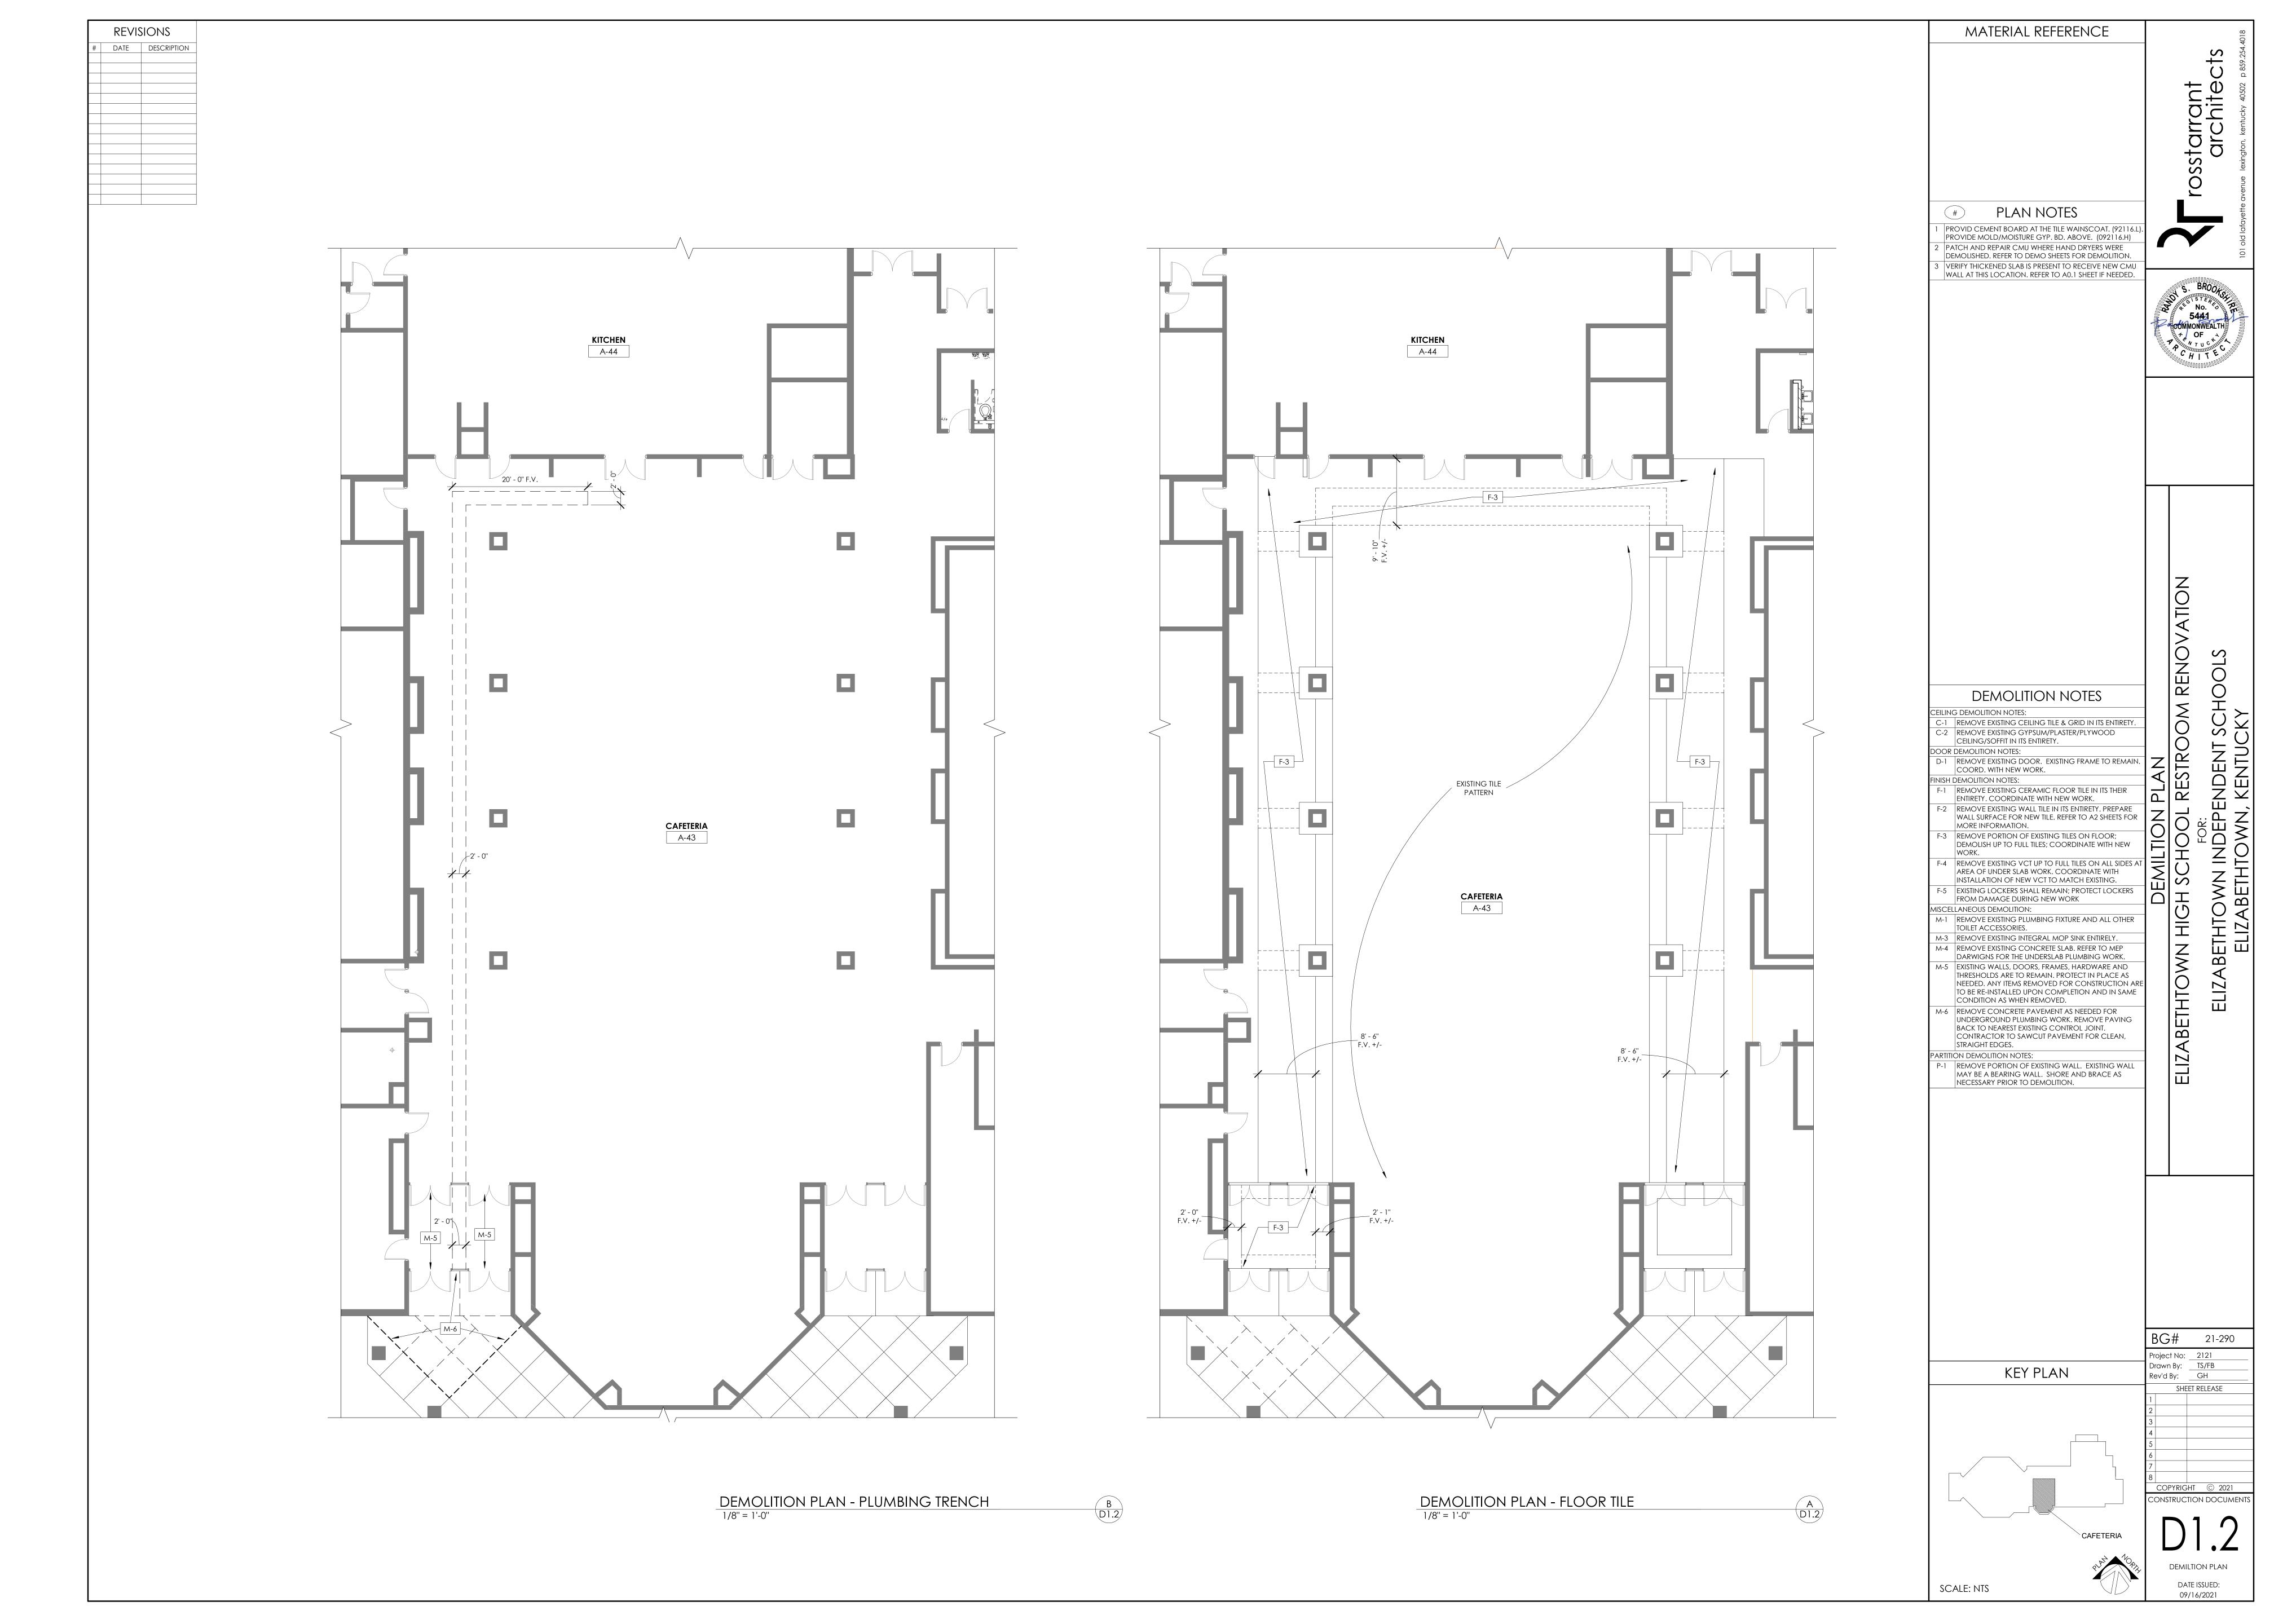
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CONSTRUCTION DOCUMENTS


COVER SHEET

DATE ISSUED:

09/16/2021




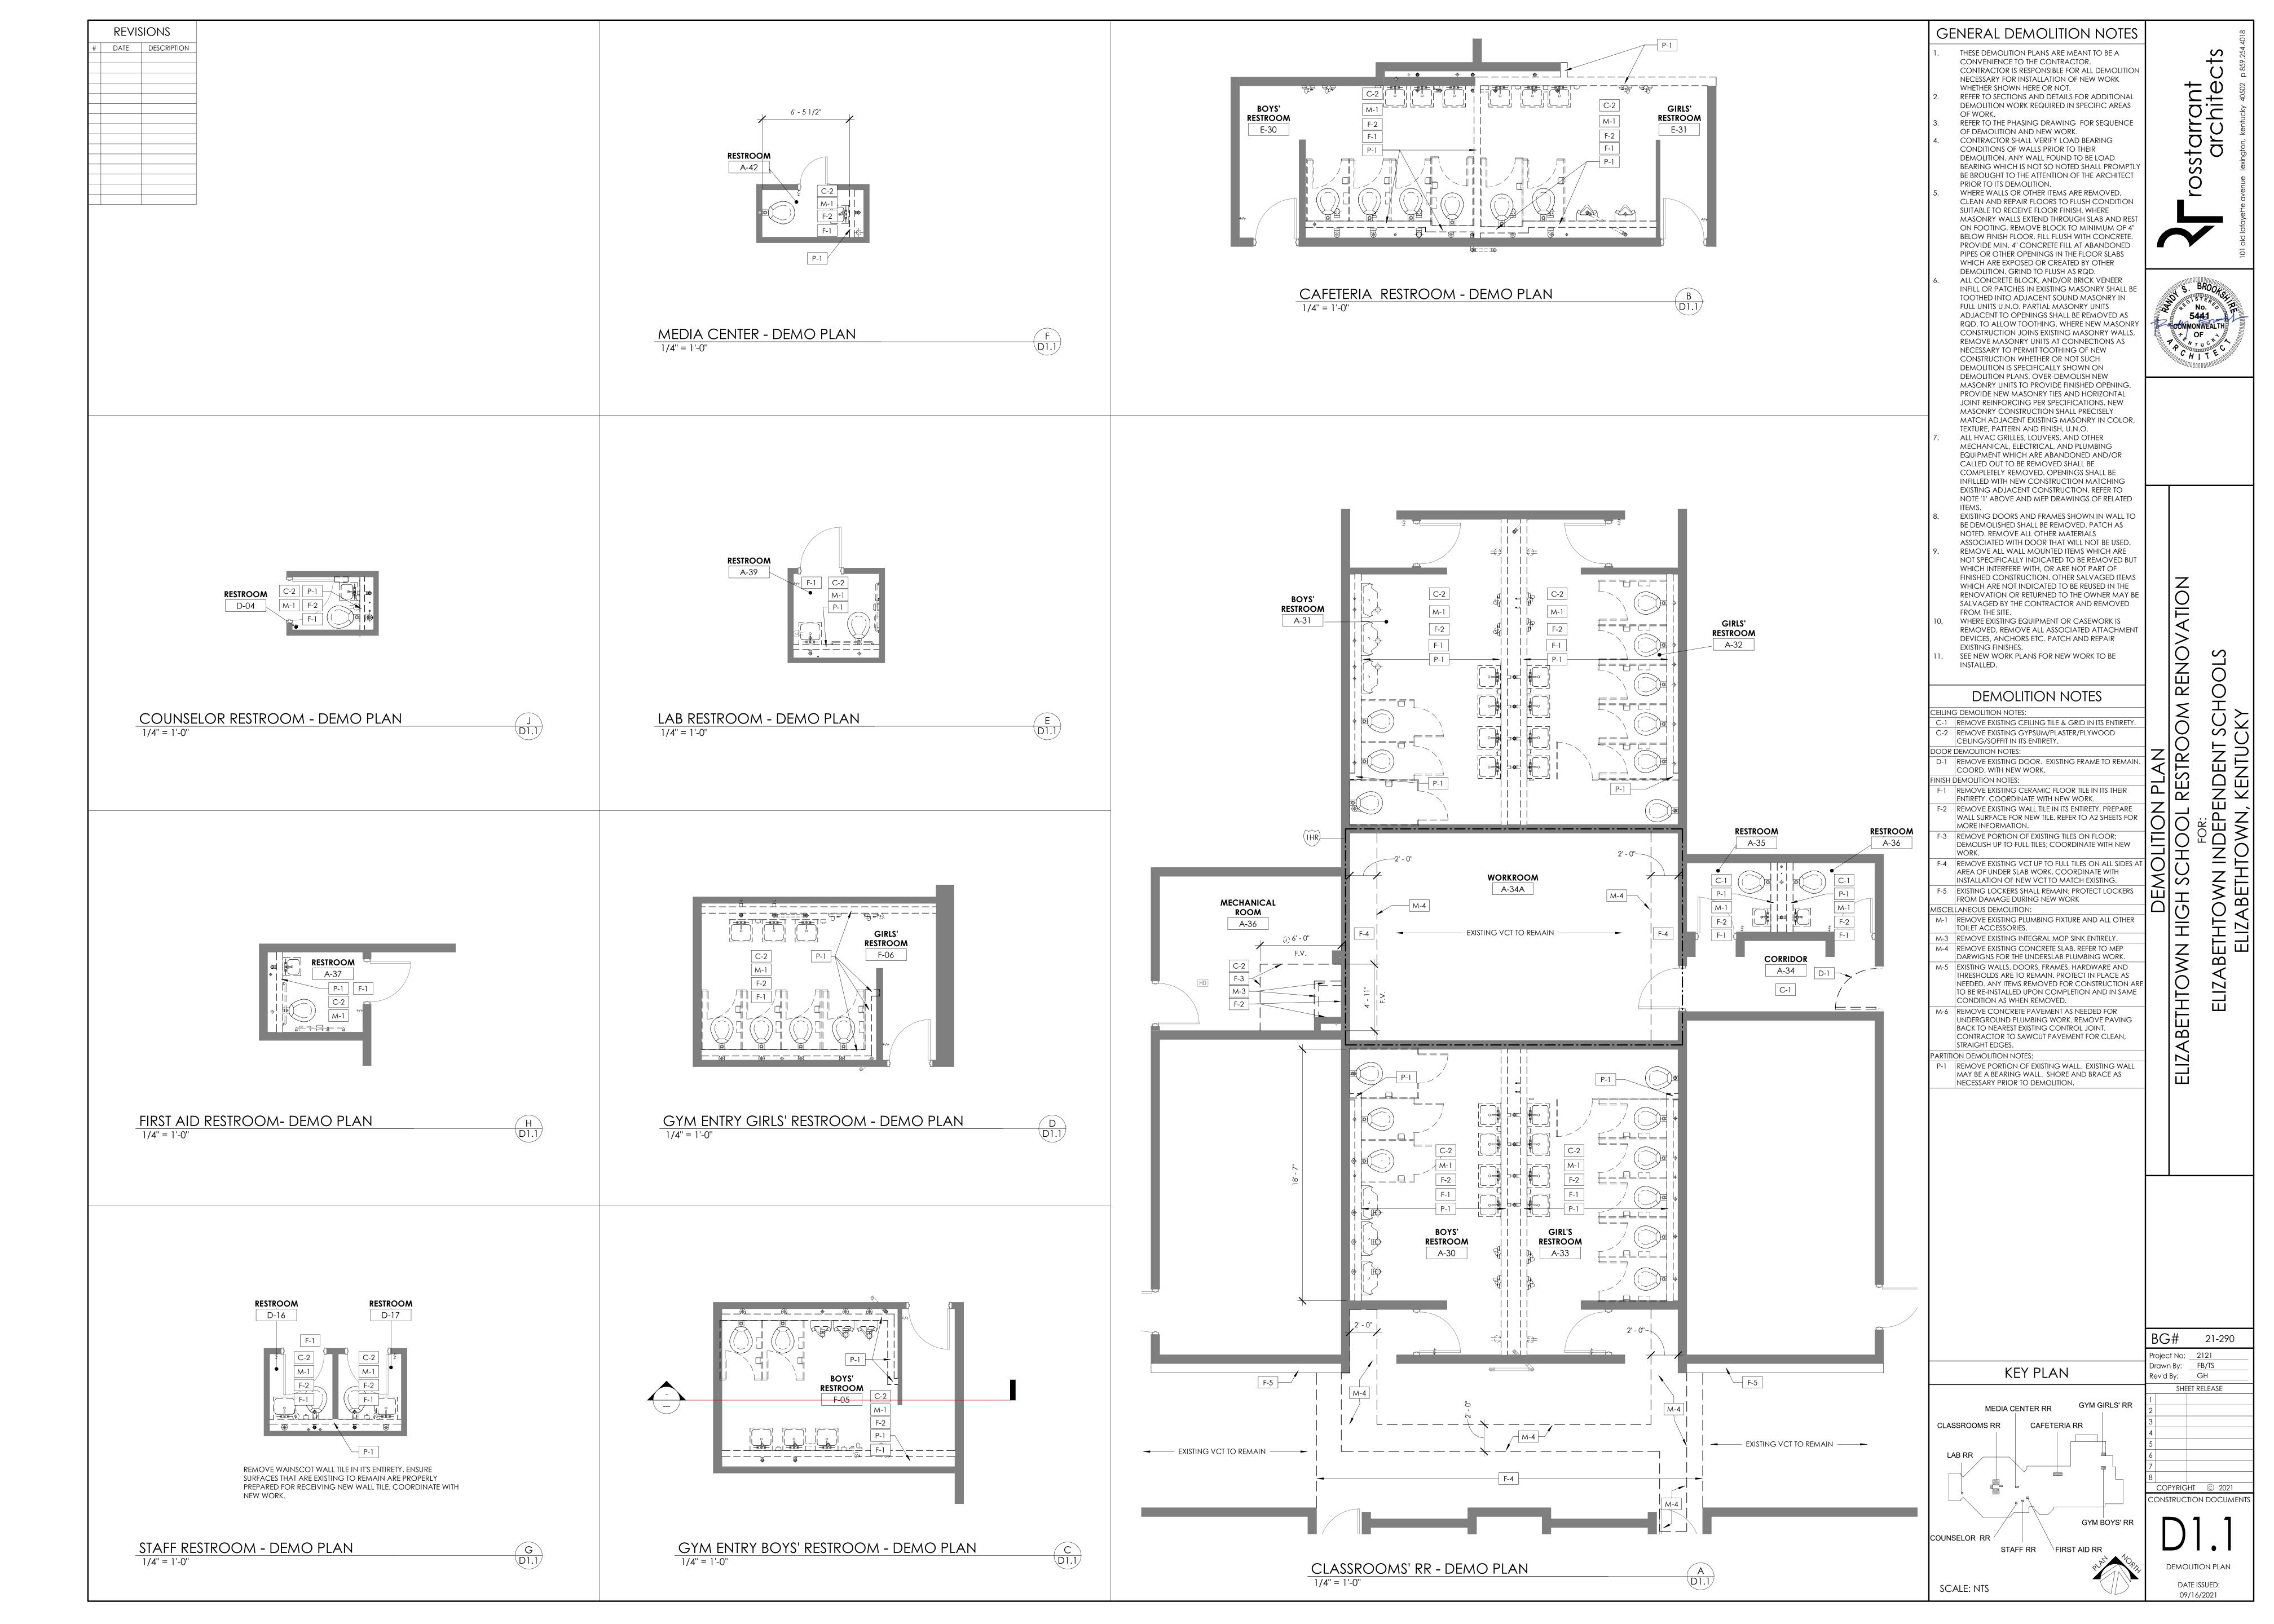

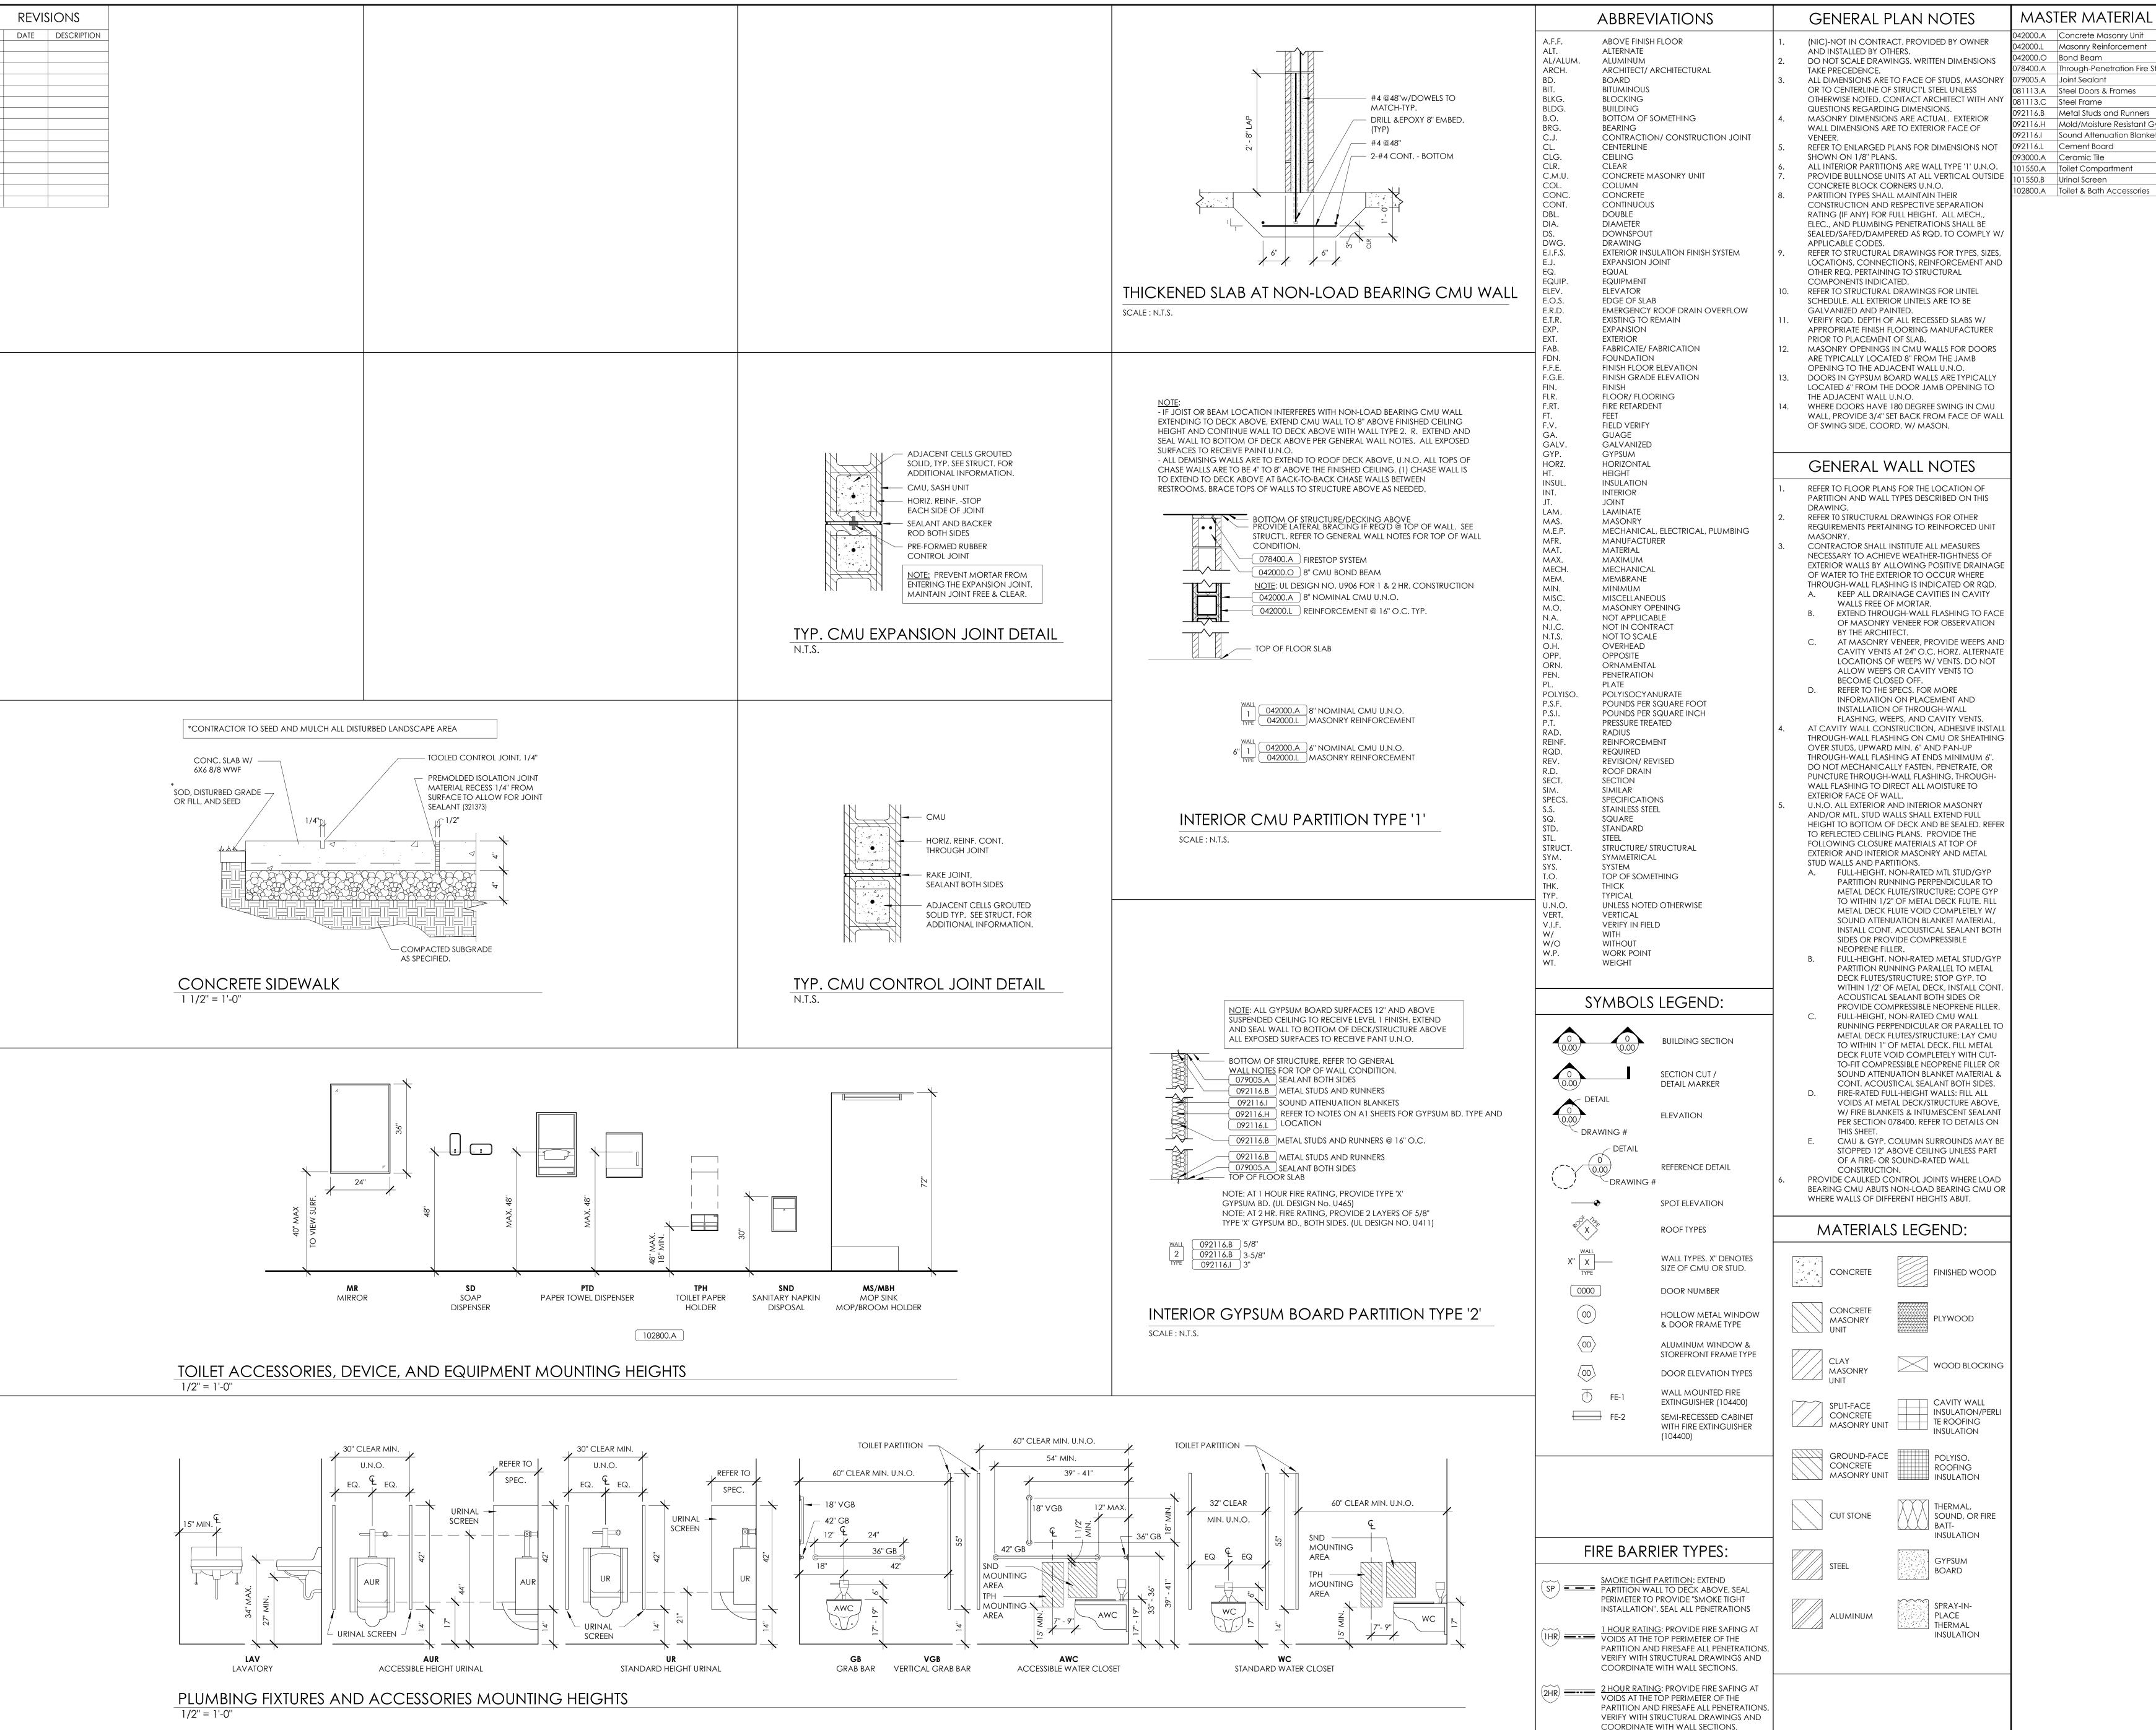

MASTER MATERIAL REFERENCE 78400.A Through-Penetration Fire Stop System P2116.H Mold/Moisture Resistant Gypsum Board 2116.I Sound Attenuation Blankets

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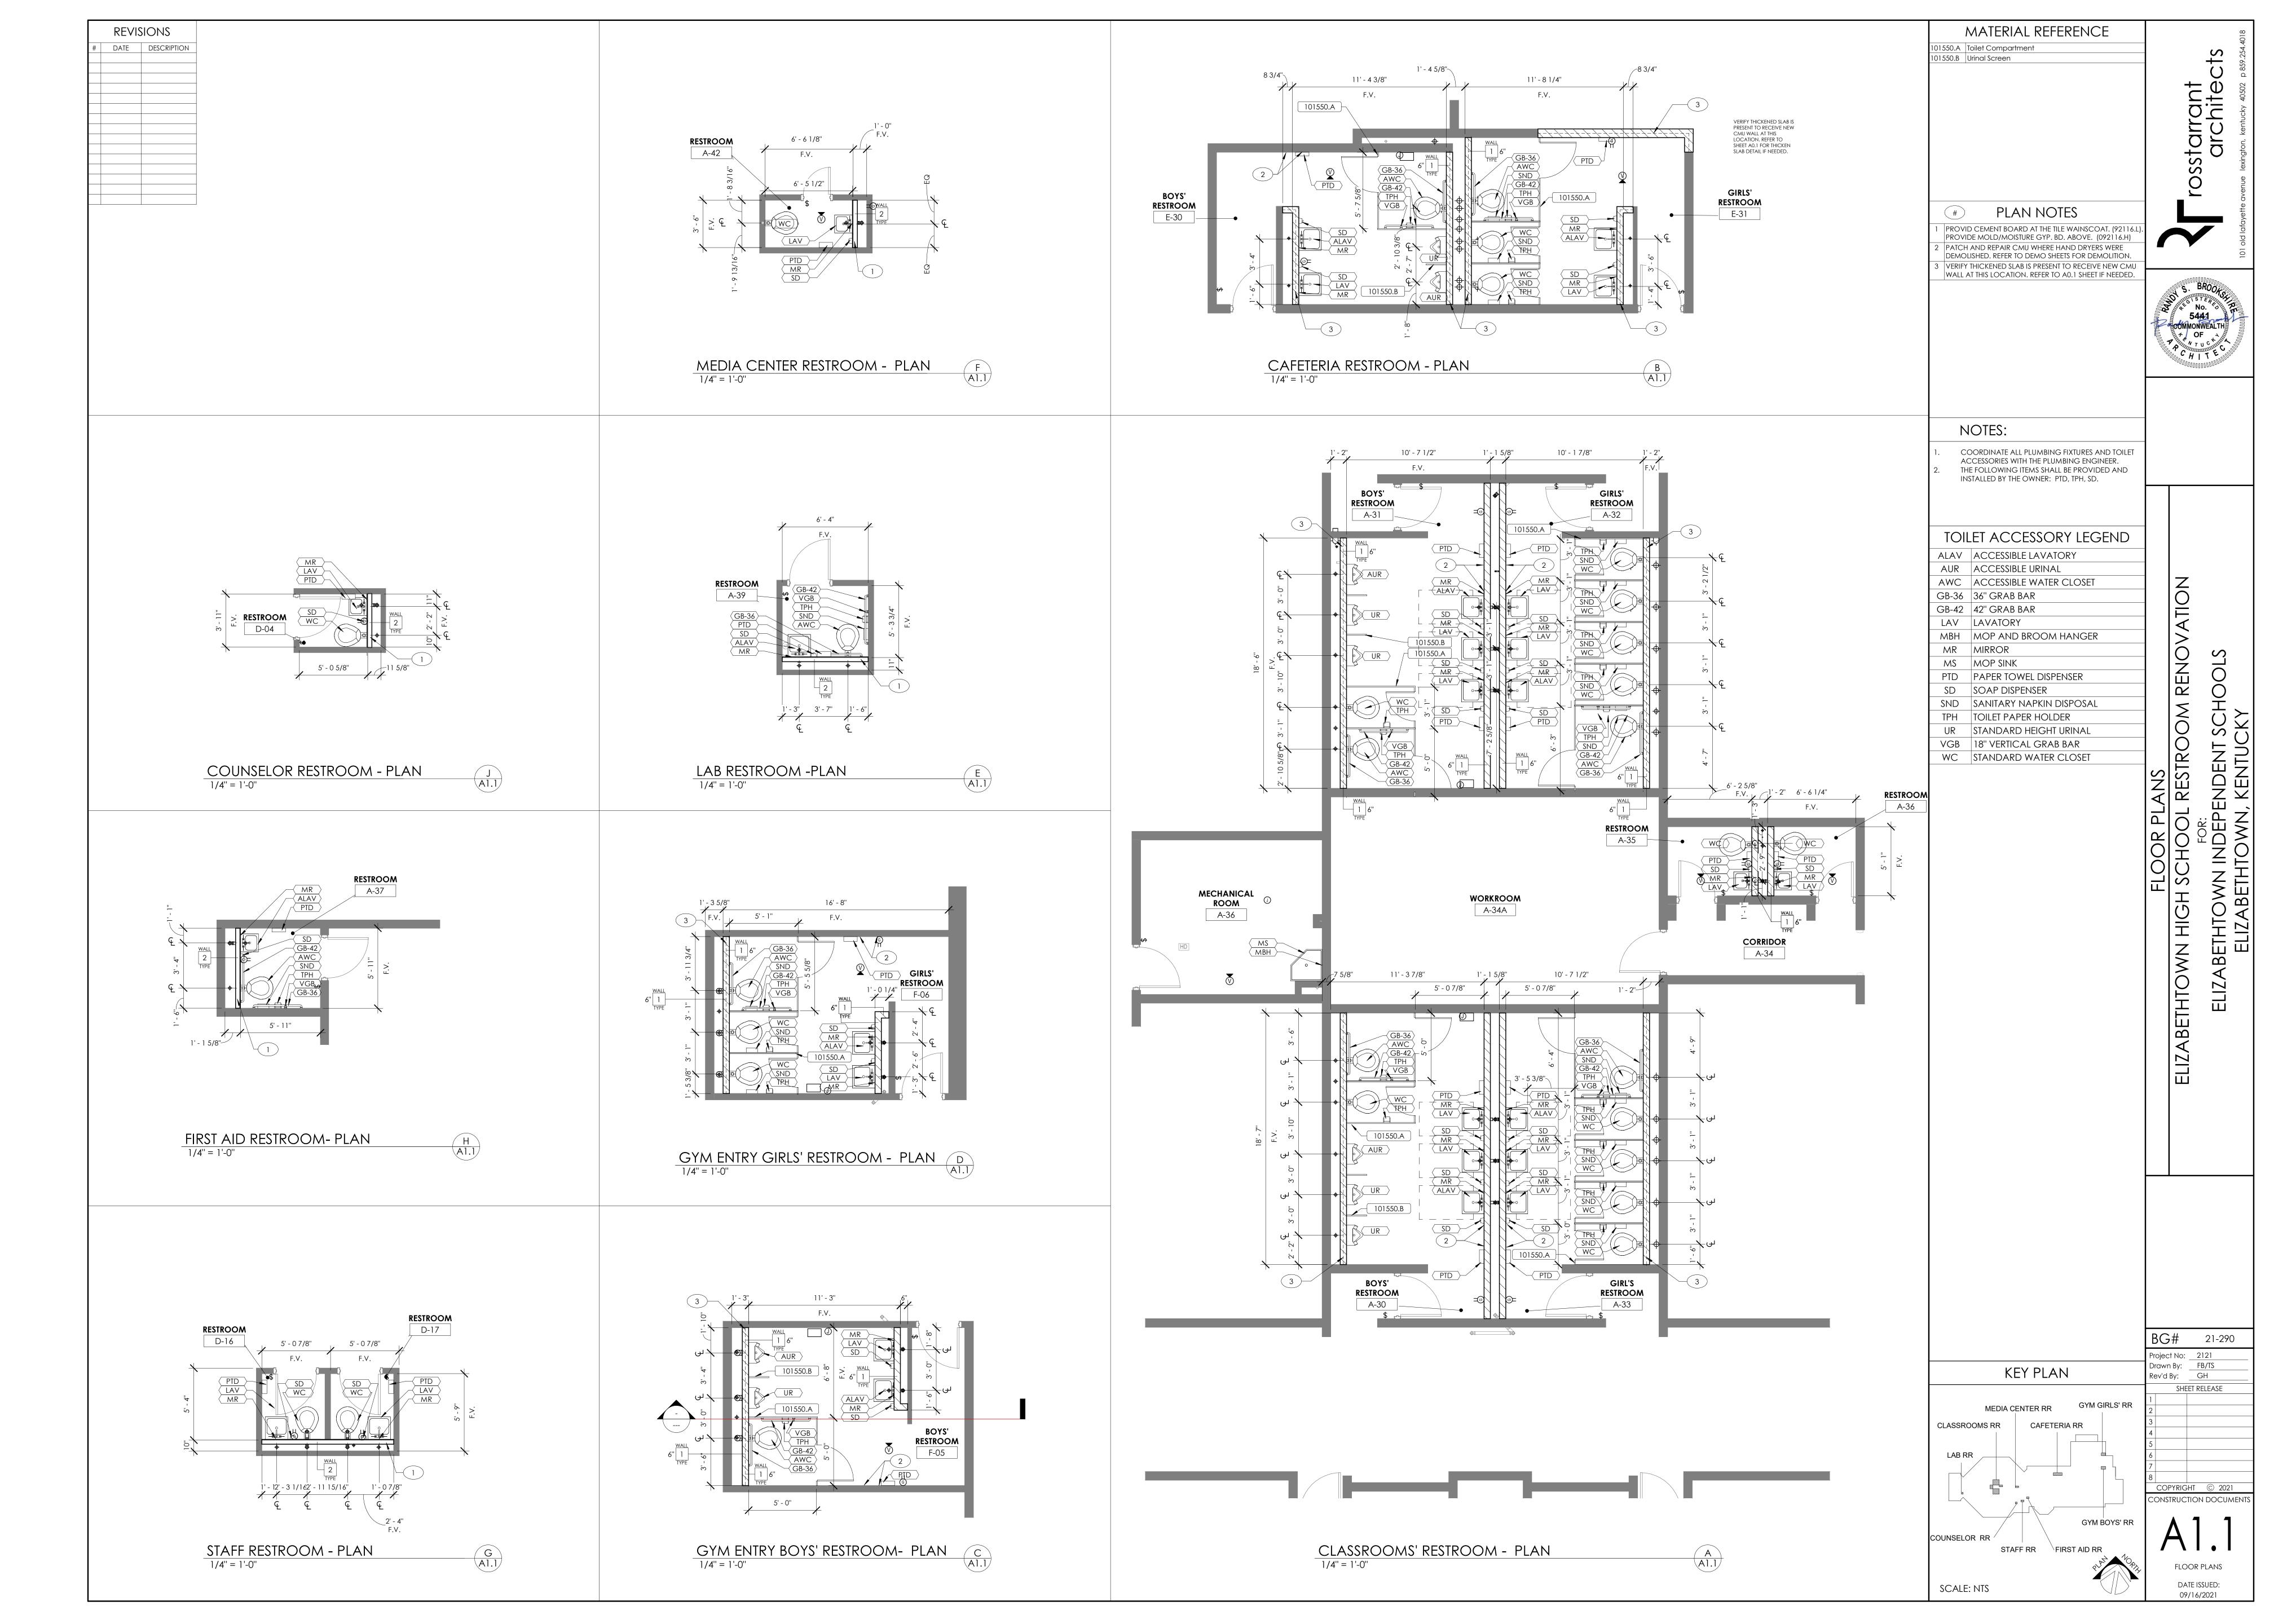


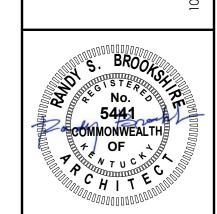
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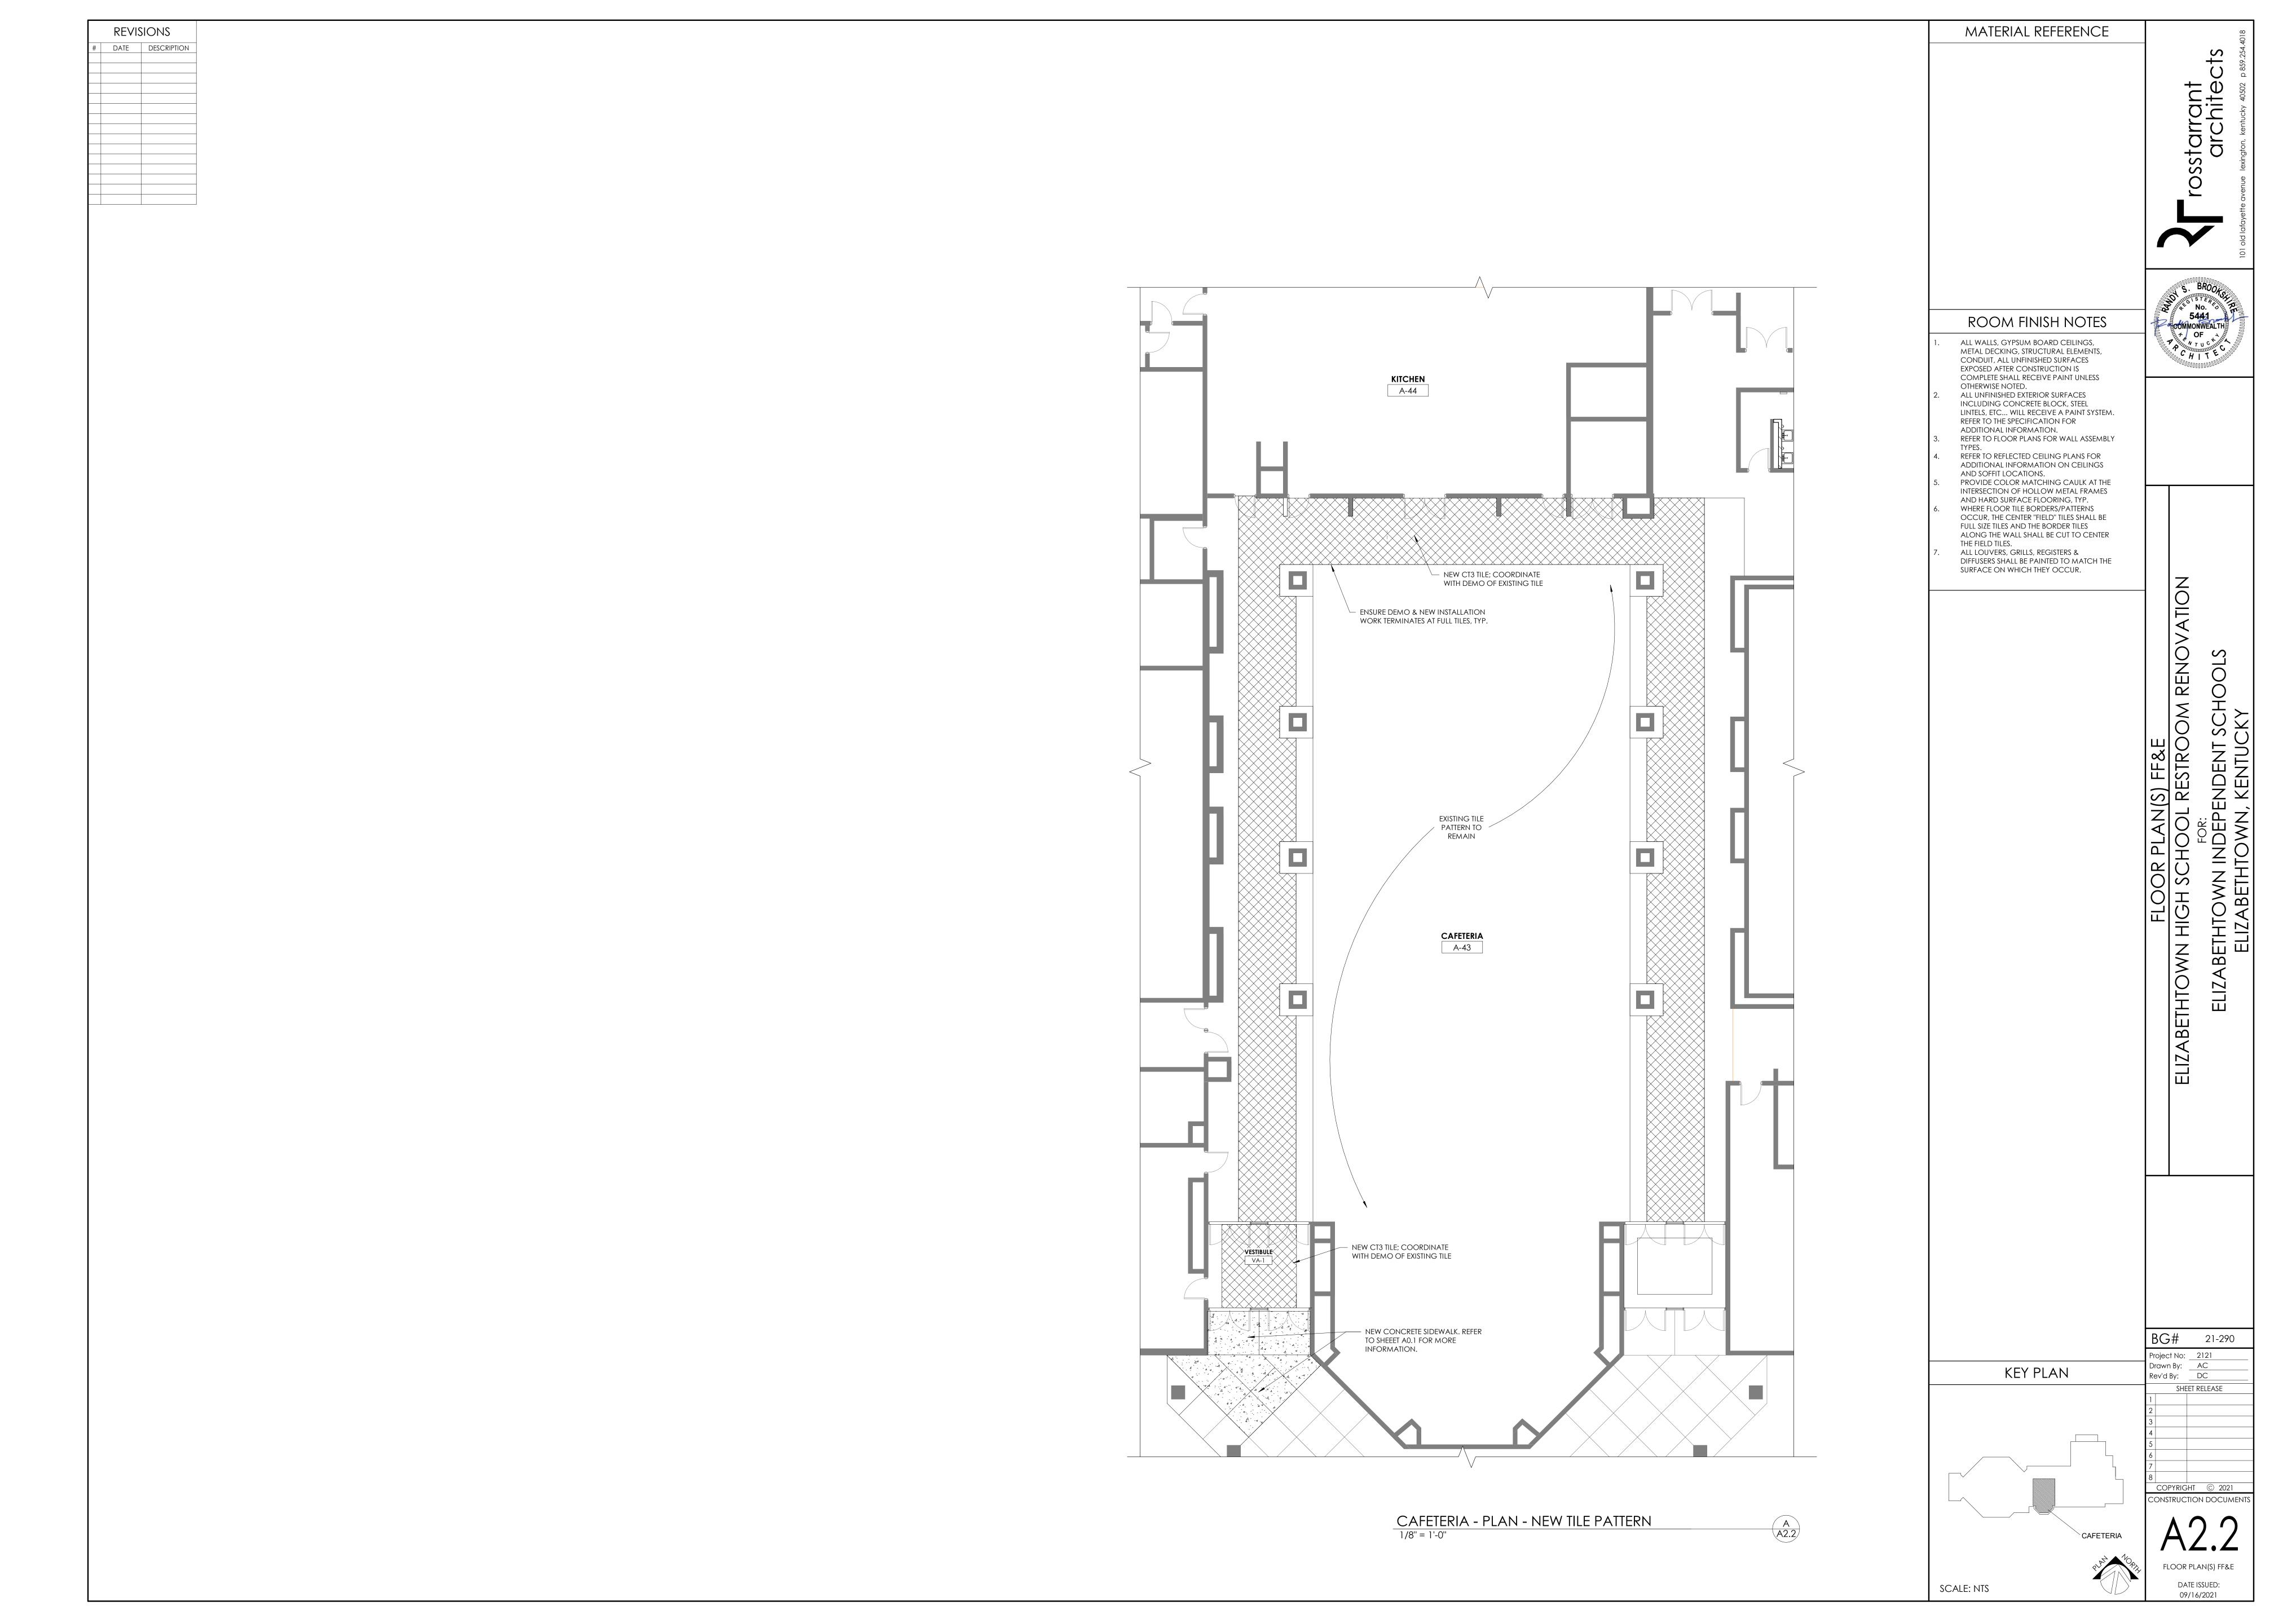
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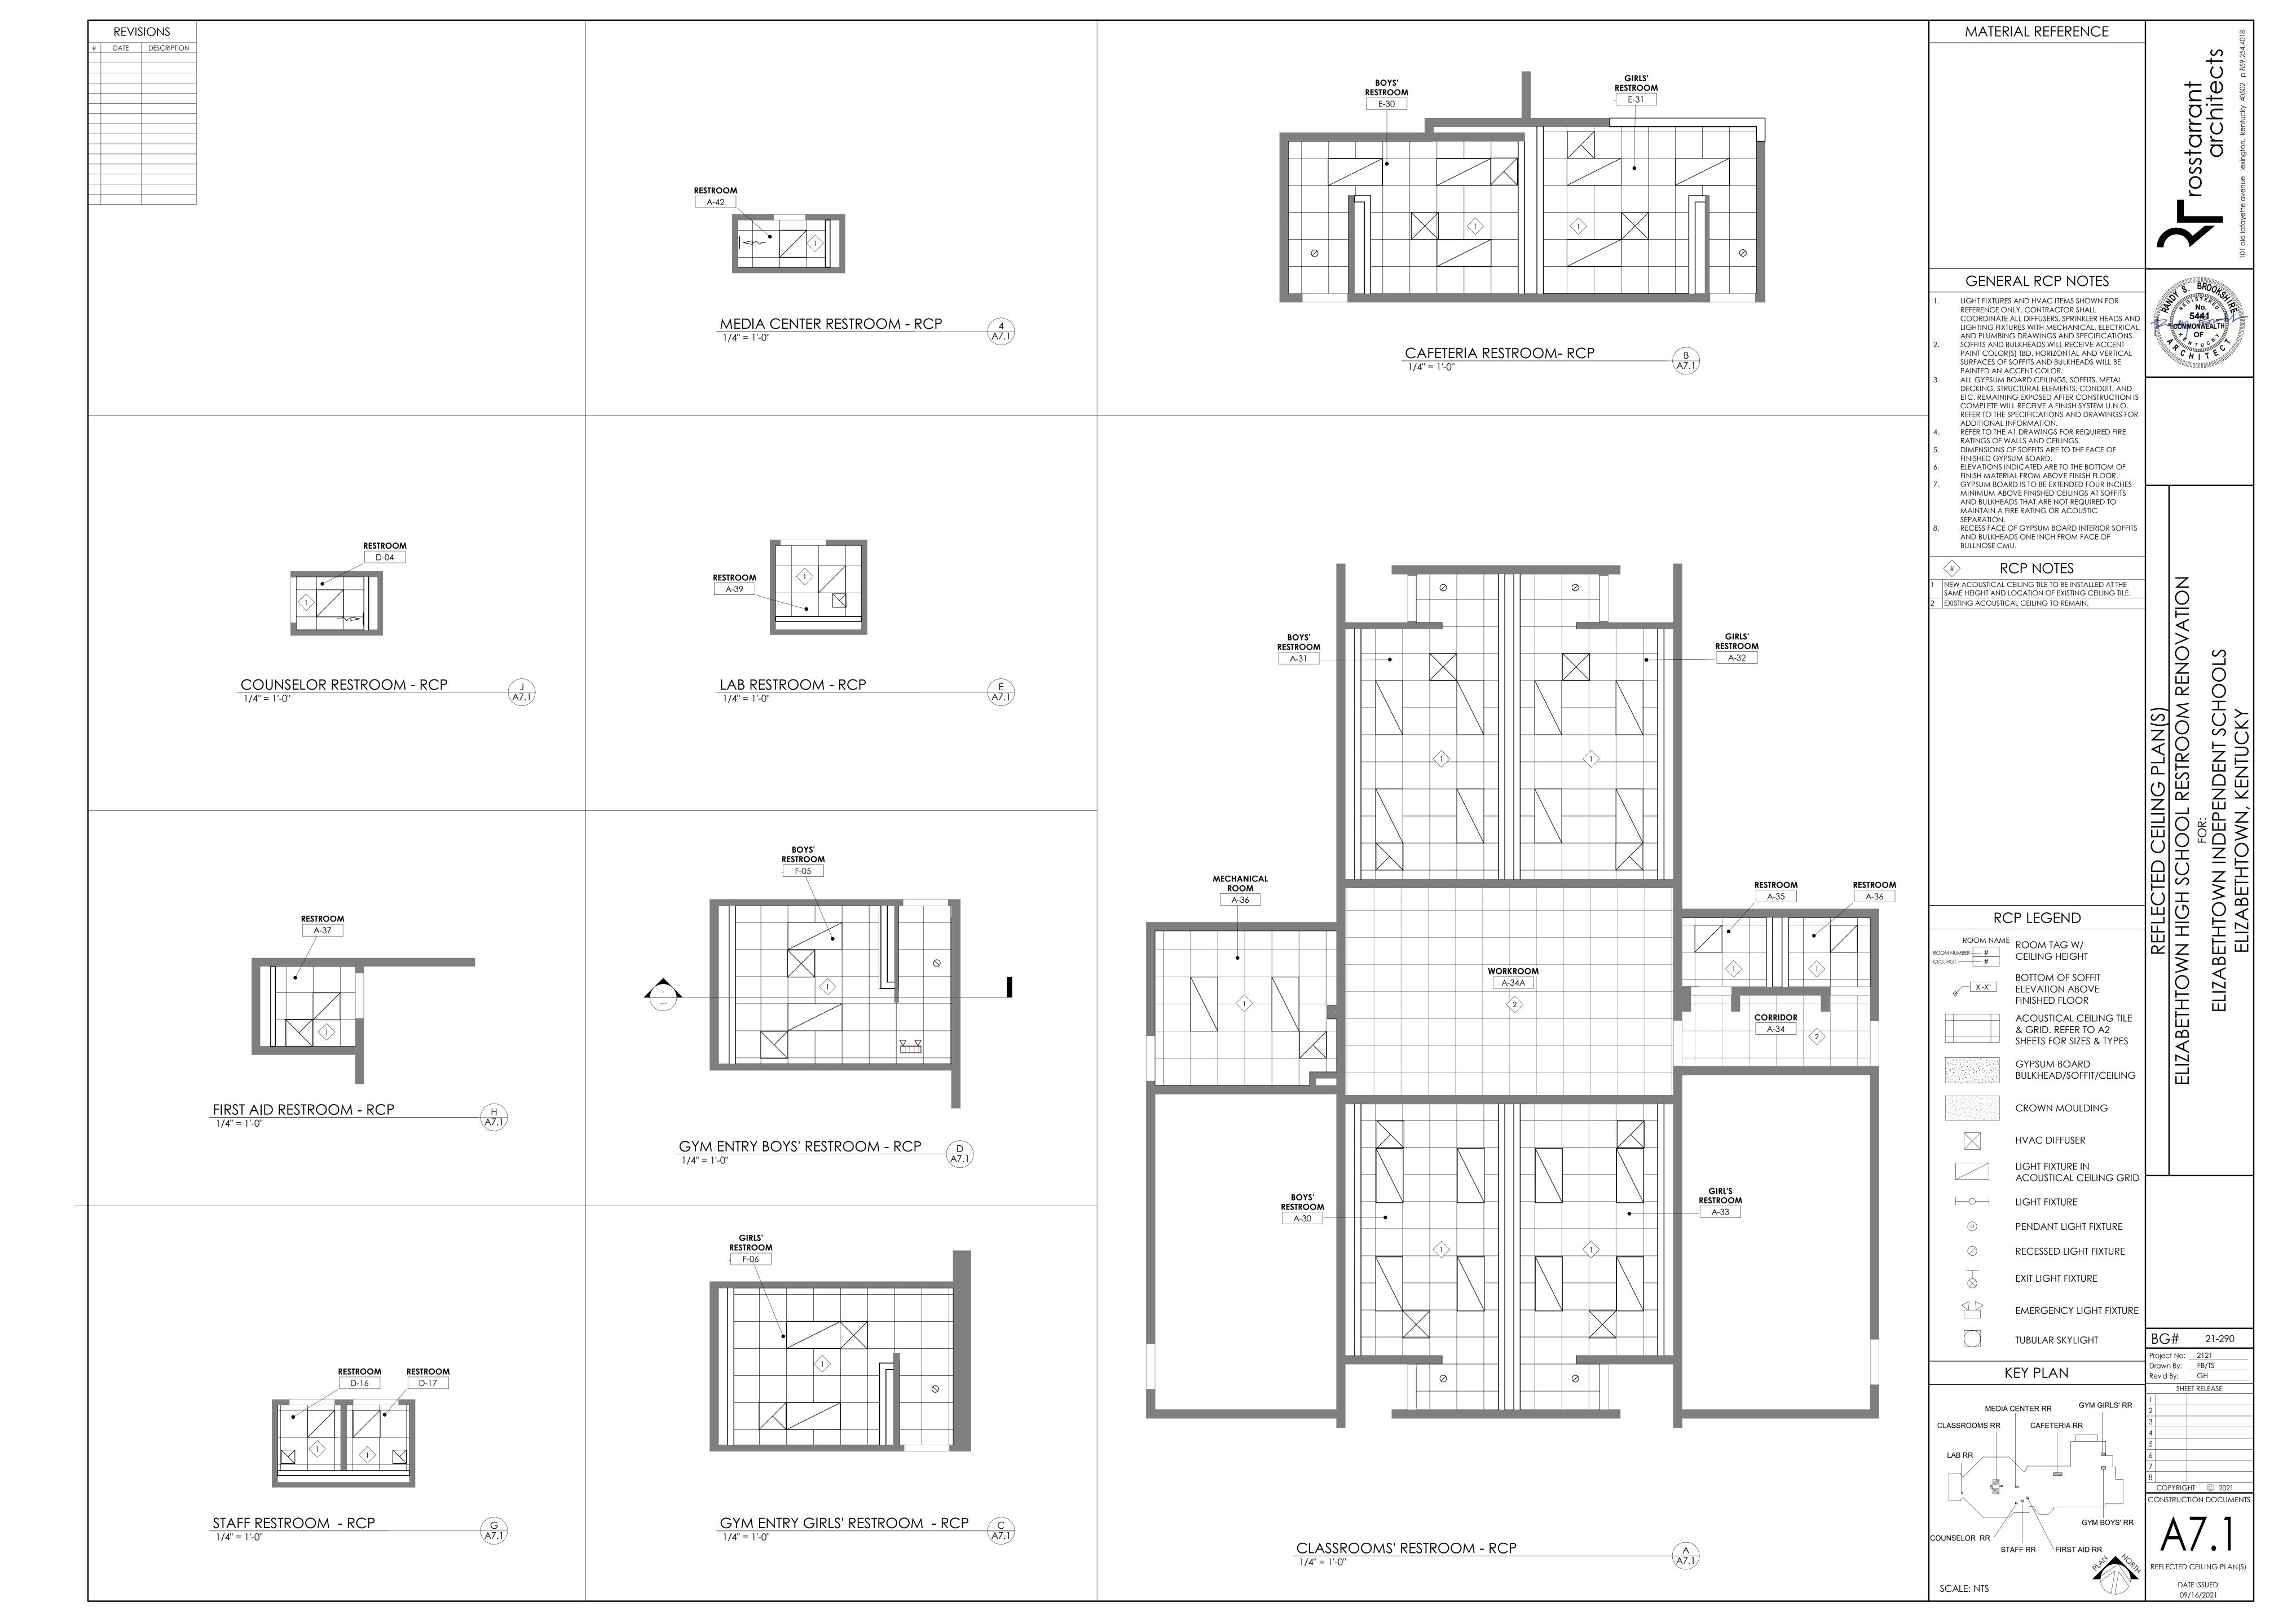
CONSTRUCTION DOCUMENT GENERAL ARCHITECTURAL DETAILS DATE ISSUED:

09/16/2021







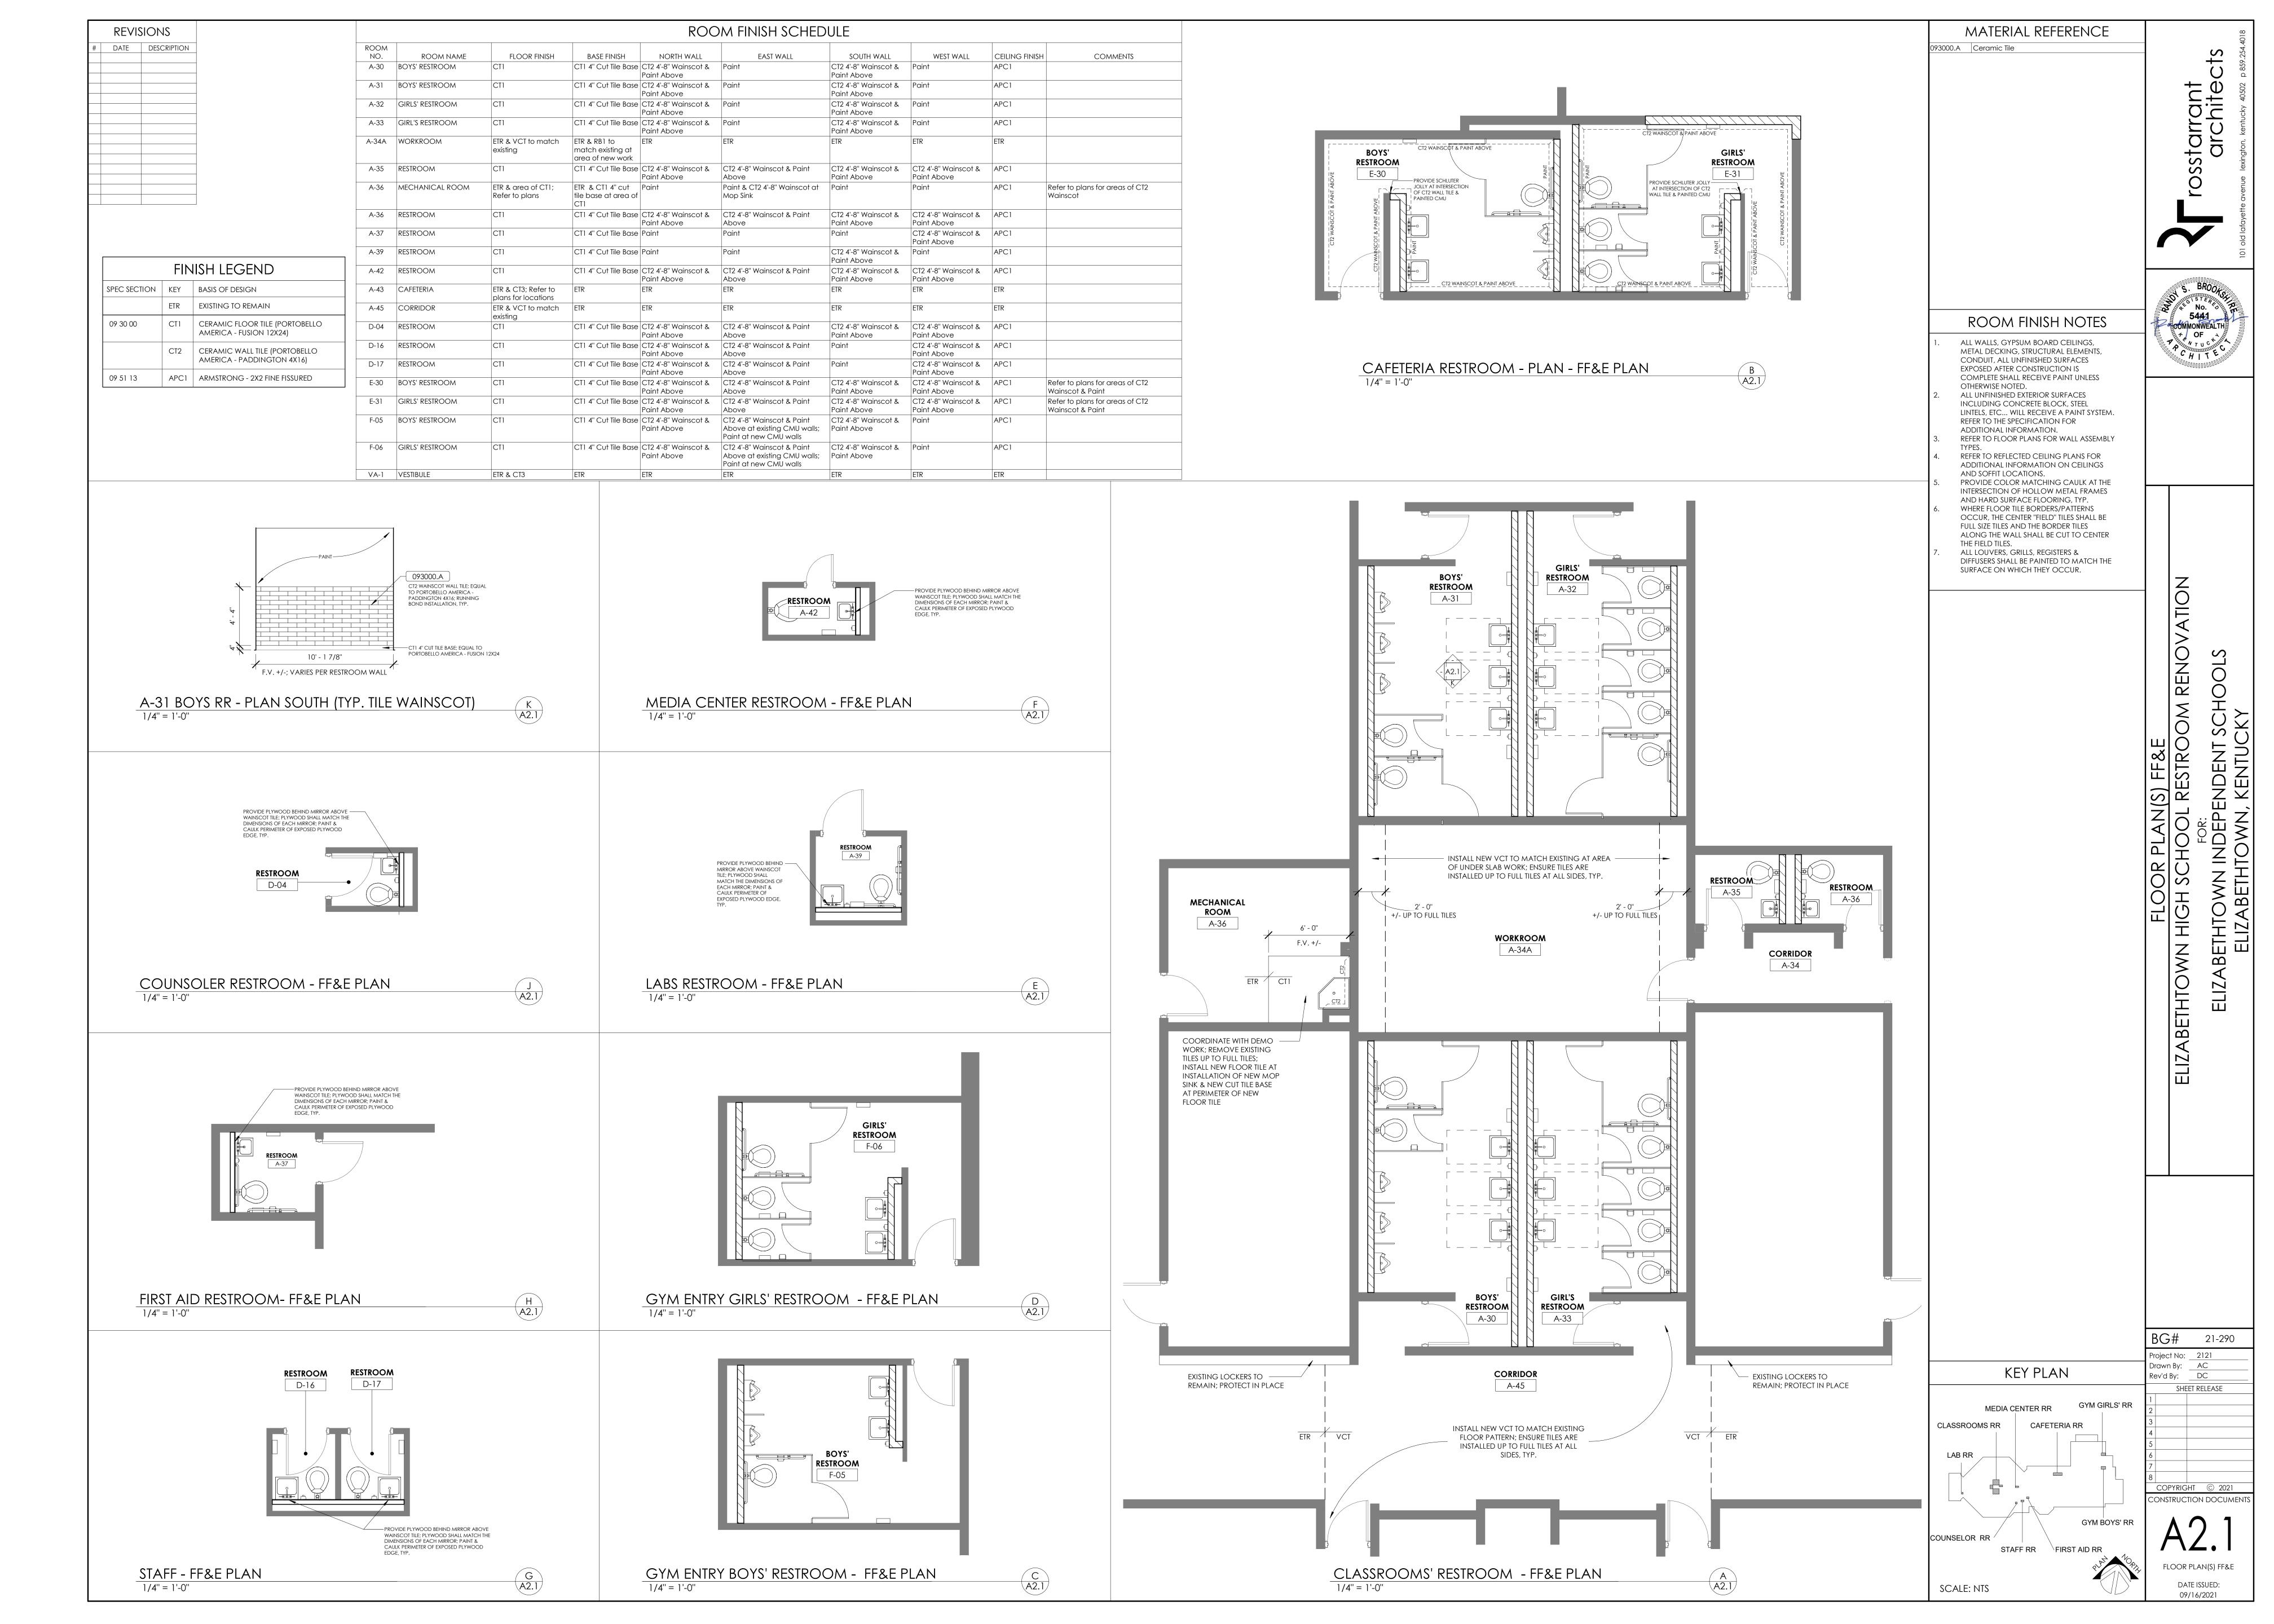

	REVISIONS						
#	DATE	DATE DESCRIPTION					
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-							

PLUMBING GENERAL NOTES A COORDINATE THE LOCATION OF DRAINS, THERMOSTATS, GAS OUTLETS, ETC., WITH ALL CASEWORK EQUIPMENT, MECHANICAL ROOM EQUIPMENT, ETC., PRIOR TO COMMENCING INSTALLATION. WORK NOT SO COORDINATED SHALL BE REMOVED AND PROPERLY INSTALLED AT THE EXPENSE OF THE CONTRACTOR.

ABBREVIATIONS

B THE CONTRACTOR SHALL EXERCISE EXTREME CARE IN THE COURSE OF THEIR WORK SO AS TO INSURE THAT THEY DO NOT INTERRUPT ANY EXISTING SERVICE. FOR SAFETY PURPOSES, PAY PARTICULAR ATTENTION TO THIS PRECAUTION RELATIVE TO NATURAL GAS AND ELECTRICAL LINES. VERIFY THE LOCATION, SIZE, TYPE, ETC., OF EACH UNDERGROUND OR OVERHEAD UTILITY. ALL WORK SHALL BE PERFORMED IN ACCORD WITH ALL FEDERAL, STATE AND/OR LOCAL RULES, REGULATIONS, STANDARD AND SAFETY REQUIREMENTS. UTILITIES SHALL BE INSTALLED IN ACCORD WITH THE APPLICABLE MUNICIPALITY OR UTILITY COMPANY STANDARDS. IN ALL CASES, THE MOST STRINGENT REQUIREMENT SHALL APPLY.

C WHERE WORK IS REQUIRED ABOVE EXISTING LAY-IN, PLASTER OR GYPSUM BOARD CEILINGS, THE CONTRACTOR SHALL BE RESPONSIBLE FOR REMOVAL AND REINSTALLATION (OR REPLACEMENT, IF DAMAGED) OF ALL CEILING OR TILE AND GRID MEMBERS NECESSARY TO PERFORM HIS WORK. NEW TILE AND GRID SHALL MATCH THE SURROUNDING AREAS. ALL PATCHING WORK SHALL MATCH ADJACENT SURFACES.

D ALL NEW WORK SHALL BE HUNG FROM STRUCTURE, NOT FROM THE WORK OF OTHER TRADES, WHETHER

EXISTING OR NEW. E COORDINATE ALL WORK WITH PROJECT PHASING REQUIREMENTS.

F PATCH, REPAIR AND PAINT OR PROVIDE WALL COVERING FOR (TO OWNER'S STANDARDS) EXISTING WALLS, CEILINGS, ETC., THAT ARE TO REMAIN IF DAMAGED DURING CONSTRUCTION, REPAIRS SHALL MATCH ADJACENT SURFACES TO THE SATISFACTION OF THE ARCHITECT AND OWNER.

G OBSERVE ALL APPLICABLE CODES, RULES AND REGULATIONS THAT MAY APPLY TO THE WORK UNDER THIS CONTRACT. (CITY, COUNTY, LOCAL, FEDERAL, MUNICIPALITY, UTILITY COMPANY, COMMONWEALTH OF KENTUCKY, ETC.)

H CONTRACTOR SHALL BE AWARE OF UNSEEN PLUMBING WORK DURING DEMOLITION. IF ITEMS ARE UNCOVERED DURING DEMOLITION THEN FIELD VERIFY THE USE OF THE ITEMS AND PLAN AN ALTERNATE ROUTE TO RUN THESE ITEMS. THEN CONTACT THE ENGINEERS TO REVIEW THE ROUTING. I ALL PENETRATIONS OF FIRE AND SMOKE RATED

CONTRACTOR SHALL PAY PARTICULAR ATTENTION TO INSULATED PIPING PENETRATIONS. J ALL WORK REQUIRING DOWNTIME OF ANY AREA IN THE BUILDING SHALL BE SCHEDULED 2 WEEKS IN

PER AN APPROVED U.L. LISTED STANDARD.

ASSEMBLIES SHALL BE APPROPRIATELY FIRE STOPPED

ADVANCE, AND SHALL COMPLY WITH INTERIM LIFE SAFETY MEASURES.

K ALL PIPING IN ROOMS WITH CEILINGS SHALL BE ABOVE CEILING EXCEPT AS NOTED. L IN ACCORDANCE WITH K.R.S. ALL PLUMBING WORK SHALL BE CONSTRUCTED IN COMPLIANCE WITH PLANS APPROVED BY AND BEARING THE APPROVAL STAMP OF THE KENTUCKY DIVISION OF PLUMBING AND/OR THE DIVISION OF WATER. THE CONTRACTOR SHALL NOT

BEGIN WORK UNTIL HE HAS RECEIVED SUCH

APPROVED PLANS. M LOCATIONS OF PIPING AND EQUIPMENT ARE APPROXIMATE AND SUBJECT TO MINOR ADJUSTMENTS IN THE FIELD. DO NOT SCALE THE DRAWINGS.

N ALL OFFSETS IN PIPING ARE NOT NECESSARILY SHOWN. PROVIDE ADDITIONAL OFFSETS WHERE NECESSARY.

O THE CONTRACTOR IS RESPONSIBLE FOR ALL UTILITY COMPANY FEES OR OTHER COSTS THAT ANY UTILITY COMPANY MAY REQUIRE TO COMPLETE THEIR WORK. (GAS, SEWER, WATER, ETC.).

P INSTALL ALL PIPING AND EQUIPMENT IN STRICT ACCORDANCE WITH MANUFACTURER'S INSTALLATION INSTRUCTION. IF IN CONFLICT WITH THE DESIGN INDICATED IN CONTRACT DOCUMENTS, ADVISE THE ENGINEERS PRIOR TO INSTALLATION FOR CLARIFICATION, PROVIDE RECOMMENDED ACCESS AND SERVICE CLEARANCES FOR ALL EQUIPMENT. Q SEAL AIRTIGHT AROUND ALL DUCTS AND PIPING

PENETRATIONS THROUGH WALLS, FLOORS AND ROOF. PROVIDE FIRE STOPPING IN FIRE PARTITION. R THE CONTRACTOR SHALL RELOCATE OR AVOID ANY

EXISTING EQUIPMENT APPURTENANCES, ETC., THAT CONFLICT WITH NEW WORK.

S WHERE MOUNTING HEIGHTS ARE NOT INDICATED OR ARE IN CONFLICT WITH ANY OTHER BUILDING SYSTEM, CONTACT THE ENGINEERS BEFORE INSTALLATION. REFER ALSO TO ARCHITECTURAL WALL INTERIOR AND EXTERIOR WALL ELEVATIONS, CEILING HEIGHTS AND OTHER DETAIL OF THESE

DOCUMENTS. T DEVIATIONS IN SIZE, CAPACITIES, FIT, FINISH, ETC. FOR EQUIPMENT FROM THAT USED AS BASIS OF DESIGN SHALL BE THE RESPONSIBILITY OF THE PURCHASER OF THAT EQUIPMENT. ANY PROVISIONS REQUIRED TO ACCOMMODATE A DEVIATION, WHETHER APPROVED BY THE ENGINEERS OR NOT, SHALL BE THE RESPONSIBILITY OF THE PURCHASER.

U VALVES, BALANCING DAMPERS OR ANY MECHANICAL/ELECTRICAL ITEM REQUIRING ACCESS SHALL NOT BE LOCATED ABOVE A HARD CEILING. IF THIS IS NOT POSSIBLE, THEN AN APPROPRIATELY SIZED ACCESS DOOR SHALL BE PLACED UNDER THE ITEM TO ALLOW EASY MAINTENANCE AND ADJUSTMENT. ADDITIONALLY ALL SUCH ITEMS SHALL NOT BE LOCATED AN UNREASONABLE DISTANCE ABOVE THE CEILINGS. IN GENERAL ALL SUCH ITEMS UNLESS INDICATED OTHERWISE SHALL BE MOUNTED SIX TO TWELVE INCHES ABOVE THE CEILING. IF IN

DOUBT, CONTACT ENGINEER PRIOR TO INSTALLING. V ALL MANHOLES, VAULTS AND SIMILAR UNDERGROUND STRUCTURES SHALL HAVE THE TOP ELEVATION SET FLUSH WITH FINISHED GRADE UNLESS SPECIFICALLY NOTED OTHERWISE.

W WORK IN CONFINED AREAS SHALL BE IN ACCORDANCE WITH THE OWNER'S SAFETY POLICY REQUIREMENTS.

DDICEATA	
AC	ALTERNATING CURRENT
ADJ	ADJUSTABLE
AFF	ABOVE FINISHED FLOOR
AFR	ABOVE FINISHED ROOF
AFUE	ANNUAL FUEL UTILIZATION EFFICIENCY
АНЈ	AUTHORITY HAVING JURISDICTION
AMP	AMPERE (AMP, AMPS)
ANSI	AMERICAN NATIONAL STANDARD INSTITUTE
APD	AIR PRESSURE DROP
ASHRAE	AMERICAN SOCIETY OF HEATING, REFRIGERATION, AND AIR-CONDITIONING ENGINEERS
	AIR CONDITIONING ENGINEERS
AVG	AVERAGE
BAS	BUILDING AUTOMATION SYSTEM
BHP	BREAK HORSEPOWER
BTU	BRITISH THERMAL UNIT
CAP	CAPACITY
CD	CONDENSATE DRAIN
CFM	CUBIC FEET PER MINUTE
C.I.	CAST IRON
CLG	CEILING
CLR	CLEAR
CO	CARBON MONOXIDE
COND	CONDENS (-ER, -ING, -ATION, -ATE)
CONT	CONTINU (-ED, -OUS)
CU FT	CUBIC FEET
CU IN	CUBIC INCHES
CV	VALVE FLOW COEFFICIENT
dB	DECIBEL
DB	DRY BULB
DC DC	DIRECT CURRENT
DD	DUCT SMOKE DETECTOR
DDC	DEGREE (-S)
DEG	DEGREE (-S)
DIA	DIAMETER (-S)
DNC	DDAWING
DWG	DRAWING
	ELECTRICAL CONTRACTOR
EC .	ELECTRICAL CONTRACTOR
ELEV	ELEVA (-TION, -TOR)
ENGR	ENGINEER
EQ	EQUAL CTATIC PRESSURE
ESP	EXTERNAL STATIC PRESSURE
ETR	EXISTING TO REMAIN
EVAP	EVAPORAT (-E, -ING, -ED, -OR, -ION)
EWT	ENTERING WATER TEMPERATURE
EXP	EXPANSION
EXT	EXTERIOR
	1

IDDILLATA	ITONS (CONTINUED)	ADDICETIA	TONS (CONTINUED)
		NO	NORMALLY OPEN OR NUMBER
FL	FLOOR	NTS	NOT TO SCALE
FLA	FULL LOAD AMPS	OC	ON CENTER
FOB	FLAT ON BOTTOM	OD	OUTSIDE DI (-AMETER, -MENSIO
FOT	FLAT ON TOP	CFCI	CONTRACTOR FURNISHED, CON
FPC	FIRE PROTECTION CONTRACTOR	OFCI	OWNER FURNISHED, CONTRACT
FPM	FEET PER MINUTE	OFOI	OWNER FURNISHED, OWNER IN
FPS	FEET PER SECOND	OR	OPEN RECEPTACLE
FT	FEET OR FOOT	OZ	OUNCE (-S)
FUT	FUTURE	PC	PLUMBING CONTRACTOR
FV	FACE VELOCITY	PD	PRESSURE DROP
GA	GAGE/GAUGE	PH	PHASE [ELECTRICAL]
GAL	GALLON (-S)	PLBG	PLUMBING
GC	GENERAL CONTRACTOR	PPM	PARTS PER MILLION
GPD	GALLONS PER DAY	PRS	PRESSURE REDUCING STATION
GPH	GALLONS PER HOUR	PRV	PRESSURE REDUCING VALVE (S
GPM	GALLONS PER MINUTE	PSF	POUNDS PER SQUARE FOOT
GR	GRAINS	PSI	POUNDS PER SQUARE INCH
Н	HUMIDITY	PSIG	PPSI GAUGE
HD	HEAD	RLA	RUNNING LOAD AMPS
HG	MERCURY	RPM	REVOLUTIONS PER MINUTE
HORIZ	HORIZONTAL	SQ	SQUARE
HP	H (-ORSEPOWER, -EAT PUMP)	SQ FT	SQUARE FEET OR FOOT
HR	HOUR (-S)	SQ IN	SQUARE INCH OR INCHES
HVAC	HEATING, VENTILATING, & AIR-CONDITIONING	TAB	TESTING AND BALANCING
Hz	HERTZ	TBD	TO BE DETERMINED
ID	I (-DENTIFICATION, -NSIDE DIAMETER, -NSIDE DIMENSION)	TE	TOP ELEVATION
IN	INCH (-ES)	TEMP	TEMPERATURE
INSUL	INSULAT (-ED, -ION)	TPA	TRAP PRIMER ADAPTER
INT	INTER (-IOR, -ERVAL)	TSP	TOTAL STATIC PRESSURE
IPS	IRON PIPE SIZE	ТҮР	TYPICAL
kW	KILOWATT	UNO	UNLESS NOTED OTHERWISE
kWh	KILOWATT HOUR	V	VOLT (-AGE, -S)
		VAR	VARI (-ABLE, -IES)
LBS	POUNDS	VAV	VARIABLE AIR VOLUME
LF	LINEAR FEET/FOOT	VEL	VELOCITY
LRA	LOCKED ROTOR AMPS	VFD	VARIABLE FEQUENCY DRIVE
LWT	LEAVING WATER TEMPERATURE	W	WATT (-AGE, -S)
MAX	MAXIMUM	WB	WET BULB
МВН	BTU PER HOUR [THOUSANDS]	WBT	WET BULB TEMPERATURE
MCA	MINIMUM CIRCUIT AMPS	WPD	WATER PRESSURE DROP
MFG	MANUFACTURER	WT	WEIGHT
MIN	MIN (-IMUM, -UTE)	W/	WITH
MISC	MISCELLANEOUS	W/O	WITHOUT
МОСР	MAXIMUM OVERCURRENT PROTECTION [AMPS]	<u></u> %	PERCENT
MTG	MOUNTING	ΔP	DIFFERENTIAL PRESSURE
N/A	NOT APPLICABLE	ΔΤ	TEMPERATURE DIFFERENCE
NC	NOISE CRITERIA OR NORMALLY CLOSED		CENTERLINE
NEBB	NATIONAL ENVIRONMENTAL BALANCING BUREAU		
	NOT THE CONTRACT		

ABBREVIATIONS (CONTINUED)

OC	ON CENTER
OD	OUTSIDE DI (-AMETER, -MENSION)
CFCI	CONTRACTOR FURNISHED, CONTRACTOR INSTALLED
OFCI	OWNER FURNISHED, CONTRACTOR INSTALLED
OFOI	OWNER FURNISHED, OWNER INSTALLED
OR	OPEN RECEPTACLE
OZ	OUNCE (-S)
PC	PLUMBING CONTRACTOR
PD	PRESSURE DROP
PH	PHASE [ELECTRICAL]
PLBG	PLUMBING
PPM	PARTS PER MILLION
PRS	PRESSURE REDUCING STATION
PRV	PRESSURE REDUCING VALVE (STEAM, WATER, GAS)
PSF	POUNDS PER SQUARE FOOT
PSI	POUNDS PER SQUARE INCH
PSIG	PPSI GAUGE
RLA	RUNNING LOAD AMPS
RPM	REVOLUTIONS PER MINUTE
SQ	SQUARE
SQ FT	SQUARE FEET OR FOOT
SQ IN	SQUARE INCH OR INCHES
TAB	TESTING AND BALANCING
TBD	TO BE DETERMINED
TE	TOP ELEVATION
TEMP	TEMPERATURE
TPA	TRAP PRIMER ADAPTER
TSP	TOTAL STATIC PRESSURE
TYP	TYPICAL
UNO	UNLESS NOTED OTHERWISE
V	VOLT (-AGE, -S)
VAR	VARI (-ABLE, -IES)
VAV	VARIABLE AIR VOLUME
VEL	VELOCITY
VFD	VARIABLE FEQUENCY DRIVE
W	WATT (-AGE, -S)
WB	WET BULB
WBT	WET BULB TEMPERATURE
WPD	WATER PRESSURE DROP
WT	WEIGHT
	WITH
W/O	WITHOUT
%	PERCENT
ΔΡ	DIFFERENTIAL PRESSURE
ΔΤ	TEMPERATURE DIFFERENCE

ABBREVIATIONS (CONTINUED)

GENERAL	SYMBOLS
(#)	TAGGED NOTE DESIGNATOR
\triangle	REVISION TRIANGLE
	ROOM TAG
TAG XXX-# INSTANCE XXXX	EQUIPMENT TAG
XXX ##	DOMESTIC WATER RISER TAG
XXX ##	SANITARY, WASTE, & VENT RISER TAG
XXX ##	FIRE SUPPRESSION RISER TAG
•	POINT OF CONNECTION / CONNECT TO EXISTING
♦	POINT OF DEMOLITION
D(XXX)	PIPING TO BE DEMOLISHED - (XXX) DENOTES SYSTEM
—E(XXX)—	EXISTING PIPING - (XXX) DENOTES SYSTEM
—A(XXX)—	ABANDONED IN PLACE PIPING - (XXX) DENOTES SYST
VAI VE SVI	MBOL LEGEND
—K—	TWO-WAY CONTROL VALVE
	THREE-WAY CONTROL VALVE
φ	AUTOMATIC AIR VENT (AAV)
<u></u>	MANUAL AIR VENT (MAV)

AUTO-FLOW CONTROL VALVE

DOUBLE CHECK VALVE ASSEMBLY

CHECK VALVE

—DHR(#°F)— PLUMBING SYMBOL LEGEND FLEXIBLE PIPE CONNECTION FLOW METER (VENTURI) ——||—— | PIPING UNION MANUAL BALANCING VALVE (BV) FLOW SWITCH ——Ō—— |BALL VALVE ____Ps PRESSURE SWTICH — BUTTERFLY VALVE ______Ттѕ TAMPER SWITCH TRIPLE DUTY VALVE (TDV) THERMOMETER _____T____ PETE'S PLUG; TEMPERATURE/PRESSURE PORT MANUAL ISOLATION VALVE ─────── | GLOBE VALVE OS&Y (GATE) VALVE PRESSURE REDUCING VALVE (STEAM, GAS, WATER, ETC.)

PLUMBING PIPING LEGEND

----⊃

— – DCM – –

-DHW(#°F)-

——AVT—— ACID VENT

——AW—— ACID WASTE

——CA—— COMPRESSED AIR

——DHW—— DOMESTIC HOT WATER (DHW)

—O PIPE ELBOW TURNING UP

——O—— PIPE TEE; CONNECTION ON TOP

PIPE TEE; CONNECTION ON BOTTOM

PIPE ELBOW TURNING DOWN

DOMESTIC COLD WATER (DCW)

— -DHR- — RECIRCULATED DOMESTIC HOT WATER (DHR)

APPLICABLE BUILDING CODES	DOCUMENT	YEAR
ACCESSIBLE AND USEABLE BUILDINGS AND FACILITIES	ANSI A117.1	2009
FIRE SPRINKLER CODE	NFPA 13	2013
INTERNATIONAL BUILDING CODE (IBC)	STATE EDITION	2015
INTERNATIONAL ENERGY CONSERVATION CODE (IECC) OR ASHRAE 90.1	STATE EDITION	2012
INTERNATIONAL FIRE CODE (IFC)	STATE EDITION	2015
INTERNATIONAL FUEL GAS CODE (IFGC)	STATE EDITION	2015
INTERNATIONAL MECHANICAL CODE (IMC)	STATE EDITION	2015
INTERNATIONAL PLUMBING CODE (IPC)	STATE EDITION	2015
INTERNATIONAL EXISTING BUILDING CODE (IEBC)	STATE EDITION	2009
NATIONAL ELECTRIC CODE (NEC)	NFPA 70	2017
NATIONAL FIRE ALARM & SIGNALING CODE	NFPA 72	2013
UNIFORM STATEWIDE BUILDING CODE	KBC	2018

APPLICABLE BUILDING CODES

Sheet List - Plumbing			
SHEET #	SHEET NAME		
P1.0	PLUMBING LEGEND		
P2.1	ENLARGED PLANS - PLUMBING DEMOLITION		
P2.2	ENLARGED PLANS - PLUMBING DEMOLITION		
P3.1	ENLARGED PLANS - PLUMBING		
P3.2	ENLARGED PLANS - PLUMBING		
P4.0	MECHANICAL DETAILS		
P5.0	PLUMBING RISERS		
P5.1	PLUMBING RISERS		
P5.2	PLUMBING RISERS		

PLUMBING PHASING NOTES

A THIS PROJECT INTERFACES EXTENSIVELY WITH EXISTING BUILDING SERVICES. IT SHALL BE THE CONTRACTOR'S RESPONSIBILITY TO COORDINATE AND PHASE ALL TIE-INS AND INTERRUPTIONS OF EXISTING SERVICES TO MINIMIZE OR ELIMINATE DOWNTIME. AS AN EXAMPLE, MAIN GAS SERVICE, WATER SERVICE, ELECTRICAL SERVICE, HVAC SERVICES, STEAM GENERATION, ETC., WILL BE AFFECTED AND REPLACED OR MOVED DURING THIS PROJECT. THE CONTRACTOR SHALL INSTALL ALL NEW SERVICES AND EQUIPMENT AND HAVE THEM TESTED AND FULLY AND RELIABLY FUNCTIONAL PRIOR TO INTERRUPTING, RELOCATING OR REMOVING ANY EXISTING SERVICES. IT SHALL BE THE CONTRACTOR'S RESPONSIBILITY TO BARE ANY AND ALL COSTS ASSOCIATED WITH THIS PHASING, INCLUDING TEMPORARY SERVICES, TEMPORARY RELOCATION, PREMIUM TIME WORK, ETC. CONTRACTOR SHALL COORDINATE ALL SAID WORK WITH THE OWNER AND APPLICABLE UTILITIES PER THE CONTRACT DOCUMENTS.

PLUMBING DEMOLITION NOTES

REQUIREMENTS.

CEILING GRID.

A THE CONTRACTOR SHALL REFER TO THE ARCHITECTURAL PLANS FOR AREAS IN WHICH THE CEILING IS REMAINING. THE CONTRACTOR IS RESPONSIBLE FOR REMOVING THE EXISTING CEILING AS REQUIRED AND REINSTALLATION. TEMPORARILY SUPPORT LIGHTS, DIFFUSERS, CEILING ETC. REPLACE BROKEN CEILING TILES WITH NEW AT NO ADDITIONAL COST TO OWNER. FIELED VERIFY EXACT

B ALL WALLS AND FLOOR SLABS SHALL BE REPAIRED TO MATCH EXISTING AND TO A LIKE NEW CONDITION. ALL RATED WALLS AND FLOOR SLABS SHALL BE PATCHED AND REPAIRED TO MAINTAIN RATING.

C ALL EXISTING BUILDING FINISHES SHALL BE PROTECTED DURING THE DEMOLITION PHASE.

D HEAVY DASHED LINES INDICATE ITEMS FOR REMOVAL (UON) AND LIGHT SOLID LINES INDICATE EXISTING ITEMS TO REMAIN. E COORDINATE DISPOSAL OF ALL FIXTURES, DEVICES,

ETC. (INDICATED FOR DEMOLITION) WITH THE OWNER. F ALL OUTAGES SHALL BE SCHEDULED THROUGH THE ELIZABETHTOWN INDEPENDENT FACILITY DIRECTOR FOR PROPER COORDINATION. A REQUEST FOR AN OUTAGE SHALL BE SUBMITTED IN WRITING A MINIMUM OF TWO WEEKS IN ADVANCE.

G ALL DUCTWORK, PIPING, CONDUIT, ETC. SHALL BE INSTALLED A MINIMUM OF 4" ABOVE THE TOP OF THE

PLUMBING HAZARDOUS MATERIALS NOTES

A THE CONTRACTOR IT IS HEREBY ADVISED THAT IS POSSIBLE THAT ASBESTOS AND/OR OTHER HAZARDOUS MATERIALS ARE OR WERE PRESENT IN THIS BUILDING(S). ANY WORKER, OCCUPANT, VISITOR, ETC., WHO ENCOUNTERS ANY MATERIAL OF WHOSE CONTENT THEY ARE NOT CERTAIN SHALL PROMPTLY REPORT THE EXISTENCE AND LOCATION OF THAT MATERIAL TO THE OWNER. FURTHERMORE, THE CONTRACTOR SHALL INSURE THAT NO ONE COMES NEAR TO OR IN CONTACT WITH ANY SUCH MATERIAL OR FUMES THEREFROM UNTIL ITS CONTENT CAN BE

NIC

NOT IN CONTRACT

ASCERTAINED TO BE NON-HAZARDOUS. B CMTA, INC. HAS NO EXPERTISE IN THE DETERMINATION OF THE PRESENCE OF ANY HAZARDOUS MATERIAL. THEREFORE, NO ATTEMPT HAS BEEN MADE BY CMTA TO IDENTIFY THE EXISTENCE OR LOCATION OF ANY SUCH HAZARDOUS MATERIAL. FURTHERMORE, CMTA NOR ANY AFFILIATE HEREOF WILL NOT OFFER OR MAKE ANY RECOMMENDATIONS RELATIVE TO THE

REMOVAL, HANDLING OR DISPOSAL OF SUCH MATERIAL. C IF THE WORK WHICH IS TO BE PERFORMED INTERFACES, CONNECTS OR RELATES IN ANY PHYSICAL WAY WITH OR TO EXISTING COMPONENTS WHICH CONTAIN OR BEAR ANY HAZARDOUS MATERIAL, ASBESTOS BEING ONE, THEN IT SHALL BE THE CONTRACTOR'S SOLE RESPONSIBILITY TO CONTACT THE

OWNER AND SO ADVISE HIM IMMEDIATELY. D THE CONTRACTOR BY EXECUTION OF THE CONTRACT FOR ANY WORK AND/OR BY THE ACCOMPLISHMENT OF ANY WORK THEREBY AGREE TO BRING NO CLAIM RELATIVE TO HAZARDOUS MATERIALS FOR NEGLIGENCE. BREACH OF CONTRACT, INDEMNITY, OR ANY OTHER SUCH ITEM AGAINST CMTA, ITS PRINCIPALS, EMPLOYEES, AGENTS OR CONSULTANTS. ALSO, THE CONTRACTOR FURTHER AGREES TO DEFEND, INDEMNIFY AND HOLD CMTA, ITS PRINCIPALS, EMPLOYEES, AGENTS AND CONSULTANTS HARMLESS FROM ANY SUCH RELATED CLAIMS WHICH MAY BE BROUGHT BY ANY SUBCONTRACTORS, SUPPLIERS OR ANY OTHER THIRD PARTIES.

E THE CONTRACTOR IS DIRECTED TO THE SPECIFICATIONS FOR FURTHER INFORMATION.

	PLUMBING FIXTURE SCHEDULE						
TAG	DESCRIPTION	CW	HW	VENT ,	WASTE/DRAIN	VOLTAGE	EXTERNAL CHECK VALVE
FD-1	FLOOR DRAIN - 6" DIA. : ZURN, ZN-415 OR EQUAL FLOOR DRAIN WITH 6" DIAMETER TOP, TYPE "B" NICKEL BRONZE STRAINER, 4" DRAIN OUTLET AND TRAP PRIMER CONNECTION.	-	-	2"	4"	Yes	Yes
НВ	HOSE BIBB: ZURN MODEL Z1350 OR EQUAL ENCASED MODERATE CLIMATE WALL HYDRANT FOR NARROW WALL INSTALLATION. WITH ALL BRONZE BODY, ALL BRONZE INTERIOR PARTS, REPLACEABLE SEAT WASHER, LOOSE KEY OPERATED CONTROL VALVE, VACUUM BREAKER AND 3/4" MALE HOSE CONNECTION. ADJUSTABLE STAINLESS STEEL BOX FURNISHED WITH HINGED COVER CYLINDER LOCK AND "WATER" STAMPED ON THE COVER. MOUNTED WITH HOSE CONNECTION AT 18" ABOVE FINISHED FLOOR ELEVATION OF AREA SERVED.	1/2"	-	-	-	Yes	Yes
P-1	WATER CLOSET - FLOOR MOUNTED - MANUAL FLUSH VALVE : VITREOUS CHINA, 15" HIGH ELONGATED BOWL, SIPHON JET, 11/2" TOP SPUD INLET, CHINA BOLT CAPS AND WHITE OPEN FRONT PLASTIC SEAT WITH SELF-SUSTAINING CHECK HINGES. PROVIDE WITH MANUAL 1.6 GPF FLUSH VALVE.	1-1/2"	-	2"	4"	Yes	Yes
P-1A	WATER CLOSET - FLOOR MOUNTED - MANUAL FLUSH VALVE - ADA COMPLIANT : VITREOUS CHINA, 18" HIGH ELONGATED BOWL, SIPHON JET, 11/2" TOP SPUD INLET, CHINA BOLT CAPS AND WHITE OPEN FRONT PLASTIC SEAT WITH SELF-SUSTAINING CHECK HINGES. PROVIDE MANUAL 1.6 GPF FLUSH VALVE WITH HANDLE AT A MAXIMUM OF 31" AFF.	1-1/2"	-	2"	4"	Yes	Yes
P-2	URINAL: VITREOUS CHINA SIPHON JET URINAL WITH 3/4' TOP SPUD INLET, 2" I.P.S. OUTLET AND 1.0 GPF MANUAL FLUSH VALVE. MOUNT WITH LIP OF URINAL AT 24" ABOVE FINISHED FLOOR. PROVIDE FLOOR MOUNTED WALL CARRIER.	3/4"	-	2"	2"	Yes	Yes
P-2A	URINAL - ADA COMPLIANT : VITREOUS CHINA SIPHON JET URINAL WITH 3/4' TOP SPUD INLET, 2" I.P.S. OUTLET AND 1.0 GPF MANUAL FLUSH VALVE. MOUNT WITH LIP OF URINAL AT 16" ABOVE FINISHED FLOOR. CONTROLS SHALL BE A MAXIMUM OF 39" ABOVE FINISHED FLOOR. PROVIDE FLOOR MOUNTED WALL CARRIER.	3/4"	-	2"	2"	Yes	Yes
P-3	LAVATORY - WALL HUNG W/ SINGLE LEVER FAUCET - ADA COMPLIANT: VITREOUS CHINA, 20"X18" WALL HUNG LAVATORY WITH 4" FAUCET CENTERS, CONCEALED ARMS AND 4" HIGH BACKSPLASH. PROVIDE WITH A 0.5 GPM SINGLE LEVER FAUCET, CHROME PLATED 3/8" SUPPLIES WITH STOPS, GRID DRAIN, A KENTUCKY CODE P-TRAP, TAILPIECE AND ESCUTCHEONS. MOUNT LAVATORY AT A HEIGHT LEAVING A CLEARANCE OF AT LEAST 29" FROM THE FLOOR TO THE APRON AND THE RIM AT A MAXIMUM OF 34" AFF. PROVIDE ON THE EXPOSED WASTE PIPE AND WATER SUPPLY LINES A TRAP-WRAP INSULATION KIT WITH A VINYL AND PLASTIC COVERING.	1/2"	1/2"	2"	2"	Yes	Yes
P-4	MOP BASIN : 24"X24"X10" HIGH TERRAZZO MOP SERVICE BASIN, NEO-CORNER STYLE IN WHITE DRIFT COLOR, 3" DRAIN, SERVICE FAUCET, HOSE AND HOSE BRACKET, VINYL BUMPERGUARD AND STAINLESS STEEL WALL GUARDS. THE DRAIN SHALL BE LOCATED 12" TO THE CENTER. PROVIDE A CHECK VALVE IN THE HOT AND COLD WATER SUPPLIES.	3/4"	3/4"	2"	3"	Yes	Yes

REGISTERS, GRILLES, AND DIFFUSERS												
MARK	MANUFACTURER	MODEL#	TYPE	GRILLE SIZE	PANEL SIZE	DUCT INLET SIZE	DUCT BRANCH SIZE	CFM	P.D.	NOISE CRITERIA	THROW PATTERN	REMARKS
E-1	TITUS	45F	ALUMINUM 1/2" EGG CRATE	12x12	12x12	8x8	6"	0-100	0.02	20	-	
E-2	TITUS	45F	ALUMINUM 1/2" EGG CRATE	24x24	24x24	20x20	10"	0-400	0.05	20	-	
E-3	TITUS	350FL	FIXED ALUMINUM SIDEWALL GRILLE	8x6	8x6	8x6	8x6	0-200	0.05	20	-	
S-1	TITUS	TDCA-AA SERIES	ALUMINUM ADJUSTABLE SQUARE DIFFUSER	15x15	24x24	9x9	8"	101-225	0.05	25	4-WAY	

 $D \stackrel{\sim}{\succ}$ S S

> NOT FOR CONSTRUCTION





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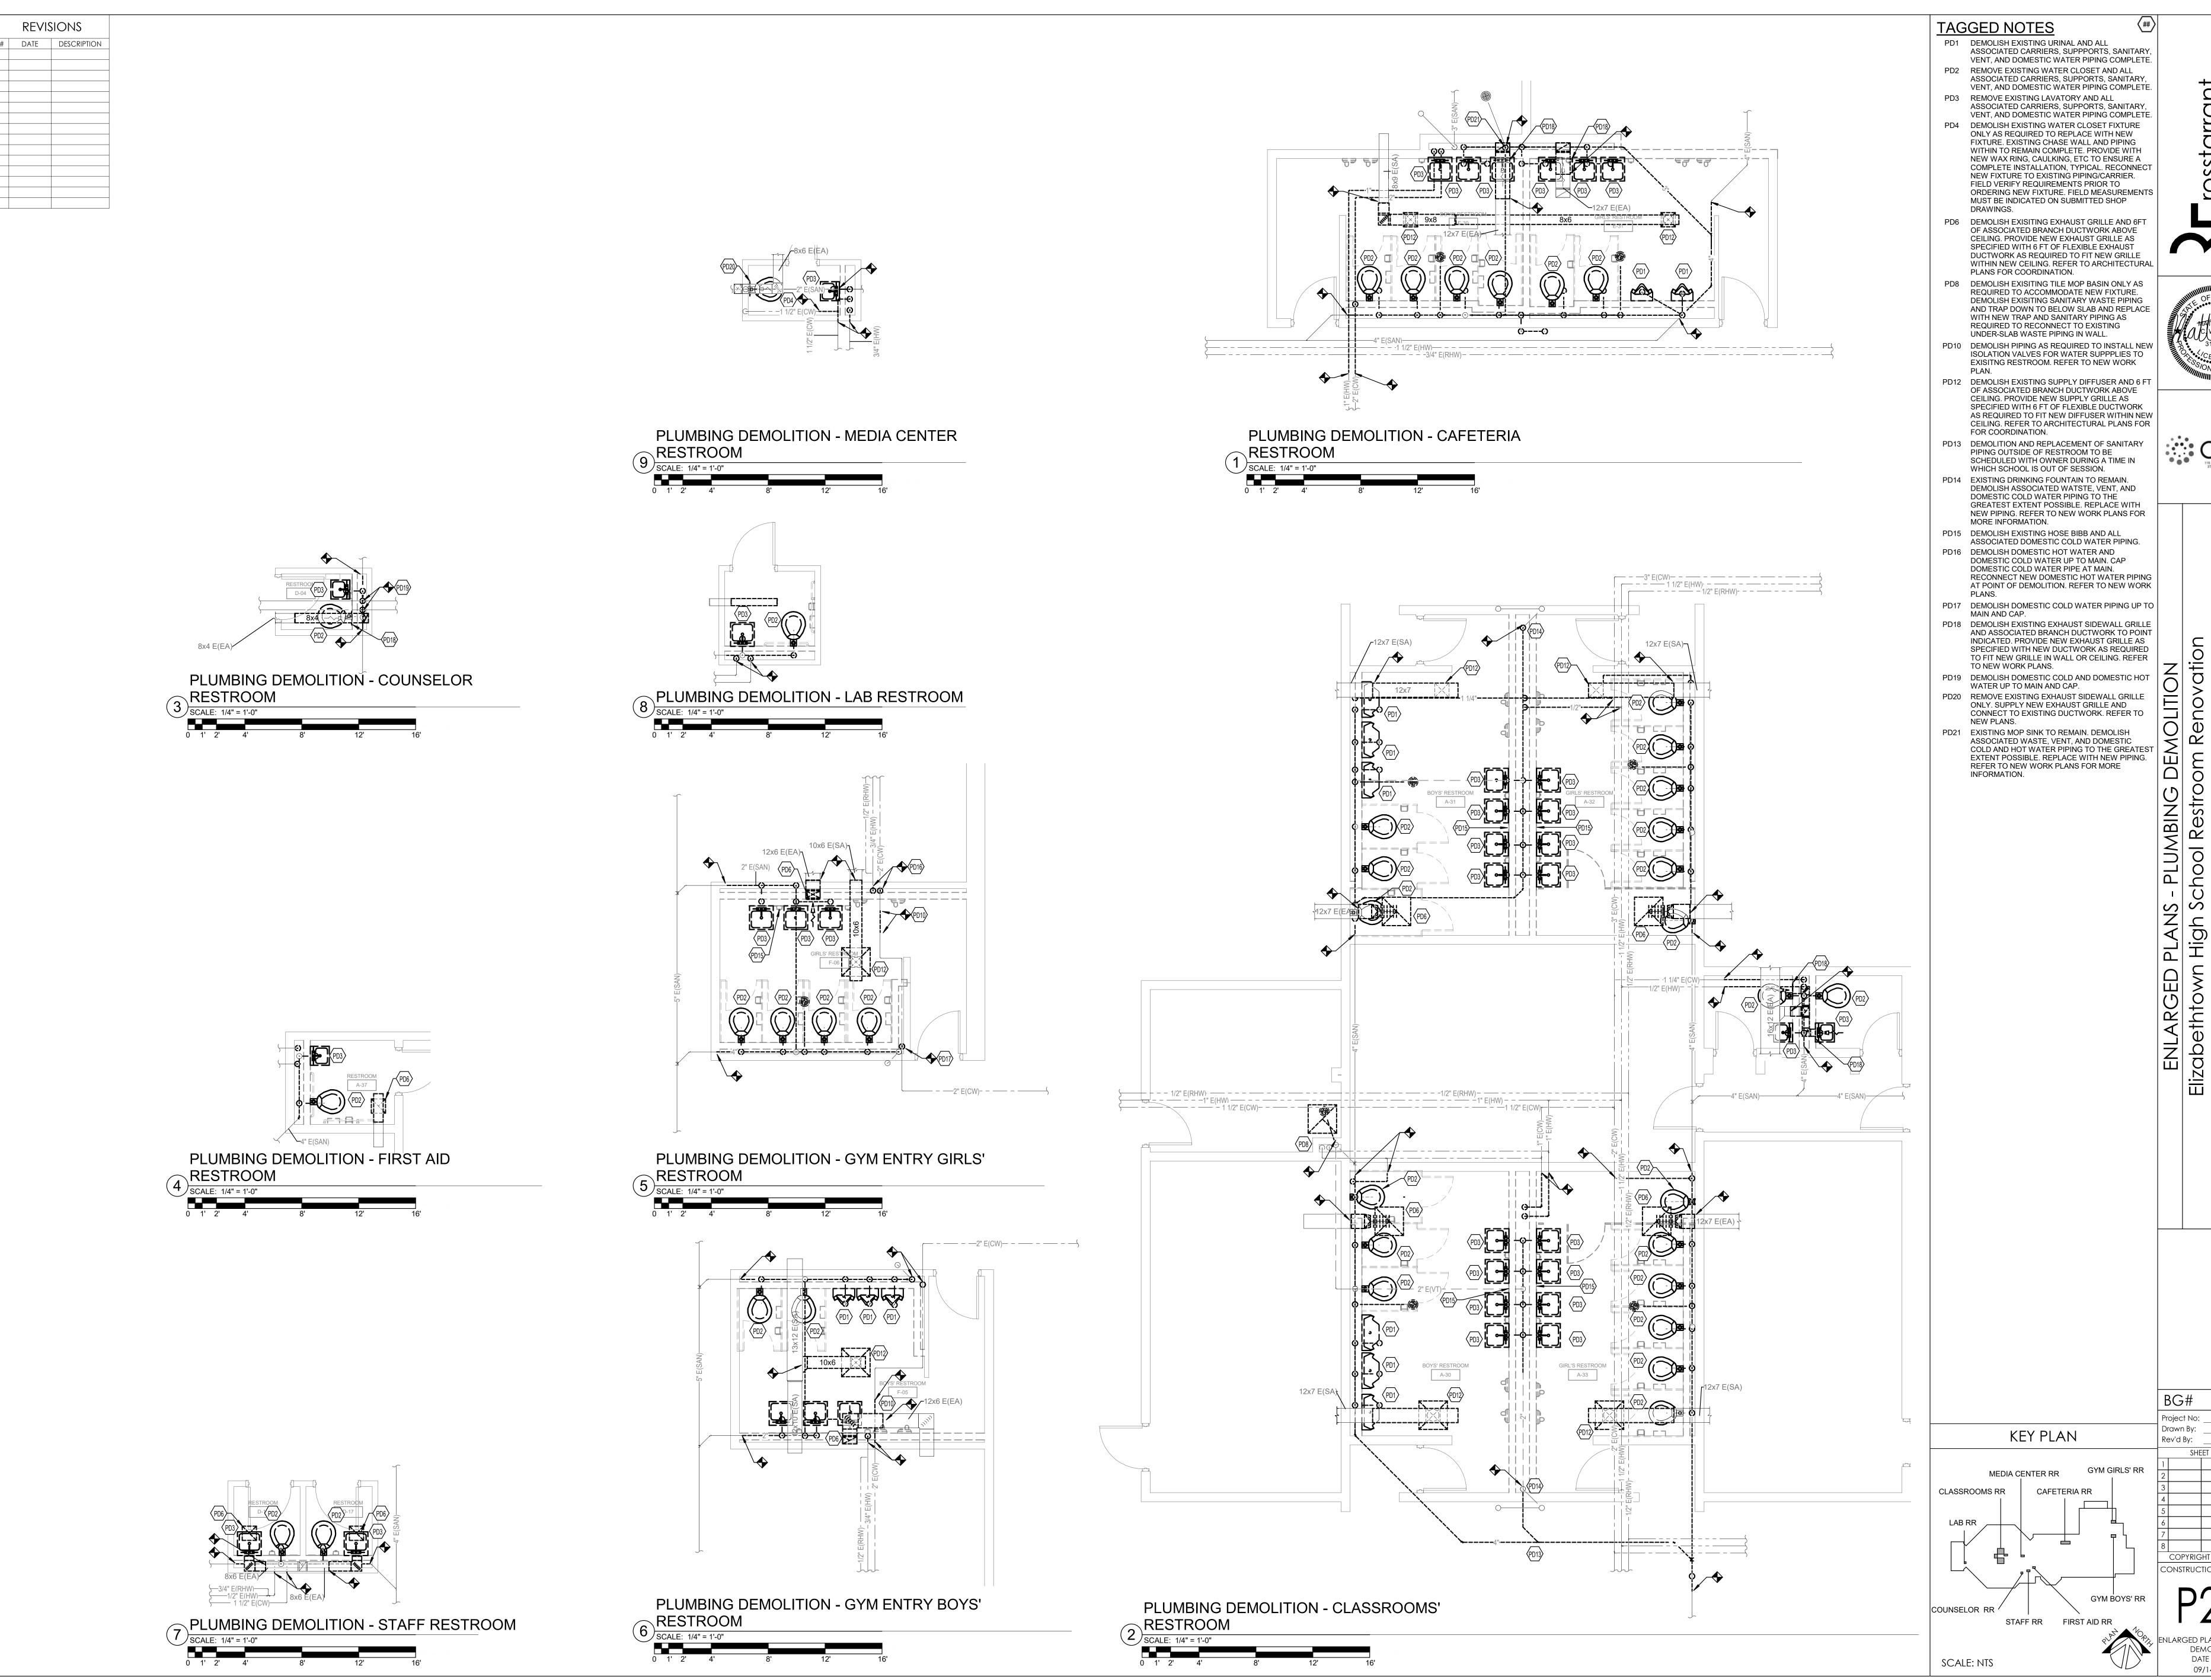
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21-290 Drawn By: WDT Rev'd By: MCW

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PLUMBING LEGEND DATE ISSUED:

09/14/2021



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AND ASSOCIATED BRANCH DUCTWORK TO POINT INDICATED. PROVIDE NEW EXHAUST GRILLE AS SPECIFIED WITH NEW DUCTWORK AS REQUIRED

ELIZABETHTOWN INDEPENDENT Elizabethtown, Kentuc

21-290
 Project No:
 2121/XETR21


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SED PLANS - PLUMBING

DEMOLITION DATE ISSUED: 09/14/2021



5" E(SAN)—

DEMOLITION PLAN

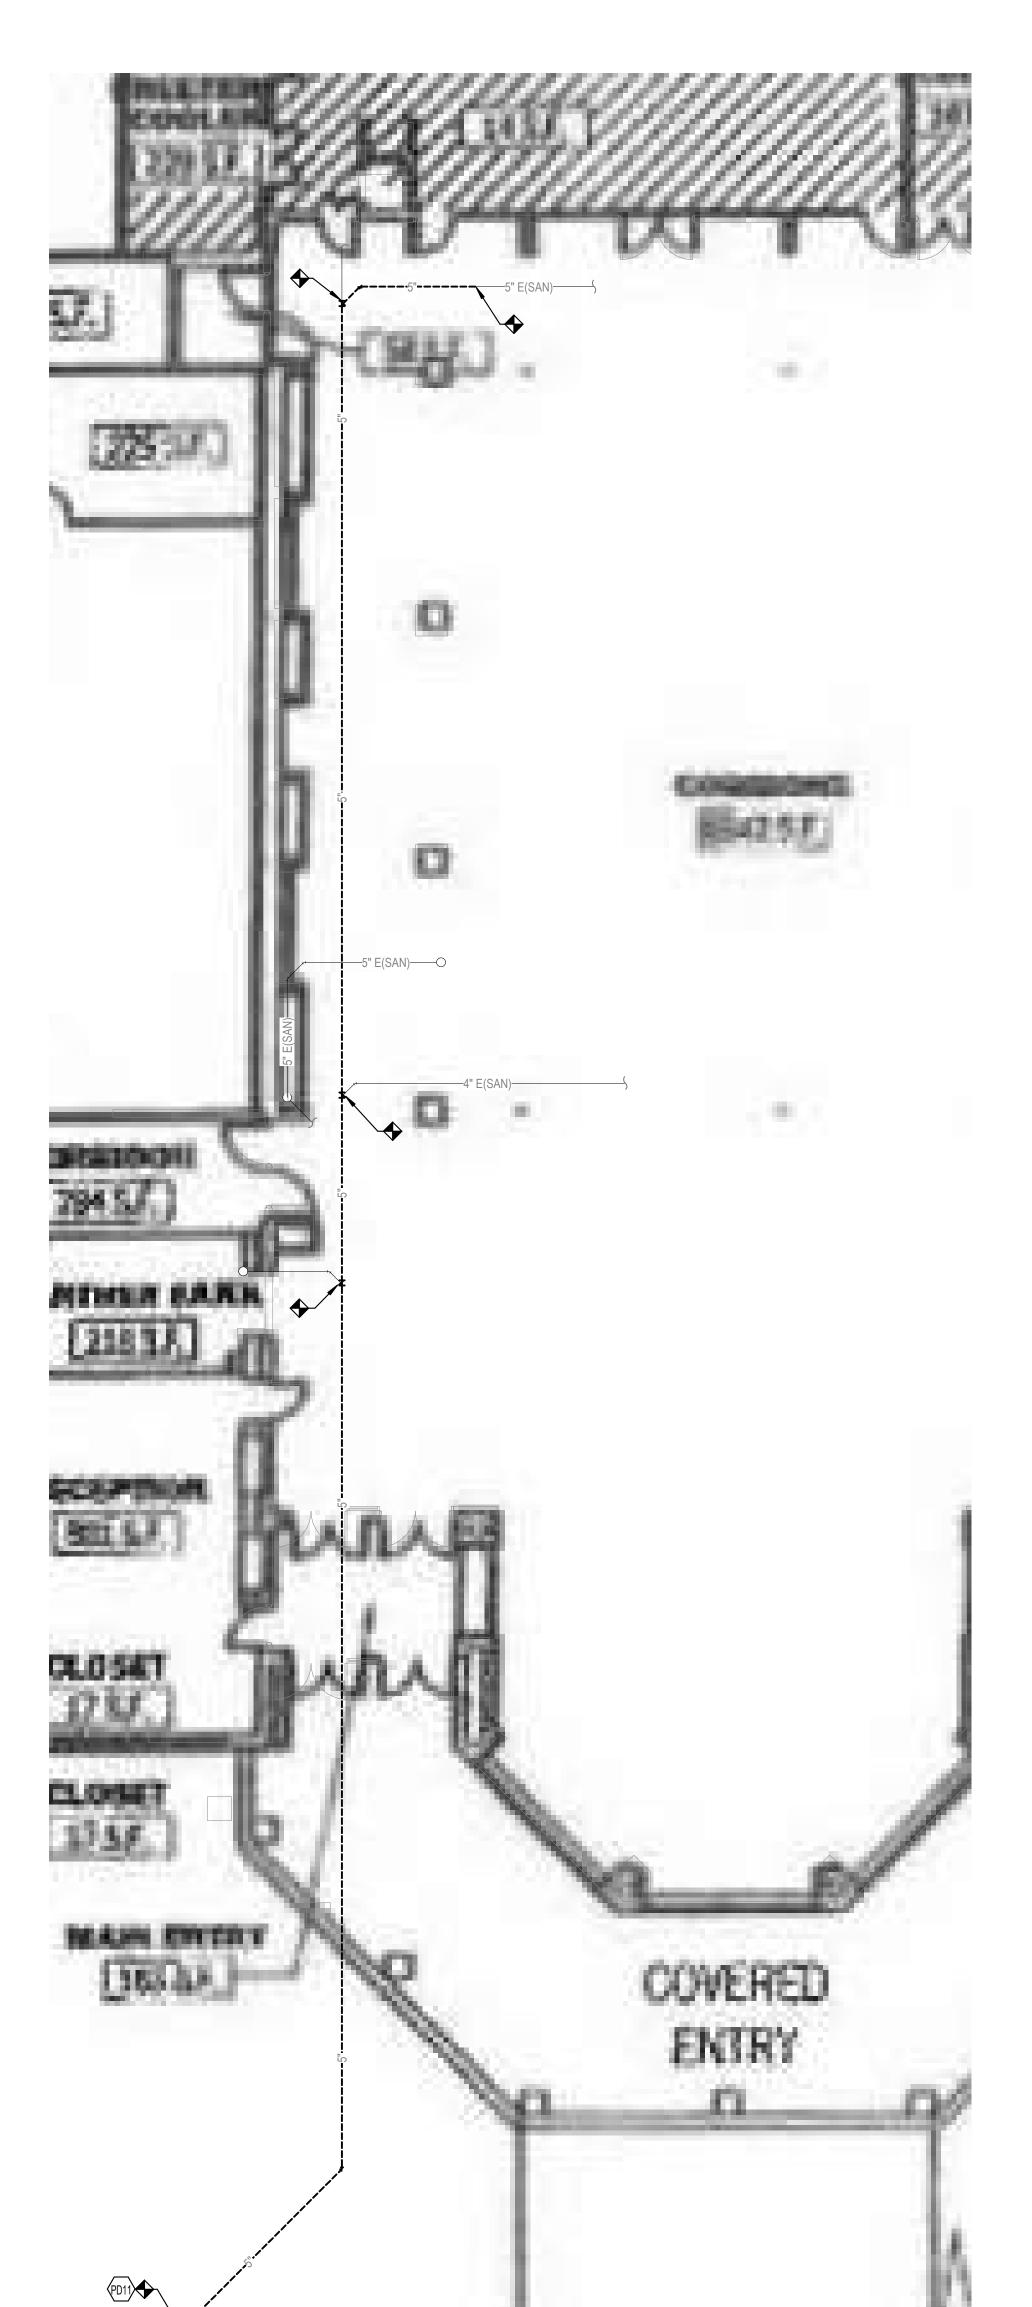
SCALE: 1/8" = 1'-0"


0 2' 4' 8' 16'

PLUMBING - CAFETERIA AND LOBBY


TAGGED NOTES PD11 DEMOLISH EXISTING SANITARY PIPING UP TO EXISTING MANHOLE. RECONNECT NEW SANITARY PIPING TO EXISTING MANHOLE. SEE NEW WORK


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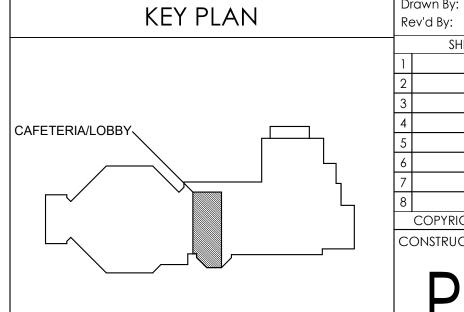


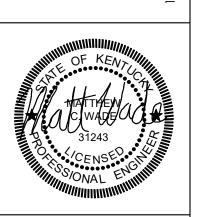

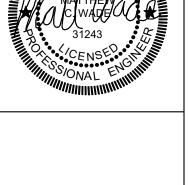


BG# 21-290

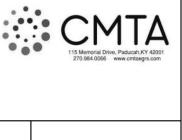Project No: 2121/XETR21
Drawn By: Author
Rev'd By: Checker SHEET RELEASE

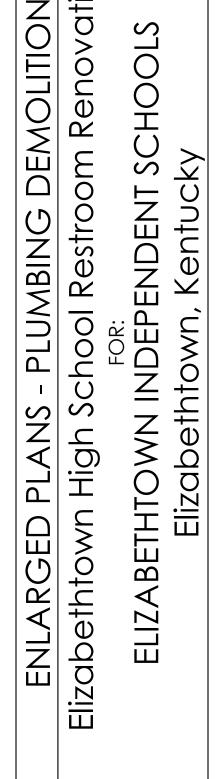





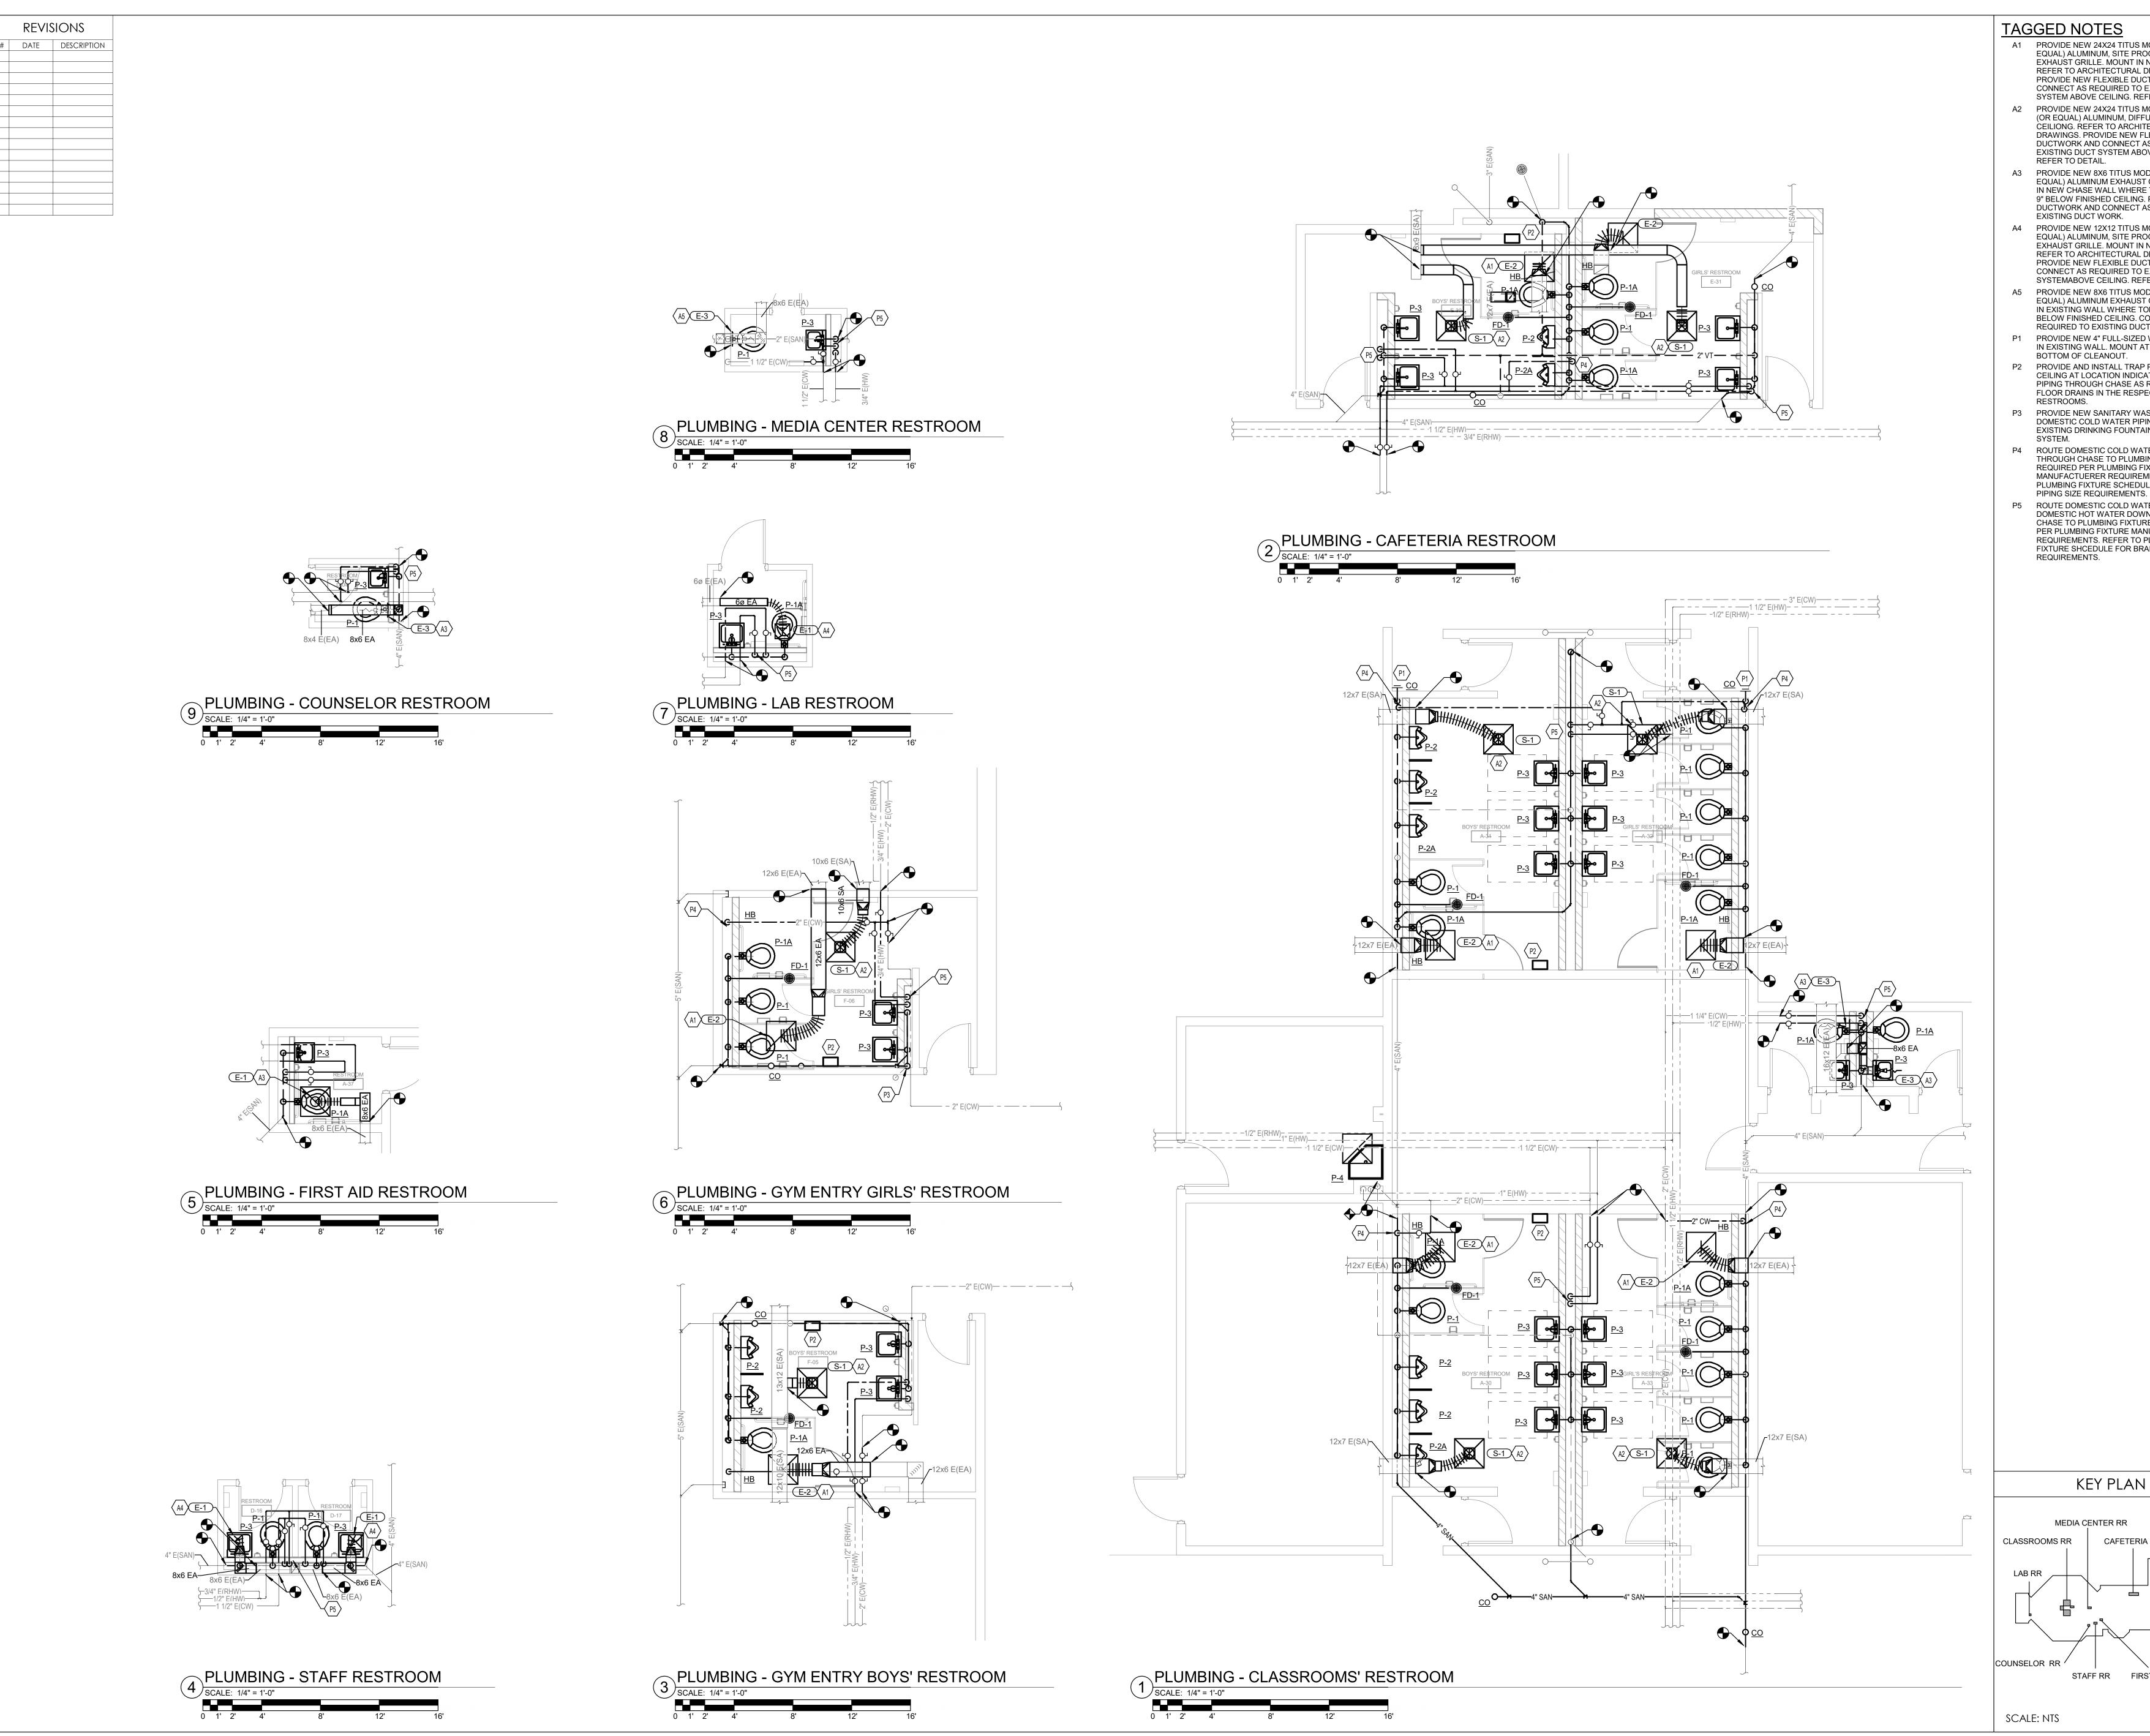

TAGGED NOTES A1 PROVIDE NEW 24X24 TITUS MODEL 45F (OR EQUAL) ALUMINUM, SITE PROOF EGGCRATE EXHAUST GRILLE. MOUNT IN NEW CEILING. REFER TO ARCHITECTURAL DRAWINGS. PROVIDE NEW FLEXIBLE DUCTWORK AND

CONNECT AS REQUIRED TO EXISTING DUCT SYSTEM ABOVE CEILING. REFER TO DETAIL. A2 PROVIDE NEW 24X24 TITUS MODEL TDCA-AA (OR EQUAL) ALUMINUM, DIFFUSER. MOUNT IN CEILIONG. REFER TO ARCHITECTURAL DRAWINGS. PROVIDE NEW FLEXIBLE DUCTWORK AND CONNECT AS REQUIRED TO

EXISTING DUCT SYSTEM ABOVE CEILING. REFER TO DETAIL. A3 PROVIDE NEW 8X6 TITUS MODEL 350FL (OR EQUAL) ALUMINUM EXHAUST GRILLE. MOUNT IN NEW CHASE WALL WHERE TOP OF GRILL IS

9" BELOW FINISHED CEILING. PROVIDE NEW DUCTWORK AND CONNECT AS REQUIRED TO EXISTING DUCT WORK. A4 PROVIDE NEW 12X12 TITUS MODEL 45F (OR

EQUAL) ALUMINUM, SITE PROOF EGGCRATE EXHAUST GRILLE. MOUNT IN NEW CEILING. REFER TO ARCHITECTURAL DRAWINGS. PROVIDE NEW FLEXIBLE DUCTWORK AND CONNECT AS REQUIRED TO EXISTING DUCT

SYSTEMABOVE CEILING. REFER TO DETAIL. A5 PROVIDE NEW 8X6 TITUS MODEL 350FL (OR EQUAL) ALUMINUM EXHAUST GRILLE. MÒUNT IN EXISTING WALL WHERE TOP OF GRILL IS 9" BELOW FINISHED CEILING. CONNECT AS REQUIRED TO EXISTING DUCTWORK.

P1 PROVIDE NEW 4" FULL-SIZED WALL CLEANOUT IN EXISTING WALL. MOUNT AT 8" AFF TO BOTTOM OF CLEANOUT. P2 PROVIDE AND INSTALL TRAP PRIMER ABOVE CEILING AT LOCATION INDICATED. ROUTE

PIPING THROUGH CHASE AS REQUIRED TO FLOOR DRAINS IN THE RESPECTIVE RESTROOMS.

P3 PROVIDE NEW SANITARY WASTE, VENT, AND DOMESTIC COLD WATER PIPING TO PIPE EXISTING DRINKING FOUNTAIN BACK INTO P4 ROUTE DOMESTIC COLD WATER DOWN

THROUGH CHASE TO PLUMBING FIXTURES AS REQUIRED PER PLUMBING FIXTURE MANUFACTUERER REQUIREMENTS. REFER TO PLUMBING FIXTURE SCHEDULE FOR BRANCH PIPING SIZE REQUIREMENTS. P5 ROUTE DOMESTIC COLD WATER AND

DOMESTIC HOT WATER DOWN THROUGH CHASE TO PLUMBING FIXTURES AS REQUIRED PER PLUMBING FIXTURE MANUFACTURER REQUIREMENTS. REFER TO PLUMBING FIXTURE SHCEDULE FOR BRANCH PIPING SIZE REQUIREMENTS.

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ELIZABETHTOWN INDEPENDENT SCHOC Elizabethtown, Kentucky

21-290
 Project No:
 2121/XETR21

 Drawn By:
 WDT

 Rev'd By:
 MCW
 SHEET RELEASE GYM GIRLS' RR

CONSTRUCTION DOCUMENTS LARGED PLANS - PLUMBING

DATE ISSUED:

FIRST AID RR

09/14/2021

REVISIONS # DATE DESCRIPTION

5" E(SAN)—(

PLUMBING - CAFETERIA AND LOBBY NEW
WORK PLAN

SCALE: 1/8" = 1'-0"

0 2' 4' 8' 16' 24' 32'

TAGGED NOTES ENLARGED PLANS - PLUMBING
Elizabethtown High School Restroom Rencent For:
ELIZABETHTOWN INDEPENDENT SCHOOL Elizabethtown, Kentucky BG# 21-290

Project No: 2121/XETR21
Drawn By: Author
Rev'd By: Checker KEY PLAN SHEET RELEASE CAFETERIA/LOBBY CONSTRUCTION DOCUMENTS NLARGED PLANS - PLUMBING DATE ISSUED: SCALE: NTS 09/14/2021

BELLMOUTH SPIN-IN COLLAR FITTING —

FOR ROUND DUCT BRANCH OR

REVISIONS


DATE DESCRIPTION

FAUCET WITH INTEGRAL VACUUM BREAKER — STAINLESS STEEL WALL GUARD MOP BASIN —

MANUAL VOLUME DAMPER. (REFER TO SPECIFICATIONS). DO NOT INSTALL VOLUME DAMPER

MOP BASIN DETAIL

SCALE: NONE

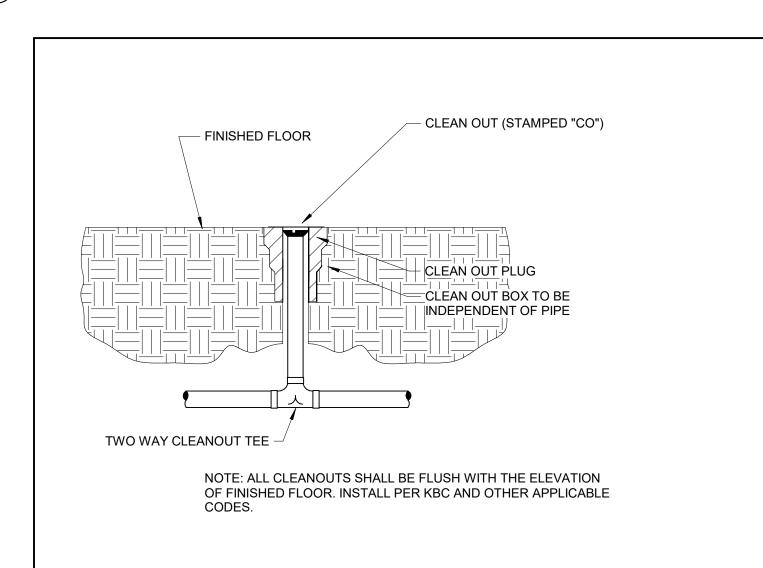

2 CLEANOUT DETAIL
SCALE: NONE

21-290 Project No: 2121/XETR21 Drawn By: MCW
Rev'd By: MCW SHEET RELEASE CONSTRUCTION DOCUMENTS


MECHANICAL DETAILS


Elizabethtown High School Restroom Renova
FOR:
ELIZABETHTOWN INDEPENDENT SCHOOLS
Elizabethtown, Kentucky

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MECHANICAL DETAILS

DATE ISSUED: 09/14/2021



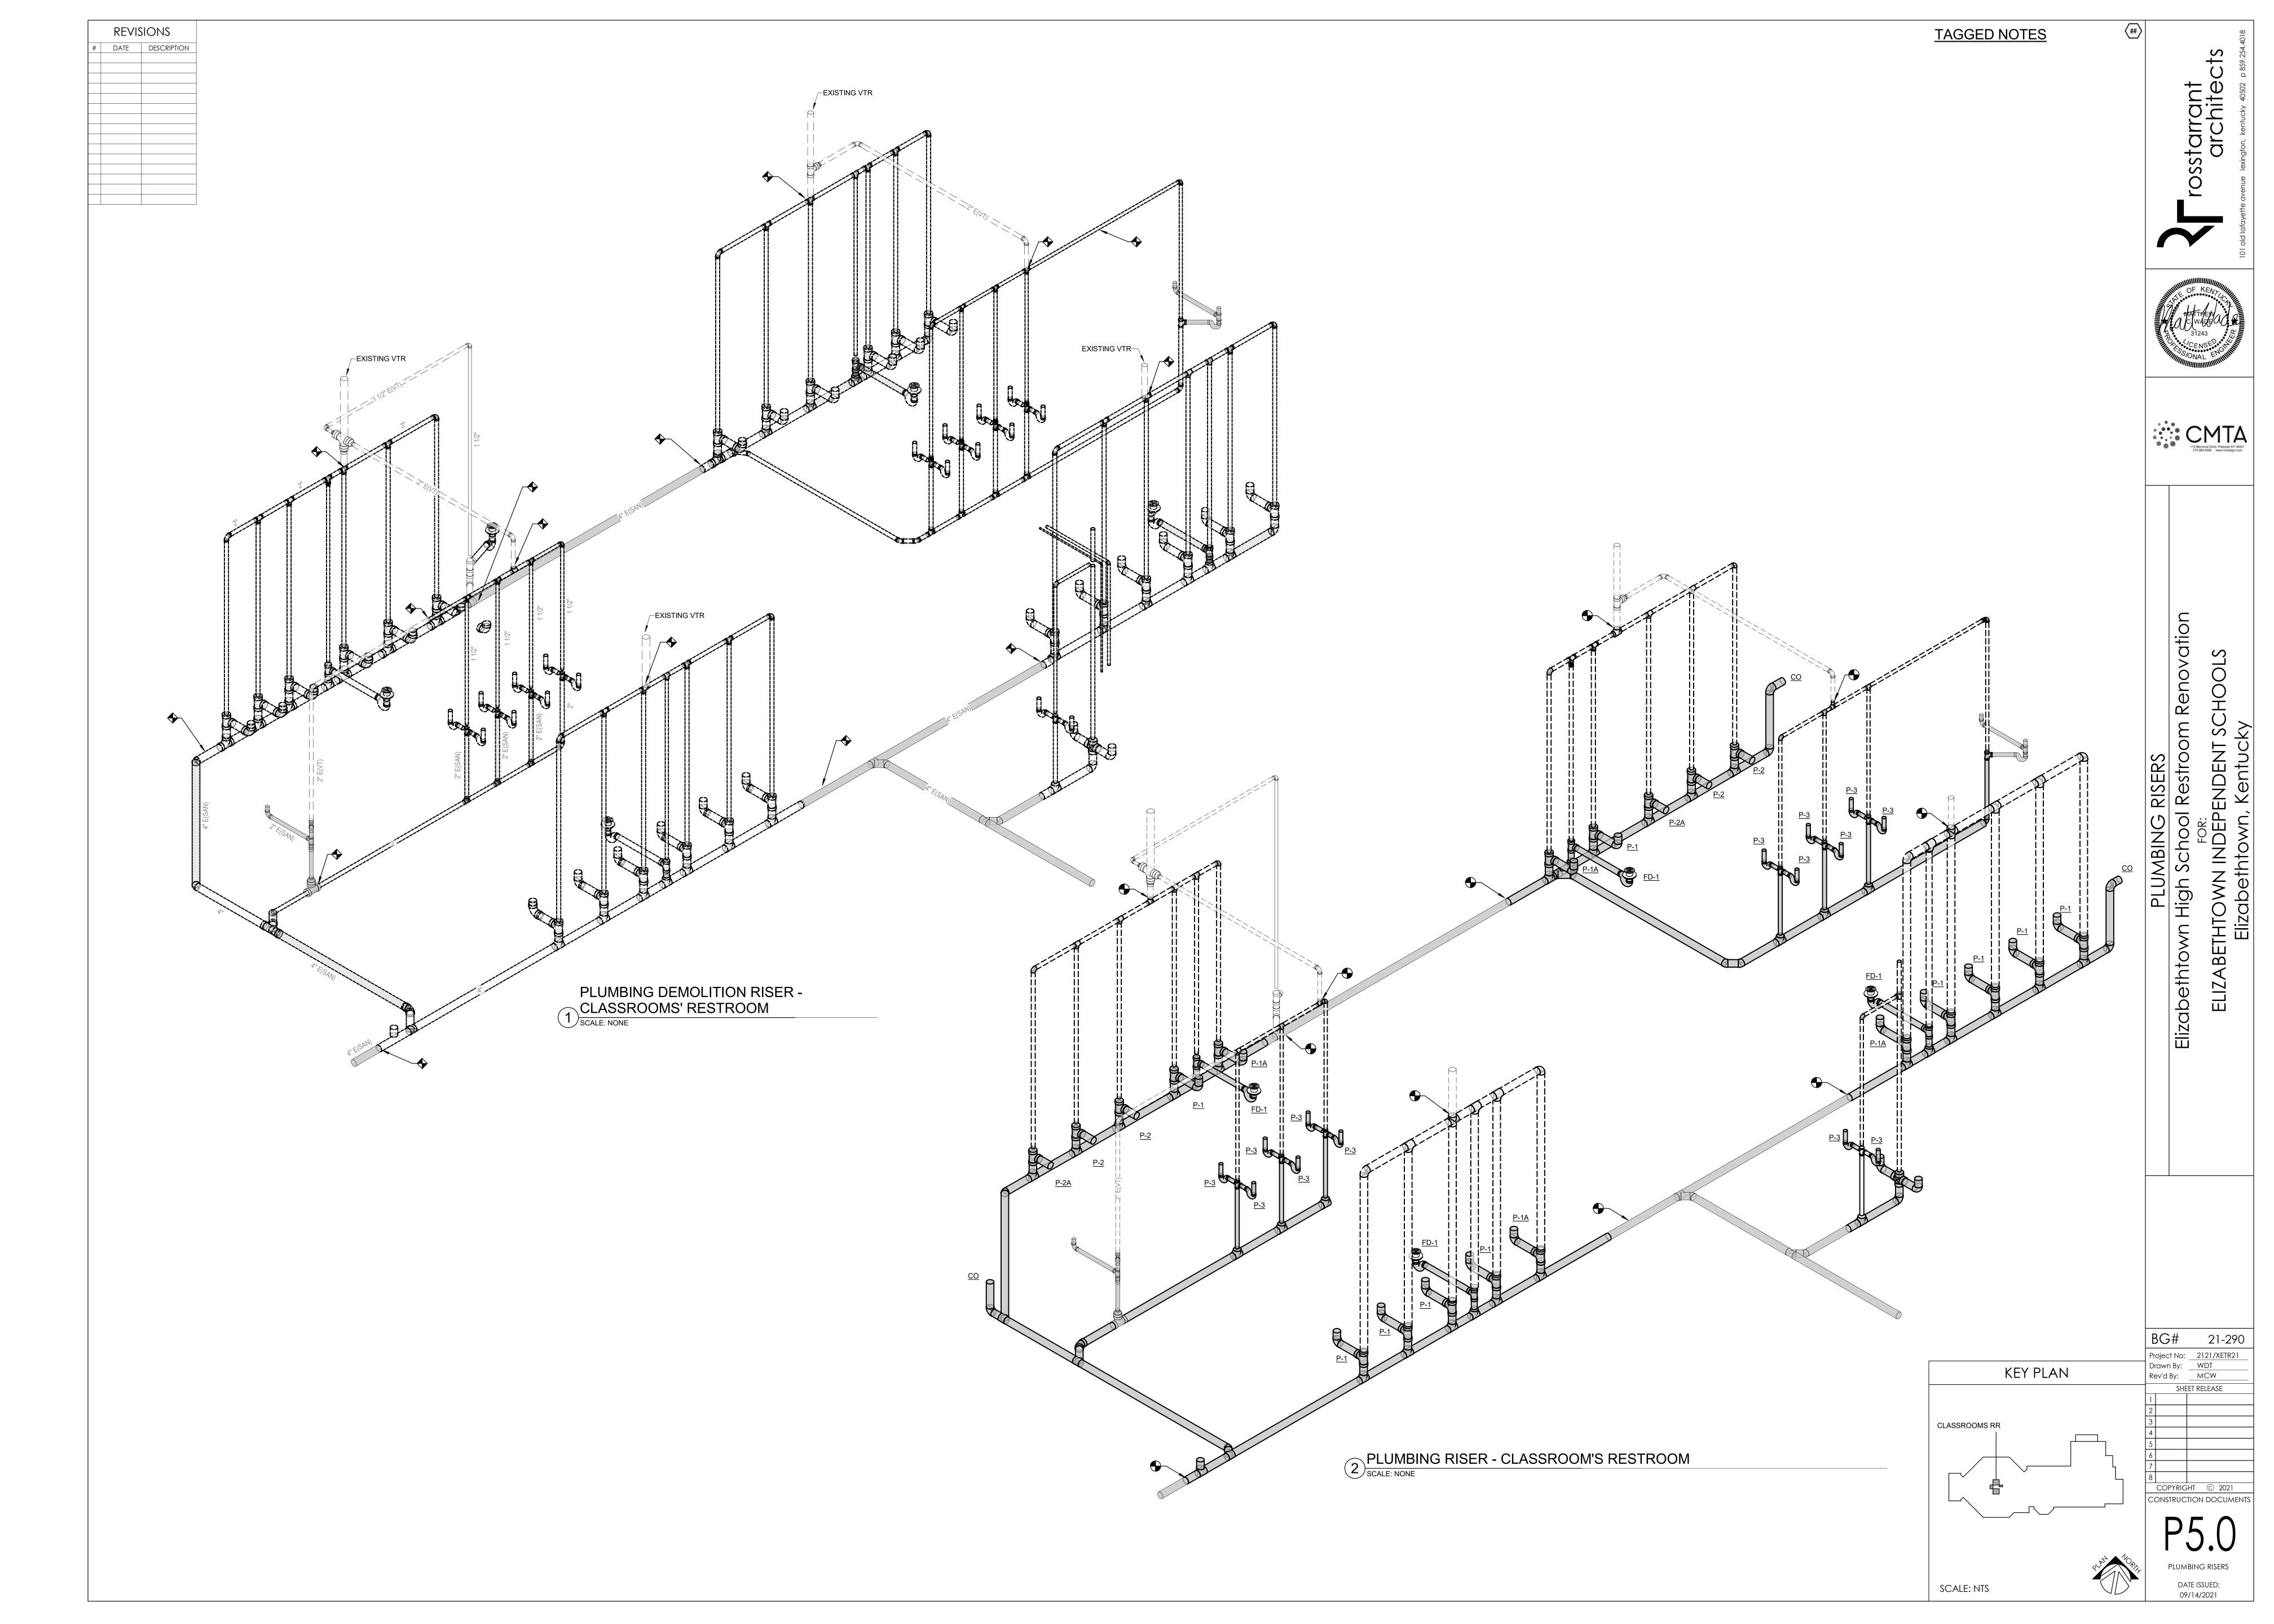

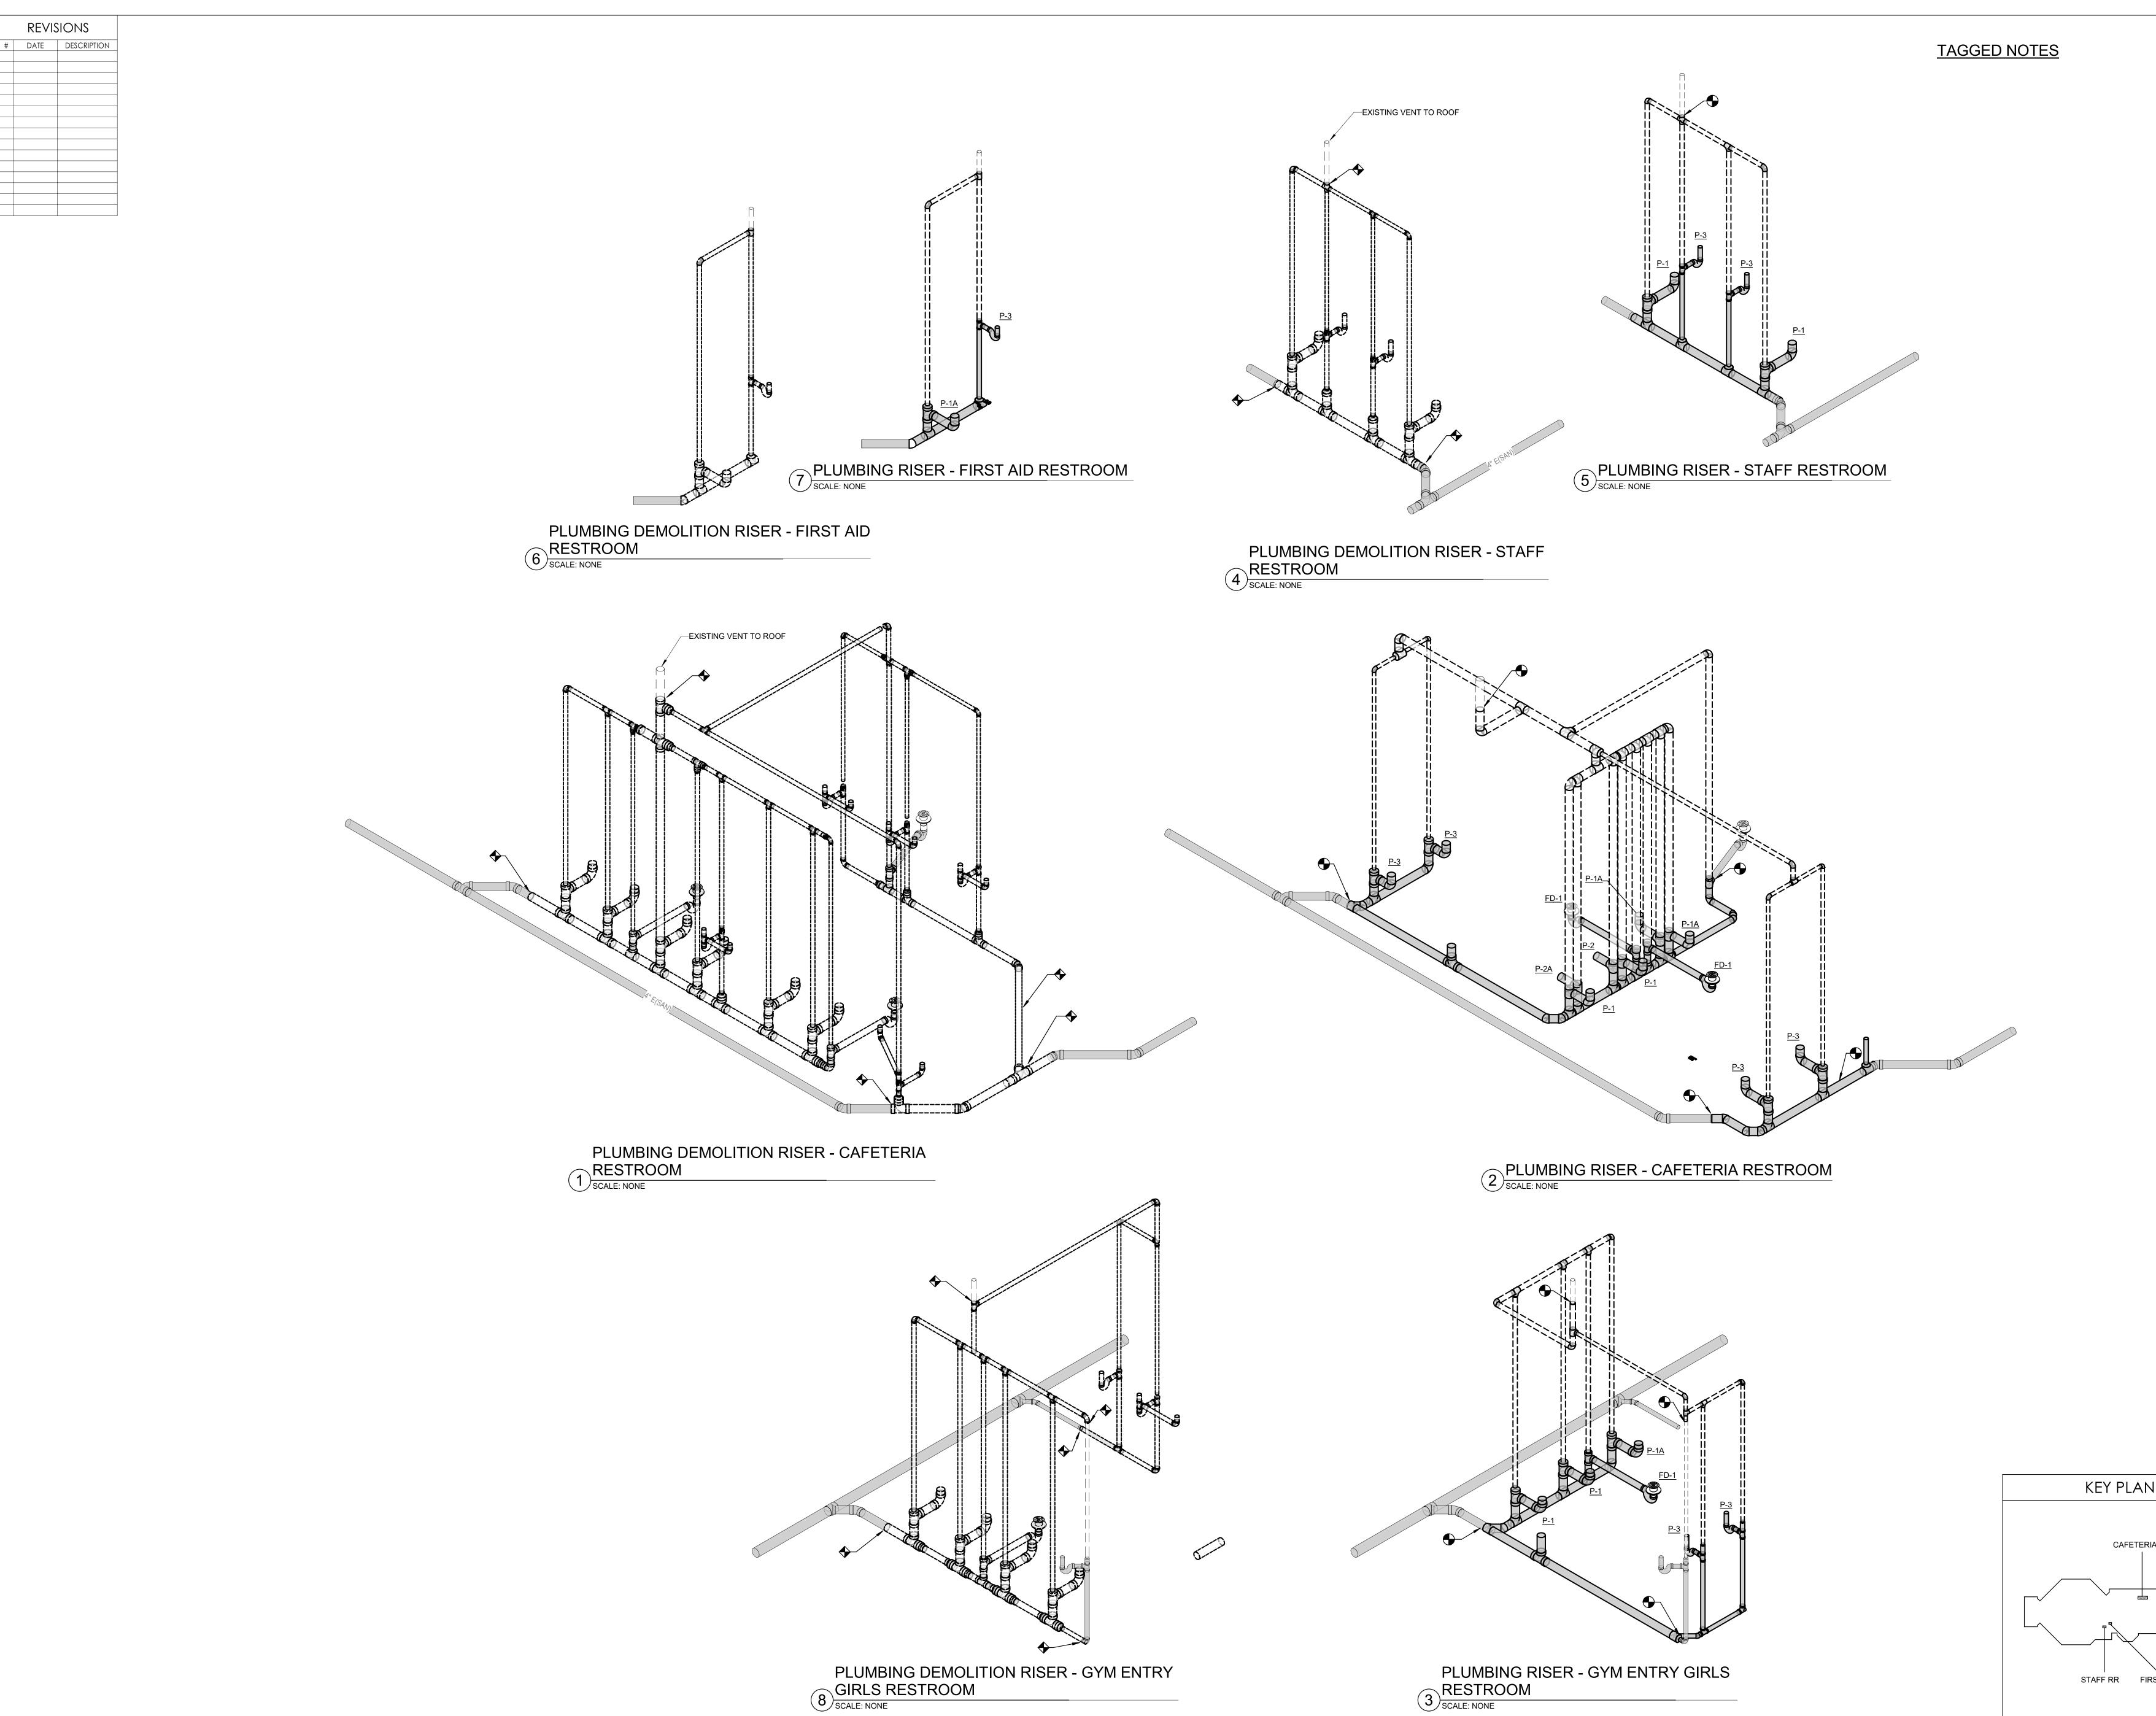







ELIZABETHTOWN INDEPENDENT SCHOC Elizabethtown, Kentucky

21-290
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SCALE: NTS

PLUMBING RISERS

DATE ISSUED:

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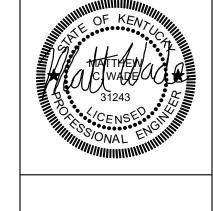
PLUMBING DEMOLITION RISER - MEDIA

8 CENTER RESTROOM
SCALE: NONE

PLUMBING RISER - MEDIA CENTER

7 RESTROOM
SCALE: NONE










PLUMBING RISERS
Elizabethtown High School Restroom Rencross
FOR:
ELIZABETHTOWN INDEPENDENT SCHOOL
Elizabethtown, Kentucky

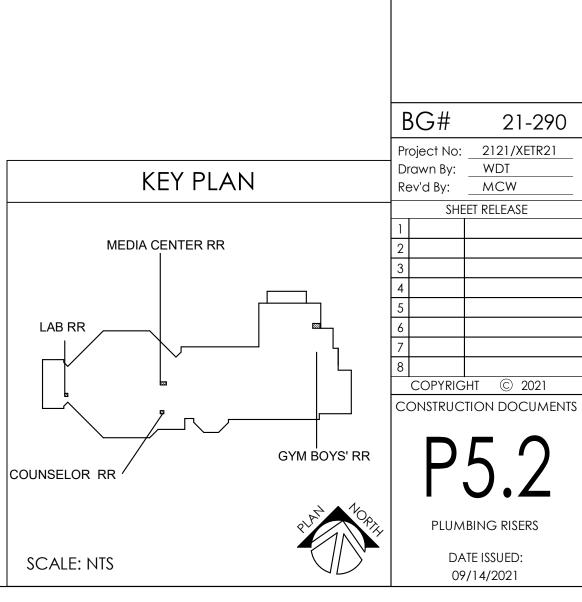

REVISIONS						
#	DATE	DESCRIPTION				

DESCRIPTION	MOUNTING HEIGHT	SYMBOI
LIGHTING CONTROLS	HLIGH	STABOL
LIGHT SWITCH: LOW VOLTAGE (WHEN PRESENT, # INDICATES QUANTITY OF CHANNELS)	46"	\$ #
EXAM LIGHT SWITCH	46"	\$ X
NIGHT LIGHT SWITCH WITH CONSTANTLY ILLUMINATED HANDLE	46"	\$ N
SURGICAL LIGHT INTENSITY CONTROL LOW VOLTAGE DIMMER SWITCH (WHEN PRESENT, # INDICATES	46"	\$ SL \$ D#
QUANTITY OF CHANNELS)		
GRAPHIC TOUCHSCREEN CONTROL STATION LINE VOLTAGE SWITCH	46"	\$ G S LV
LINE VOLTAGE THREE-WAY, FOUR-WAY SWITCH	46"	\$ LV3 \$ LV4
LINE VOLTAGE THREE-WAY, FOUR-WAY DIMMER SWITCH	46"	\$ LV3D \$ LV4
KEYED SWITCH	46"	\$ K \$ OS \$ VS
OCCUPANCY OR VACANCY SENSOR SWITCH OCCUPANCY OR VACANCY SENSOR SWITCH WITH DIMMING	46"	\$ DOS
LIGHT SWITCH FOR UNDER-CABINET LIGHTS	46"	\$ ^U
ILLUMINATED HANDLE LIGHT SWITCH (ILLUMINATED WHEN LOAD IS OFF)	46"	\$ ^{IL}
PILOT LIGHT SWITCH (ILLUMINATED WHEN LOAD IS ON)	46"	\$ PL
TIMER SWITCH OCCUPANCY OR VACANCY SENSOR, CEILING MOUNT	46" CLG	\$ ^T
OCCUPANCY SENSOR, CORNER MOUNT	CLG	
DAYLIGHT SENSOR	AS NOTED	©S
PHOTOCELL	AS NOTED	© [E]
LIGHTING RELAY EMERGENCY AUTOMATIC TRANSFER SWITCH FOR LIGHTING	AS NOTED CLG	LR ER
CONTROLS (REFER TO DETAIL)		
POWER OUTLETS SIMPLEX RECEPTACLE (TEXT INDICATES NEMA TYPE)	1'-6"	φ φ
DUPLEX RECEPTACLE	1'-6"	Ф
SLASH THROUGH ANY DEVICE INDICATES MOUNTING ABOVE COUNTERTOP 4" ABOVE BACKSPLASH		Ø ₩
FILLED CENTER BAR INDICATES INTEGRAL GROUND FAULT PROTECTION (GFCI)	1'-6"	@
DEAD FRONT GFCI DEVICE, LABEL AND INSTALL IN READILY		စ
ACCESSIBLE LOCATION DUPLEX RECEPTACLE WITH TWO INTEGRAL USB CHARGING PORTS	1'-6"	<u>ل</u> ا
USB CHARGING OUTLET WITH FOUR INTEGRAL USB PORTS	1'-6"	
		(O)
GANG RECEPTACLE IN COMBINATION WITH SWITCH (PROVIDE DIVIDER IF LIGHTING CIRCUIT IS 277V)	46"	ф ^{с/s}
DUPLEX RECEPTACLE, CEILING MOUNTED QUADRUPLEX RECEPTACLE	CLG 1'-6"	ф ф
JUNCTION BOX, CEILING OR WALL		Ф Ф Ф
VOLTAGE/2 POLE RECEPTACLE, TEXT INDICATES NEMA TYPE	1'-6"	₩ 🖔
VOLTAGE/3 POLE RECEPTACLE, TEXT INDICATES NEMA TYPE 'T' INDICATES SAFETY TYPE, TAMPER RESISTANT OUTLET(S)	1'-6"	₩ ₺
SS INDICATES SURGE SUPPRESION TYPE OUTLET(S)		фss
GROUND FAULT PROTECTED DUPLEX WITH WEATHER-PROOF "WHILE IN USE" TYPE DIE-CAST METAL COVERPLATE WITH	2'-2"	G _{WP}
LOCKABLE ENCLOSURE AT OUTLET - SEE SPECIFICATIONS DUPLEX FOR ELECTRIC WATER COOLER: COORDINATE EXACT		
LOCATION WITH PLUMBING CONTRACTOR TO CONCEAL OUTLET BEHIND COOLER, PROVIDE READILY ACCESSIBLE GFI DEVICE AT 18" ADJACENT TO WATER COOLER		@ _{EMC}
BOX ON ANY DEVICE INDICATES SURFACE MOUNTED BACKBOX/WIREMOLD		ф
CIRCLE ON ANY DEVICE INDICATES DEVICE FED FROM STUB UP		ф
FIRE ALARM		\
MAIN CONTROL PANEL CENTRAL PROCESSING UNIT (CPU)	6'-6" TO TOP	FACP
REMOTE L.C.D. FIRE ALARM ANNUNCIATOR	54"	FAA
REMOTE FIRE ALARM ANNUNCIATOR W/ MICROPHONE	54"	FAAM LOC
LOCAL OPERATOR CONSOLE SMOKE EVACUATION CONTROL PANEL	54"	SECP
POWER SUPPLY/CONTROL FOR AUDIO/VISUAL DEVICES	46"	NAC
TRANSPONDER CABINET	46"	TRAN
GRAPHICS DISPLAY TERMINAL FIRE ALARM CONTROL EXTENDER		GDT EXT
POST INDICATOR VALVE		PIV
PULL STATION : DOUBLE ACTION	46" TO LEVER	F
KEYED, LOCKED PULL STATION : DOUBLE ACTION. STATION SHALL ONLY BE OPERABLE VIA KEY IN POSSESSION OF STAFF.	46" TO LEVER	FK
AUDIO/VISUAL NOTIFICATION APPLIANCE	WALL, CLG	音音
AUDIO-ONLY NOTIFICATION APPLIANCE	WALL, CLG	
VISUAL-ONLY NOTIFICATION APPLIANCE BELL / LIGHT	WALL, CLG	
BELL ONLY	80"	В
PHOTO-ELECTRIC SMOKE DETECTOR	CLG	SD
PHOTO-ELECTRIC SMOKE DETECTOR FOR PATIENT ROOM MONITORING (SEE RISER)	CLG	SD P
PROJECTED BEAM SMOKE DETECTOR; EMITTER (BE) AND RECEIVER (BR)		BE BR
HEAT DETECTOR	CLG	HD
CARBON MONOXIDE DUCT DETECTOR	ABOVE CEILING	CD
CARBON MONOXIDE ALARM: SINGLE STATION W/SOUNDER BASE	CLG	CM FCM
CARBON MONOXIDE AUDIO/VISUAL NOTIFICATION APPLIANCE DOOR HOLDER: WALL TYPE	WALL	DH
DOOR HOLDER : CLOSURE TYPE	ABV DOOR	DHC
DUCT SMOKE DETECTOR	ABV CLG	DD
CONNECTION TO SPRINKLER FLOW SWITCH WITH ADDRESSABLE MODULE		FS
CONNECTION TO SPRINKLER TAMPER SWITCH WITH ADDRESSABLE MODULE		TS
PRESSURE SWITCH		PS
ISOLATION MODULE ZONE ADDRESSABLE MODULE	WALL	
H.V.A.C. SMOKE DAMPER CONNECTION		SM
FLUSH MOUNTED REMOTE ALARM INDICATING STATION/TEST SWITCH	7'-6"	RI
FIREMAN'S PHONE JACK	4'-6"	FP
FIREMAN'S KNOX BOX CONNECTION ADDRESSABLE RELAY MODULE		KB R
ADDRESSABLE RELAY MODULE INDICATES VANDAL-PROOF POLYCARBONATE COVER, VANDAL		VR
PROOF COVERS SHALL BE UL LISTED FOR USE WITH THE SPECIFIC DEVICE THEY ARE PROTECTING		
INDICATES CHIME AUDIBLE NOTIFICATION	1	CH

DEVICE USED FOR ELEVATOR CONTROL

DESCRIPTION	MOUNTING HEIGHT	SYMBOL
LIGHTING FIXTURES AND EQUIPMENT	HEIGH	JIIIDOL
REFER TO LUMINAIRE SCHEDULE FOR EXACT FIXTURE SPECIFICATIONS, MOUNTING HEIGHTS, ETC.		
SURFACE OR SUSPENDED CEILING FIXTURE		
] LJ ŏ
RECESSED CEILING FIXTURE		
POLE MOUNTED AREA LIGHT WITH CONCRETE BASE		<u>الله</u>
LIGHTED BOLLARD WITH CONCRETE BASE EMERGENCY BATTERY WALL-PACK		©
WALL MOUNT FIXTURE		₩₩ ₩₩
TRACK COMPLETE WITH POWER SUPPLIES AND FIXTURE HEADS		<u> </u>
FLOODLIGHT		Ψ
EXIT LIGHT (CEILING, END, WALL MOUNT) WITH OR WITHOUT DIRECTIONAL ARROWS, WITH OR WITHOUT EGRESS HEADS		
STRIP FIXTURE		⊢ ⊶
CROSS-HATCHING INDICATES LIGHT IS POWERED FROM THE EMERGENCY-CRITICAL BRANCH		
PARALLEL-HATCHING INDICATES LIGHT IS POWERED FROM THE EMERGENCY-LIFE SAFETY BRANCH		
REMOTE LIGHT FIXTURE DRIVER	AS NOTED	RD
REMOTE BATTERY BACKUP	AS NOTED	RB
CENTRAL BATTERY INVERTER	AS NOTED	INV
MISCELLANEOUS		PHASE
CONDUIT CONCEALED IN WALLS OR IN CEILING SPACE: ARROW(S) INDICATE(S) HOME RUN & # OF CIRCUITS:		GROUND
HASHMÀRKS INDICATÉ # OF CONDUCTORS.		
NON-REVERSING MOTOR STARTER SNAP SWITCH	AS NOTED	\$ ^M
MOMENTARY CONTACT SWITCH	46"	\$ MC
HAND-OFF-AUTO 3-POSTION SWITCH	46"	\$ HOA
DISCONNECT SWITCH MAGNETIC STARTER	5'-0"	' -
MAGNETIC COMBINATION STARTER	5'-0"	_
VARIABLE FREQUENCY DRIVE	5'-0"	_ B
ENCLOSED FLUSH MTD. CIRCUIT BREAKER	5'-0"	
MUSHROOM SWITCH	46"	
PUSHBUTTON STATION WITH 1, 2, OR 3 BUTTONS.	46"	000
PANELBOARD, SURFACE OR FLUSH MOUNTED, HATCHING INDICATES EMERGENCY	6'-6" TO TOP	
TRANSFORMER	AS NOTED	
·	7.6 TO 125	لا <u>ا</u> ح
EQUIPMENT HARDWIRE CONNECTION (SEE DETAIL) KITCHEN EQUIPMENT OUTLET COUPLING CONNECTION		8
(SEE DETAIL)		Q
MOTOR CONNECTION, REFER TO EQUIPMENT CONNECTION SCHEDULE		∼
PLUMBING FIXTURE SOLENOID VALVE/ELECTRIC EYE SENSOR CONNECTION. COORDINATE EXACT CONNECTION REQUIREMENTS		→
WITH MANUFACTURER.		_
PLUMBING FIXTURE ELECTRIC EYE TRANSFORMER CONNECTION. TRANSFORMER SHALL BE 120V-24V. MOUNT ABOVE SUSPENDED ACCESSIBLE CEILING IN J-BOX. PROVIDE ADDITIONAL		&
TRANSFORMERS OF SAME TYPE AS/IF NEEDED PROVIDE CONNECTION TO HAND DRYER (SEE ARCHITECTURAL	\/EDIEV\\\/ITI	_
PROVIDE CONNECTION TO HAND DRYER (SEE ARCHITECTURAL SPECIFICATIONS)	VERIFY WITH ARCHITECT	190
SURGE PROTECTION DEVICE (SURFACE OR FLUSH MOUNTED)		□ □ SPD
GENERATOR ANNUNCIATOR PANEL (SURFACE OR FLUSH MOUNTED) - SEE SPECIFICATIONS	46"	□ च GEN-A
CONDUIT UP		0
CONDUIT DOWN		•
FLEXIBLE CONDUIT		
GROUND BUS BAR ON INSULATED STANDOFFS	2'-0"	
BUS DUCT, AMPERAGES AS NOTED WIREWAY WITH REMOVABLE COVER (SIZE AS NOTED)	AS SHOWN	
TRENCH DUCT (SIZE AS NOTED)	AS SHOWN	
WIRE BASKET CABLE TRAY, SIZE AS NOTED	AS SHOWN	
LADDER CABLE TRAY, SIZE AS NOTED	AS SHOWN	
SOLID BOTTOM CABLE TRAY, SIZE AS NOTED	AS SHOWN	
J-HOOK PATHWAY		
EQUIPMENT TAG, REFER TO EQUIPMENT SCHEDULE MECHANICAL EQUIPMENT DESIGNATOR (SEE MECH. SCHEDULES)		EQUIP-#
MECHANICAL EQUIPMENT DESIGNATOR (SEE MECH. SCHEDULES) TAGGED NOTE		EQUIP-#
REVISION TAG		
LINETYPE LEGEND]
	EXISTING	

EXISTING

NEW

DESCRIPTION	MOUNTING HEIGHT
ABBREVIATIONS	
UNLESS OTHERWISE NOTED	
OWNER FURNISHED CONTRACTOR INSTALLED	
OWNER FURNISHED OWNER INSTALLED	
CONTRACTOR FURNISHED CONTRACTOR INSTALLED	
CONTRACTOR FURNISHED OWNER INSTALLED	
INDICATES EMERGENCY POWER	
WIREGUARD - PROVIDE MANUFACTURER'S SPECIFIC GUARD FOR DEVICE NOTED	
WEATHERPROOF - NEMA-3R, WET LOCATION LISTED. PROVIDE COVERS, RATINGS, ETC, AS SUITABLE FOR OUTDOORS.	
EXPLOSION PROOF - PROVIDE WIRING METHODS, ENCLOSURES, RATINGS, ETC. AS SUITABLE FOR HAZARDOUS LOCATION.	
SPECIAL OUTLETS	
FLOORBOX, AS SCHEDULED	FLOOR
POKE-THRU, AS SCHEDULED	FLOOR
WALLBOX, AS SCHEDULED	WALL
AUDIO/VISUAL SYSTEM OUTLET WITH DUPLEX RECEPTACLE, REFER	1'-6"
TO ASSOCIATED DETAIL FOR ADDITIONAL INFORMATION	1-0
COMBINATION POWER AND DATA OUTLET LOCATION, REFER TO ASSOCIATED DETAIL FOR ADDITIONAL INFORMATION	1'-6"
COMBINATION POWER AND DATA OUTLET LOCATION, GFCI DUPLEX RECEPTACLE, REFER TO ASSOCIATED DETAIL FOR ADDITIONAL INFORMATION	1'-6"
OVERHEAD PROJECTOR: PROVIDE DUPLEX RECEPTACLE, ONE DATA, HDMI, 3.5mm AUDIO, AND VGA OUTLET ON (3) PLATES	CLG
SPECIAL VIDEO SYSTEM SIGNAL INPUT	
SURFACE PLUG-MOLD	
SURFACE WIRE-MOLD	
POWER POLE AS NOTED	
TELEVISION	
	401
TELEVISION HEADEND (SPLITTERS/AMPLIFIERS/DISTRIBUTION)	46"
TELEVISION SYSTEM OUTLET WITH DUPLEX RECEPTACLE, COORDINATE LOCATION WITH WALL BRACKET WHERE APPLICABLE	7'-0"
OVERHEAD PAGING	
PAGING SPEAKER: CEILING	CLG
PAGING SPEAKER W/ VOLUME CONTROL	CLG
PAGING SPEAKER: WALL	8'-0"
RECESSED WALL MOUNTED PAGING SPEAKER DUKANE 5A606 SPEAKER. ATLAS 417-8WD	8'-0"
VANDAL PROOF / WEATHERPROOF WALL MOUNTED PAGING SPEAKER. QUAM VP1	SEE FLOOR PLANS
EXTERIOR VANDAL PROOF / WEATHERPROOF WALL MOUNTED PAGING SPEAKER, SHALL BE PAINTED COLOR SELECTED BY ARCHITECT/OWNER. QUAM VP6	SEE FLOOR PLANS
WALL MOUNTED PAGING HORN	9'-0"
CALL INITIATION STATION	46"
WALL VOLUME CONTROL	46"
PAGING MICROPHONE	1'-6"
PANIC BUTTON (MOUNTING PER DRAWINGS)	46", UNDER
NOTIFICATION LIGHT (MOUNTING PER DRAWINGS)	DESK 7'-6", CLG
LCD WALL DISPLAY	
PAGING SYSTEM HEADEND	46"
CLOCKS	. ,
TYPICAL CLOCK MOUNTING HEIGHTS:	
FOR CEILING HEIGHTS < 9'-8" : MOUNT CENTER OF BACKBOX AT 8" BELOW CEILING.	
FOR CEILING HEIGHTS >= 9'-8" : MOUNT CENTER OF BACKBOX AT 9'-0" AFF.	
ANALOG CLOCK: SINGLE FACE	SEE ABOVE
ANALOG CLOCK: DUAL FACE	SEE ABOVE
DIGITAL CLOCK: SINGLE FACE	SEE ABOVE
DIGITAL CLOCK: DUAL FACE	SEE ABOVE
CLOCK SYSTEM HEAD END	84"
AV SYSTEMS	1
PROJECTOR WITH MOUNT (CEILING OR WALL AS INDICATED)	REFER TO
LOCAL SOLIND SPEAKER: CEILING	DRAWINGS
LOCAL SOUND SPEAKER: CEILING	CLG
WIRELESS MICROPHONE ANTENNA	CLG
LOCAL SOUND SPEAKER: WALL	REFER TO SPECS.
MICROPHONE INPUT: # INDICATES NUMBER OF INPUTS.	1'-6"
WIRELESS MICROPHONE ANTENNA, WALL MOUNT	REFER TO
	SPECS.
AV INPUT (OR OUTPUT) WALL PLATE. REFER TO DRAWINGS AND SPECIFICATIONS FOR TYPE AND QUANTITY OF CONNECTIONS.	1'-6"
BLUETOOTH INPUT MODULE	1'-6"

AV TOUCHSCREEN CONTROL STATION

LOCAL SOUND SYSTEM HEADEND

REFER TO

SPECS.

ELECTRICAL GENERAL NOTES


- A EACH CONTRACTOR, PROPOSER, SUPPLIER AND/OR MANUFACTURER SHALL REFER TO ALL DOCUMENTS PERTAINING TO THIS PROJECT AND COORDINATE ACCORDINGLY SO AS TO ENSURE ADEQUACY OF FIT, COMPLIANCE WITH SPECIFICATIONS, PROPER VOLTAGE AND
- CURRENT CHARACTERISTICS TO AVOID CONFLICT WITH ANY OTHER BUILDINGS SYSTEMS. VERIFY SAME WITH SHOP DRAWINGS. B ADDITIONAL ELECTRICAL REQUIREMENTS MAY BE SHOWN ON PLANS FROM OTHER DISCIPLINES IN THIS SET. IT IS THE CONTRACTOR'S RESPONSIBILITY TO REVIEW ALL PLANS AND SPECIFICATIONS FOR A COMPLETE UNDERSTANDING OF THE PROJECT REQUIREMENTS.
- C WORK SHALL BE IN ACCORDANCE WITH THE LATEST EDITION OF ALL LOCAL, STATE, AND NATIONAL CODES. INCLUDING BUT NOT LIMITED TO NFPA 70 (NEC), NFPA 72, INTERNATIONAL BUILDING CODES, ETC.
- D CONTRACTOR SHALL FOLLOW SEISMIC RESTRAINT AND DESIGN REQUIREMENTS CONTAINED IN LATEST ADOPTED STATE AND INTERNATIONAL BUILDING CODES, WITH ALL AMENDMENTS AS ADOPTED BY THE CURRENT LEGISLATION. REFER TO ELECTRICAL AND
- STRUCTURAL SPECIFICATIONS FOR ADDITIONAL INFORMATION. E ALL OFFSETS, TURNS, FITTINGS, TRIM, DETAIL, ETC. MAY NOT BE INDICATED, BUT SHALL BE PROVIDED AS REQUIRED. ADDITIONAL ALLOWANCES SHALL BE INCLUDED FOR SAME AT EACH PROPOSER'S DISCRETION.
- F INSTALL NO PIPING, CONDUIT, DUCTWORK, ETC. IN A LOCATION OR IN A MANNER WHICH WILL ALLOW FREEZING OR THE COLLECTION
- OF CONDENSATION THEREON. IF IN DOUBT, CONTACT THE ENGINEER. G ADVISE THE ENGINEER OF ANY CONFLICTS, ERRORS, OMISSIONS, ETC. AT LEAST TEN DAYS PRIOR TO BID DATE, TO ALLOW CLARIFICATION BY WRITTEN ADDENDUM.
- H WHERE CONFLICTS ARE FOUND BETWEEN DRAWINGS, DETAILS, OR SPECIFICATIONS, THE MORE STRINGENT REQUIREMENT SHALL APPLY. NOTIFY ARCHITECT OF DISCREPANCY IN WRITING.
- I DEVIATION FROM SPECIFICATIONS OR PLANS REQUIRES PRIOR WRITTEN APPROVAL FROM THE ENGINEERS AND MUST BE SUBMITTED IN WRITING NO LATER THAN TEN DAYS PRIOR TO THE BID DATE.
- J OBSERVE ALL APPLICABLE CODES, RULES AND REGULATIONS THAT MAY APPLY TO THE WORK UNDER THIS CONTRACT. (CITY, COUNTY, LOCAL, STATE, FEDERAL, MUNICIPALITY, UTILITY COMPANY, OSHA, ETC.).
- K MOUNTING HEIGHTS FOR WALL MOUNTED DEVICES INDICATED ABOVE FINISHED FLOOR ARE TO CENTER OF DEVICE UON. MOUNTING HEIGHTS TO CEILING SUSPENDED DEVICES ARE TO BOTTOM OF DEVICE UON.
- L INSTALL EOUIPMENT, MATERIALS, ETC. IN STRICT ACCORDANCE WITH MANUFACTURER'S RECOMMENDATIONS AND DIRECTIONS. IF IN CONFLICT WITH THE DESIGN INDICATED IN CONTRACT DOCUMENTS, ADVISE THE ENGINEER PRIOR TO INSTALLATION FOR
- M DO NOT RECESS PANELBOARD TUBS OR OTHER FLUSH-MOUNTED EQUIPMENT IN WALLS THAT HAVE A FIRE RATING. NO INSTALLATION SHALL DIMINISH OR VOID FIRE RESISTIVE RATINGS IN ANYWAY. N THE PURPOSE AND INTENT OF ALL OF THE DOCUMENTS PERTAINING TO THIS PROJECT IS TO PROVIDE A COMPLETE, FUNCTIONAL,
- SAFE, LIKE-NEW FACILITY. ANYTHING LESS SHALL BE UNACCEPTABLE. O ALL SYSTEMS, EQUIPMENT AND MATERIALS ARE TO BE INSTALLED IN A NEAT AND WORKMANLIKE MANNER, WORK NOT MEETING THIS
- CRITERION SHALL BE REMOVED AND REINSTALLED SATISFACTORILY. FINAL DETERMINATION OF THE ACCEPTABILITY OF THE QUALITY OF WORK RESIDES WITH THE ENGINEER P ALL WORK, MATERIALS, EQUIPMENT, ETC. SHALL BE FULLY GUARANTEED FOR ONE FULL CALENDAR YEAR FROM THE DATE OF
- SUBSTANTIAL COMPLETION AS DOCUMENTED BY THE ENGINEER, UNLESS LONGER WARRANTY PERIODS FOR EQUIPMENT ARE SPECIFIED. O UNLESS OTHERWISE SPECIFIED OR INDICATED, ALL EQUIPMENT AND/OR MATERIALS WITHIN OCCUPIED SPACES OR EXPOSED TO VIEW ON THE BUILDING EXTERIOR SHALL BE PRIMED AND FINISHED SO AS TO COMPLEMENT ADJACENT SURFACE, UNLESS OTHERWISE NOTED. COORDINATE WORK AND COLORS WITH ARCHITECT.
- R WHERE PENETRATING ROOFING MEMBRANE OR OTHER MATERIALS USED FOR WEATHERPROOFING THE BUILDING, MAKE SUCH PENETRATION IN A WAY THAT WILL NOT VOID OR DIMINISH THE ROOFING WARRANTY OR INTEGRITY IN ANYWAY. COORDINATE ALL SUCH PENETRATIONS WITH THE ROOFING MANUFACTURER AND ARCHITECT.
- S THE CONTRACTOR IS RESPONSIBLE FOR ALL UTILITY COMPANY FEES, CASH CONTRIBUTIONS OR OTHER COSTS THAT THE UTILITY
- COMPANY MAY REQUIRE TO COMPLETE THEIR WORK. (ELECTRIC, TELEPHONE, TELEVISION, DATA, ETC.).
- T COORDINATE WITH ARCHITECTURAL FLOOR PLANS, ELEVATIONS AND CASEWORK DETAILS FOR LOCATION OF ADDITIONAL
- RECEPTACLES, UTILITY OUTLETS, ELECTRICAL DEVICES, ETC. U CEILING-MOUNTED ELECTRICAL DEVICES SHALL BE CENTERED IN 2'X2' CEILING TILE AND INSTALLED CENTERED ON 2' DIMENSION OF
- 2'X4' TILE AND ON CENTERLINE OR A QUARTER POINT ON 4' DIMENSION. V ANY VIBRATING, OSCILLATING OR OTHER NOISE OR MOTION PRODUCING EQUIPMENT SHALL BE ISOLATED FROM SURROUNDING SYSTEMS IN AN APPROVED MANNER. NOISY OR STRUCTURALLY DAMAGING INSTALLATIONS SHALL BE SATISFACTORILY REPLACED OR REPAIRED AT THE INSTALLING CONTRACTORS' EXPENSE. THE FINAL DECISION ON THE SUITABILITY OF A PARTICULAR INSTALLATION'S
- ACCEPTABILITY SHALL BE THAT OF THE ENGINEER. W CHECK ALL THREE PHASE MOTORS WITH A PHASE ROTATION METER, PRIOR TO PLACING IN SERVICE.
- X PROVIDE DETAILED SHOP DRAWINGS TO ENGINEER PRIOR TO PURCHASING OR INSTALLING ANY EQUIPMENT Y DEVIATIONS IN SIZES, CAPACITIES, FIT, FINISH, ETC. FOR EQUIPMENT FROM THAT PRIME SPECIFIED SHALL BE THE RESPONSIBILITY OF THE PURCHASER OF THAT EQUIPMENT. ANY PROVISIONS REQUIRED TO ACCOMMODATE A DEVIATION, WHETHER APPROVED BY THE
- ENGINEER OR NOT, SHALL BE THE RESPONSIBILITY OF THE PURCHASER. Z THE CONSTRUCTION MANAGER, GENERAL CONTRACTOR, OR WHOMEVER HOLDS THE PRIME CONTRACT(S) FOR THIS CONSTRUCTION IS RESPONSIBLE FOR THE COORDINATION, APPEARANCE, SCHEDULING AND TIMELINESS OF THE WORK OF ALL TRADES, CONTRACTORS,
- SUPPLIERS, INSTALLERS, ETC. POOR OR UNTIMELY WORK ON THE PART OF ANY SUBCONTRACTOR SHALL BE RESOLVED BY THE PARTY WHO ENGAGED THEM ON THIS PROJECT. AA WHERE MOUNTING HEIGHTS ARE NOT INDICATED OR ARE IN CONFLICT WITH ANY OTHER BUILDING SYSTEM, CONTACT THE ENGINEER
- BEFORE AFFECTING INSTALLATION. REFER ALSO TO ARCHITECTURAL INTERIOR AND EXTERIOR ELEVATIONS, CEILING HEIGHTS AND OTHER DETAILS OF THESE DOCUMENTS, AS APPLICABLE.
- AB WHERE FIRE-RATED CEILING ASSEMBLIES ARE NOTED, PROVIDE UL-LISTED FIRE-RATED GYPSUM BOARD OR PRE-MANUFACTURED ENCLOSURES ABOVE LUMINAIRES, CEILING DEVICES, ETC. IN OR ON CEILING, AS REQUIRED TO MAINTAIN CEILING RATINGS.
- AC COORDINATE THE LOCATION OF DRAINS, ELECTRICAL OUTLETS, GAS OUTLETS, ETC. WITH ALL CASEWORK, KITCHEN EQUIPMENT MECHANICAL ROOM EQUIPMENT, ETC. PRIOR TO COMMENCING INSTALLATION. WORK NOT SO COORDINATED SHALL BE REMOVED AND PROPERLY INSTALLED AT THE EXPENSE OF THE RESPONSIBLE CONTRACTOR(S).
- AD ALL ELECTRICAL COMPONENTS OR EQUIPMENT SHALL BE LISTED AND LABELED BY UNDERWRITER'S LABORATORIES OR OTHER APPROVED LISTING AGENCY. APPROVAL AND LABELING OF INDIVIDUAL COMPONENTS ON AN ASSEMBLY IS NOT ACCEPTABLE AS MEETING THIS REQUIREMENT, UNLESS WAIVED BY THE ENGINEER IN WRITING.
- AE ALL WIRING SYSTEMS SHALL BE INSTALLED WITH A MINIMUM OF SPLICES. CONDUCTORS, WHETHER SINGLE OR MULTI-PAIR, SHALL BE INSTALLED CONTINUOUS INSOFAR AS POSSIBLE FROM TERMINAL POINT TO TERMINAL POINT.
- AF NO CONDUIT, SUPPORTS, ETC. SHALL BE RUN THROUGH ACCESS CLEARANCES OF EQUIPMENT BY OTHER TRADES (I.E. VAV BOXES). COORDINATE WITH ALL TRADES PRIOR TO CONSTRUCTION.
- AG ALL CONTRACTORS SHALL EXERCISE EXTREME CARE IN THE COURSE OF THEIR WORK SO AS TO ENSURE THAT THEY DO NOT INTERRUPT ANY EXISTING SERVICE OR SUB-SERVICE FOR SAFETY PURPOSES. PAY PARTICULAR ATTENTION TO THIS PRECAUTION RELATIVE TO NATURAL GAS AND ELECTRICAL LINES. VERIFY THE LOCATION, SIZE, TYPE, ETC. OF EACH UNDERGROUND OR OVERHEAD UTILITY. ALL WORK SHALL BE PERFORMED IN ACCORDANCE WITH ALL FEDERAL, STATE AND/OR LOCAL RULES, REGULATIONS, STANDARD AND SAFETY REQUIREMENTS. UTILITIES SHALL BE INSTALLED IN ACCORDANCE WITH THE APPLICABLE MUNICIPALITY OR UTILITY COMPANY STANDARDS. IN ALL CASES, THE MOST STRINGENT REQUIREMENT SHALL APPLY.
- AH ALL SUPPORTS FOR EQUIPMENT, DEVICES OR FIXTURES SHALL BE UNIQUE, DIRECTLY FROM THE BUILDING STRUCTURE. DO NOT SUPPORT WORK FROM OTHER TRADES EQUIPMENT OR SUPPORTS WITHOUT WRITTEN PERMISSION FROM THE ENGINEER AND CONSENT
- OF THE OTHER TRADE, IN WRITING. AI WHERE INTERRUPTING AN EXISTING UTILITY OR SERVICE DELIBERATELY OR ACCIDENTALLY, THE RESPONSIBLE CONTRACTOR SHALL
- WORK CONTINUOUSLY AS NEEDED TO RESTORE SAME, PROVIDING PREMIUM TIME AS NEEDED. AJ REFER TO ARCHITECTURAL WALL ELEVATIONS (WHERE GIVEN) FOR HEIGHTS AND MOUNTING RELATIONSHIP OF OUTLETS AND
- EQUIPMENT. IF IN DOUBT, CONTACT ENGINEER FOR DIRECTION PRIOR TO ROUGH IN. AK FLUSH OR PEDESTAL TYPE FLOOR OUTLETS/BOXES, AS INDICATED ON PLAN, SHALL BE LOCATED BY DIMENSIONS PROVIDED BY THE
- ARCHITECT, UNLESS OTHERWISE SHOWN ON PLANS. IF IN DOUBT, CONTACT THE ENGINEER PRIOR TO ROUGHING-IN ANY WORK. AL AS APPLICABLE, REFER TO ARCHITECTURAL PHASING PLANS AND PHASING BOUNDARIES ON THESE DRAWINGS FOR SEQUENCING OF WORK, FULL EXTENT OF AREAS INVOLVED, EXTENT OF CEILING WORK, ETC. PROVIDE TEMPORARY CONNECTIONS FOR CIRCUITS AND
- WORK AS REQUIRED TO MAINTAIN SEQUENCE OF THE WORK FROM PHASE TO PHASE.
- AM THIS CONTRACTOR SHALL BE RESPONSIBLE FOR ALL CUTTING AND PATCHING REQUIRED FOR HIS WORK. ALL CUTTING AND PATCHING SHALL BE IN ACCORDANCE WITH THE ARCHITECT'S STANDARDS FOR SUCH WORK.
- AN ALL WORK SHALL BE CONCEALED UNLESS SPECIFICALLY INDICATED TO BE EXPOSED, OR REQUIRED TO BE EXPOSED. IF IN DOUBT, CONTACT THE ENGINEER FOR CLARIFICATIONS PRIOR TO INSTALLING ANY SUCH WORK.
- AO INTERRUPTION OF ANY EXISTING SERVICES SHALL BE COORDINATED WITH THE OWNER, GENERAL CONTRACTOR, UTILITY COMPANY AS NECESSARY, AND THE ARCHITECT, AT LEAST TWO WEEKS IN ADVANCE OF ANTICIPATED INTERRUPTION. A SCHEDULE FOR THESE OUTAGES SHALL BE DEVELOPED AND AGREED UPON BETWEEN THE PARTIES MENTIONED TO AVOID UNNECESSARY INCONVENIENCE TO THE OWNER OR ANY AFFECTED PARTY. NOTIFY THE UTILITY COMPANY OF ANY ANTICIPATED SERVICES REQUIRED TWO WEEKS IN
- ADVANCE, IN WRITING. IF UTILITY COMPANY REQUIRES A LONGER NOTIFICATION PERIOD, SO PROVIDE. AP WHERE BACKBOXES ARE LOCATED IN THE SAME VERTICAL CHANNEL/STUD SPACE ON OPPOSITE SIDES OF THE SAME WALL, PROVIDE SOUND-INSULATING PUTTY AROUND BOXES AS REQUIRED TO ELIMINATE SOUND TRANSMISSION FROM ROOM TO ROOM.
- AQ JUNCTION BOXES LOCATED ABOVE ACCESSIBLE CEILINGS SHALL BE LOCATED NO MORE THAN 36" ABOVE CEILING LEVEL. LABEL EACH BOX IN AREA OF WORK WITH A PERMANENT MARKER OR IN ACCORDANCE WITH SPECIFICATIONS, WHICHEVER IS MORE STRINGENT.
- AR ALL MATERIALS FURNISHED AND ALL WORK INSTALLED SHALL COMPLY WITH THE CURRENT EDITION OF THE NATIONAL ELECTRICAL CODES, NATIONAL FIRE CODES OF THE NATIONAL FIRE PROTECTION ASSOCIATION, THE REQUIREMENTS OF LOCAL UTILITY COMPANIES, AND WITH THE REQUIREMENTS OF ALL GOVERNMENTAL AGENCIES OR DEPARTMENTS HAVING JURISDICTION. IF ANY CONFLICTS OR DISCREPANCIES OCCUR THE MOST STRINGENT SHALL APPLY.
- AS DO NOT SCALE FROM DRAWINGS, AS PRINTING DISTORTS SCALE. WORK SHALL BE LAID OUT FROM DIMENSIONED DRAWINGS, OR DIMENSIONS SUPPLIED TO THE CONTRACTOR.
- AT NOISY WORK, WORK OUTSIDE CONSTRUCTION BARRIERS, WORK IN OCCUPIED AREAS, ETC. SHALL BE PERFORMED AFTER HOURS OR ON WEEKENDS. COORDINATE EXACT SCHEDULING WITH FACILITY PRIOR TO CONSTRUCTION.
- AU ALL ITEMS HAVING KEYED LOCKS/OPERATORS SHALL HAVE CORED LOCKS/OPERATORS. ALL KEYING SHALL MATCH THE OWNER'S EXISTING KEY-WAYS. COORDINATE EXACT REQUIREMENTS WITH OWNER PRIOR TO CONSTRUCTION.
- AV REFER TO ARCHITECTURAL PLANS FOR PHASING REQUIREMENTS. WORK SHALL BE COMPLETED IN PHASES PER THE PHASING PLAN AND AS COORDINATED WITH OWNER AND GENERAL CONTRACTOR. PROVIDE ALL REQUIRED INCREMENTAL INSPECTIONS, CERTIFICATIONS, ETC. AND ALL TEMPORARY SERVICES AS REQUIRED BY OWNER TO ACCOMPLISH THE PHASING PLAN.

ELECTRICAL DEMOLITION NOTES

- A DOTTED LINES INDICATE ITEMS FOR REMOVAL (UON) AND SOLID HALFTONE LINES INDICATE EXISTING ITEMS TO
- B THE CONTRACTOR SHALL MAINTAIN THE CONTINUITY OF EXISTING CIRCUITS THAT CONTAIN DEVICES OR EQUIPMENT THAT ARE TO REMAIN. WHEN DEMOLITION OF AN ELECTRICAL DEVICE (OR CIRCUIT) IS INDICATED ON THE DRAWINGS: THE CONTRACTOR SHALL ENSURE THAT OTHER DEVICES OR EQUIPMENT "UPSTREAM" OR "DOWNSTREAM" ON THE CIRCUITS SHALL REMAIN IN "PRE- DEMOLITION" WORKING ORDER. "LEFT-OVER" CIRCUIT BREAKERS SHALL REMAIN, BE SWITCHED TO OFF POSITION, AND BE LABELED AS SPARES IN THEIR PANELS. PROVIDE NEW TYPEWRITTEN DIRECTORIES FOR ALL PANELS AFFECTED.
- C LOCATIONS OF DEVICES, CONNECTIONS, ETC., INDICATED ON THIS DRAWING WERE TAKEN FROM VARIOUS SOURCES. THEY ARE DIAGRAMMATIC ONLY AND ARE SUBJECT TO VARIATION FROM EXISTING CONDITIONS. CERTAIN EXISTING ELEMENTS MAY NOT BE INDICATED AT ALL. THE CONTRACTOR PROPOSING TO DO ANY PART OF THE WORK INDICATED HEREON SHALL VISIT THIS SITE AND DETERMINE TO HIS SATISFACTION THAT THEY MAY COMPLETE ALL WORK REQUIRED FOR THE BID WHICH HE PROPOSES.
- D REMOVE ALL ASSOCIATED BACKBOXES, CONDUIT AND CONDUCTORS FOR DEVICES / FIXTURES / ETC. BEING REMOVED (BACK TO SOURCE), WHETHER INDICATED OR NOT (UON). CONTRACTOR SHALL PATCH AND REPAIR ANY EXISTING WALLS, FLOORS OR CEILINGS WHERE DEVICES ARE SHOWN TO BE REMOVED (PATCH AND REPAIR TO
- RECEIVE NEW FINISHES SEE ARCHITECTURAL PLANS). E COORDINATE DISPOSAL OF ALL FIXTURES, DEVICES, ETC. (INDICATED FOR DEMOLITION) WITH OWNER. TURN OVER ITEMS REMOVED TO OWNER AT THEIR OPTION.
- F COORDINATE WITH OTHER TRADES FOR THE REMOVAL AND/OR RELOCATION OF ELECTRICAL DEVICES AND CONNECTIONS ASSOCIATED WITH THEIR EQUIPMENT.
- G PROVIDE TEMPORARY EMERGENCY EXIT LIGHTS AT CONSTRUCTION BARRIERS AS REQUIRED. H CONTRACTOR SHALL PATCH AND REPAIR ALL EXISTING WALLS / CEILINGS AS REQUIRED WHERE DEVICES ARE BEING REMOVED OR INSTALLED.
- I UNUSED/ABANDONED CONDUCTORS DISCOVERED ABOVE ACCESSIBLE CEILINGS SHALL BE REMOVED IN ACCORDANCE WITH NEC REQUIREMENTS.
- J EXISTING ELECTRICAL SYSTEMS IN CONFLICT WITH CONSTRUCTION SHALL BE RELOCATED TO PERMIT
- INSTALLATION OF DEVICES AND EQUIPMENT SHOWN ON PLANS. K CONTRACTOR SHALL SEAL ALL EXISTING AND NEW PENETRATIONS OF BUILDING ENVELOPE (EXTERIOR WALLS. ROOF, ETC.) WATER-TIGHT AND AS APPROVED BY ARCHITECT AND ENGINEER. ROOFING SHALL BE RESTORED BY A LICENSED ROOFING CONTRACTOR BASED ON WRITTEN INSTRUCTIONS AND DETAILS FROM ROOFING MANUFACTURER AS REQUIRED TO MAINTAIN ROOF WARRANTY. REFER TO ARCHITECTURAL AND ENGINEERING
- PLANS AND SPECIFICATIONS FOR FURTHER REQUIREMENTS. L DEVICES INDICATED WITH AN "R" SHALL BE RELOCATED, REMOVE, PROTECT, AND REINSTALL IN NEW LOCATION INDICATED ON NEW WORK PLANS. INTERCEPT AND EXTEND ALL EXISTING CABLING TO NEW LOCATION. CLEAN AND RE-LAMP RELOCATED LUMINAIRES. M ALL EXISTING PANELS AFFECTED BY THIS CONTRACTOR'S WORK SHALL BE PROVIDED WITH NEW TYPE-WRITTEN
- PANEL DIRECTORIES AND INSERT SLEEVES. PANEL DIRECTORIES SHALL NOT USE ROOM NAMES OR NUMBERS FROM THESE DRAWINGS. DIRECTORIES SHALL BE DETAILED AND COORDINATED WITH OWNER'S SUITE NUMBERS, FINAL ROOM NUMBERS, IT RACK NAMES, WORKSTATION DESIGNATIONS, ETC. UNUSED BREAKERS SHALL BE IN OFF
- N CONTRACTOR TO VERIFY THAT THERE ARE NO ELECTRICAL CIRCUITS IN CHASES BEING REMOVED UNDER DEMOLITION WHICH REMAIN IN SERVICE AND CANNOT BE REMOVED. SHOULD SUCH CIRCUITS BE ENCOUNTERED, THE CONTRACTOR IS TO REPOUTE AND RECONNECT AS REQUIRED TO MAINTAIN SERVICE.





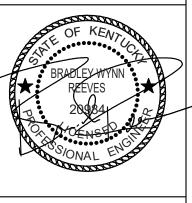



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ELECTRICAL LEGEND

DATE ISSUED: 09/14/2021

REVISIONS

ELECTRICAL DEMOLITION NOTES

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TAGGED NOTES

L2 DEMOLISH LIGHT FIXTURE, LIGHT SWITCH, WIRING, AND CONDUIT.

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ELIZABETHTOWN INDEPENDENT SCHOC Elizabethtown, Kentucky

21-290
 Project No:
 2121/XETR21

 Drawn By:
 KPL

 Rev'd By:
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DATE ISSUED:

09/14/2021

KEY PLAN GYM GIRLS' RR MEDIA CENTER RR CLASSROOMS RR CAFETERIA RR COUNSELOR RE STAFF RR FIRST AID RR ITING DEMOLITION PLAN

SCALE: NTS

ELECTRICAL DEMOLITION NOTES

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I UNUSED/ABANDONED CONDUCTORS DISCOVERED ABOVE ACCESSIBLE CEILINGS SHALL BE REMOVED IN

J EXISTING ELECTRICAL SYSTEMS IN CONFLICT WITH CONSTRUCTION SHALL BE RELOCATED TO PERMIT INSTALLATION OF DEVICES AND EQUIPMENT SHOWN ON PLANS.

K CONTRACTOR SHALL SEAL ALL EXISTING AND NEW PENETRATIONS OF BUILDING ENVELOPE (EXTERIOR WALLS, ROOF, ETC.) WATER-TIGHT AND AS APPROVED BY ARCHITECT AND ENGINEER. ROOFING SHALL BE RESTORED BY A LICENSED ROOFING CONTRACTOR BASED ON WRITTEN INSTRUCTIONS AND DETAILS FROM ROOFING MANUFACTURER AS REQUIRED TO MAINTAIN ROOF WARRANTY. REFER TO ARCHITECTURAL AND ENGINEERING PLANS AND SPECIFICATIONS FOR FURTHER REQUIREMENTS.

L DEVICES INDICATED WITH AN "R" SHALL BE RELOCATED. REMOVE, PROTECT, AND REINSTALL IN NEW LOCATION INDICATED ON NEW WORK PLANS. INTERCEPT AND EXTEND ALL EXISTING CABLING TO NEW LOCATION. CLEAN

M ALL EXISTING PANELS AFFECTED BY THIS CONTRACTOR'S WORK SHALL BE PROVIDED WITH NEW TYPE-WRITTEN PANEL DIRECTORIES AND INSERT SLEEVES. PANEL DIRECTORIES SHALL NOT USE ROOM NAMES OR NUMBERS FROM THESE DRAWINGS. DIRECTORIES SHALL BE DETAILED AND COORDINATED WITH OWNER'S SUITE NUMBERS, FINAL ROOM NUMBERS, IT RACK NAMES, WORKSTATION DESIGNATIONS, ETC. UNUSED BREAKERS SHALL BE IN OFF

DEMOLITION WHICH REMAIN IN SERVICE AND CANNOT BE REMOVED. SHOULD SUCH CIRCUITS BE ENCOUNTERED, THE CONTRACTOR IS TO REROUTE AND RECONNECT AS REQUIRED TO MAINTAIN SERVICE.

TAGGED NOTES

E3 DEMOLISH EXISITING HAND DRYER. DEMOLISH CONDUIT TO ABOVE CEILING AND SAVE WIRING TO CONNECT/EXTEND TO NEW GFCI

E4 DEMOLISH HAND DRYER CIRCUIT BACK TO SOURCE AND LABEL

BREAKER AS SPARE. E7 DEMOLISH OUTLET. SAVE WIRING AND CONDUIT TO RECONNECT

E9 REMOVE JUNCTION BOX AND ASSOCIATED CONDUIT THAT IS

S2 REMOVE AND REINSTALL SPEAKERS IN SAME LOCATION. S4 REMOVE SPEAKER SAVE FOR REINSTALLATION.

S6 REMOVE AND STORE EXISTING HEAT DETECTOR IN SECURE

CIRCUIT TO NEW GFCI OUTLET. CEILING MOUNTED AND REINSTALL ABOVE CEILING.

LOCATION.

ELIZABETHTOWN INDEPENDENT SCHOC Elizabethtown, Kentucky

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21-290

Drawn By: KPL **KEY PLAN** Rev'd By: BWR GYM GIRLS' RR CAFETERIA RR STAFF RR FIRST AID RR

SHEET RELEASE CONSTRUCTION DOCUMENTS


POWER AND SYSTEMS DEMOLITION PLAN DATE ISSUED:


09/14/2021

SCALE: NTS

COUNSELOR RE


CLASSROOMS RR

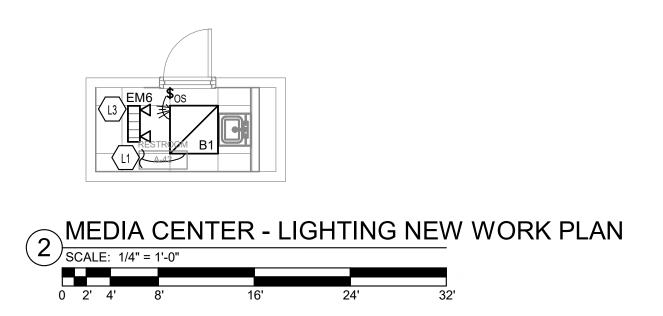

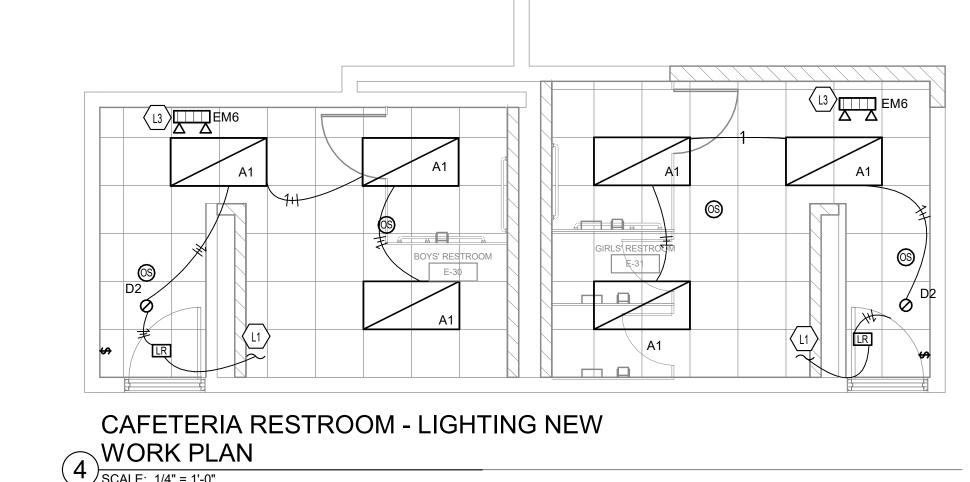



- A REFER TO THE ARCHITECT'S REFLECTED CEILING PLANS, ELEVATIONS, AND CASEWORK DETAILS FOR EXACT LOCATIONS OF ALL WALL AND CEILING MOUNTED ELECTRICAL DEVICES.
- B CONTRACTOR SHALL FOLLOW BRANCH CIRCUITING LAY-OUT, AS INDICATED ON THE FLOOR PLANS, WITH A MAXIMUM OF THREE (3) BRANCH CIRCUITS PER HOMERUN. EACH BRANCH CIRCUIT SHALL BE PROVIDED WITH A DEDICATED NEUTRAL CONDUCTOR. DEDICATED NEUTRAL CONDUCTORS SHALL BE CONSIDERED CURRENT CARRYING. IF ADDITIONAL CONDUCTORS ARE RAN IN THE SAME CONDUIT WITH THOSE INDICATED, CONTRACTOR SHALL DERATE ALL CURRENT CARRYING CONDUCTORS PER N.E.C. #310.15(B)(3), AND UPSIZE CONDUIT AS REQUIRED PER N.E.C. #300.17 AND ANNEX C. MULTIWIRE BRANCH CIRCUITS AS DEFINED IN N.E.C #100 / 210.4 (CIRCUITS SHARING A COMMON NEUTRAL CONDUCTOR) SHALL NOT BE
- C IDENTIFY THE PANEL AND CIRCUIT NUMBER FOR ALL RECEPTACLES, SWITCHES, ETC. IN AREA OF CONSTRUCTION. PROVIDE CLEAR ADHESIVE
- E LOCATE EXIT SIGNS FOR MAXIMUM VIEWING AREA TO IDENTIFY EGRESS PATHS AS INDICATED ON PLANS. COORDINATE LOCATIONS SUCH THAT ARCHITECTURAL FEATURES OR EQUIPMENT FROM OTHER TRADES DO NOT
- F LUMINAIRES INDICATED WITH MULTI-LEVEL SWITCHING SHALL HAVE SIMILAR LAMPS CONTROLLED TOGETHER, I.E. INBOARD AND OUTBOARD
- G ALL LIGHTING FIXTURE LENSES, PARABOLIC LOUVERS, DOWNLIGHTING DIRT DEPOSITS. IT IS PREFERRED THAT FIXTURES BE SHIPPED AND CLEANED WITH SOLVENT RECOMMENDED BY THE MANUFACTURER, OR REPLACED AS NECESSARY IN ORDER TO TURN OVER TO THE OWNER NEW
- H RECESSED LUMINAIRES SHALL BE SECURED SUCH THAT THE FORCE
- I CONTRACTOR SHALL PROVIDE UNSWITCHED CONDUCTOR TO ALL EXIT SIGNS, EMERGENCY INVERTER BATTERY PACKS, AND NIGHT LIGHTS AS

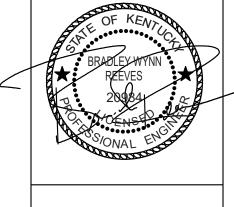


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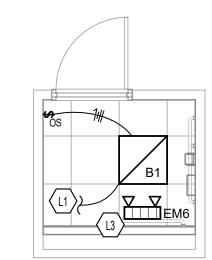




- L1 EXTEND/CONNECT LIGHT SWITCH AND LIGHTS TO EXISITNG
- L3 EXTEND 2#12, #12G IN 3/4" CONDUIT TO NEAREST UNSWITCHED CIRCUIT.






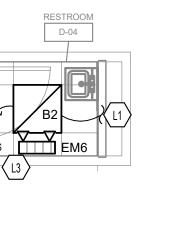


LAB RESTROOM - LIGHTING NEW WORK PLAN

SCALE: 1/4" = 1'-0"

0 2' 4' 8' 16' 24' 32'

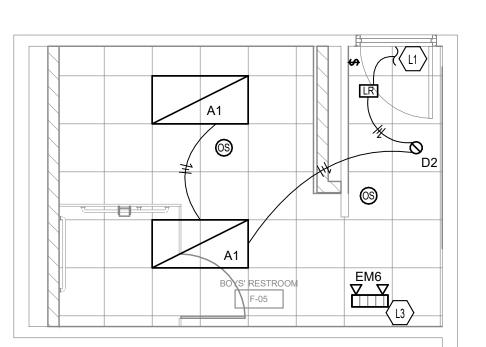


GYM ENTRY BOYS RESTROOM - LIGHTING NEW WORK PLAN
SCALE: 1/4" = 1'-0"

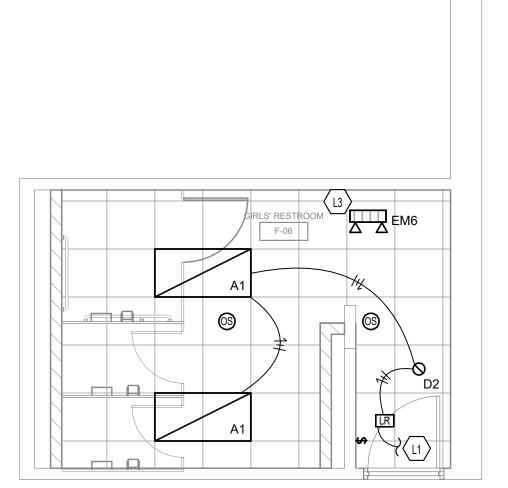

GYM ENTRY GIRLS RESTROOM - LIGHTING 8 NEW WORK PLAN
SCALE: 1/4" = 1'-0"



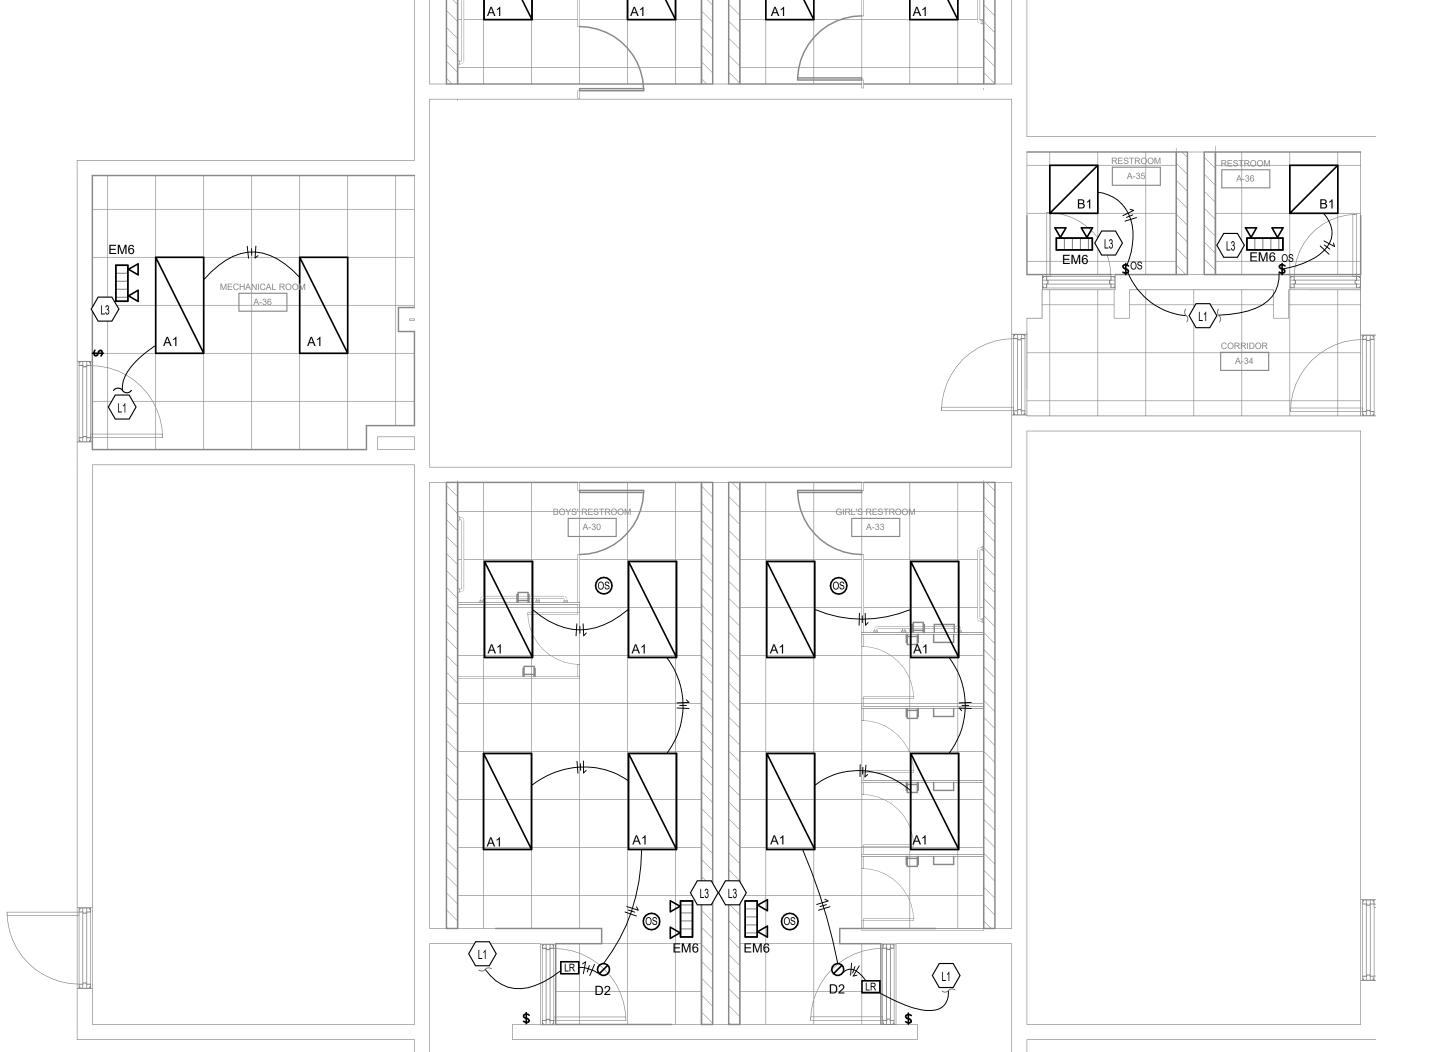



CLASSROOM RESTROOM - LIGHTING NEW


WORK PLAN

| SCALE: 1/4" = 1'-0"


KEY PLAN SHEET RELEASE GYM GIRLS' RR MEDIA CENTER RR CLASSROOMS RR COUNSELOR F STAFF RR FIRST AID RR ITING NEW WORK PLAN DATE ISSUED: SCALE: NTS 09/14/2021

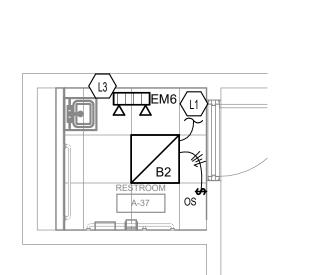


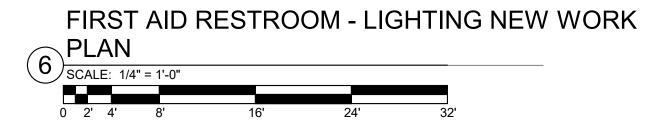


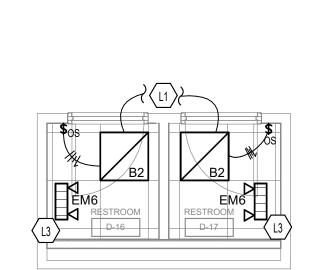



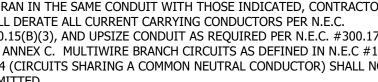

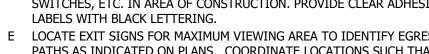

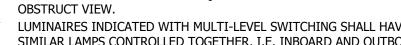

- LAMPS OR RIGHT AND LEFT HAND LAMPS. ALZAK CONES AND "PARACUBE" LOUVERS SHALL BE HANDLED WITH COTTON GLOVES DURING INSTALLATION AND LAMPING TO AVOID FINGERPRINTS OR INSTALLED WITH CLEAR PLASTIC BAGS TO PROTECT LOUVERS. AT CLOSE OF PROJECT, AND AFTER CONSTRUCTION AIR FILTERS ARE CHANGED, REMOVE BAGS. ANY LOUVER OR CONE SHOWING DIRT OR FINGER PRINTS SHALL BE FIXTURES AT OCCUPANCY.
- REQUIRED INSERTING LAMPS, TRIMS, LENSES, LOUVERS, OR DOOR FRAMES DOES NOT SHIFT HOUSING. ALL TRIMS SHALL BE COMPLETELY FLUSH WITH FINISHED CEILINGS AT COMPLETION OF CONSTRUCTION.





ELIZABETHTOWN INDEPENDENT SCHOC Elizabethtown, Kentucky

BG # 21-290
 Project No:
 2121/XETR21

 Drawn By:
 KPL

 Rev'd By:
 BWR

CONSTRUCTION DOCUMENTS

COUNSELOR RESTROOM - POWER AND

SYSTEMS NEW WORK PLAN


FIRST AIRD RESTROOM - POWER AND

STAFF RESTROOM - POWER AND SYSTEMS

NEW WORK PLAN
SCALE: 1/4" = 1'-0"


SYSTEMS NEW WORK PLAN

SCALE: 1/4" = 1'-0"

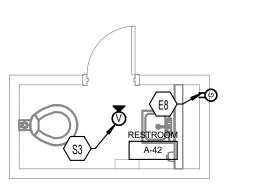



MEDIA CENTER- POWER AND SYSTEMS NEW WORK PLAN



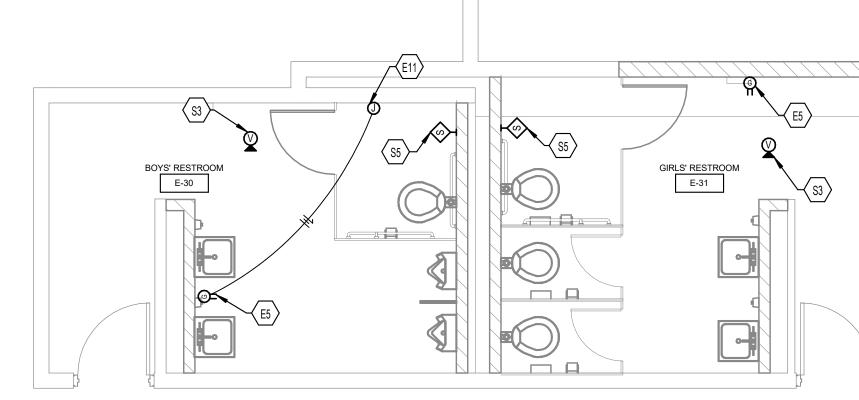





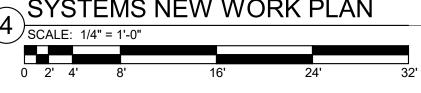

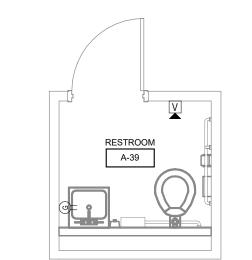

LAB RESTROOM - POWER AND SYSTEMS NEW WORK PLAN

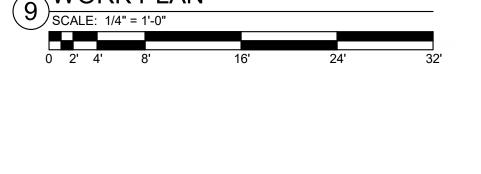


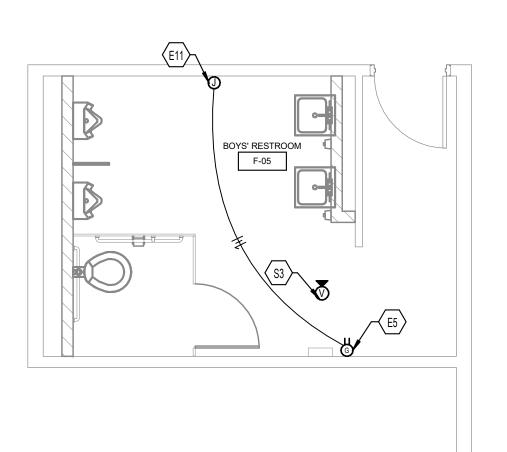

GYM ENTRY BOYS RESTROOM - POWER AND SYSTEMS NEW WORK PLAN

SCALE: 1/4" = 1'-0"

0 2' 4' 8' 16' 24'

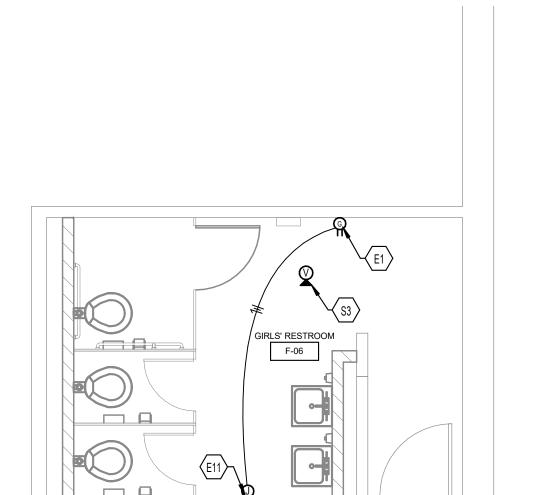

GYM ENTRY GIRLS RESTROOM - POWER AND





ARE RAN IN THE SAME CONDUIT WITH THOSE INDICATED, CONTRACTOR SHALL DERATE ALL CURRENT CARRYING CONDUCTORS PER NEC 310.15(B)(3), AND UPSIZE CONDUIT AS REQUIRED PER NEC 300.17 AND ANNEX C. MULTIWIRE BRANCH CIRCUITS AS DEFINED IN NEC 100 / 210.4 (CIRCUITS SHARING A COMMON NEUTRAL CONDUCTOR) SHALL NOT BE PERMITTED. C IDENTIFY THE PANEL AND CIRCUIT NUMBER FOR ALL RECEPTACLES,

ELECTRICAL POWER NOTES

MOUNTED ELECTRICAL DEVICES.

SWITCHES, ETC. IN AREA OF CONSTRUCTION. PROVIDE CLEAR ADHESIVE LABELS WITH BLACK LETTERING. IN HEALTHCARE FACILITIES, ENGRAVE EMERGENCY DEVICE COVERPLATES IN PATIENT CARE AREAS. MARK INSIDES OF ALL DEVICE BOXES WITH PANEL AND CIRCUIT NUMBER.

A REFER TO THE ARCHITECT'S REFLECTED CEILING PLANS, ELEVATIONS, AND CASEWORK DETAILS FOR EXACT LOCATIONS OF ALL WALL AND CEILING

B CONTRACTOR SHALL FOLLOW BRANCH CIRCUITING LAY-OUT, AS INDICATED ON THE FLOOR PLANS, WITH A MAXIMUM OF THREE (3) BRANCH CIRCUITS PER HOMERUN. EACH BRANCH CIRCUIT SHALL BE PROVIDED WITH A DEDICATED NEUTRAL CONDUCTOR. DEDICATED NEUTRAL CONDUCTORS SHALL BE CONSIDERED CURRENT CARRYING. IF ADDITIONAL CONDUCTORS

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- D RECEPTACLES THAT ARE CONTROLLED BY AN AUTOMATIC MEANS SUCH AS OCCUPANCY SENSOR OR ENERGY MANAGEMENT SYSTEM SHALL BE MARKED IN ACCORDANCE WITH NEC 406.3(E). E LOCATIONS OF ELECTRICAL CONNECTIONS AND LOCAL DISCONNECTS SHALL
- BE COORDINATED WITH MECHANICAL AND PLUMBING CONTRACTORS TO ENSURE ACCESS AND WORKING CLEARANCE IS MAINTAINED PER NEC. NOTIFY OTHER TRADES OF REQUIRED CLEARANCE AREAS TO AVOID ROUTING OF OTHER SYSTEMS IN THESE AREAS. DO NOT INSTALL ELECTRICAL EQUIPMENT OVER EQUIPMENT NAMEPLATES OR ACCESS PANELS OR THROUGH ACCESS/MAINTENANCE CLEARANCES OF EQUIPMENT BY OTHER


ELECTRICAL SYSTEMS NOTES


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- B CONTRACTOR SHALL FOLLOW BRANCH CIRCUITING LAY-OUT, AS INDICATED ON THE FLOOR PLANS, WITH A MAXIMUM OF THREE (3) BRANCH CIRCUITS PER HOMERUN. EACH BRANCH CIRCUIT SHALL BE PROVIDED WITH A DEDICATED NEUTRAL CONDUCTOR. DEDICATED NEUTRAL CONDUCTORS SHALL BE CONSIDERED CURRENT CARRYING. IF ADDITIONAL CONDUCTORS ARE RAN IN THE SAME CONDUIT WITH THOSE INDICATED, CONTRACTOR SHALL DERATE ALL CURRENT CARRYING CONDUCTORS PER NEC 310.15(B)(3), AND UPSIZE CONDUIT AS REQUIRED PER NEC 300.17 AND ANNEX C. MULTIWIRE BRANCH CIRCUITS AS DEFINED IN NEC 100 / 210.4 (CIRCUITS
- SHARING A COMMON NEUTRAL CONDUCTOR) SHALL NOT BE PERMITTED. C IDENTIFY THE PANEL AND CIRCUIT NUMBER FOR ALL RECEPTACLES, SWITCHES, ETC. IN AREA OF CONSTRUCTION. PROVIDE CLEAR ADHESIVE LABELS WITH BLACK LETTERING. IN HEALTHCARE FACILITIES, ENGRAVE EMERGENCY DEVICE COVERPLATES IN PATIENT CARE AREAS. MARK INSIDES
- OF ALL DEVICE BOXES WITH PANEL AND CIRCUIT NUMBER. D REFER TO "SYSTEM INSTALLATION MATRIX" (ON SYSTEMS LEGEND SHEET)
- AND SPECIFICATIONS FOR CONTRACTOR REQUIREMENTS OF EACH SYSTEM. E THE CONTRACTOR SHALL ROUTE ALL "SYSTEM CONDUIT STUB-UPS" TO THE NEAREST CORRIDOR CABLING PATH (SEE "STUB-UP" DETAILS). REFER TO
- CABLING PATH INSTALLATION DETAIL FOR ADDITIONAL REQUIREMENTS. F CONTRACTOR SHALL PAINT ALL SYSTEMS CONDUIT STUB-UPS LIGHT BLUE FOR SYSTEMS CABLING INTO THE CORRIDOR CABLING PATH. PROVIDE PULL STRINGS IN ALL NEW CONDUIT RUNS FOR SYSTEM CABLING INSTALLATION.

TAGGED NOTES


- E1 EXTEND CIRCUIT TO NEW GFCI OUTLET. E5 CONNECT GFCI OUTLET TO EXISTING CIRCUIT THAT SERVED HAND
- E6 EXTEND/ RECONNECT TO CIRCUIT TO NEW GFCI. E8 EXTEND 2#12, #12G IN 3/4" CONDUIT TO NEAREST UNSWITCHED
- E10 REINSTALL JUNCTION BOX AND CONDUIT ABOVE CEILING. E11 PROVIDE POWER TO TRAP PRIMER. PROVIDE 3#12 IN 3/4" CONDUIT FROM TRAP PRIMER TO 120V OUTLET. REFER TO PLUMBING
- S3 EXTEND FIRE ALARM CIRCUIT TO EXISTING SIMPLEX FIRE ALARM CONTROL PANEL. REFER TO SHEET E6.0 FOR APPROXIMATE LOCATION.
- S5 EXTEND/ RECONNECT EXISITNG SPEAKER. S7 REINSTALL EXISTING HEAT DETECTOR

SHEETS. COORDINATE WORK WITH PLUMBER

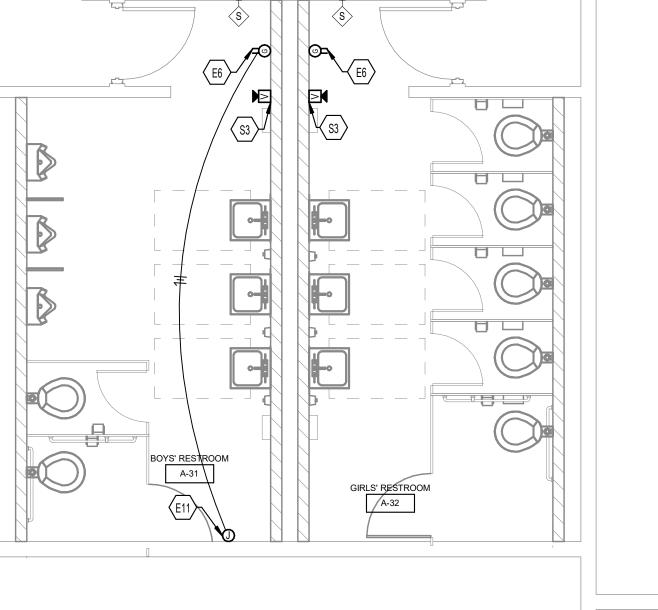

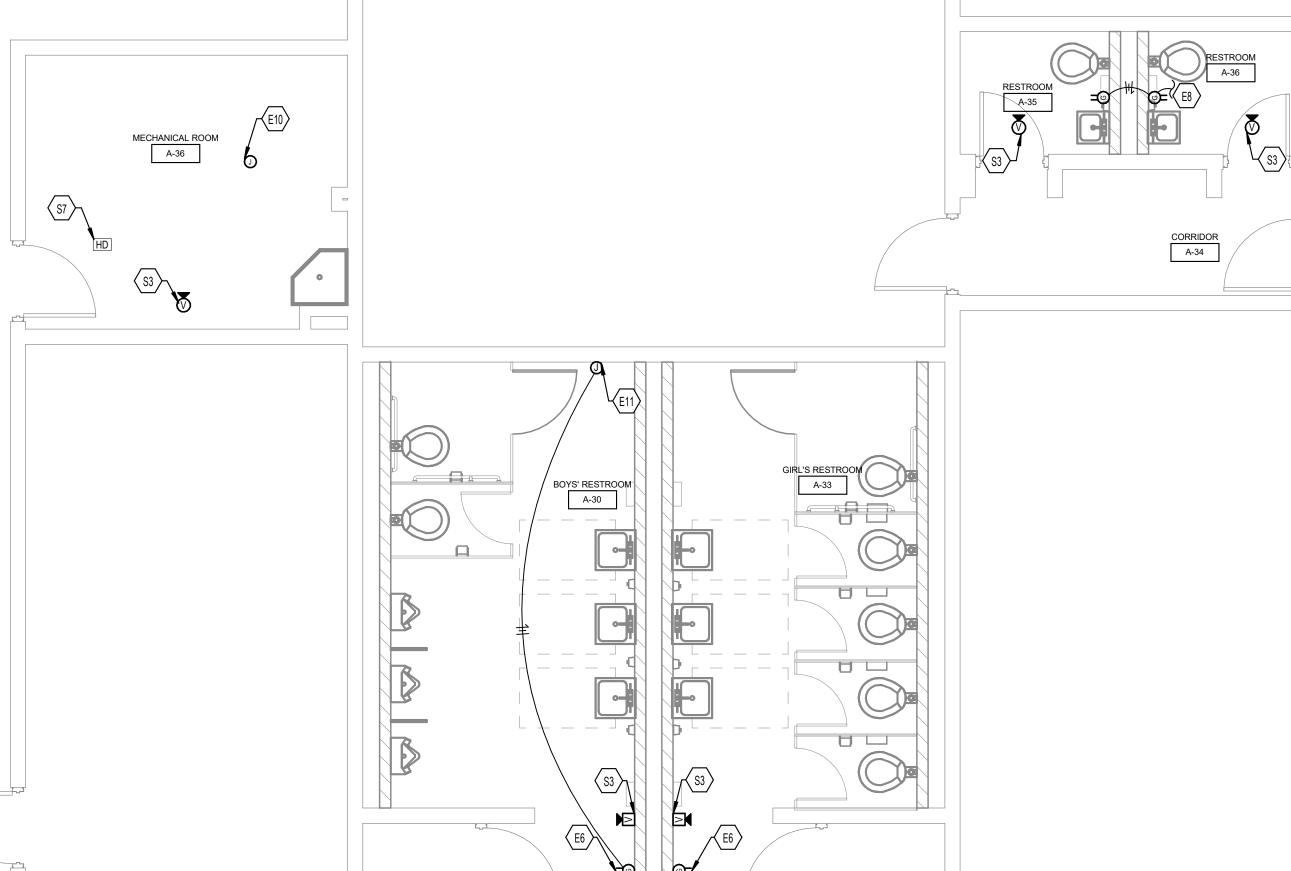

KEY PLAN CLASSROOMS RR

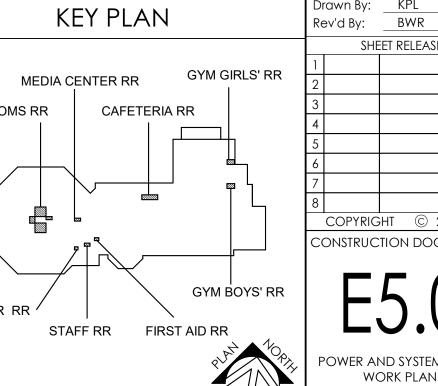

21-290
 Project No:
 2121/XETR21

 Drawn By:
 KPL

 Rev'd By:
 BWR
 SHEET RELEASE

CONSTRUCTION DOCUMENTS ER AND SYSTEMS NEW

ELIZABETHTOWN INDEPENDENT SCHOC Elizabethtown, Kentucky


WORK PLAN DATE ISSUED: 09/14/2021

COUNSELOR R

SCALE: NTS

SCALE: 1/4" = 1'-0"

SYSTEMS NEW WORK PLAN

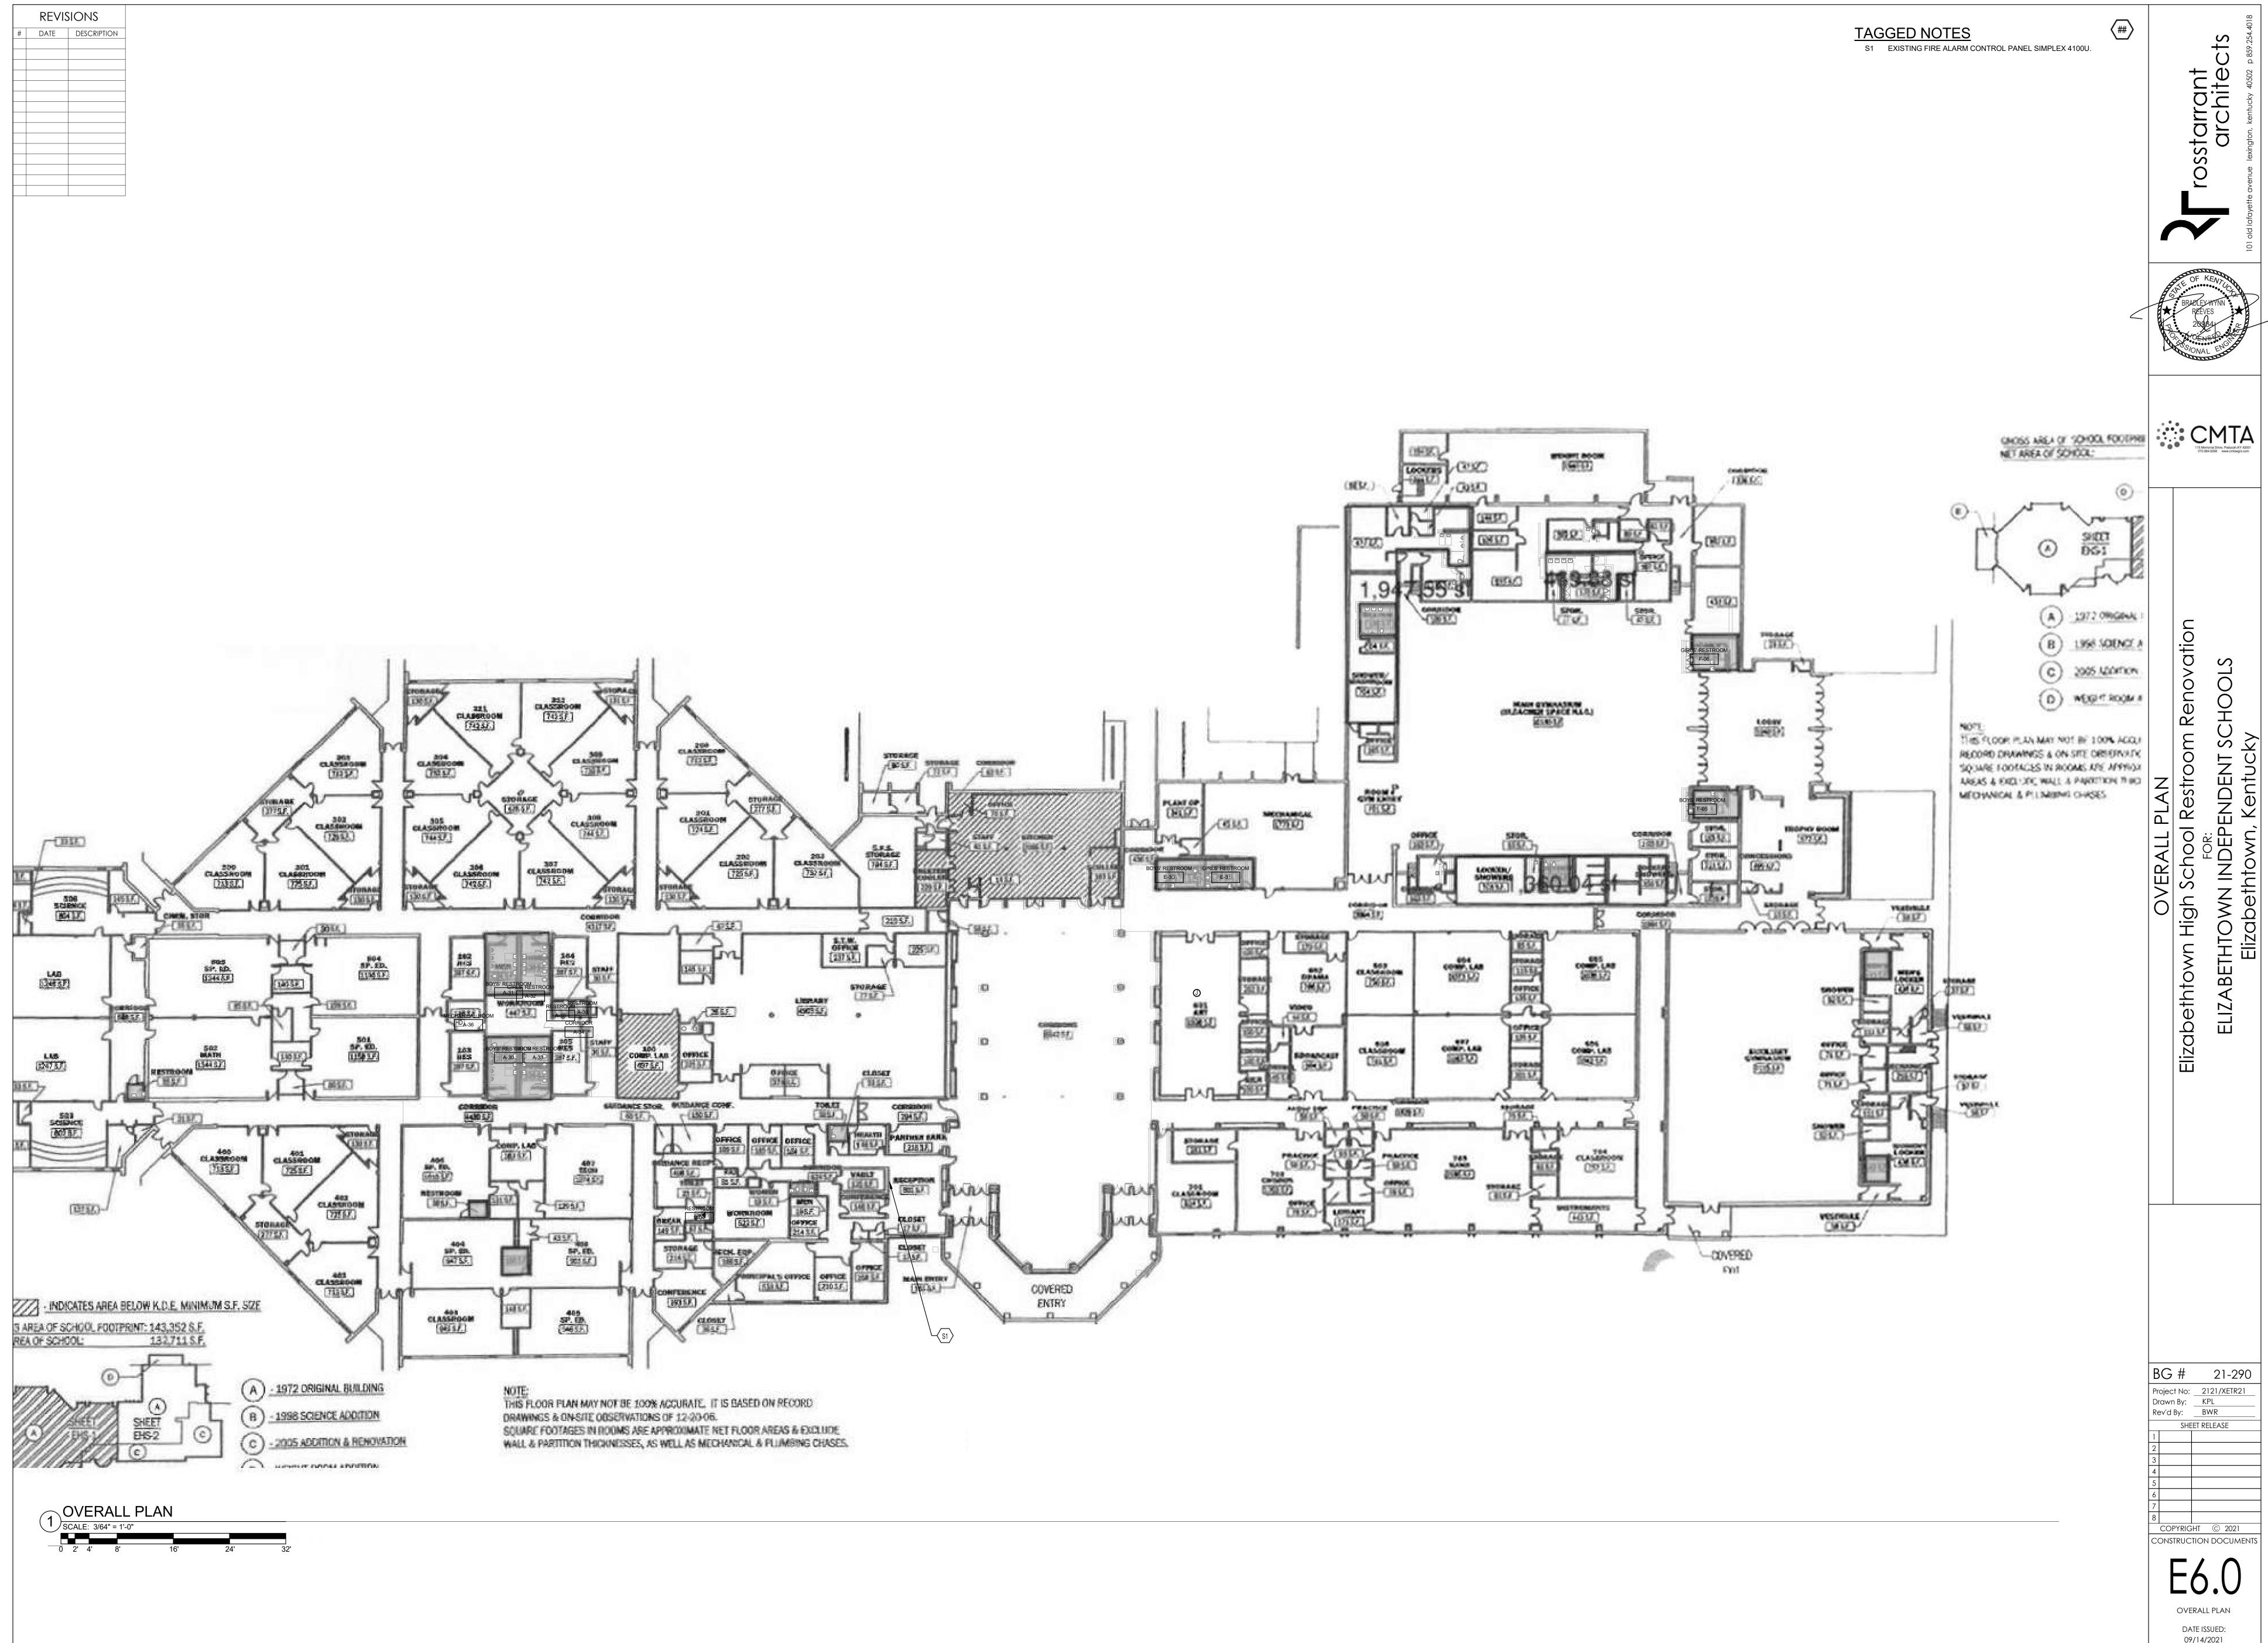


	REVISIONS							
#	DATE	DESCRIPTIO						

	ELEC - LUMINAIRE SCHEDULE								
TYPE	DESCRIPTION	BASIS OF DESIGN	EQUALS	LAMPS / CCT	MINIMUM LUMENS	MOUNTING	MAXIMUM WATTAGE	VOLTAGE	REMARKS
	2 X 4 LED GRID TROFFER WITH 2-3/8" DEEP STEEL HOUSING, INTEGRAL T-BAR CLIPS, COLD ROLLED STEEL REFLECTOR, POLYESTER POWDER COAT AFTER FABRICATION, IMPACT RESISTANT MODIFIED ACRYLIC PRISMATIC REFRACTOR, L90 RATED LIFE OF 60,000 HOURS, DLC QUALIFIED, AND FIVE YEAR LIMITED FIXTURE WARRANTY.	LITHONIA LIGHITNG BLT SERIES	METALUX, DAYBRITE	4000K	4000	RECESSED	31	277	ALL FIXTURES SHALL BE RATED FOR 120V AND 277 CONNECTION 0-10V DIMMING TO 1%
	2 X 2 LED GRID TROFFER WITH 2-3/8" DEEP STEEL HOUSING, INTEGRAL T-BAR CLIPS, COLD ROLLED STEEL REFLECTOR, POLYESTER POWDER COAT AFTER FABRICATION, IMPACT RESISTANT MODIFIED ACRYLIC PRISMATIC REFRACTOR, L90 RATED LIFE OF 60,000 HOURS, DLC QUALIFIED, AND FIVE YEAR LIMITED FIXTURE WARRANTY.	LITHONIA LIGHTING BLT SERIES	METALUX, DAYBRITE	4000K	3300	RECESSED	29	277	ALL FIXTURES SHALL BE RATED FOR 120V AND 277 CONNECTION 0-10V DIMMING TO 1%
	2 X 2 LED GRID TROFFER WITH 2-3/8" DEEP STEEL HOUSING, INTEGRAL T-BAR CLIPS, COLD ROLLED STEEL REFLECTOR, POLYESTER POWDER COAT AFTER FABRICATION, IMPACT RESISTANT MODIFIED ACRYLIC PRISMATIC REFRACTOR, L90 RATED LIFE OF 60,000 HOURS, DLC QUALIFIED, AND FIVE YEAR LIMITED FIXTURE WARRANTY.	LITHONIA LIGHTING BLT SERIES	METALUX, DAYBRITE	4000K	4000	RECESSED	29	277	ALL FIXTURES SHALL BE RATED FOR 120V AND 277 CONNECTION 0-10V DIMMING TO 1%
D2	6" RECESSED CAN LIGHT FIXTURE	LITHONIA LIGHTING LDN6	PRESCOLITE, OMEGA EQUIVALENT, PORTFOLIO	4000K	1500	RECESSED	19	277	ALL FIXTURES SHALL BE RATED FOR 120V AND 277 CONNECTION 0-10V DIMMING TO 1%
D3	6" RECESSED CAN SHOWER LIGHT FIXTURE	GOTHAM LIGHTING EVO6SH	PRESCOLITE, OMEGA EQUIVALENT, PORTFOLIO	4000K	1500	RECESSED	19	277	ALL FIXTURES SHALL BE RATED FOR 120V AND 277 CONNECTION 0-10V DIMMING TO 1%
EM6	EMERGENCY LIGHT	LITHONIA LIGHTING ELM6L	EVENLITE, DUALITE, EMERGILITE	N/A	1100	SURFACE	3	277	ALL FIXTURES SHALL BE RATED FOR 120V AND 277 CONNECTION

rosstarrant architects

101 old lafayette avenue lexington, kentucky 40502 p 859.254

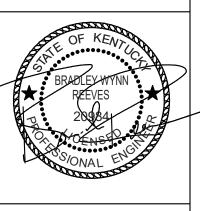



•		115 Memorial Drive, Paducah,KY 42001 270.984.0066 www.cmtaegrs.com						

LUMINAIRE SCHEDULE
Elizabethtown High School Restroom Rencross
FOR:
ELIZABETHTOWN INDEPENDENT SCHOOL
Elizabethtown, Kentucky

LUMINAIRE SCHEDULE

DATE ISSUED: 09/14/2021